



**Request for Proposal
RFP-4703-19-DH**

**City of Grand Junction Fire Station #6
CM/GC**

RESPONSES DUE:

October 17, 2019 prior to 3:30 PM MST

Accepting Electronic Responses Only

**Responses Only Submitted Through the Rocky Mountain E-Purchasing System
(RMEPS)**

<https://www.rockymountainbidsystem.com/default.asp>

(Purchasing Representative does not have access or control of the vendor side of RMEPS. If website or other problems arise during response submission, vendor **MUST** contact RMEPS to resolve issue prior to the response deadline. 800-835-4603)

PURCHASING REPRESENTATIVE:

Duane Hoff Jr., Senior Buyer

duaneh@gjcity.org

(970) 244-1545

This solicitation has been developed specifically for a Request for Proposal intended to solicit competitive responses for this solicitation, and may not be the same as previous City of Grand Junction solicitations. All offerors are urged to thoroughly review this solicitation prior to submitting. Submittal by **FAX, EMAIL or HARD COPY IS NOT ACCEPTABLE** for this solicitation.

REQUEST FOR PROPOSAL

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REQUEST FOR PROPOSAL

SECTION 1.0: ADMINISTRATIVE INFORMATION & CONDITIONS FOR SUBMITTAL

- 1.1 **Issuing Office:** This Request for Proposal (RFP) is issued by the City of Grand Junction, on behalf of the Fire Department. All contact regarding this RFP is directed to:

RFP QUESTIONS:

Duane Hoff Jr., Senior Buyer
duaneh@gjcity.org

- 1.2 **Purpose:** The purpose of this RFP is to obtain proposals from qualified professional Firms, interested in providing CONSTRUCTION MANAGEMENT/GENERAL CONTRACTOR (CM/GC) services for the proposed Fire Station #6 which shall be new construction. The project will be located at 731 27 Road, Grand Junction, CO. The City has selected Chamberlin Architects as the design firm. This proposal includes pre-construction services for work with the City and the Architect during design.
- 1.3 **The Owner:** The Owner is the City of Grand Junction, Colorado and is referred to throughout this Solicitation. The term Owner means the Owner or his authorized representative.
- 1.4 **Mandatory Pre-Proposal Briefing:** A **mandatory** pre-proposal briefing is required by all contractors intending to submit a response to this RFP. Any contractor that does not attend the **mandatory** pre-proposal briefing shall not be eligible to submit a response to this RFP. **The pre-proposal briefing shall be held at City Hall Auditorium, 250 N. 5th Street, Grand Junction, CO on October 2, 2019 at 2:30pm.**
- 1.5 **Compliance:** All participating Offerors, by their signature hereunder, shall agree to comply with all conditions, requirements, and instructions of this RFP as stated or implied herein. Should the Owner omit anything from this packet which is necessary to the clear understanding of the requirements, or should it appear that various instructions are in conflict, the Offeror(s) shall secure instructions from the Purchasing Division prior to the date and time of the submittal deadline shown in this RFP.
- 1.6 **Submission:** Please refer to section 5.0 for what is to be included. ***Each proposal shall be submitted in electronic format only, and only through the Rocky Mountain E-Purchasing website (<https://www.rockymountainbidsystem.com/default.asp>).*** *This site offers both "free" and "paying" registration options that allow for full access of the Owner's documents and for electronic submission of proposals. (Note: "free" registration may take up to 24 hours to process. Please Plan accordingly.)* Please view our **"Electronic Vendor Registration Guide"** at <http://www.gjcity.org/business-and-economic-development/bids/> for details. For proper comparison and evaluation, the City requests that proposals be formatted as directed in Section 5.0 "Preparation and Submittal of Proposals." Submittals received that fail to follow this format may be ruled non-responsive. (Purchasing Representative does not have access or control of the vendor side of RMEPS. If website or other problems arise during response submission, vendor **MUST** contact RMEPS to resolve issue prior to the response deadline. **800-835-4603**).

- 1.7 Altering Proposals:** Any alterations made prior to opening date and time must be initiated by the signer of the proposal, guaranteeing authenticity. Proposals cannot be altered or amended after submission deadline.
- 1.8 Withdrawal of Proposal:** A proposal must be firm and valid for award and may not be withdrawn or canceled by the Offeror for sixty (60) days following the submittal deadline date, and only prior to award. The Offeror so agrees upon submittal of their proposal. After award this statement is not applicable.
- 1.9 Acceptance of Proposal Content:** The contents of the proposal of the successful Offeror shall become contractual obligations if acquisition action ensues. Failure of the successful Offeror to accept these obligations in a contract shall result in cancellation of the award and such vendor shall be removed from future solicitations.
- 1.10 Addenda:** All questions shall be submitted in writing to the appropriate person as shown in Section 1.1. Any interpretations, corrections and changes to this RFP or extensions to the opening/receipt date shall be made by a written Addendum to the RFP by the City Purchasing Division. Sole authority to authorize addenda shall be vested in the City of Grand Junction Purchasing Representative. Addenda will be issued electronically through the Rocky Mountain E-Purchasing website at www.rockymountainbidsystem.com. Offerors shall acknowledge receipt of all addenda in their proposal.
- 1.11 Exceptions and Substitutions:** All proposals meeting the intent of this RFP shall be considered for award. Offerors taking exception to the specifications shall do so at their own risk. The Owner reserves the right to accept or reject any or all substitutions or alternatives. When offering substitutions and/or alternatives, Offeror must state these exceptions in the section pertaining to that area. Exception/substitution, if accepted, must meet or exceed the stated intent and/or specifications. The absence of such a list shall indicate that the Offeror has not taken exceptions, and if awarded a contract, shall hold the Offeror responsible to perform in strict accordance with the specifications or scope of work contained herein.
- 1.12 Confidential Material:** All materials submitted in response to this RFP shall ultimately become public record and shall be subject to inspection after contract award. **“Proprietary or Confidential Information”** is defined as any information that is not generally known to competitors and which provides a competitive advantage. Unrestricted disclosure of proprietary information places it in the public domain. Only submittal information clearly identified with the words **“Confidential Disclosure”** and uploaded as a separate document shall establish a confidential, proprietary relationship. Any material to be treated as confidential or proprietary in nature must include a justification for the request. The request shall be reviewed and either approved or denied by the Owner. If denied, the proposer shall have the opportunity to withdraw its entire proposal, or to remove the confidential or proprietary restrictions. Neither cost nor pricing information nor the total proposal shall be considered confidential or proprietary.
- 1.13 Response Material Ownership:** All proposals become the property of the Owner upon receipt and shall only be returned to the proposer at the Owner’s option. Selection or rejection of the proposal shall not affect this right. The Owner shall have the right to use

all ideas or adaptations of the ideas contained in any proposal received in response to this RFP, subject to limitations outlined in the entitled "Confidential Material". Disqualification of a proposal does not eliminate this right.

1.14 Minimal Standards for Responsible Prospective Offerors: A prospective Offeror must affirmably demonstrate their responsibility. A prospective Offeror must meet the following requirements.

- Have adequate financial resources, or the ability to obtain such resources as required.
- Be able to comply with the required or proposed completion schedule.
- Have a satisfactory record of performance.
- Have a satisfactory record of integrity and ethics.
- Be otherwise qualified and eligible to receive an award and enter into a contract with the Owner.

1.15 Open Records: Proposals shall be received and publicly acknowledged at the location, date, and time stated herein. Offerors, their representatives and interested persons may be present. Proposals shall be received and acknowledged only so as to avoid disclosure of process. However, all proposals shall be open for public inspection after the contract is awarded. Trade secrets and confidential information contained in the proposal so identified by offer as such shall be treated as confidential by the Owner to the extent allowable in the Open Records Act.

1.16 Sales Tax: The Owner is, by statute, exempt from the State Sales Tax and Federal Excise Tax; therefore, all fees shall not include taxes.

1.17 Public Opening: Proposals shall be opened in the City Hall Auditorium, 250 North 5th Street, Grand Junction, CO, 81501, immediately following the proposal deadline. Offerors, their representatives and interested persons may be present. Only the names and locations on the proposing firms will be disclosed.

SECTION 2.0: GENERAL CONTRACT TERMS AND CONDITIONS

2.1. Acceptance of RFP Terms: A proposal submitted in response to this RFP shall constitute a binding offer. Acknowledgment of this condition shall be indicated on the Letter of Interest or Cover Letter by the autographic signature of the Offeror or an officer of the Offeror legally authorized to execute contractual obligations. A submission in response to the RFP acknowledges acceptance by the Offeror of all terms and conditions including compensation, as set forth herein. An Offeror shall identify clearly and thoroughly any variations between its proposal and the Owner's RFP requirements. Failure to do so shall be deemed a waiver of any rights to subsequently modify the terms of performance, except as outlined or specified in the RFP.

2.2. Execution, Correlation, Intent, and Interpretations: The Contract Documents shall be signed by the Owner and Contractor. By executing the contract, the Contractor represents that they have familiarized themselves with the local conditions under which the Work is to be performed, and correlated their observations with the requirements of the Contract Documents. The Contract Documents are complementary, and what is

required by any one, shall be as binding as if required by all. The intention of the documents is to include all labor, materials, equipment, services and other items necessary for the proper execution and completion of the scope of work as defined in the technical specifications and drawings contained herein. All drawings, specifications and copies furnished by the Owner are, and shall remain, Owner property. They are not to be used on any other project.

- 2.3. Permits, Fees, & Notices:** The Contractor shall secure and pay for all permits, governmental fees and licenses necessary for the proper execution and completion of the work. The Contractor shall give all notices and comply with all laws, ordinances, rules, regulations and orders of any public authority bearing on the performance of the work. If the Contractor observes that any of the Contract Documents are at variance in any respect, he shall promptly notify the Owner in writing, and any necessary changes shall be adjusted by approximate modification. If the Contractor performs any work knowing it to be contrary to such laws, ordinances, rules and regulations, and without such notice to the Owner, he shall assume full responsibility and shall bear all costs attributable.
- 2.4. The Owner:** The Owner is the City of Grand Junction and/or Mesa County, Colorado and is referred to throughout the Contract Documents. The term Owner means the Owner or his authorized representative. The Owner shall, at all times, have access to the work wherever it is in preparation and progress. The Contractor shall provide facilities for such access. The Owner will make periodic visits to the site to familiarize himself generally with the progress and quality of work and to determine, in general, if the work is proceeding in accordance with the contract documents. Based on such observations and the Contractor's Application for Payment, the Owner will determine the amounts owing to the Contractor and will issue Certificates for Payment in such amounts, as provided in the contract. The Owner will have authority to reject work which does not conform to the Contract documents. Whenever, in his reasonable opinion, he considers it necessary or advisable to insure the proper implementation of the intent of the Contract Documents, he will have authority to require the Contractor to stop the work or any portion, or to require special inspection or testing of the work, whether or not such work can be then be fabricated, installed, or completed. The Owner will not be responsible for the acts or omissions of the Contractor, and sub-Contractor, or any of their agents or employees, or any other persons performing any of the work.
- 2.5. Contractor:** The Contractor is the person or organization identified as such in the Agreement and is referred to throughout the Contract Documents. The term Contractor means the Contractor or his authorized representative. The Contractor shall carefully study and compare the General Contract Conditions of the Contract, Specification and Drawings, Scope of Work, Addenda and Modifications and shall at once report to the Owner any error, inconsistency or omission he may discover. Contractor shall not be liable to the Owner for any damage resulting from such errors, inconsistencies or omissions. The Contractor shall not commence work without clarifying Drawings, Specifications, or Interpretations.
- 2.6. Sub-Contractors:** A sub-contractor is a person or organization who has a direct contract with the Contractor to perform any of the work at the site. The term sub-contractor is referred to throughout the contract documents and means a sub-contractor or his authorized representative.

- 2.7. Award of Sub-Contractors & Other Contracts for Portions of the Work:** As soon as practicable after bids are received and prior to the award of the contract, the successful Contractor shall furnish to the Owner, in writing for acceptance, a list of the names of the sub-contractors or other persons or organizations proposed for such portions of the work as may be designated in the proposal requirements, or, if none is so designated, the names of the sub-contractors proposed for the principal portions of the work. Prior to the award of the contract, the Owner shall notify the successful Contractor in writing if, after due investigation, has reasonable objection to any person or organization on such list. If, prior to the award of the contract, the Owner has a reasonable and substantial objection to any person or organization on such list, and refuses in writing to accept such person or organization, the successful Contractor may, prior to the award, withdraw their proposal without forfeiture of proposal security. If the successful Contractor submits an acceptable substitute with an increase in the proposed price to cover the difference in cost occasioned by the substitution, the Owner may, at their discretion, accept the increased proposal or may disqualify the Contractor. If, after the award, the Owner refuses to accept any person or organization on such list, the Contractor shall submit an acceptable substitute and the contract sum shall be increased or decreased by the difference in cost occasioned by such substitution and an appropriate Change Order shall be issued. However, no increase in the contract sum shall be allowed for any such substitution unless the Contractor has acted promptly and responsively in submitting a name with respect thereto prior to the award.
- 2.8. Supervision and Construction Procedures:** The Contractor shall supervise and direct the work, using his best skill and attention. He shall be solely responsible for all construction means, methods, techniques, sequences and procedures and for coordinating all portions of the work under the contract.
- 2.9. Warranty:** The Contractor warrants to the Owner that all materials and equipment furnished under this contract will be new unless otherwise specified, and that all work will be of good quality, free from faults and defects and in conformance with the Contract Documents. All work not so conforming to these standards may be considered defective. If required by Owner, the Contractor shall furnish satisfactory evidence as to the kind and quality of materials and equipment. If within ten (10) days after written notice to the Contractor requesting such repairs or replacement, the Contractor should neglect to make or undertake with due diligence to the same, the City may make such repairs or replacements. All indirect and direct costs of such correction or removal or replacement shall be at the Contractor's expense. The Contractor will also bear the expenses of making good all work of others destroyed or damaged by the correction, removal or replacement of his defective work.
- 2.10. Responsibility for those Performing the Work:** The Contractor shall be responsible to the Owner for the acts and omissions of all his employees and all other persons performing any of the work under a contract with the Contractor.
- 2.11. Use of the Site:** The Contractor shall confine operations at the site to areas permitted by law, ordinances, permits and the Contract Documents, and shall not unreasonably encumber the site with any materials or equipment.

- 2.12. Cleanup:** The Contractor at all times shall keep the premises free from accumulation of waste materials or rubbish caused by his operations. At the completion of work he shall remove all his waste materials and rubbish from and about the project, as well as all his equipment and surplus materials.
- 2.13. Miscellaneous Conditions:** Material Availability: Contractors must accept responsibility for verification of material availability, production schedules, and other pertinent data prior to submission of bid. It is the responsibility of the bidder to notify the Owner immediately if materials specified are discontinued, replaced, or not available for an extended period of time. OSHA Standards: All bidders agree and warrant that services performed in response to this invitation shall conform to the standards declared by the US Department of Labor under the Occupational Safety and Health Act of 1970 (OSHA). In the event the services do not conform to OSHA standards, the Owner may require the services to be redone at no additional expense to the Owner.
- 2.14. Time:** Time is of the essence with respect to the time of completion of the Project and any other milestones or deadline which are part of the Contract. It will be necessary for each Bidder to satisfy the City of its ability to complete the Work within the Contract Time set forth in the Contract Documents. The Contract Time is the period of time allotted in the Contract Documents for completion of the work. The date of commencement of the work is the date established in a Notice to Proceed. If there is no Notice to Proceed, it shall be the date of the Contract or such other date as may be established therein, or as established as entered on the Bid Form. The Date of Substantial Completion of the work or designated portions thereof is the date certified by the Owner when construction is sufficiently complete, in accordance with the Contract Documents.
- 2.15. Performance & Payment Bonds:** After design & construction documents completion, but prior to construction commencement, Contractor shall furnish a Performance and a Payment Bond, each in an amount at least equal to that specified for the contract amount as security for the faithful performance and payment of all Contractor's obligations under the Contract Documents. These bonds shall remain in effect for the duration of the Warranty Period (as specified in the Special Conditions). Contractor shall also furnish other bonds that may be required by the Special Conditions. All bonds shall be in the forms prescribed by the Contract Documents and be executed by such sureties as (1) are licensed to conduct business in the State of Colorado and (2) are named in the current list of "Companies Holding Certificates of Authority as Acceptable Sureties on Federal Bonds and as Acceptable Reinsuring Companies" as published in Circular 570 (amended) by the Audit Staff, Bureau of Accounts, U.S. Treasury Department. All bonds signed by an agent must be accompanied by a certified copy of the Authority Act. If the surety on any bond furnished by the Contractor is declared bankrupt, or becomes insolvent, or its rights to do business in Colorado are terminated, or it ceases to meet the requirements of clauses (1) and (2) of this section, Contractor shall within five (5) days thereafter substitute another bond and surety, both of which shall be acceptable to the City.
- 2.16. Retention:** The Owner will deduct money from the partial payments in amounts considered necessary to protect the interest of the Owner and will retain this money until after completion of the entire contract. The amount to be retained from partial payments will be five (5) percent of the value of the completed work, and not greater than

five (5) percent of the amount of the Contract. When the retainage has reached five (5) percent of the amount of the Contract no further retainage will be made and this amount will be retained until such time as final payment is made.

- 2.17. Liquidated Damages for Failure to Enter Into Contract:** Should the Successful Bidder fail or refuse to enter into the Contract within ten Calendar Days from the issuance of the Notice of Award, the City shall be entitled to collect the amount of such Bidder's Bid Guaranty as Liquidated Damages, not as a penalty but in consideration of the mutual release by the City and the Successful Bidder of all claims arising from the City's issuance of the Notice of Award and the Successful Bidder's failure to enter into the Contract and the costs to award the Contract to any other Bidder, to readvertise, or otherwise dispose of the Work as the City may determine best serves its interest.
- 2.18. Liquidated Damages for Failure to Meet Project Completion Schedule:** Once a construction schedule is set and agreed upon by both Owner and Contractor, if the Contractor does not achieve Final Completion by the required date, whether by neglect, refusal or any other reason, the parties agree and stipulate that the Contractor shall pay liquidated damages to the City for each such day that final completion is late. As provided elsewhere, this provision does not apply for delays caused by the City. The date for Final Completion may be extended in writing by the Owner.

The Contractor agrees that as a part of the consideration for the City's awarding of this Contract liquidated damages in the daily amount of **\$1,000.00** is reasonable and necessary to pay for the actual damages resulting from such delay. The parties agree that the real costs and injury to the City for such delay include hard to quantify items such as: additional engineering, inspection and oversight by the City and its agents; additional contract administration; inability to apply the efforts of those employees to the other work of the City; perceived inefficiency of the City; citizens having to deal with the construction and the Work, rather than having the benefit of a completed Work, on time; inconvenience to the public; loss of reputation and community standing for the City during times when such things are very important and very difficult to maintain.

The Contractor must complete the Work and achieve final completion included under the Bid Schedule in the number of consecutive calendar days after the City gives is written Notice to Proceed. When the Contractor considers the entire Work ready for its intended use, Contractor shall certify in writing that the Work is substantially complete. In addition to the Work being substantially complete, Final Completion date is the date by which the Contractor shall have fully completed all clean-up, and all items that were identified by the City in the inspection for final completion. Unless otherwise stated in the Special Conditions, for purposes of this liquidated damages clause, the Work shall not be finished and the Contract time shall continue to accrue until the City gives its written Final Acceptance.

If the Contractor shall fail to pay said liquidated damages promptly upon demand thereof after having failed to achieve Final Completion on time, the City shall first look to any retainage or other funds from which to pay said liquidated damages; if retainage or other liquid funds are not available to pay said liquidated damages amounts, the Surety on the Contractor's Performance Bond and Payment Bond shall pay such liquidated damages.

In addition, the City may withhold all, or any part of, such liquidated damages from any payment otherwise due the Contractor.

Liquidated damages as provided do not include any sums to reimburse the City for extra costs which the City may become obligated to pay on other contracts which were delayed or extended because of the Contractor's failure to complete the Work within the Contract Time. Should the City incur additional costs because of delays or extensions to other contracts resulting from the Contractor's failure of timely performance, the Contractor agrees to pay these costs that the City incurs because of the Contractor's delay, and these payments are separate from and in addition to any liquidated damages.

The Contractor agrees that the City may use its own forces or hire other parties to obtain Substantial or Final Completion of the work if the time of completion has elapsed and the Contractor is not diligently pursuing completion. In addition to the Liquidated Damages provided for, the Contractor agrees to reimburse the City for all expenses thus incurred.

- 2.19. Contingency/Force Account:** Contingency/Force Account work will be authorized by the Owner's Project Manager and is defined as minor expenses to cover miscellaneous or unforeseen expenses related to the project. The expenses are not included in the Drawings, Specifications, or Scope of Work and are necessary to accomplish the scope of this contract. Contingency/Force Account Authorization will be directed by the Owner through an approved form. Contingency/Force Account funds are the property of the Owner and any Contingency/Force Account funds, not required for project completion, shall remain the property of the Owner. Contractor is not entitled to any Contingency/Force Account funds, that are not authorized by Owner or Owner's Project Manager.
- 2.20. Claims for Additional Cost or Time:** If the Contractor wishes to make a claim for an increase in the contract sum or an extension in the contract time, he shall give the Owner written notice thereof within a reasonable time after the occurrence of the event giving rise to such claim. This notice shall be given by the Contractor before proceeding to execute the work, except in an emergency endangering life or property in which case the Contractor shall precede in accordance with the regulations on safety. No such claim shall be valid unless so made. Any change in the contract sum or contract time resulting from such claim shall be authorized by Change Order.
- 2.21. Field Orders:** The Owner may issue written Field Orders which interpret the Contract Documents in accordance with the specifications, or which order minor changes in the work in accordance with the agreement, without change in the contract sum or time. The Contractor shall carry out such Field Orders promptly.
- 2.22. Progress & Completion:** The Contractor shall begin work on the date of commencement as defined in the Contract, and shall carry the work forward expeditiously with adequate forces and shall complete it within the contract time.
- 2.23. Payment & Completion:** The Contract Sum is stated in the Contract and is the total amount payable by the Owner to the Contractor for the performance of the work under the Contract Documents. Upon receipt of written notice that the work is ready for final inspection and acceptance and upon receipt of application for payment, the Owner's Project Manager will promptly make such inspection and, when they find the work

acceptable under the Contract Documents and the Contract fully performed, the Owner shall make payment in the manner provided in the Contract Documents. Partial payments will be based upon estimates, prepared by the Contractor, of the value of Work performed and materials placed in accordance with the Contract Documents. The work performed by Contractor shall be in accordance with generally accepted professional practices and the level of competency presently maintained by other practicing professional firms in the same or similar type of work in the applicable community. The work and services to be performed by Contractor hereunder shall be done in compliance with applicable laws, ordinances, rules and regulations.

- 2.24. Protection of Persons & Property:** The Contractor shall comply with all applicable laws, ordinances, rules, regulations and orders of any public authority having jurisdiction for the safety of persons or property or to protect them from damage, injury or loss. Contractor shall erect and maintain, as required by existing safeguards for safety and protection, and all reasonable precautions, including posting danger signs or other warnings against hazards promulgating safety regulations and notifying owners and users of adjacent utilities. When or where any direct or indirect damage or injury is done to public or private property by or on account of any act, omission, neglect, or misconduct by the Contractor in the execution of the work, or in consequence of the non-execution thereof by the Contractor, they shall restore, at their own expense, such property to a condition similar or equal to that existing before such damage or injury was done, by repairing, rebuilding, or otherwise restoring as may be directed, or it shall make good such damage or injury in an acceptable manner.
- 2.25. Changes in the Work:** The Owner, without invalidating the contract, may order changes in the work within the general scope of the contract consisting of additions, deletions or other revisions, the contract sum and the contract time being adjusted accordingly. All such changes in the work shall be authorized by Change Order and shall be executed under the applicable conditions of the contract documents. A Change Order is a written order to the Contractor signed by the Owner issued after the execution of the contract, authorizing a change in the work or an adjustment in the contract sum or the contract time. The contract sum and the contract time may be changed only by Change Order.
- 2.26. Claims for Additional Cost or Time:** If the Contractor wishes to make a claim for an increase in the contract sum or an extension in the contract time, he shall give the Owner written notice thereof within a reasonable time after the occurrence of the event giving rise to such claim. This notice shall be given by the Contractor before proceeding to execute the work, except in an emergency endangering life or property in which case the Contractor shall precede in accordance with the regulations on safety. No such claim shall be valid unless so made. Any change in the contract sum or contract time resulting from such claim shall be authorized by Change Order.
- 2.27. Minor Changes in the Work:** The Owner shall have authority to order minor changes in the work not involving an adjustment in the contract sum or an extension of the contract time and not inconsistent with the intent of the contract documents.
- 2.28. Uncovering & Correction of Work:** The Contractor shall promptly correct all work rejected by the Owner as defective or as failing to conform to the contract documents whether observed before or after substantial completion and whether or not fabricated

installed or completed. The Contractor shall bear all costs of correcting such rejected work, including the cost of the Owner's additional services thereby made necessary. If within one (1) year after the date of completion or within such longer period of time as may be prescribed by law or by the terms of any applicable special guarantee required by the contract documents, any of the work found to be defective or not in accordance with the contract documents, the Contractor shall correct it promptly after receipt of a written notice from the Owner to do so unless the Owner has previously given the Contractor a written acceptance of such condition. The Owner shall give such notice promptly after discovery of condition. All such defective or non-conforming work under the above paragraphs shall be removed from the site where necessary and the work shall be corrected to comply with the contract documents without cost to the Owner. The Contractor shall bear the cost of making good all work of separate Contractors destroyed or damaged by such removal or correction. If the Owner prefers to accept defective or non-conforming work, he may do so instead of requiring its removal and correction, in which case a Change Order will be issued to reflect an appropriate reduction in the payment or contract sum, or, if the amount is determined after final payment, it shall be paid by the Contractor.

- 2.29. Acceptance Not Waiver:** The Owner's acceptance or approval of any work furnished hereunder shall not in any way relieve the proposer of their present responsibility to maintain the high quality, integrity and timeliness of his work. The Owner's approval or acceptance of, or payment for, any services shall not be construed as a future waiver of any rights under this Contract, or of any cause of action arising out of performance under this Contract.
- 2.30. Change Order/Amendment:** No oral statement of any person shall modify or otherwise change, or affect the terms, conditions or specifications stated in the resulting contract. All amendments to the contract shall be made in writing by the Owner.
- 2.31. Amendment:** No oral statement of any person shall modify or otherwise change, or affect the terms, conditions or specifications stated in the resulting contract. All amendments to the contract shall be made in writing by the Owner Purchasing Division.
- 2.32. Assignment:** The Offeror shall not sell, assign, transfer or convey any contract resulting from this RFP, in whole or in part, without the prior written approval from the Owner.
- 2.33. Compliance with Laws:** Proposals must comply with all Federal, State, County and local laws governing or covering this type of service and the fulfillment of all ADA (Americans with Disabilities Act) requirements. Contractor hereby warrants that it is qualified to assume the responsibilities and render the services described herein and has all requisite corporate authority and professional licenses in good standing, required by law.
- 2.34. Debarment/Suspension:** The Contractor hereby certifies that the Contractor is not presently debarred, suspended, proposed for debarment, declared ineligible, or voluntarily excluded from covered transactions by any Governmental department or agency.

- 2.35. Confidentiality:** All information disclosed by the Owner to the Offeror for the purpose of the work to be done or information that comes to the attention of the Offeror during the course of performing such work is to be kept strictly confidential.
- 2.36. Conflict of Interest:** No public official and/or Owner employee shall have interest in any contract resulting from this RFP.
- 2.37. Contract:** This Request for Proposal, submitted documents, and any negotiations, when properly accepted by the Owner, shall constitute a contract equally binding between the Owner and Offeror. The contract represents the entire and integrated agreement between the parties hereto and supersedes all prior negotiations, representations, or agreements, either written or oral, including the Proposal documents. The contract may be amended or modified with Change Orders, Field Orders, or Amendment.
- 2.38. Project Manager/Administrator:** The Project Manager, on behalf of the Owner, shall render decisions in a timely manner pertaining to the work proposed or performed by the Offeror. The Project Manager shall be responsible for approval and/or acceptance of any related performance of the Scope of Services.
- 2.39. Contract Termination:** This contract shall remain in effect until any of the following occurs: (1) contract expires; (2) completion of services; (3) acceptance of services or, (4) for convenience terminated by either party with a written *Notice of Cancellation* stating therein the reasons for such cancellation and the effective date of cancellation at least thirty days past notification.
- 2.40. Employment Discrimination:** During the performance of any services per agreement with the Owner, the Offeror, by submitting a Proposal, agrees to the following conditions:
- 2.40.1. The Offeror shall not discriminate against any employee or applicant for employment because of race, religion, color, sex, age, disability, citizenship status, marital status, veteran status, sexual orientation, national origin, or any legally protected status except when such condition is a legitimate occupational qualification reasonably necessary for the normal operations of the Offeror. The Offeror agrees to post in conspicuous places, visible to employees and applicants for employment, notices setting forth the provisions of this nondiscrimination clause.
- 2.40.2. The Offeror, in all solicitations or advertisements for employees placed by or on behalf of the Offeror, shall state that such Offeror is an Equal Opportunity Employer.
- 2.40.3. Notices, advertisements, and solicitations placed in accordance with federal law, rule, or regulation shall be deemed sufficient for the purpose of meeting the requirements of this section.
- 2.41. Affirmative Action:** In executing a Contract with the City, the Contractor agrees to comply with Affirmative Action and Equal Employment Opportunity regulations presented in the General Contract Conditions.
- 2.42. Immigration Reform and Control Act of 1986 and Immigration Compliance:** The Offeror certifies that it does not and will not during the performance of the contract employ illegal alien workers or otherwise violate the provisions of the Federal Immigration

Reform and Control Act of 1986 and/or the immigration compliance requirements of State of Colorado C.R.S. § 8-17.5-101, *et. seq.* (House Bill 06-1343).

- 2.43. Ethics:** The Offeror shall not accept or offer gifts or anything of value nor enter into any business arrangement with any employee, official, or agent of the Owner.
- 2.44. Failure to Deliver:** In the event of failure of the Offeror to deliver services in accordance with the contract terms and conditions, the Owner, after due oral or written notice, may procure the services from other sources and hold the Offeror responsible for any costs resulting in additional purchase and administrative services. This remedy shall be in addition to any other remedies that the Owner may have.
- 2.45. Failure to Enforce:** Failure by the Owner at any time to enforce the provisions of the contract shall not be construed as a waiver of any such provisions. Such failure to enforce shall not affect the validity of the contract or any part thereof or the right of the Owner to enforce any provision at any time in accordance with its terms.
- 2.46. Force Majeure:** The Offeror shall not be held responsible for failure to perform the duties and responsibilities imposed by the contract due to legal strikes, fires, riots, rebellions, and acts of God beyond the control of the Offeror, unless otherwise specified in the contract.
- 2.47. Indemnification:** Offeror shall defend, indemnify and save harmless the Owner and all its officers, employees, insurers, and self-insurance pool, from and against all liability, suits, actions, or other claims of any character, name and description brought for or on account of any injuries or damages received or sustained by any person, persons, or property on account of any negligent act or fault of the Offeror, or of any Offeror's agent, employee, subcontractor or supplier in the execution of, or performance under, any contract which may result from proposal award. Offeror shall pay any judgment with cost which may be obtained against the Owner growing out of such injury or damages.
- 2.48. Independent Firm:** The Offeror shall be legally considered an Independent Firm and neither the Firm nor its employees shall, under any circumstances, be considered servants or agents of the Owner. The Owner shall be at no time legally responsible for any negligence or other wrongdoing by the Firm, its servants, or agents. The Owner shall not withhold from the contract payments to the Firm any federal or state unemployment taxes, federal or state income taxes, Social Security Tax or any other amounts for benefits to the Firm. Further, the Owner shall not provide to the Firm any insurance coverage or other benefits, including Workers' Compensation, normally provided by the Owner for its employees.
- 2.49. Nonconforming Terms and Conditions:** A proposal that includes terms and conditions that do not conform to the terms and conditions of this Request for Proposal is subject to rejection as non-responsive. The Owner reserves the right to permit the Offeror to withdraw nonconforming terms and conditions from its proposal prior to a determination by the Owner of non-responsiveness based on the submission of nonconforming terms and conditions.

- 2.50. Ownership:** All plans, prints, designs, concepts, etc., shall become the property of the Owner.
- 2.51. Oral Statements:** No oral statement of any person shall modify or otherwise affect the terms, conditions, or specifications stated in this document and/or resulting agreement. All modifications to this request and any agreement must be made in writing by the Owner.
- 2.52. Patents/Copyrights:** The Offeror agrees to protect the Owner from any claims involving infringements of patents and/or copyrights. In no event shall the Owner be liable to the Offeror for any/all suits arising on the grounds of patent(s)/copyright(s) infringement. Patent/copyright infringement shall null and void any agreement resulting from response to this RFP.
- 2.53. Remedies:** The Offeror and Owner agree that both parties have all rights, duties, and remedies available as stated in the Uniform Commercial Code.
- 2.54. Venue:** Any agreement as a result of responding to this RFP shall be deemed to have been made in, and shall be construed and interpreted in accordance with, the laws of the City of Grand Junction, Mesa County, Colorado.
- 2.55. Expenses:** Expenses incurred in preparation, submission and presentation of this RFP are the responsibility of the company and can not be charged to the Owner.
- 2.56. Sovereign Immunity:** The Owner specifically reserves its right to sovereign immunity pursuant to Colorado State Law as a defense to any action arising in conjunction to this agreement.
- 2.57. Public Funds/Non-Appropriation of Funds:** Funds for payment have been provided through the Owner's budget approved by the City Council/Board of County Commissioners for the stated fiscal year only. State of Colorado statutes prohibit the obligation and expenditure of public funds beyond the fiscal year for which a budget has been approved. Therefore, anticipated orders or other obligations that may arise past the end of the stated Owner's fiscal year shall be subject to budget approval. Any contract will be subject to and must contain a governmental non-appropriation of funds clause.
- 2.58. Collusion Clause:** Each Offeror by submitting a proposal certifies that it is not party to any collusive action or any action that may be in violation of the Sherman Antitrust Act. Any and all proposals shall be rejected if there is evidence or reason for believing that collusion exists among the proposers. The Owner may or may not, at the discretion of the Owner Purchasing Representative, accept future proposals for the same service or commodities for participants in such collusion.
- 2.59. Gratuities:** The Contractor certifies and agrees that no gratuities or kickbacks were paid in connection with this contract, nor were any fees, commissions, gifts or other considerations made contingent upon the award of this contract. If the Contractor breaches or violates this warranty, the Owner may, at their discretion, terminate this contract without liability to the Owner.

- 2.60. Safety Warranty:** Offeror also warrants that the services performed shall conform to the standards declared by the US Department of Labor under the Occupational Safety and Health Act of 1970.
- 2.61. OSHA Standards:** All Offerors agree and warrant that services performed in response to this invitation shall conform to the standards declared by the US Department of Labor under the Occupational Safety and Health Act of 1970 (OSHA). In the event the services do not conform to OSHA Standards, the Owner may require the services to be redone at no additional expense to the Owner.
- 2.62. Performance of the Contract:** The Owner reserves the right to enforce the performance of the contract in any manner prescribed by law or deemed to be in the best interest of the Owner in the event of breach or default of resulting contract award.
- 2.63. Benefit Claims:** The Owner shall not provide to the Offeror any insurance coverage or other benefits, including Worker's Compensation, normally provided by the Owner for its employees.
- 2.64. Default:** The Owner reserves the right to terminate the contract in the event the Contractor fails to meet delivery or completion schedules, or otherwise perform in accordance with the accepted proposal. Breach of contract or default authorizes the Owner to purchase like services elsewhere and charge the full increase in cost to the defaulting Offeror.
- 2.65. Multiple Offers:** If said proposer chooses to submit more than one offer, THE ALTERNATE OFFER must be clearly marked "Alternate Proposal". The Owner reserves the right to make award in the best interest of the Owner.
- 2.66. Cooperative Purchasing:** Purchases as a result of this solicitation are primarily for the Owner. Other governmental entities may be extended the opportunity to utilize the resultant contract award with the agreement of the successful provider and the participating agencies. All participating entities will be required to abide by the specifications, terms, conditions and pricings established in this Proposal. The quantities furnished in this proposal document are for only the Owner. It does not include quantities for any other jurisdiction. The Owner will be responsible only for the award for our jurisdiction. Other participating entities will place their own awards on their respective Purchase Orders through their purchasing office or use their purchasing card for purchase/payment as authorized or agreed upon between the provider and the individual entity. The Owner accepts no liability for payment of orders placed by other participating jurisdictions that choose to piggy-back on our solicitation. Orders placed by participating jurisdictions under the terms of this solicitation will indicate their specific delivery and invoicing instructions.
- 2.67. Definitions:**
- 2.67.1. "Consultant" refers to the person, partnership, firm or corporation entering into an Agreement with the Owner for the services required and the legal representatives of said party or the agent appointed to act for said party in the performance of the service(s) contracted for.

- 2.67.2. "Offeror" refers to the person or persons legally authorized by the Consultant to make an offer and/or submit a bid (fee) proposal in response to the Owner's RFP.
- 2.67.3. The term "Work" includes all labor necessary to produce the requirements by the Contract Documents, and all materials and equipment incorporated or to be incorporated in such construction.
- 2.67.4. "Sub-Contractor" is a person or organization who has a direct contract with the Contractor to perform any of the work at the site. The term sub-contractor is referred to throughout the contract documents and means a sub-contractor or his authorized representative.
- 2.67.5. "Owner" is the City of Grand Junction/Mesa County, Colorado and is referred to throughout the Contract Documents. The term Owner means the Owner or his authorized representative. The Owner shall, at all times, have access to the work wherever it is in preparation and progress. The Contractor shall provide facilities for such access. The Owner will make periodic visits to the site to familiarize himself generally with the progress and quality of work and to determine, in general, if the work is proceeding in accordance with the contract documents. Based on such observations and the Contractor's Application for Payment, the Owner will determine the amounts owing to the Contractor and will issue Certificates for Payment in such amounts, as provided in the contract. The Owner will have authority to reject work which does not conform to the Contract documents. Whenever, in his reasonable opinion, he considers it necessary or advisable to insure the proper implementation of the intent of the Contract Documents, he will have authority to require the Contractor to stop the work or any portion, or to require special inspection or testing of the work, whether or not such work can be then be fabricated, installed, or completed. The Owner will not be responsible for the acts or omissions of the Contractor, and sub-Contractor, or any of their agents or employees, or any other persons performing any of the work.
- 2.67.6. "Contractor" is the person or organization identified as such in the Agreement and is referred to throughout the Contract Documents. The term Contractor means the Contractor or his authorized representative. The Contractor shall carefully study and compare the General Contract Conditions of the Contract, Specification and Drawings, Scope of Work, Addenda and Modifications and shall at once report to the Owner any error, inconsistency or omission he may discover. Contractor shall not be liable to the Owner for any damage resulting from such errors, inconsistencies or omissions. The Contractor shall not commence work without clarifying Drawings, Specifications, or Interpretations.
- 2.67.7. "Sub-Contractor" is a person or organization who has a direct contract with the Contractor to perform any of the work at the site. The term sub-contractor is referred to throughout the contract documents and means a sub-contractor or his authorized representative.

2.68. Public Disclosure Record: If the Proposer has knowledge of their employee(s) or sub-proposers having an immediate family relationship with an Owner employee or elected official, the proposer must provide the Purchasing Representative with the name(s) of these individuals. These individuals are required to file an acceptable "Public Disclosure Record", a statement of financial interest, before conducting business with the Owner.

2.69. Keep Jobs in Colorado Act: Contractor shall be responsible for ensuring compliance with Article 17 of Title 8, Colorado Revised Statutes requiring 80% Colorado labor to be employed on public works. Contractor shall, upon reasonable notice provided by the Owner, permit the Owner to inspect documentation of identification and residency required by C.R.S. §8-17-101(2)(a). If Contractor claims it is entitled to a waiver pursuant to C.R.S. §8-17-101(1), Contractor shall state that there is insufficient Colorado labor to perform the work such that compliance with Article 17 would create an undue burden that would substantially prevent a project from proceeding to completion, and shall include evidence demonstrating the insufficiency and undue burden in its response.

Unless expressly granted a waiver by the Owner pursuant to C.R.S. §8-17-101(1), Contractor shall be responsible for ensuring compliance with Article 17 of Title 8, Colorado Revised Statutes requiring 80% Colorado labor to be employed on public works. Contractor shall, upon reasonable notice provided by the Owner, permit the Owner to inspect documentation of identification and residency required by C.R.S. §8-17- 101(2)(a).

"Public project" is defined as:

- (a) any construction, alteration, repair, demolition, or improvement of any land, building, structure, facility, road, highway, bridge, or other public improvement suitable for and intended for use in the promotion of the public health, welfare, or safety and any maintenance programs for the upkeep of such projects
- (b) for which appropriate or expenditure of moneys may be reasonably expected to be \$500,000.00 or more in the aggregate for any fiscal year
- (c) except any project that receives federal moneys.

SECTION 3.0: INSURANCE REQUIREMENTS

3.1 Insurance Requirements: The selected Firm agrees to procure and maintain, at its own cost, policy(s) of insurance sufficient to insure against all liability, claims, demands, and other obligations assumed by the Firm pursuant to this Section. Such insurance shall be in addition to any other insurance requirements imposed by this Contract or by law. The Firm shall not be relieved of any liability, claims, demands, or other obligations assumed pursuant to this Section by reason of its failure to procure or maintain insurance in sufficient amounts, durations, or types.

Firm shall procure and maintain and, if applicable, shall cause any Subcontractor of the Firm to procure and maintain insurance coverage listed below. Such coverage shall be procured and maintained with forms and insurers acceptable to The Owner. All coverage shall be continuously maintained to cover all liability, claims, demands, and other obligations assumed by the Firm pursuant to this Section. In the case of any claims-made policy, the necessary retroactive dates and extended reporting periods shall be procured to maintain such continuous coverage. Minimum coverage limits shall be as indicated below unless specified otherwise in the Special Conditions:

(a) **Worker Compensation:** Contractor shall comply with all State of Colorado Regulations concerning Workers' Compensation insurance coverage.

(b) **General Liability insurance with minimum combined single limits of:**

ONE MILLION DOLLARS (\$1,000,000) each occurrence and
ONE MILLION DOLLARS (\$1,000,000) per job aggregate.

The policy shall be applicable to all premises, products and completed operations. The policy shall include coverage for bodily injury, broad form property damage (including completed operations), personal injury (including coverage for contractual and employee acts), blanket contractual, products, and completed operations. The policy shall include coverage for explosion, collapse, and underground (XCU) hazards. The policy shall contain a severability of interests provision.

(c) Comprehensive Automobile Liability insurance with minimum combined single limits for bodily injury and property damage of not less than:

ONE MILLION DOLLARS (\$1,000,000) each occurrence and
ONE MILLION DOLLARS (\$1,000,000) aggregate

(d) Professional Liability & Errors and Omissions Insurance policy with a minimum of:
ONE MILLION DOLLARS (\$1,000,000) per claim

This policy shall provide coverage to protect the contractor against liability incurred as a result of the professional services performed as a result of responding to this Solicitation.

With respect to each of Consultant's owned, hired, or non-owned vehicles assigned to be used in performance of the Work. The policy shall contain a severability of interests provision.

- 3.2** Additional Insured Endorsement: The policies required by paragraphs (b) above shall be endorsed to include the Owner and the Owner's officers and employees as additional insureds. Every policy required above shall be primary insurance, and any insurance carried by the Owner, its officers, or its employees, or carried by or provided through any insurance pool of the Owner, shall be excess and not contributory insurance to that provided by Contractor. The Contractor shall be solely responsible for any deductible losses under any policy required above.

SECTION 4.0: SPECIFICATIONS/SCOPE OF SERVICES

- 4.1. General:** The general scope of services to be obtained as a result of this RFP includes preconstruction services, value engineering, construction management ("CM") and general contractor ("GC") services relative to the construction of the new Fire Station #6 (**NOTE: This new station shall be based off of existing Fire Station #4 plans, that shall be modified for the new Fire Station #6.**) The selected CM/GC will work collaboratively with Owner's architect and City project staff. The selection of the CM/GC is expected to be concluded and approved by the City Council in November of 2019.

The time line for this project is ambitious. All planning, design and construction efforts will be expedited to the extent possible. The Owner intends to establish a Not to Exceed Price for all Pre-Construction Services, and a Guaranteed Maximum Price for the Construction portion of this project.

- 4.2.** The total project budget (including design and construction) is estimated at approximately \$3,200,000.

4.3. Designer: The Owner has selected Chamberlin Architects as the design firm for this project. The Owner shall require maximum collaboration by the Architect, the Construction Manager/General Contractor and the Owner's project staff to insure value engineering through constructability assessments, during the preconstruction phase, as well as the construction phase of the project.

4.4. Special Conditions/Provisions:

4.4.1 Term of Contract: By submitting a response to this RFP, the proposer agrees and understands that payments pursuant to this Contract are subject to and contingent upon the continuing availability of funds for the purposes herein. If such funds become unavailable, the Council may terminate all or part of this Contract immediately without further liability.

4.4.2 Pricing/Fees: Pricing shall be all inclusive to include but not be limited to: all labor, equipment, supplies, materials, freight (F.O.B. Destination – Freight Pre-paid and Allowed to each site), all design related services, travel, mobilization costs, fuel, set-up and take down costs, and full-time inspection costs, and all other costs related to the successful completion of the project.

The Owner shall not pay nor be liable for any other additional costs including but not limited to: taxes, shipping charges, insurance, interest, penalties, termination payments, attorney fees, liquidated damages, etc.

Contractor shall submit pricing as follows: Not to Exceed Price for all Pre-Construction Services for this project; and % of OH&P for Construction Services for this project. The Owner intends to establish a Guaranteed Maximum Price for the construction portion of this project.

Also see Section 5.0, paragraph I.

4.5. Scope of Services: The general scope of services to be obtained as a result of this RFP includes preconstruction and Construction Services. These services shall consist of the following: (also see attached complete "as-built" drawings for Fire Station #4, which Fire Station #6 shall be based on).

Pre-Construction Services

- a. Design Consultation During Project Development – Attend regularly scheduled meetings (as needed) with the Architect and the City during design development, and development of construction documents, to advise on site use and improvements, selection of materials, building systems and equipment. Provide recommendations on construction feasibility, availability of materials and labor, time requirements for installation and construction and factors related to cost including alternative designs or materials, preliminary budgets and possible economies. Consult with the City and the Architect to finalize construction-phasing plans based upon the preliminary project plan included with the Construction Manager's original proposal. Present schedule and cost associated with each plan. The Construction Phasing Plan must consider construction feasibility, availability of materials and labor, coordination with the City's on-going activities on the

Project sites, and other factors related to time, cost and safety.

- b. Scheduling – Develop a Project Time Schedule that coordinates and integrates the Architect’s design efforts with construction schedules. Update the Project Time Schedule incorporating details for the construction operations of the project, including realistic activity sequences and durations, allocation of labor and materials, processing of shop drawings, and samples and delivery of products requiring long lead-time procurement. The schedule shall include the City’s other construction activities (i.e. Abatement, FF&E, Data/Telecommunications and Temperature Controls) necessary for coordination and occupancy requirements showing portions of the Project having occupancy priority.
- c. Site Investigation – After receiving Construction Documents, Construction Manager shall conduct a walkthrough of the project to familiarize itself with the proposed Scope of Work and document the existing conditions of the facilities and/or site. The Construction Manager shall provide a written report to the City of any discrepancies or issues and their affects to the project identified during the site investigation walk through.
- d. Construction Estimate – Prepare a construction estimate for the work based on a quantity survey of drawings and available specifications. Update and refine the construction estimate for the City’s approval and acceptance as the development of the drawings and specifications proceeds. Provide detailed construction costs estimates at the completion of 100% Schematic Design (SD) and 100% Design Development (DD) documents produced by the Architect. Estimate shall include the bid amounts and construction contingencies.
- e. Guaranteed Maximum Price shall be submitted for approval upon completion of the Construction Documents.
- f. Value Engineering (VE) – At the end of both Schematic Design (SD) and Design Development (DD), Construction Manager shall complete a technical review and analysis of systems and materials being considered in the design to produce the greatest value for the least cost, including life cycle analysis.
 - (1) Design Review/Coordination of Contract Documents – Conduct a formal review of 100% Design Development documents produced by the Architect. These reviews shall address estimated cost, completeness of design, coordination of documents, and construction feasibility and work phasing and shall include detailed reviews of the structural, mechanical, plumbing and electrical work described. A written report of findings, including recommended revisions and/or value engineering proposals, shall be submitted to the City and the Architect within one week of receipt of said documents. Verify that all identified deficiencies and/or revisions authorized by the City are acknowledged by the Architect and incorporated in all subsequent documents presented and in the final Construction Documents.
- g. Construction Logistic Plan – Throughout the course of design & bidding, develop (with the input from the Architect and City) options regarding the execution of the work that will be performed within the existing occupied facility. Upon the completion of design, and as part of the amendments to the contract sum, document and/or identify in the

appropriate detail as required and/or approved by the City, construction sequencing and actions required to mitigate adverse effects to ongoing daily operations of areas affected by construction activities.

- h. Subcontractor Pre-Qualification – Develop and implement a subcontractor pre-qualification process, with the cooperation and approval of the City and the Architect. Recommend early pre-qualification of critical subcontractors as deemed advisable, especially for mechanical and electrical work.
- i. Labor – Analyze the types, quantity and availability of appropriate categories of labor required for various phases of the Project.
- j. Bidding – The Construction Manager shall establish bidding schedules and conduct pre-bid conferences to familiarize bidders with bidding documents, management techniques and any special systems, materials or methods. Solicit and receive competitive and responsible bids on the Work from qualified subcontractors and materials suppliers, pursuant to bidding procedures acceptable to the City.
- k. Conferences – In concert with the City and the Architect, conduct pre-construction conferences with successful subcontractors.

Construction Services

- a. Pre-Construction Conference – Prior to the commencement of work, the Construction Manager shall submit to the Architect and the City in reasonable detail and format acceptable to the Architect and the City, copies of the following documents:
 - 1. Submittal log and schedule.
 - 2. Request for Information (RFI) form and log format.
 - 3. Request for Change Order form and log format.
 - 4. List of inspections required by the Contract Documents.
 - 5. Quality Control (QC) plan.
 - 6. Safety plan.
 - 7. Copies of required permits.

Upon review of the above documents by the Architect and the City, the Construction Manager shall facilitate a Pre-Construction Conference and establish project procedures and construction schedules.

- b. Project Control – Supervise the Work of the subcontractors and coordinate the Work with the activities and responsibilities of the City and Architect in order to complete the Project in accordance with the City's objectives of cost, time and quality.
- c. Staffing – Maintain, at the Project site, a competent staff as approved by the City, to coordinate, provide overall direction of the Work, and monitor progress of the subcontractors on the Project. Assign to the Project, for the duration of the Work through correction of punch-list, a full-time competent Superintendent and any necessary assistants, as satisfactory to the City, in accordance with executed Amendments and/or Construction Managers General Conditions. The Superintendent

shall not be changed except with the consent of the City. The Superintendent shall see that the Work is carried out in accordance with the Contract Documents and shall be full time and/or shall be present on the project site during the execution of all work associated with this Agreement unless authorized by the City.

- d. Organization – Establish, document and communicate an on-site organization and lines of authority in order to carry out the overall plans of the Project team.
- e. Coordination – Establish and implement procedures for coordination among the City, Architect, subcontractors and the Construction Manager with respect to all aspects of the Project. Schedule and conduct weekly progress meetings with the Architect and the City. Construction Manager shall be responsible for recording and distribution of meeting minutes
- f. Schedule Monitoring and Updating– Provide regular monitoring and monthly updating of the schedule as construction progresses. Identify potential variances between scheduled and projected completion dates. Review schedule for work not started or incomplete, and recommend to the City and Architect, subcontractors adjustments in the schedule to meet the scheduled completion date.
- g. Change Orders – Develop and implement a system for the expeditious review and processing of Change Orders. Propose necessary or desirable changes in the Scope of Work to the City and the Architect, review requests for changes, submit recommendations to the City and the Architect and negotiate Change Orders with subcontractors.
- h. Permits – Secure all necessary permits, licenses and inspections for the proposed completion and execution of the Work. Coordinate and schedule all inspections. Create and maintain a log of all inspection including copies of all “sign-offs.”
- i. City’s Consultants/Contractors – If required, assist the City in the coordination of a surveyor, testing laboratories other special consultants, telecom/data, temperature controls and other contractors contracted directly to the City involved with work associated with contract documents.
- j. Safety Measures – Establish procedures and measures for the safety of persons and property at and around the site of the Work. Assure compliance with all federal, state and local statutes, rules, regulations and orders applicable to the conduct of the Work.
- k. Quality Control Program – The Construction Manager shall establish and maintain a Quality Control (QC) Program specific to the Project. The QC program shall consist of the Construction Manager’s QC organization, the project specific QC plan, QC meetings, the phases of control, submittal review and approval, testing and inspections, and documentation necessary to provide materials, equipment, workmanship, fabrication, construction and operations compliance with the requirements of the Contract Documents.

Quality Control is the responsibility of the Construction Manager. This Quality Control is not to be mistaken for the Quality Assurance Program provided by the City (construction materials testing & Inspection services, Architect/Engineer observations,

City roofing consultant, City test & balance services, etc.. These City-provided inspection and/or observation services are for the purpose of verifying the Construction Manager's Quality Control.

- l. Contract Interpretations – Refer all questions, in writing, relative to interpretations of design intent to the Architect. Construction Manager shall implement an effective system for recording and tracking questions (RFI) and responses through final resolution and distribution to all parties concerned. At the weekly progress meeting, Construction Manager is to identify any critical questions (RFI) that may impact either schedule, cost or quality of the Project.
 - m. Material Submittals, Shop Drawings and Samples – In collaboration with the Architect, establish and implement procedures for expediting the processing and approval of material submittals, shop drawings and samples.
 - n. Reports and Project Site Documents – Record the daily progress of the Project in a daily log available to the City and the Architect. Submit, on a weekly basis, written progress reports and summaries of meetings to the City and the Architect, including information of the subcontractors' work, labor resource levels by trade, safety violations, inspections or tests and the percentage of completion of item relative to the Project Schedule.
 - o. Record Documents – Maintain at the Project site, on a current basis, records of all contracts, shop drawings, samples, purchases, materials, equipment, maintenance and operating manuals and instructions and any other documents and revisions thereto which arise out of the Project or the Work.
 - p. Start-Up and Training - With the City's maintenance personnel, schedule and direct the checkout of utilities, operating systems and equipment for readiness and assist in their initial start-up and testing by the appropriate subcontractor, representative or authority.
 - q. Attic Stock - Turn over to the City all keys and maintenance/attic stocks required by the Contract Documents.
 - r. Warranty – During the one-year warranty period, which starts at the date of Substantial Completion, perform two (2) warranty inspections, 1 each at 6 months and 11 months, and ensure that Work which proves defective or deficient during such time is corrected either by the subcontractors or such other means as shall be required. Administer the one-year warranty period by the City's Warranty Work Request process.
- 4.6. Mandatory Pre-Proposal Briefing:** A **mandatory** pre-proposal briefing is required by all contractors intending to submit a response to this RFP. Any contractor that does not attend the **mandatory** pre-proposal briefing shall not be eligible to submit a response to this RFP. **The pre-proposal briefing shall be held at City Hall Auditorium, 250 N. 5th Street, Grand Junction, CO on October 2, 2019 at 2:30pm.**

4.7. RFP Tentative Time Schedule:

- Request for Proposal available September 23, 2019
- Mandatory Pre-Proposal Meeting October 2, 2019
- Inquiry deadline, no questions after this date October 9, 2019
- Addendum Posted October 10, 2019
- Submittal deadline for proposals October 17, 2019
- Owner evaluation of proposals October 18-23, 2019
- Interviews (if required) October 30, 2019
- Final selection November 1, 2019
- City Council Approval November 20, 2019
- Contract execution November 21, 2019

4.8. Questions Regarding Scope of Services:

Duane Hoff Jr., Senior Buyer
duaneh@gjcity.org

SECTION 5.0: PREPARATION AND SUBMITTAL OF PROPOSALS

Submission: Each proposal shall be submitted in electronic format only, and only through the Rocky Mountain E-Purchasing website (<https://www.rockymountainbidssystem.com/default.asp>). This site offers both “free” and “paying” registration options that allow for full access of the Owner’s documents and for electronic submission of proposals. (Note: “free” registration may take up to 24 hours to process. Please Plan accordingly.) Please view our “**Electronic Vendor Registration Guide**” at <http://www.gjcity.org/BidOpenings.aspx> for details. (Purchasing Representative does not have access or control of the vendor side of RMEPS. If website or other problems arise during response submission, vendor **MUST** contact RMEPS to resolve issue prior to the response deadline **800-835-4603**). For proper comparison and evaluation, the City requests that proposals be formatted as directed in Section 5.0 “Preparation and Submittal of Proposals.” Offerors are required to indicate their interest in this Project, show their specific experience and address their capability to perform the Scope of Services in the Time Schedule as set forth herein. For proper comparison and evaluation, the Owner requires that proposals be formatted **A to I**:

- A. Cover Letter:** Cover letter shall be provided which explains the Firm’s interest in the project. The letter shall contain the name/address/phone number/email of the person who will serve as the firm’s principal contact person with Owner’s Contract Administrator and shall identify individual(s) who will be authorized to make presentations on behalf of the firm. The statement shall bear the signature of the person having proper authority to make formal commitments on behalf of the firm. By submitting a response to this solicitation the Contractor agrees to all requirements herein.
- B. Qualifications/Experience/Credentials:** Proposers shall provide their qualifications (to include specifics to Fire Stations) for consideration as a contract provider to the City of Grand Junction and include prior experience in similar projects. Information provided shall include but is not limited to:
- Organizational chart of company and/or project team
 - Identification of key personnel
 - Professional qualifications, resumes and functions of personnel who will be assigned to the project
 - Specific related project experience of personnel
 - Personnel availability and time commitment proposed to meet the project schedule
- C. Strategy and Implementation Plan:** Describe your (the firm’s) interpretation of the Owner’s objectives with regard to this RFP. Describe your proposed CM/GC management strategy and/or plan for achieving the objectives of this RFP. Provide examples of control systems you propose to use in the execution of this project:
- Cost control
 - Schedule control
 - Quality control (value engineering, methodology)
 - Value Engineering

The Firm may utilize a written narrative or any other printed technique to demonstrate their ability to satisfy the Scope of Services. The narrative should describe a logical progression of tasks and efforts starting with the initial steps or tasks to be accomplished and

continuing until all proposed tasks are fully described and the RFP objectives are accomplished. Include a **time schedule** for completion of your firm's implementation plan and an estimate of time commitments from Owner staff.

- D. Current and Anticipated Workload:** Describe your current workload and expectations in coordinating your current projects, anticipated projects and this project.
- E. Capability/Performance:** Provide brief project descriptions and histories that delineate your ability for at least four (4) projects completed in the past five years with a similar size and scope to this project. Provide as a minimum:
- Project description
 - Project budget at SD and DD
 - Guaranteed Maximum Price
 - Total dollar amount of change orders (exclusive of change of scope change orders)
 - Completed project cost inclusive of all change orders, final contractor fees, and general conditions.
 - Gross square footage, number of stories, and number of parking spaces
 - Major structural system(s)
 - Special or unique conditions, systems, characteristics, etc.
 - Original and actual construction schedule comparisons
 - Owner's representative name and contact information
- F. Bonding Capacity:** Provide proof of bonding capacity for this project including CM/GC fees along with current and anticipated project workloads.
- G. References:** A minimum of three (4) **references** with name, address, telephone number, and email address that can attest to your experience CM/GC projects of similar scope and size.
- H. Fee Proposal:** The construction duration for this project will be determined during the course of design and the development of the "Construction Logistics Plan". Contractor shall submit pricing as follows: Not to Exceed Price for all Pre-Construction Services for this project; and % of OH&P for Construction Services for this project. The Owner intends to establish a Guaranteed Maximum Price for the construction portion of this project. Include the following:
- 1. Fee & Pre-Construction Services**

The Construction Manager fee shall be all inclusive, and include all job indirect costs, home office overhead and profit, including, but not limited, to the following:

- a Salaries benefits and taxes or other compensation of the Construction Manager's employees at the principal office and branch offices;
- b General operating expenses of the Construction Manager's principal and branch offices other than the field office;
- c Any part of the Construction Manager's capital expenses, including interest on the Construction Manager's capital employed for the Project;

- d Overhead or general expenses of any kind;
- e Salaries of the Construction Manager's principal(s) or branch office employees when at the field office in whatever capacity employed and such employees when engaged on the road in expediting the production or transportation of materials and equipment;
- f Cost of data processing services required in the performance of the Work;
- g Cost of the premium for all insurance which the Construction Manager is required to procure by this Agreement or is deemed necessary by the Construction Manager;
- h Minor expenses such as facsimile messages, telegrams, long distance telephone calls, express mailing and similar petty cash items in connection with Pre-construction and/or the Construction Services;

2. General Conditions

The Construction Manager General Conditions shall include all job direct onsite management costs including, but not limited, to the following:

- a Onsite Staff – Project Manager, Project Superintendent, Assistant Superintendent(s), Office/Field Engineers, Field Inspectors, and Secretary. All onsite employees of the Construction Manager with the exception of self-performed work authorized by the City and bid in accordance with this agreement, shall be considered staff and shall be identified within the General Conditions and not part of the “Direct Cost of the Work”.
 - b Onsite Equipment and office expenses – personal computers, copy machine, fax machine, first aid supplies, office or trailer rental, storage trailer, telephones, generators (for construction manager’s office), radios and office furniture, facsimile messages, telegrams, long distance telephone calls and mailings;
 - c Onsite Services – temporary toilets, project sign, bulletin boards, street / walk / parking lot cleaning / snow removal and trash removal;
 - d Onsite Utilities – temporary enclosures / weather protection, temporary building heat, temporary electrical service, temporary gas and power charges and temporary water;
 - e Safety – safety programs, handrails and toe boards, fire extinguishers, temporary stairs, construction fencing and covered walkways;
 - f Insurance and Bonds – errors and omissions, general liability, workers’ compensation, FICA, federal and state unemployment and performance and payment bonds and builders risk;
 - g Miscellaneous – project photographs, warranty inspection and coordination.
- I. **Additional Data (optional):** Provide any additional information that will aid in evaluation of your qualifications with respect to this project.

SECTION 6.0: EVALUATION CRITERIA AND FACTORS

- 6.1 Evaluation:** An evaluation team shall review all responses and select the proposal or proposals that best demonstrate the capability in all aspects to perform the scope of services and possess the integrity and reliability that will ensure good faith performance.
- 6.2 Intent:** Only respondents who meet the qualification criteria will be considered. Therefore, it is imperative that the submitted proposal clearly indicate the firm's ability to provide the services described herein.

Submittal evaluations will be done in accordance with the criteria and procedure defined herein. The Owner reserves the right to reject any and all portions of proposals and take into consideration past performance. The following parameters will be used to evaluate the submittals (in no particular order of priority):

- Responsiveness of submittal to the RFP
- Understanding of the project and the objectives
- Experience/Performance CM/GC (to include specifics to Fire Stations)
- Necessary resources/Capacity & Availability
- Strategy & Implementation Plan
- References
- Fees

Owner also reserves the right to take into consideration past performance of previous awards/contracts with the Owner of any vendor, contractor, supplier, or service provider in determining final award(s).

The Owner will undertake negotiations with the top rated firm and will not negotiate with lower rated firms unless negotiations with higher rated firms have been unsuccessful and terminated.

- 6.3 Oral Interviews:** The Owner may invite the most qualified rated proposers to participate in oral interviews.
- 6.4 Award:** Firms shall be ranked or disqualified based on the criteria listed in Section 6.2. The Owner reserves the right to consider all of the information submitted and/or oral presentations, if required, in selecting the project Contractor.

SECTION 7.0: SOLICITATION RESPONSE FORM

Bid Date: _____

Project: RFP-4703-19-DH "City of Grand Junction Fire Station #6 CM/GC"

Bidding Company: _____

Name of Authorized Agent: _____

Email _____

Telephone _____ **Address** _____

City _____ **State** _____ **Zip** _____

The undersigned Bidder, in compliance with the Request for Proposals, having examined the Instruction to Bidders, General Contract Conditions, Statement of Work, Specifications, and any and all Addenda thereto, having investigated the location of, and conditions affecting the proposed work, hereby proposes to furnish all labor, materials and supplies, and to perform all work for the Project in accordance with Contract Documents, within the time set forth and at the prices stated below. These prices are to cover all expenses incurred in performing the work required under the Contract Documents, of which this Solicitation Response Form is a part.

The undersigned Contractor does hereby declare and stipulate that this offer is made in good faith without collusion or connection to any person(s) providing an offer for the same work, and that it is made in pursuance of, and subject to, all terms and conditions of Solicitation Documents, all of which have been examined by the undersigned.

The Contractor also agrees that if awarded the Contract, to provide insurance certificates within ten (10) working days of the date of Notification of Award. Submittal of this offer will be taken by the Owner as a binding covenant that the Contractor will be prepared to complete the project in its entirety.

The Owner reserves the right to make the award on the basis of the offer deemed most favorable, to waive any formalities or technicalities and to reject any or all offers. It is further agreed that this offer may not be withdrawn for a period of sixty (60) calendar days after closing time. Submission of clarifications and revised offers automatically establish a new thirty day (30) period.

Prices in the proposal have not knowingly been disclosed with another provider and will not be prior to award.

- Prices in this proposal have been arrived at independently, without consultation, communication or agreement for the purpose of restricting competition.
- No attempt has been made nor will be to induce any other person or firm to submit a proposal for the purpose of restricting competition.
- The individual signing this proposal certifies they are a legal agent of the offeror, authorized to represent the offeror and is legally responsible for the offer with regard to supporting documentation and prices provided.
- Direct purchases by the City of Grand Junction are tax exempt from Colorado Sales or Use Tax. Tax exempt No. 98-903544. The undersigned certifies that no Federal, State, County or Municipal tax will be added to the quoted prices.
- City of Grand Junction payment terms shall be Net 30 days.
- Prompt payment discount of _____ percent of the net dollar will be offered to the Owner if the invoice is paid within _____ days after the receipt of the invoice.

RECEIPT OF ADDENDA: the undersigned Contractor acknowledges receipt of Addenda to the Solicitation, Scope of Services, and other Contract Documents.

State number of Addenda received: _____.

It is the responsibility of the Offeror to ensure all Addenda have been received and acknowledged.

By signing below, the Undersigned agree to comply with all terms and conditions contained herein.

Company: _____

Authorized Signature: _____

Title: _____


ORCHARD MESA FIRE STATION #4

GRAND JUNCTION, COLORADO

CHAMBERLIN ARCHITECTS
437 Main St.
Grand Junction, Colorado 81501
T 970.242.6804

725 Saint Joseph St., Suite B1
Rapid City, South Dakota 57701
T 605.355.6804

www.chamberlinarchitects.com

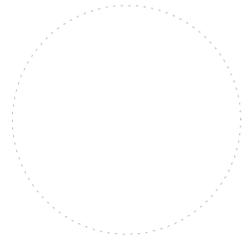

ORCHARD MESA FIRE STATION #4

GRAND JUNCTION, COLORADO

COVER SHEET

NO: ISSUED FOR: DATE:



PROJECT STATUS: 100% CDs

DRAWN BY: JW CHECKED BY: Checker

DATE: 04/10/2015 SHEET NO:


PROJECT NO: 1443 **G001**

LOCALITY MAP



BUILDING SITE

VICINITY MAP

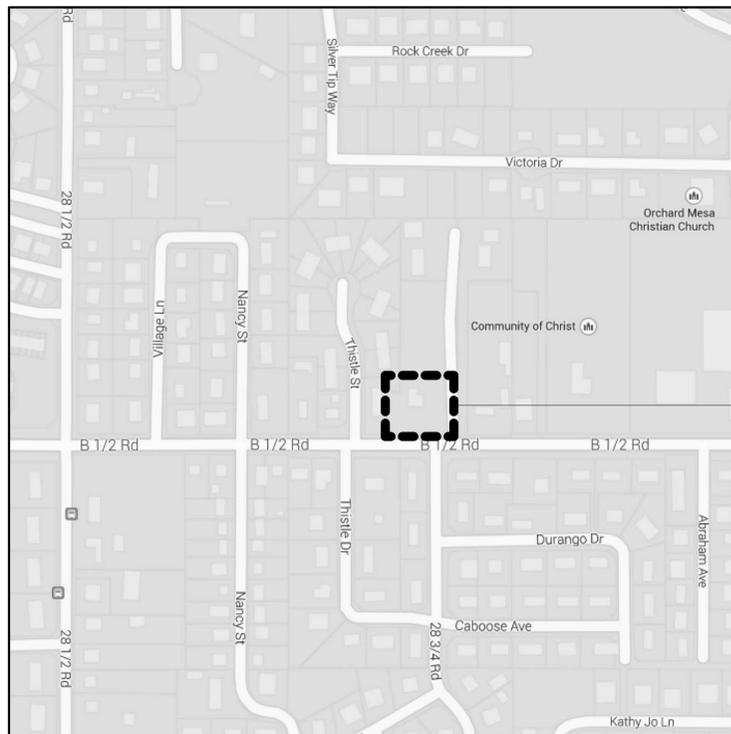

BUILDING SITE

OWNER

CITY OF GRAND JUNCTION
250 N. 5th Street
Grand Junction, CO 81501

DESIGN TEAM

ARCHITECT:
CHAMBERLIN ARCHITECTS
437 Main Street
Grand Junction, CO 81501
(970) 242-6804

CIVIL:
AUSTIN CIVIL GROUP
123 North 7th Street, Suite 300
GRAND JUNCTION, CO 81501
PHONE: (970) 242 -7540

LANDSCAPE:
JULIEE WOLVERTON
61945 Nighthawk Road
Montrose, CO 81403
(970) 249-9392

STRUCTURAL:
LINDAUER DUNN, INC
802 Rood Avenue
Grand Junction, CO 81501
(970) 241-0900

MECHANICAL:
RALSTON MECHANICAL CONSULTING, LLC
356 Echo Canyon Court
Grand Junction, CO 81507
(970) 434-9819

ELECTRICAL:
GRAND VALLEY ENGINEERING SOLUTIONS
2961 Circling Hawk Court
Grand Junction, CO 81503
(970) 256-0353

DRAWING LIST

GENERAL
G001 COVER SHEET

CIVIL
C-2 GENERAL NOTES & DETAILS
C-3 DEMOLITION PLAN
C-4 SITE PLAN
C-5 UTILITY PLAN
C-6 UTILITY DETAILS
C-7 HORIZONTAL CONTROL PLAN
C-8 OVERALL GRADING PLAN
C-9 GRADING PLAN SHEET 1
C-10 GRADING PLAN SHEET 2

LANDSCAPE
L101 LANDSCAPE PLAN
L201 LANDSCAPE ENLARGEMENT PLAN
L301 LANDSCAPE LEGENDS
L401 LANDSCAPE DETAILS

IRRIGATION
IR-101 IRRIGATION PLAN
IR-201 IRRIGATION LEGEND
IR-301 IRRIGATION NOTES & DETAILS
IR-302 IRRIGATION DETAILS

ARCHITECTURAL
A001 NOTES, SYMBOLS, ABBREVIATIONS AND WALL TYPES
A002 CODE CHECKLIST & LIFE SAFETY PLAN
A101 FLOOR PLAN
A121 REFLECTED CEILING PLAN
A141 ROOF PLAN
A151 FURNITURE, FIXTURES, AND EQUIPMENT
A161 INTERIOR FINISH PLAN
A201 EXTERIOR ELEVATIONS
A202 EXTERIOR ELEVATIONS
A301 ENLARGED FLOOR PLANS
A401 INTERIOR ELEVATIONS
A402 INTERIOR ELEVATIONS
A403 INTERIOR ELEVATIONS
A404 INTERIOR ELEVATIONS
A405 INTERIOR ELEVATIONS
A406 INTERIOR ELEVATIONS
A501 WALL SECTIONS
A502 WALL SECTIONS
A503 WALL SECTIONS
A504 WALL SECTIONS
A601 ARCHITECTURAL DETAILS

DRAWING LIST

A602 ARCHITECTURAL DETAILS
A603 ARCHITECTURAL DETAILS
A604 MONUMENT SIGN DETAILS
A621 CASEWORK DETAILS
A622 CASEWORK SECTIONS
A701 DOOR SCHEDULE, FRAME, DOOR, WINDOW & SIGN TYPES
A702 DOOR DETAILS
A721 WINDOW DETAILS
A741 COLOR SCHEDULE

STRUCTURAL
S100 GENERAL NOTES
S101 SCHEDULE OF SPECIAL INSPECTIONS
S102 FOUNDATION PLAN
S103 LOW ROOF FRAMING PLAN
S104 UPPER ROOF FRAMING PLAN
S200 TYPICAL FOUNDATION DETAILS
S201 MASONRY DETAILS
S202 CMU WALL ELEVATIONS
S203 CMU WALL ELEVATIONS
S204 TYPICAL STEEL FRAMING DETAILS
S205 TYPICAL WOOD FRAMING DETAILS
S300 FOUNDATION SECTIONS
S301 FRAMING SECTIONS
S302 FRAMING SECTIONS

MECHANICAL
M001 MECHANICAL SCHEDULES AND LEGEND
M101 MECHANICAL PLAN
M301 MECHANICAL DETAILS

PLUMBING
P101 PLUMBING PLAN
P201 ENLARGED PLUMBING PLAN & GAS PIPING SITE PLAN
P301 PLUMBING DETAILS

ELECTRICAL
E101 LEGEND, SITE PLAN, ONE LINE & DETAILS
E201 LIGHTING PLAN
E301 POWER PLAN
E302 LIGHTING PROTECTION & ROOF PLAN
E401 SYSTEMS PLAN
E402 ALERTING SYSTEM PLAN
E501 SCHEDULES
E502 SCHEDULES
E503 SCHEDULES
E504 SCHEDULES
E505 SCHEDULES

100% CONSTRUCTION DOCUMENTS

GENERAL CONSTRUCTION NOTES

- Locations of existing utilities shown on these plans are approximate only. Contractor is to contact affected utility for specific locations before digging.
- The Contractor shall notify the engineer if unanticipated conditions are encountered during completion of the work which require modifications to the contract drawings. The engineer can be reached at 970-242-7540.
- Contractor shall give 48-hour notice to all authorized inspectors, superintendents, or person in charge of public and private utilities affected by his operations prior commencement of work. Contractor shall assure himself that all construction permits are current.
- Contractor shall confine his construction operations to the right-of-way, easements, and lots, as shown on plans and plat. Any damage to private facilities outside these limits shall be repaired by the Contractor at no expense to the Owner.
- All road construction, related work, materials, performance and quality of work provided shall conform to the requirements of the City of Grand Junction Standard Specifications and Drawings and the applicable sections of the most current edition of the Division of Highways, State of Colorado Standard Specifications for Road and Bridge Construction, Colorado Standard Plans, Division of Highways M & S Standards.
- Contractor shall familiarize himself with the geotechnical testing requirements of the City of Grand Junction. The results of the required types of tests and numbers of passing tests shall be furnished to the Engineer for verification before final acceptance by the Owner will be granted. All failing tests shall be brought to the immediate attention of the Engineer and retests shall be performed until passing results are obtained. All utility lines, including service lines falling shall be tested.
- All earthwork operations shall be completed in accordance with the recommendations and requirements of the Geotechnical and Geologic Hazards Investigation Report by Huddleston-Berry, Project #00390-0003, dated November 20, 2014.
- Only materials on which a proctor test can be performed and accurate nuclear density tests can be run are approved for utility trench back fill unless otherwise approved by the Engineer.
- All utility installations within the City of Grand Junction jurisdiction are to be performed in accordance with the City of Grand Junction Standard Specifications for the Construction of Underground Utilities and Standard Details.
- All sewer lines must be tested and approved per Orchard Mesa Sanitation District requirements PRIOR to street construction. Contractor is required to notify the Owner's representative PRIOR to testing. The Owner's representative must be present to witness testing of water and sewer lines or the City will not approve the installation.

11. In the event of a discrepancy between the construction notes contained herein and the notes and details in the City of Grand Junction Standard Contract Documents for Capital Improvements Construction manual, the City's manual shall control.

12. All work within the City of Grand Junction Right-of-Way shall require a "Work in the Right-of-Way" Permit. All construction work shall be in accordance with the latest edition of the City of Grand Junction Standard Specifications.

13. All concrete shall have a minimum of 6: Class VI ABC, unless otherwise noted.

PAVING CONSTRUCTION NOTES

- All road widths and radii are to flow line unless noted otherwise. Any "spot" design elevations are to flow line of curb and gutter unless otherwise noted.
- Prior to pavement placement, the pavement prism should be stripped of all unsuitable materials. The subgrade soils shall be scarified to a depth of 12-inches, moisture conditioned, and recompacted to a minimum of 95% of the standard Proctor maximum dry density, within ±2% of optimum moisture as determined by AASHTO T-99.
- Contractor to protect existing utilities and appurtenances. Manholes, drainage inlets, utility lines, etc., damaged, covered, or filled with dirt or debris by the Contractor shall be cleaned and repaired at no expense to the Owner.
- Where proposed pavement is to match existing pavement, existing pavement is to be squared cut, full base thickness is to be brought to match line and existing surface is to be tack-coated before proposed surface is placed.
- All handicap ramps, sidewalks and curb and gutter are to be constructed where indicated on the plans and in accordance The City of Grand Junction requirements..
- Curb, gutter, and drainage pans are to have expansion joints at each change in horizontal alignment of curb and gutter, but in no case at a greater distance apart than 100 feet. Locate dummy grooved joints between expansion joints at intervals not exceeding 10 feet. Where length of pour precludes 10 foot intervals, the end sections may be less than 10 feet but not less than 5 feet.
- PAVEMENT SECTION: Automobile Parking – "Hot-Mix Asphalt" 3-inch HMA over 6-inch CDOT Class 6 over 6" CDOT Class 3 over 12-inch scarified & recompacted subgrade. Truck Traffic – "Hot-Mix Asphalt" 3-inch HMA over 6-inch CDOT Class 6 over 16" CDOT Class 3 over 12-inch scarified & recompacted subgrade. "Rigid Pavement" 6-inch or 8-inch Portland Cement Concrete w/ #4 bars @ 16" cntrs., E.W. over 6-inch CDOT Class 6 over 12-inch scarified & recompacted subgrade.

Summary of Pavement Recommendations

Automobile Parking Areas
EDLA = 5, Structural Number = 2.75

ALTERNATIVE	PAVEMENT SECTION (Inches)				TOTAL
	Hot-Mix Asphalt Pavement	CDOT Class 6 Base Course	CDOT Class 3 Subbase Course	Rigid Pavement	
Full Depth HMA	7.0				7.0
A	3.0	10.0			13.0
B	4.0	7.0			11.0
C	3.0	6.0	6.0		15.0
Rigid Pavement		6.0		6.0	12.0

Truck Traffic Areas
EDLA = 30, Structural Number = 3.70

ALTERNATIVE	PAVEMENT SECTION (Inches)				TOTAL
	Hot-Mix Asphalt Pavement	CDOT Class 6 Base Course	CDOT Class 3 Subbase Course	Rigid Pavement	
Full Depth HMA	9.0				9.0
A	3.0	17.0			20.0
B	4.0	14.0			18.0
C	3.0	6.0	16.0		25.0
Rigid Pavement		6.0		8.0	14.0

WATER LINE CONSTRUCTION

- CONTRACTOR IS RESPONSIBLE TO PROVIDE AND INSTALL ALL BACKFLOW PREVENTION EQUIPMENT AND ABOVE GROUND ENCLOSURES. Double Check Detector Assembly device shall be "Watts" Series L709DCDA assemblies or FEBCO Masterseries 876VST (N-Pattern), or Ute Water Approved equal.
- Above Ground Enclosures shall be as manufactured by Aqua Shield or WATTS or approved equal and be aluminum, insulated with freeze protection, heated, with service access and mounted on a 4" minimum thick concrete slab. Aqua Shield #NBPFB or Watts Model # WB-N6 or Ute Water approved Equal.
- All water line and water service construction shall be constructed in accordance with the Ute Water District Standards and Specifications.
- Contractor shall notify the Ute Water Conservancy 48 hours prior to the beginning of construction of any water line related work.
- All trenches shall be compacted to 95% within 2% of optimum moisture content, as determined by AASHTO T-99. Contractor shall be required to perform all necessary compaction tests through a certified soils lab.
- Minimum cover required over top of new waterlines is 4'-6".
- All water mains to be DR-18 PVC, conforming to AWWA C-900.
- Ductile Iron fittings to conform to AWWA C-110.
- Fire Hydrants shall conform to AWWA C-502, Mueller Super Centurian or Kennedy Gaurdian.
- All materials labor and equipment required for testing and disinfection of water lines shall be furnished by Contractor. Disinfection of water lines shall conform to AWWA C-651-86 or latest revision thereof. No separate pay.
- All pipe bends/angle points, both horizontal and vertical, as called for on the plans are to be thrust blocked per Ute Water Conservancy District details and Technical Specifications.
- Only materials on which a proctor test can be performed and accurate nuclear density tests can be run are approved for water line trench backfill unless otherwise approved by the Engineer.
- All Ute Water Mains are to be bedded per City of Grand Junction Standards.

14. All water service lines 2" and smaller from the meter to the building structure shall be "Pure Core" blue, 200 psi rated HDPE pipe, or approved equal.

STORM SEWER CONSTRUCTION NOTES

- All storm sewer line construction shall be in accordance with the City of Grand Junction Standards and Specifications.
- All Reinforced Concrete storm sewer pipe shall conform to ASTM Standard Specifications, C-76, Class III unless otherwise noted.
- All polyvinyl chloride (PVC) pipe and fittings shall conform to ASTM Standard Specifications, D3034 and F679, SDR-35 unless otherwise noted.
- All High Density Polyethylene (HDPE) pipe and fittings shall be smooth bore and shall conform to the following:
12 inch to 36 inch shall meet ASSHTO M294
42 inch to 48 inch shall meet ASSHTO MP6
All HDPE pipe up to 30" shall be backfilled to springline with Class-6.

FUGITIVE DUST CONTROL PLAN


- Before stripping of the site preparation for overlot grading, the surface is to be pre-wet to control dust.
- Any stockpiles of stripping materials are to be periodically sprayed with water or a crusting agent to stabilize potentially wind blown material.
- Haul road both into and around the site are to be sprayed as needed to suppress dust.
- The Storm Water Management Plan and permit shall be obtained and kept onsite before starting any construction work. Gravel pads are to be constructed at the entrances to the site to help in removing mud from the wheels of haulage trucks before they enter onto City streets.
- Trucks hauling import fill are to be tarped to aid in the control of airborne dust.

UTILITIES AND AGENCIES			
ORCHARD MESA SANITATION DISTRICT	STEVE LABONDE	241-7076	
UTE WATER	JIM DAUGHEY	242-7491	
GRAND VALLEY IRRIGATION	PHIL BERTRAND	242-2762	
CITY OF GRAND JUNCTION PUBLIC WORKS	MARK BARSLAND	256-4106	
XCEL ENERGY	JOHN PRICE	244-2693	
CENTURY LINK	CHRIS JOHNSON	244-4311	
BRESNAN COMMUNICATIONS	JOHN VALDEZ	245-8750	


SANITARY SEWER CONSTRUCTION NOTES

- The Orchard Mesa Sanitation District plan review is only for general conformance with the Orchard Mesa Sanitation District Design Criteria. The District is not responsible for the accuracy and adequacy of the design, of dimensions, and elevations which shall be confirmed and correlated at the job site. The Orchard Mesa Sanitation District, through the approval of this document, assumes no responsibility other than as stated above for the completeness and/or accuracy of this document.
- All sewer line construction shall conform to the Orchard Mesa Sanitation District's Standards and Specifications.
- All materials and workmanship shall be subject to inspection by the District. The District reserves the right to accept or reject any materials and workmanship that does not conform to its Standards and Specifications.
- The Contractor shall have one (1) signed set of the Plans (approved by the Orchard Mesa Sanitation District), and one (1) copy of the appropriate Orchard Mesa Sanitation District STANDARDS AND SPECIFICATIONS at the job site at all times. The Contractor shall also have a copy of any permits necessary to complete the Work.
- The Contractor shall notify the District at least 48 hours prior to commencement of construction.
- All sanitary sewer pipe shall be PVC SDR35 unless otherwise specified. All pipe joints shall be 13 foot joints unless otherwise approved by the District Engineer.
- All sewer mains shall be laid to grade utilizing a pipe laser.
- All service line connections to the new main shall be accomplished with full body wyes or tees. Tapping saddles will not be allowed.
- All trenches shall be compacted to 95% as determined by AASHTO T-99. Contractor shall be required to perform all necessary compaction tests through a certified soils lab to a level required by City of Grand Junction Standard's and Specifications. A copy of the compaction test results shall be provided to the District during the course of the project.
- A minimum 10-foot separation shall be maintained at all times between waterlines and sewer line (except at specified crossings).
- All sanitary sewer services to be 4" PVC SDR35 unless otherwise specified.
- Sewer service stub-outs shall extend 14 feet beyond the property line and shall be glue-capped and marked with a 2x4 post painted green.
- Manholes shall be constructed as shown on the Orchard Mesa Sanitation District Standard Sanitary Sewer Detail Sheet. At the District's direction, the Contractor shall field vacuum test manholes to ensure that they are of watertight construction and that manholes have not been damaged during installation.
- No service lines shall be connected directly into manholes.
- All work to install the new sewer service to the District's 10-inch sewer main is to be completed by the District's Contractor, unless otherwise approved by the District. The District's Contractor will also extend the sewer service line from the new top connection to the property line. All the District's expenses related to installing the new tap and extending the new sewer service line to the property line are to be paid by the Petitioner.
- Manhole cone and flat top sections shall be positioned such that the manhole ring and cover are offset 20 degrees to 30 degrees from the upstream main sewer line into the manhole. Manhole steps shall be installed in vertical alignment with the ring and cover.
- Steel paving rings are not allowed for grade adjustment unless otherwise approved by the District.
- The Contractor is responsible for all required sewer line testing to be completed in the presence of the District Engineer or their representative. Final testing is to be accomplished only after all other infrastructure has been installed. This includes waterlines, gas lines, electric lines, etc. Testing will be performed after all compaction of street subgrade and prior to street paving. Final lamping will also be accomplished after paving is completed to insure that the line is clean. These tests will be the basis for issuing Initial Acceptance of the sewer line extension.
- Sanitary sewer cleanouts located within traveled surface areas shall be provided with a cast-iron traffic rated lamp hole cover.


TYPICAL CONCRETE SECTIONS

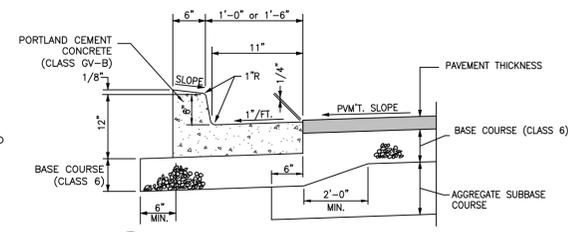


A STANDARD 1'-6" CURB AND GUTTER
NOT TO SCALE

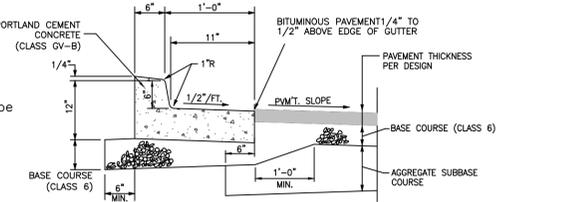


B 1'-6" SPILL CURB AND GUTTER
NOT TO SCALE

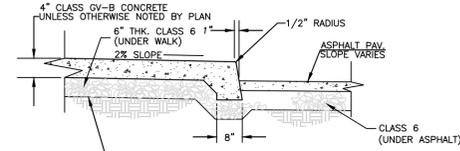


C SIDEWALK AND PAVEMENT SECTION
NOT TO SCALE

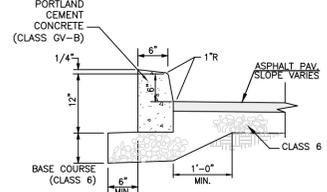

D BARRIER CURB
NOT TO SCALE

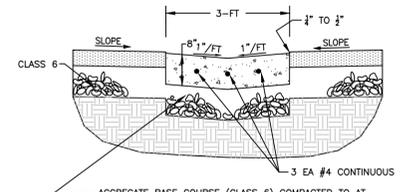

E 3' WIDE VALLEY PAN DETAIL
NOT TO SCALE

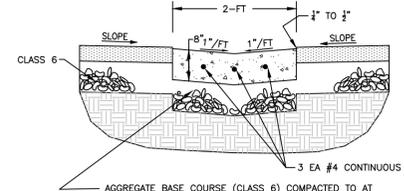

F 2' WIDE VALLEY PAN DETAIL
NOT TO SCALE

LEGEND	
---	PROPERTY LINE
---	ADJACENT PROPERTY LINE
---	EXISTING EASEMENT
---	PROPOSED EASEMENT
	EXISTING BUILDING
	PROPOSED BUILDING
	EXISTING CURB/GUTTER
	PROPOSED CURB/GUTTER
	PROPOSED SPILL CURB/GUTTER
	PROPOSED TRANSITION CURB/GUTTER
	EXISTING RETAINING WALL
---	EXISTING 1-FT CONTOUR
---	EXISTING 5-FT CONTOUR
---	PROPOSED 1-FT CONTOUR
---	PROPOSED 5-FT CONTOUR
---	EXISTING ASPHALT
---	PROPOSED ASPHALT
---	PROPOSED HEAVY DUTY ASPHALT
---	EXISTING CONCRETE
---	PROPOSED CONCRETE
---	PROPOSED HEAVY DUTY CONCRETE
---	EXISTING SANITARY SEWER
---	PROPOSED SANITARY SEWER
---	EXISTING SANITARY SEWER MANHOLE
---	PROPOSED SANITARY SEWER MANHOLE
---	PROPOSED SANITARY SEWER CLEANOUT
---	EXISTING STORM SEWER
---	PROPOSED STORM SEWER
---	EXISTING STORM SEWER INLET
---	PROPOSED STORM SEWER INLET
---	EXISTING STORM SEWER MANHOLE
---	PROPOSED STORM SEWER MANHOLE
---	PROPOSED INLINE DRAIN
---	EXISTING 8" WATER MAIN
---	PROPOSED 2" DOMESTIC SERVICE
---	PROPOSED 4" FIRE LINE
---	EXISTING FIRE HYDRANT
---	PROPOSED FIRE HYDRANT
---	EXISTING WATER METER
---	PROPOSED WATER METER
---	PROPOSED METER/BACKFLOW VAULT
---	PROPOSED IRRIGATION MANHOLE
---	PROPOSED FENCE
---	EXISTING FENCE
---	PROPOSED TRAFFIC FLOW
---	GRADE BREAK
---	ROOF DRAIN (RD)
---	STREET LIGHT POLE
---	FIRE DEPARTMENT CONNETION
---	PARKING LOT LIGHT
---	PROPOSED BUILDING LIGHT
---	POWER POLE
---	FLOWLINE
---	EOP EDGE OF PAVEMENT
---	TOC TOP OF CONCRETE
---	TOW TOP OF WALL
---	BOW BOTTOM OF WALL
---	TBW TOP BACK OF WALK
---	TC TOP OF CURB
---	BOC BACK OF CURB
---	LS LANDSCAPE AREA
---	UTILITY PEDESTALS

**C H A M B E R L I N
A R C H I T E C T S**

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437 Main St.
Grand Junction, Colorado 81501
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Rapid City, South Dakota 57701
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AUSTIN CIVIL GROUP, INC.
Land Planning • Civil Engineering • Development Services
123 N. 7th Street, Suite 300 • Grand Junction, Colorado 81501
(970) 242-7540

**ORCHARD MESA
FIRE STATION #4**

GRAND JUNCTION, COLORADO

**GENERAL NOTES
AND DETAILS**

NO:	ISSUED FOR:	DATE:
△	REVIEW COMMENTS RND#1	4-28-15
△	REVIEW COMMENTS RND#2	6-3-15
△		
△		
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△		

PROJECT STATUS: 100% CD
DRAWN BY: LMS CHECKED BY: MIRA

DATE: 4-10-15 SHEET NO:

PROJECT NO: 1443 **C-2**

GENERAL CONSTRUCTION NOTES

- Locations of existing utilities shown on these plans are approximate only. Contractor is to contact affected utility for specific locations before digging.
- The Contractor shall notify the engineer if unanticipated conditions are encountered during completion of the work which require modifications to the contract drawings. The engineer can be reached at 970-242-7540.
- Contractor shall give 48-hour notice to all authorized inspectors, superintendents, or person in charge of public and private utilities affected by his operations prior commencement of work. Contractor shall assure himself that all construction permits are current.
- Contractor shall confine his construction operations to the right-of-way, easements, and lots, as shown on plans and plot. Any damage to private facilities outside these limits shall be repaired by the Contractor at no expense to the Owner.
- All road construction, related work, materials, performance and quality of work provided shall conform to the requirements of the City of Grand Junction Standard Specifications and Drawings and the applicable sections of the most current edition of the Division of Highways, State of Colorado Standard Specifications for Road and Bridge Construction, Colorado Standard Plans, Division of Highways M & S Standards.
- Contractor shall familiarize himself with the geotechnical testing requirements of the City of Grand Junction. The results of the required types of tests and numbers of passing tests shall be furnished to the Engineer for verification before final acceptance by the Owner will be granted. All failing tests shall be brought to the immediate attention of the Engineer and retests shall be performed until passing results are obtained. All utility lines, including service lines falling shall be tested.
- All earthwork operations shall be completed in accordance with the recommendations and requirements of the Geotechnical and Geologic Hazards Investigation Report by Huddleston-Berry, Project #00390-0003, dated November 20, 2014.
- Only materials on which a proctor test can be performed and accurate nuclear density tests can be run are approved for utility trench back fill unless otherwise approved by the Engineer.
- All utility installations within the City of Grand Junction jurisdiction are to be performed in accordance with the City of Grand Junction Standard Specifications for the Construction of Underground Utilities and Standard Details.
- All sewer lines must be tested and approved per Orchard Mesa Sanitation District requirements PRIOR to street construction. Contractor is required to notify the Owner's representative PRIOR to testing. The Owner's representative must be present to witness testing of water and sewer lines or the City will not approve the installation.

- In the event of a discrepancy between the construction notes contained herein and the notes and details in the City of Grand Junction Standard Contract Documents for Capital Improvements Construction manual, the City's manual shall control.
- All work within the City of Grand Junction Right-of-Way shall required a "Work in the Right-of-Way" Permit. All construction work shall be in accordance with the latest edition of the City of Grand Junction Standard Specifications.
- All concrete shall have a minimum of 6: Class VI ABC, unless otherwise noted.

PAVING CONSTRUCTION NOTES

- All road widths and radii are to flow line unless noted otherwise. Any "spot" design elevations are to flow line of curb and gutter unless otherwise noted.
- Prior to pavement placement, the pavement prism should be stripped of all unsuitable materials. The subgrade soils shall be scarified to a depth of 12-inches, moisture conditioned, and recompacted to a minimum of 95% of the standard Proctor maximum dry density, within ±2% of optimum moisture as determined by AASHTO T-99.
- Contractor to protect existing utilities and appurtenances. Manholes, drainage inlets, utility lines, etc., damaged, covered, or filled with dirt or debris by the Contractor shall be cleaned and repaired at no expense to the Owner.
- Where proposed pavement is to match existing pavement, existing pavement is to be squared cut, full base thickness is to be brought to match line and existing surface is to be tack-coated before proposed surface is placed.
- All handicap ramps, sidewalks and curb and gutter are to be constructed where indicated on the plans and in accordance The City of Grand Junction requirements..
- Curb, gutter, and drainage pans are to have expansion joints at each change in horizontal alignment of curb and gutter, but in no case at a greater distance apart than 100 feet. Locate dummy grooved joints between expansion joints at intervals not exceeding 10 feet. Where length of pour precludes 10 foot intervals, the end sections may be less than 10 feet but not less than 5 feet.

7. PAVEMENT SECTION: Automobile Parking - "Hot-Mix Asphalt" 3-inch HMA over 6-inch CDOT Class 6 over 6" CDOT Class 3 over 12-inch scarified & recompacted subgrade. Truck Traffic - "Hot-Mix Asphalt" 3-inch HMA over 6-inch CDOT Class 6 over 16" CDOT Class 3 over 12-inch scarified & recompacted subgrade. "Rigid Pavement" 6-inch or 8-inch Portland Cement Concrete w/ #4 bars @ 16" cntrs., E.W. over 6-inch CDOT Class 6 over 12-inch scarified & recompacted subgrade.

Summary of Pavement Recommendations

Automobile Parking Areas
EDLA = 5, Structural Number = 2.75

ALTERNATIVE	PAVEMENT SECTION (Inches)				TOTAL
	Hot-Mix Asphalt Pavement	CDOT Class 6 Base Course	CDOT Class 3 Subbase Course	Rigid Pavement	
Full Depth HMA	7.0				7.0
A	3.0	10.0			13.0
B	4.0	7.0			11.0
C	3.0	6.0	6.0		15.0
Rigid Pavement		6.0		6.0	12.0

Truck Traffic Areas
EDLA = 30, Structural Number = 3.70

ALTERNATIVE	PAVEMENT SECTION (Inches)				TOTAL
	Hot-Mix Asphalt Pavement	CDOT Class 6 Base Course	CDOT Class 3 Subbase Course	Rigid Pavement	
Full Depth HMA	9.0				9.0
A	3.0	17.0			20.0
B	4.0	14.0			18.0
C	3.0	6.0	16.0		25.0
Rigid Pavement		6.0		8.0	14.0

WATER LINE CONSTRUCTION

- CONTRACTOR IS RESPONSIBLE TO PROVIDE AND INSTALL ALL BACKFLOW PREVENTION EQUIPMENT AND ABOVE GROUND ENCLOSURES. Double Check Detector Assemblies shall be "Watts" Series L709DCDA assemblies or FEBCO Masterseries 876VS (N-Pattern), or Ute Water Approved equal.
- Above Ground Enclosures shall be as manufactured by Aqua Shield or NIBFP8 or Watts Model # WB-N6 or Ute Water approved Equal.
- All water line and water service construction shall be constructed in accordance with the Ute Water District Standards and Specifications.
- The Contractor is responsible to install meter pits and yokes which will be SUPPLIED BY UTE WATER
- Contractor shall notify the Ute Water Conservancy 24 hours prior to the beginning of construction of any water line related work.
- All trenches shall be compacted to 95% within 2% of optimum moisture content, as determined by AASHTO T-99. Contractor shall be required to perform all necessary compaction tests through a certified soils lab.
- Minimum cover required over top of new waterlines is 4'-6".
- All water mains to be DR-18 PVC, conforming to AWWA C-900.
- Ductile Iron fittings to conform to AWWA C-110.
- Fire Hydrants shall conform to AWWA C-502, Mueller Super Centurian or Kennedy Gaurdian.
- All materials labor and equipment required for testing and disinfection of water lines shall be furnished by Contractor. Disinfection of water lines shall conform to AWWA C-651-86 or latest revision thereof. No separate pay.
- All pipe bends/angle points, both horizontal and vertical, as called for on the plans are to be thrust blocked per Ute Water Conservancy District details and Technical Specifications.
- Only materials on which a proctor test can be performed and accurate nuclear density tests can be run are approved for water line trench backfill unless otherwise approved by the Engineer.
- All Ute Water Mains are to be bedded per City of Grand Junction Standards.
- All water service lines 2" and smaller from the meter to the building structure shall be "Pure Core" blue, 200 psi rated HDPE pipe, or approved equal.

STORM SEWER CONSTRUCTION NOTES

- All storm sewer line construction shall be in accordance with the City of Grand Junction Standards and Specifications.
- All Reinforced Concrete storm sewer pipe shall conform to ASTM Standard Specifications, C-76, Class III unless otherwise noted.
- All polyvinyl chloride (PVC) pipe and fittings shall conform to ASTM Standard Specifications, D3034 and F679, SDR-35 unless otherwise noted.
- All High Density Polyethylene (HDPE) pipe and fittings shall be smooth bore and shall conform to the following:
12 inch to 36 inch shall meet ASSHTO M294
42 inch to 48 inch shall meet ASSHTO MP6
All HDPE pipe up to 30" shall be backfilled to springline with Class-6.

FUGITIVE DUST CONTROL PLAN

- Before stripping of the site preparation for overlot grading, the surface is to be pre-wet to control dust.
- Any stockpiles of stripping materials are to be periodically sprayed with water or a crusting agent to stabilize potentially wind blown material.
- Haul road both into and around the site are to be sprayed as needed to suppress dust.
- The Storm Water Management Plan and permit shall be obtained and kept onsite before starting any construction work. Gravel pads are to be constructed at the entrances to the site to help in removing mud from the wheels of haulage trucks before they enter onto City streets.
- Trucks hauling import fill are to be tarped to aid in the control of airborne dust.

UTILITIES AND AGENCIES

ORCHARD MESA SANITATION DISTRICT	STEVE LABONDE	241-7076
UTE WATER	JIM DAUGHEY	242-7491
GRAND VALLEY IRRIGATION	PHIL BERTRAND	242-2762
CITY OF GRAND JUNCTION PUBLIC WORKS	MARK BARSLAND	256-4106
XCEL ENERGY	JOHN PRICE	244-2693
CENTURY LINK	CHRIS JOHNSON	244-4311
BRESNAN COMMUNICATIONS	JOHN VALDEZ	245-8750


ORCHARD MESA SANITATION DISTRICT NOTES

- All sewer line construction shall conform to Orchard Mesa Sanitation District's Standards and Specifications unless otherwise specified.
- All materials and workmanship shall be subject to inspection by the District. The District reserves the right to reject any materials and workmanship that does not conform to its Standards and Specifications.
- The Contractor shall have one signed copy of the Plans and a copy of the District's Standards and Specifications at the job site at all times.
- All sanitary sewer pipe shall be PVC SDR-35 unless otherwise specified. All pipe joints shall be 13 foot joints unless otherwise approved by the District Engineer.
- All sewer mains shall be laid to grade utilizing a pipe laser.
- All service line connections to the new main shall be accomplished with full body wyes or tees. Tapping saddles will not be allowed.
- All trenches shall be compacted to 90% within 2% of optimum moisture content, as determined AASHTO T-180. Contractor shall be required to perform all necessary compaction tests through a certified soils lab. A copy of the compaction test results shall be provided to the District during the course of the project.
- A minimum 10-foot separation shall be maintained at all times between waterlines and sewer lines (except at specified crossings).
- All sanitary sewer services to be 4" PVC SDR 35 unless otherwise specified.
- Sewer service stub-outs shall extend 14 feet beyond the property line and shall be glue-capped and marked with a 2x4 post painted green.
- The Contractor shall notify the District at least 48 hours prior to commencement of construction.
- Manholes shall be constructed as shown on the Orchard Mesa Sanitation District Standard Sanitary Sewer Detail sheet. At the District's direction, the Contractor shall field vacuum test manholes to ensure that they are of watertight construction and that manholes have not been damaged during installation.
- No service lines shall be connected directly into manholes.
- Manhole cone and flat top sections shall be positioned such that the manhole ring and cover are offset 20 degrees to 30 degrees from the upstream main sewer line into the manhole. Manhole steps shall be installed in vertical alignment with the ring and cover.
- Steel paving rings are not allowed for grade adjustment unless otherwise approved by the District.
- The Contractor is responsible for all required sewer line testing to be completed in the presence of the District Engineer or their representative. Final testing is to be accomplished only after all other infrastructure has been installed. This includes waterlines, gas lines, electric lines, etc. Testing will be performed after all compaction of street subgrade and prior to street paving. Final lamping will also be accomplished after paving is completed to insure that the line is clean. These tests will be the basis for issuing Initial Acceptance of the sewer line extension.
- Where sanitary sewers cross under a water line with less than 18 inches of vertical separation, and in all cases where the sanitary sewer crosses over the waterline at any depth, provide total concrete encasement of pipe for a length of 10 feet to either side of the waterline.
- Only materials on which a proctor test can be performed and accurate nuclear density tests can be run are approved for sewer line trench backfill unless otherwise approved by the Engineer.
- To inhibit the movement of ground water through sewer bedding and haunching material, clay cutoff wall of native material are to be constructed approximately 10 feet upstream from each manhole and shown on sanitary sewer plan and profiles.
- The contractor shall obtain a City of Grand Junction Street Cut Permit for all work within existing City right-of-way prior to construction.


LEGEND

---	PROPERTY LINE	⊠	PROPOSED INLINE DRAIN
---	ADJACENT PROPERTY LINE	⊠	EXISTING 8" WATER MAIN
---	EXISTING EASEMENT	⊠	PROPOSED 2" DOMESTIC SERVICE
---	PROPOSED EASEMENT	⊠	PROPOSED 4" FIRE LINE
▨	EXISTING BUILDING	⊠	EXISTING FIRE HYDRANT
▨	PROPOSED BUILDING	⊠	PROPOSED FIRE HYDRANT
▨	EXISTING CURB/GUTTER	⊠	EXISTING WATER METER
▨	PROPOSED CURB/GUTTER	⊠	PROPOSED WATER METER
▨	PROPOSED SPILL CURB/GUTTER	⊠	PROPOSED METER/BACKFLOW VAULT
▨	PROPOSED TRANSITION CURB/GUTTER	⊠	PROPOSED IRRIGATION MANHOLE
▨	EXISTING RETAINING WALL	⊠	PROPOSED FENCE
---	EXISTING 1-FT CONTOUR	⊠	EXISTING FENCE
---	EXISTING 5-FT CONTOUR	⊠	PROPOSED TRAFFIC FLOW
---	PROPOSED 1-FT CONTOUR	⊠	GRADE BREAK
---	PROPOSED 5-FT CONTOUR	⊠	ROOF DRAIN (RD)
▨	EXISTING ASPHALT	⊠	STREET LIGHT POLE
▨	PROPOSED ASPHALT	⊠	FIRE DEPARTMENT CONNETION
▨	PROPOSED HEAVY DUTY ASPHALT	⊠	PARKING LOT LIGHT
▨	EXISTING CONCRETE	⊠	PROPOSED BUILDING LIGHT
▨	PROPOSED CONCRETE	⊠	POWER POLE
▨	PROPOSED HEAVY DUTY CONCRETE	⊠	FLOWLINE
▨	EXISTING SANITARY SEWER	⊠	EOP
⊠	PROPOSED SANITARY SEWER	⊠	TOP OF CONCRETE
⊠	EXISTING SANITARY SEWER MANHOLE	⊠	TOW
⊠	PROPOSED SANITARY SEWER MANHOLE	⊠	BOW
⊠	PROPOSED SANITARY SEWER CLEANOUT	⊠	TBW
⊠	EXISTING STORM SEWER	⊠	TC
⊠	PROPOSED STORM SEWER	⊠	BOC
⊠	EXISTING STORM SEWER INLET	⊠	LS
⊠	PROPOSED STORM SEWER INLET	⊠	UTILITY PEDESTALS
⊠	EXISTING STORM SEWER MANHOLE	⊠	
⊠	PROPOSED STORM SEWER MANHOLE	⊠	


TYPICAL CONCRETE SECTIONS

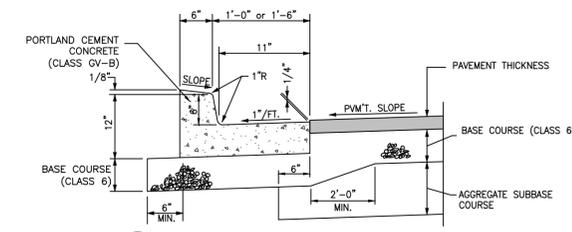


A STANDARD 1'-6" CURB AND GUTTER
NOT TO SCALE

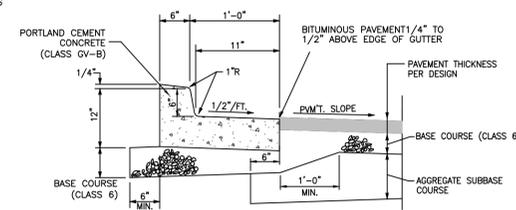


B 1'-6" SPILL CURB AND GUTTER
NOT TO SCALE

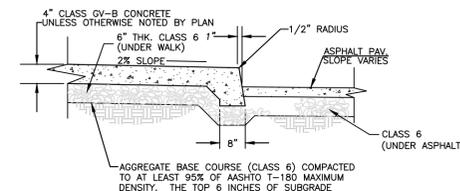


C SIDEWALK AND PAVEMENT SECTION
NOT TO SCALE

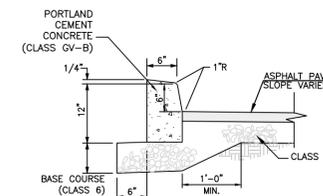

D BARRIER CURB
NOT TO SCALE

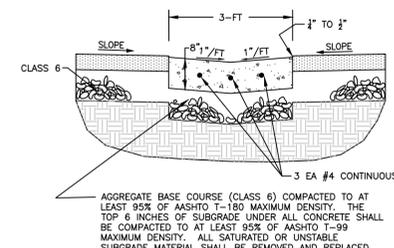

E 3' WIDE VALLEY PAN DETAIL
NOT TO SCALE

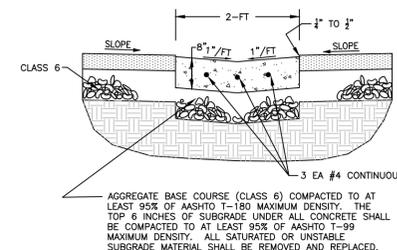

F 2' WIDE VALLEY PAN DETAIL
NOT TO SCALE

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ORCHARD MESA FIRE STATION #4

GRAND JUNCTION, COLORADO

GENERAL NOTES AND DETAILS

NO: REVIEW COMMENTS RND#1
ISSUED FOR: 4-28-15
DATE:

PROJECT STATUS: 100% CD

DRAWN BY: LMS CHECKED BY: MIRA

DATE: 4-10-15 SHEET NO:

PROJECT NO: 1443 **C-2**

ORCHARD MESA FIRE STATION #4

GRAND JUNCTION, COLORADO

UTILITY PLAN



NO:	ISSUED FOR:	DATE:
△	REVIEW COMMENTS RND#1	4-28-15
△	REVISED SANITARY SEWER SERVICE	5-7-15
△	REVIEW COMMENTS RND#2	6-3-15
△	IRR. DRAINAGE & FIRE LINE	6-11-15

PROJECT STATUS: 100% CD

DRAWN BY: LMS CHECKED BY: MRA

DATE: 4-10-15 SHEET NO:


PROJECT NO: 1443 **C-5**

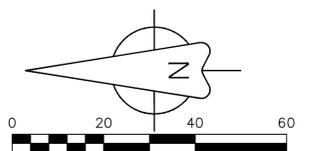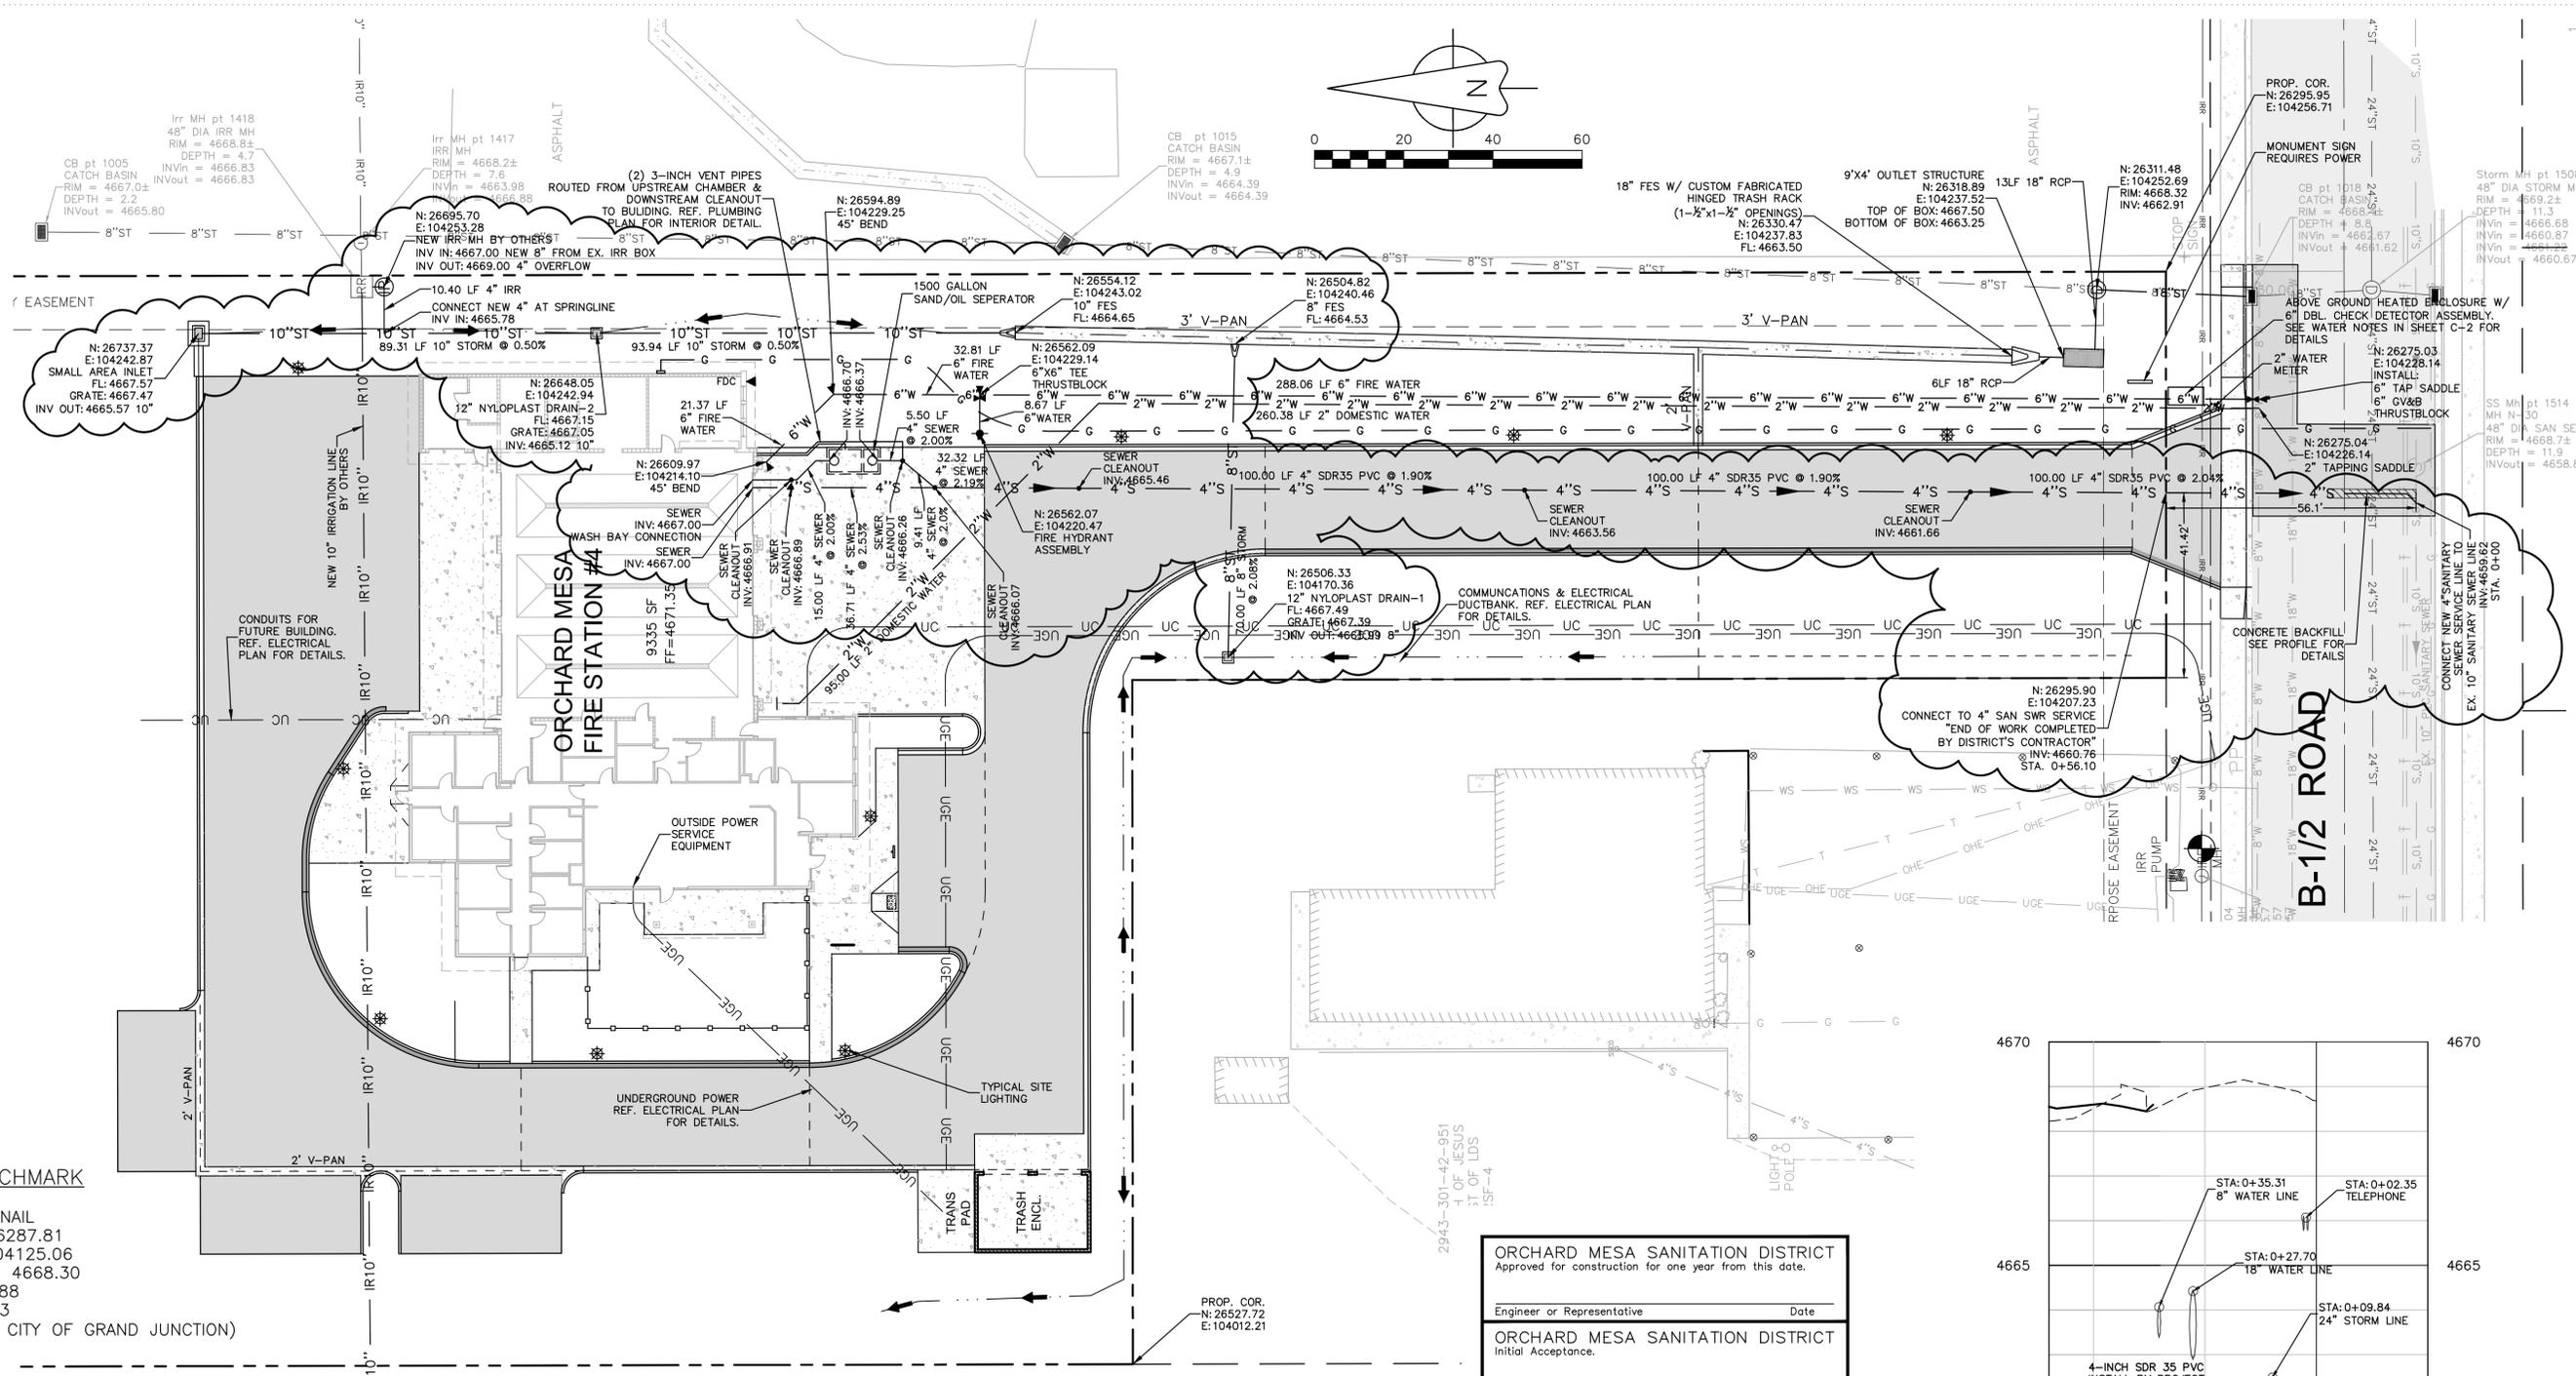

BENCHMARK
60D NAIL
N: 26287.81
E: 104125.06
NAVD88
NAD83
(PER CITY OF GRAND JUNCTION)

- NOTE:
- OBTAIN WORK IN RIGHT OF WAY PERMITS FROM THE CITY OF GRAND JUNCTION BEFORE DOING ANY WORK ALONG B 1/2 ROAD.
 - ALL SEWER CLEANOUTS LOCATED WITHIN TRAVELED DRIVEWAYS SHALL BE PROVIDED WITH TRAFFIC RATED RING & COVERS.

UTILITIES AND AGENCIES		
ORCHARD MESA SANITATION DISTRICT	STEVE LABONDE	241-7076
UTE WATER	JIM DAUGHEY	242-7491
GRAND VALLEY IRRIGATION	PHIL BERTRAND	242-2792
CITY OF GRAND JUNCTION PUBLIC WORKS	MARK BARSLAND	256-4106
XCEL ENERGY	JOHN PRICE	244-2693
CENTURY LINK	CHRIS JOHNSON	244-4311
BRESNAN COMMUNICATIONS	JOHN VALDEZ	245-8750

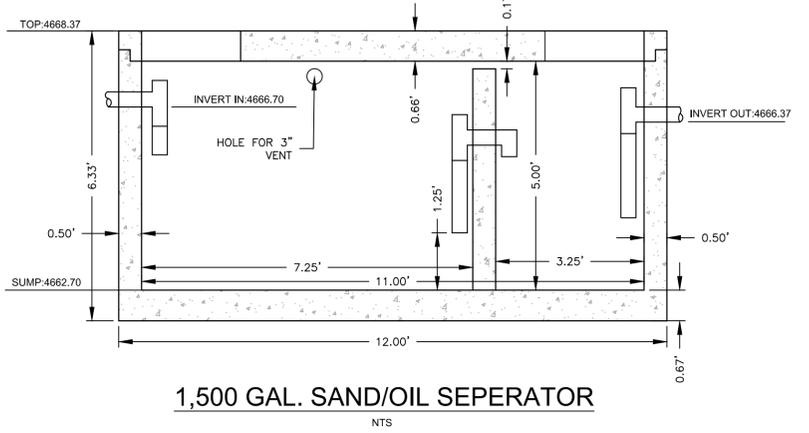

ORCHARD MESA SANITATION DISTRICT
Approved for construction for one year from this date.

Engineer or Representative _____ Date _____

ORCHARD MESA SANITATION DISTRICT
Initial Acceptance.

Engineer or Representative _____ Date _____

UTE WATER DISTRICT
APPROVED FOR CONSTRUCTION FOR ONE YEAR FROM THIS DATE.

BY: _____ DATE: _____

ACCEPTED AS CONSTRUCTED

BY: _____ DATE: _____


CITY OF GRAND JUNCTION ENGINEERING
APPROVED FOR CONSTRUCTION FOR ONE YEAR FROM THIS DATE.

BY: _____ DATE: _____

ACCEPTED AS CONSTRUCTED







BY: _____ DATE: _____

"All details, construction, inspections, and testing shall conform to the City of Grand Junction Standard Contract Documents for Capital Improvements Construction. Contractor shall have a copy of the accepted plans and current City of Grand Junction Standard Documents for Capital Improvements Construction on site and available at all times."

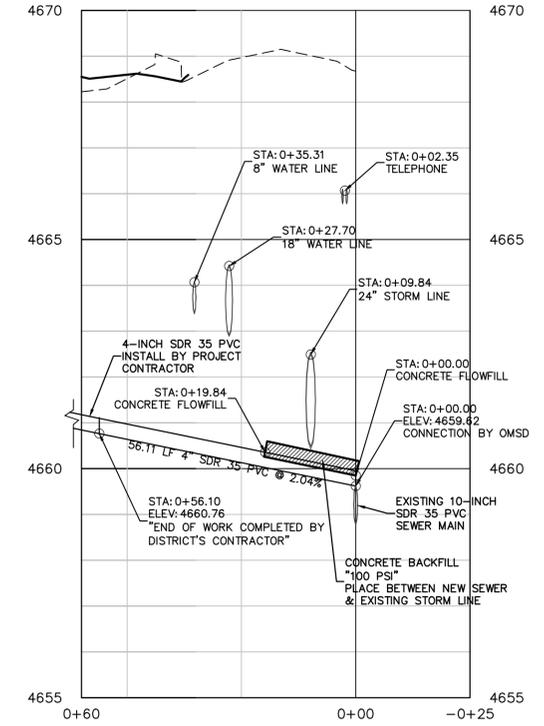

4-INCH SEWER SERVICE
HORIZONTAL: 1"=20', VERTICAL: 1"=2'

Revised

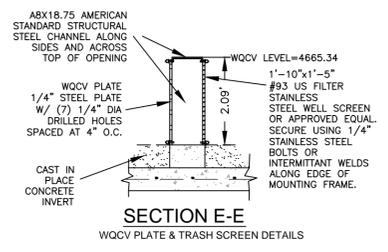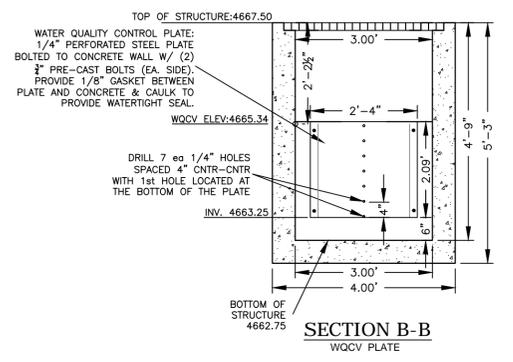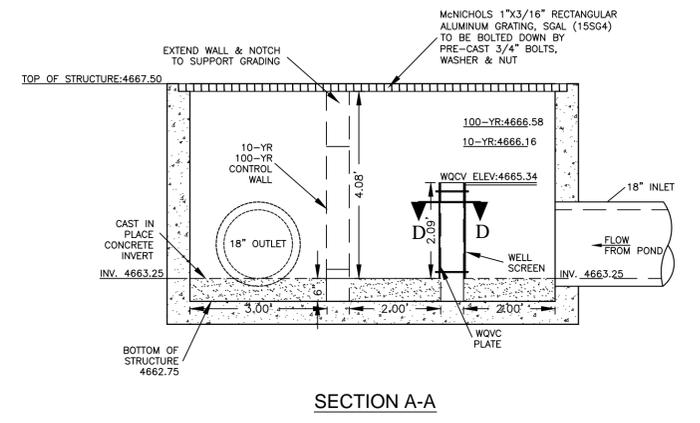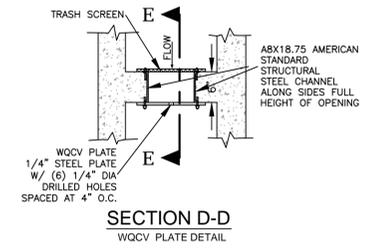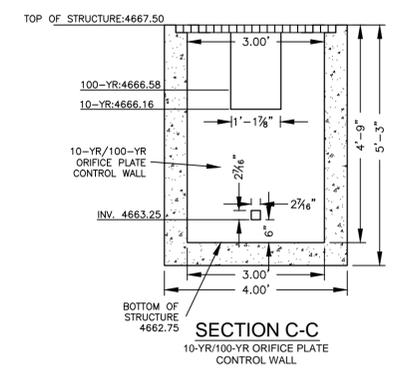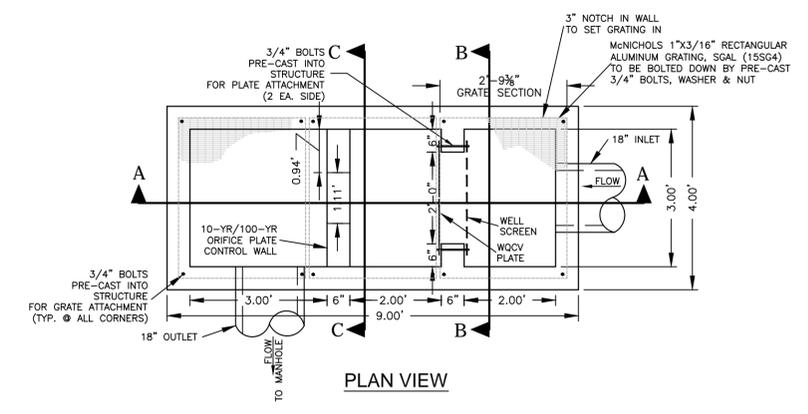

OUTLET STRUCTURE NTS

ORCHARD MESA FIRE STATION #4

GRAND JUNCTION, COLORADO

UTILITY DETAILS

NO: _____ ISSUED FOR: _____ DATE: _____

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CITY OF GRAND JUNCTION ENGINEERING	
APPROVED FOR CONSTRUCTION FOR ONE YEAR FROM THIS DATE.	
BY: _____	DATE: _____
ACCEPTED AS CONSTRUCTED	
BY: _____	DATE: _____

PROJECT STATUS: 100% CD


DRAWN BY: LMS CHECKED BY: MRA

DATE: 4-10-15 SHEET NO. _____

"All details, construction, inspections, and testing shall conform to the City of Grand Junction Standard Contract Documents for Capital Improvements Construction. Contractor shall have a copy of the accepted plans and current City of Grand Junction Standard Documents for Capital Improvements Construction on site and available at all times."

PROJECT NO: 1443 **C-6**


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NOTE: CONTRACTOR'S OPTION TO PROVIDE VERSA-LOK LANDSCAPE BLOCK at EAST EDGE ILO CONC TURNDOWN.

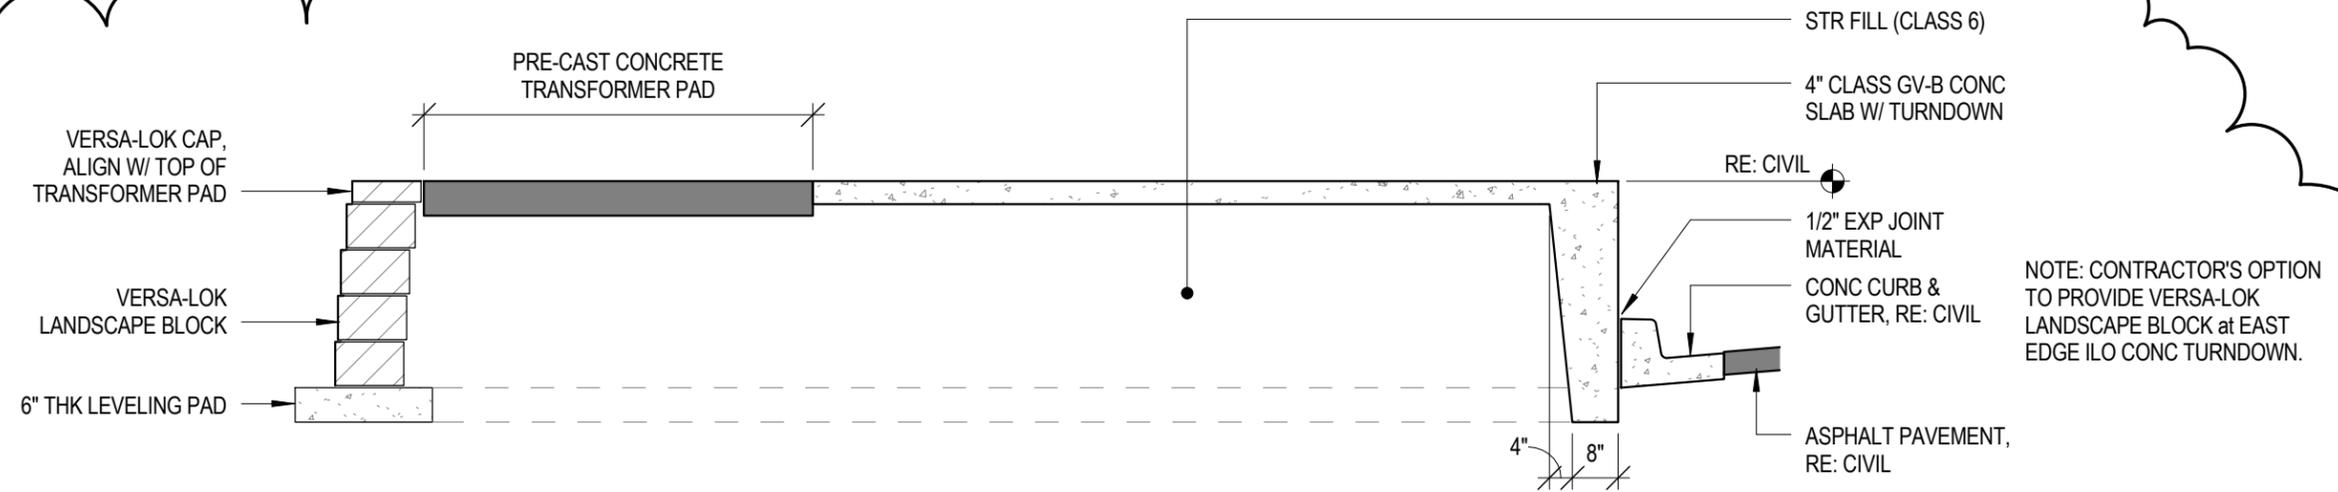
3 TRANSFORMER PAD SECTION A

SCALE: 3/8" = 1'-0"



2 TRANSFORMER PAD SECTION B

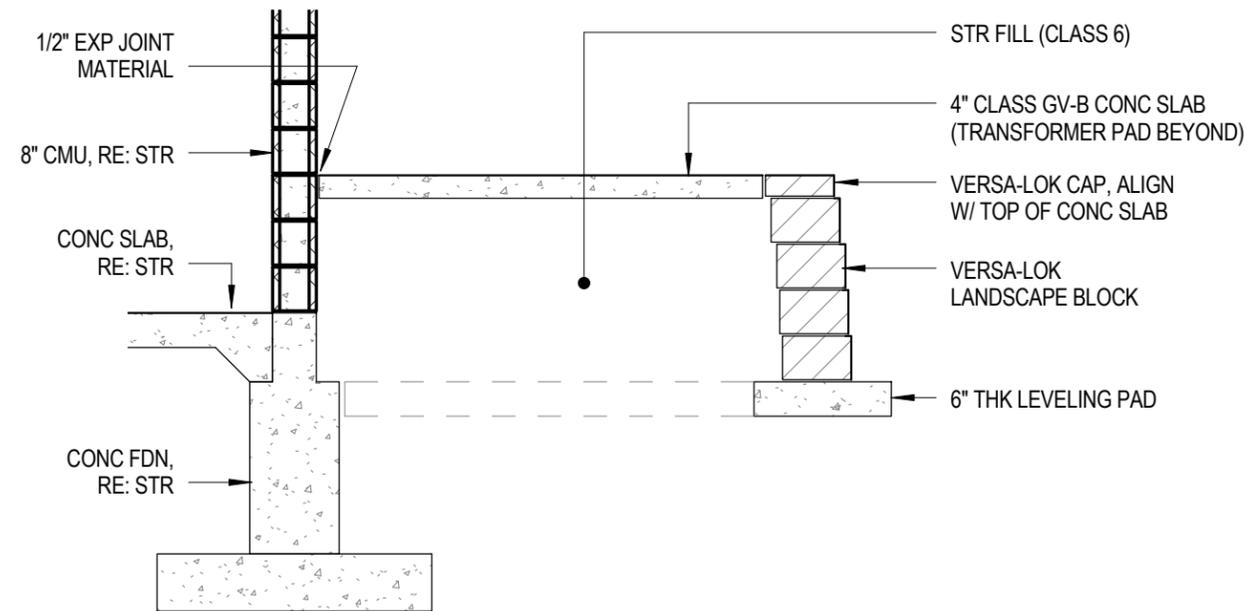SCALE: 3/8" = 1'-0"

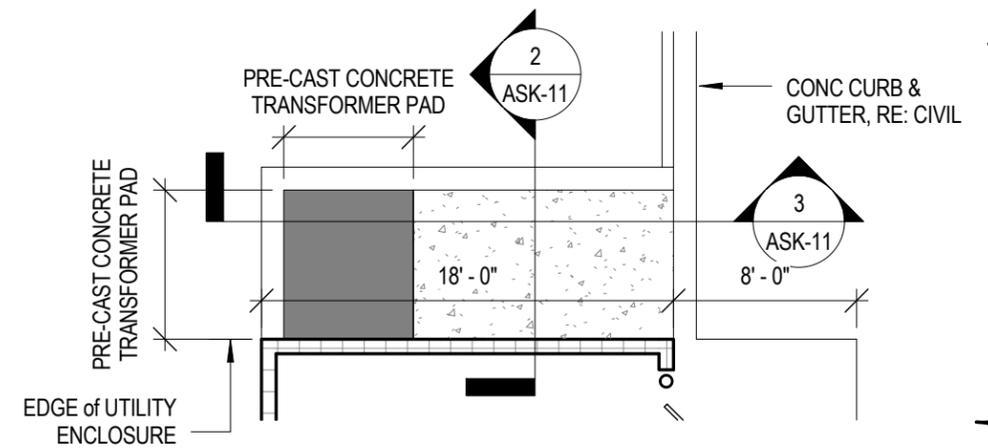


1 FLOOR PLAN - TRANSFORMER PAD

SCALE: 1/8" = 1'-0"

Grades around pad will remain per Civil

C H A M B E R L I N A R C H I T E C T S <small>GRAND JUNCTION, COLORADO 970.242.6804 RAPID CITY, SOUTH DAKOTA 605.355.6804</small>		DESCRIPTION: TRANSFORMER PAD DETAILS			ISSUED WITH: PR#008	ASK-11 <small>LOCATION:</small>
PROJECT: OMFS#4	PROJECT NO: 1443	SCALE: As indicated	DATE: 7/23/15	PREPARED BY: JW		

Revised

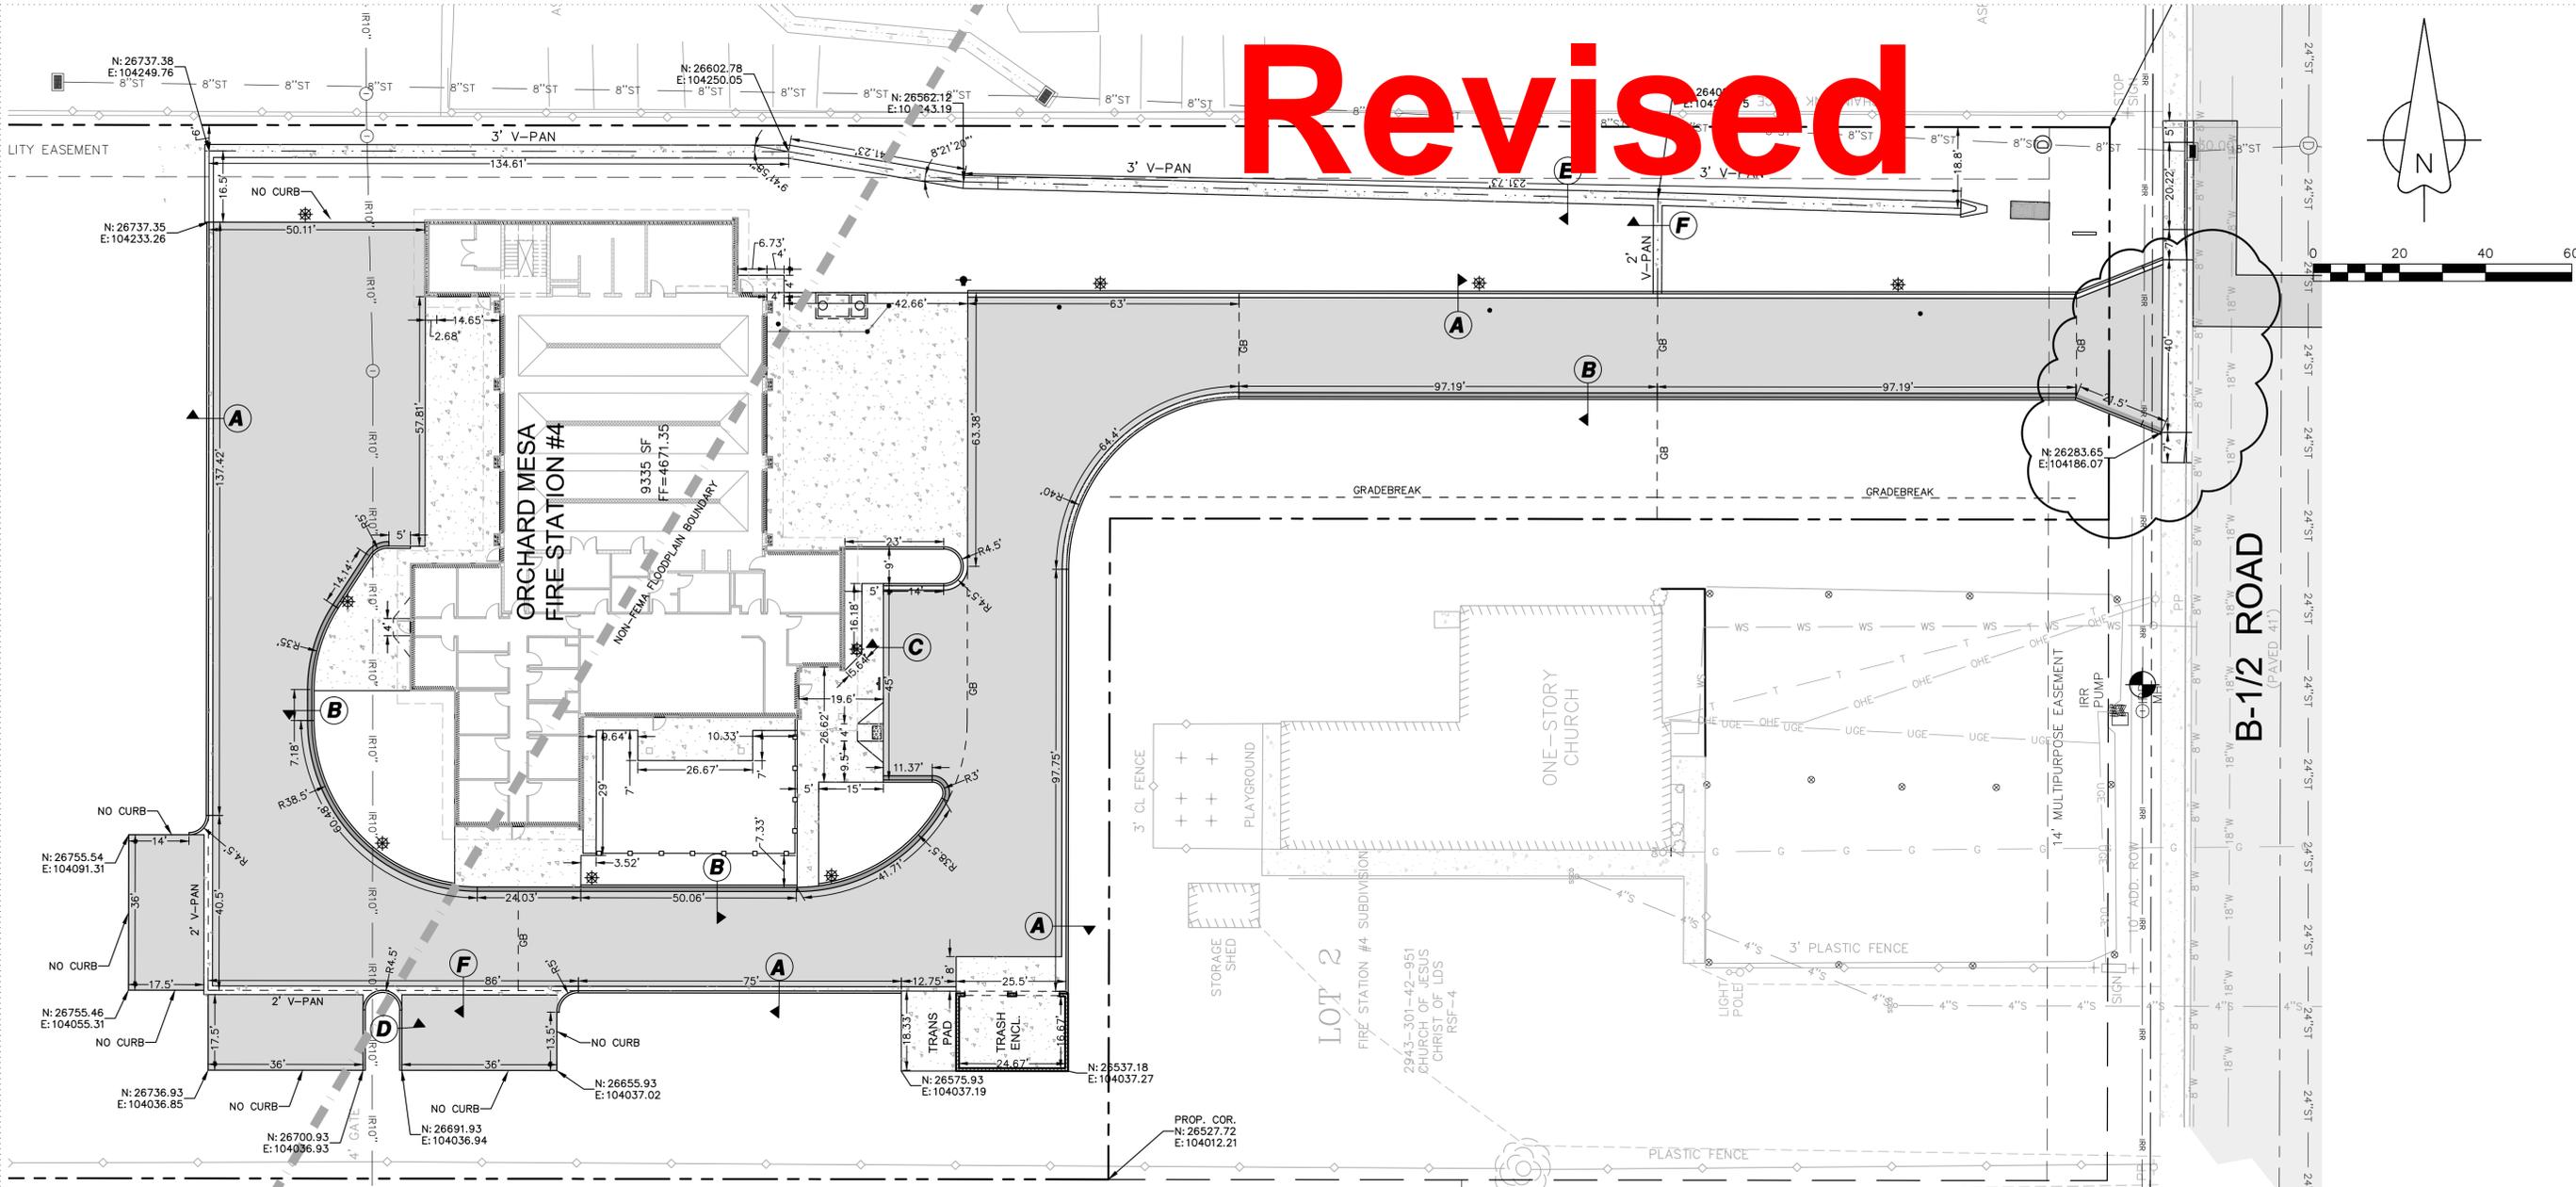

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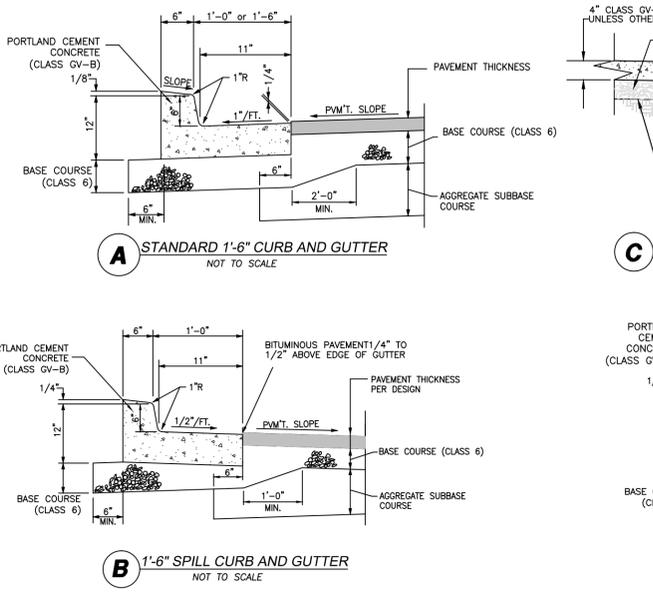
ORCHARD MESA FIRE STATION #4

GRAND JUNCTION, COLORADO


HORIZONTAL CONTROL PLAN

LEGEND	
	PROPERTY LINE
	ADJACENT PROPERTY LINE
	EXISTING EASEMENT
	PROPOSED EASEMENT
	EXISTING BUILDING
	PROPOSED BUILDING
	EXISTING CURB/GUTTER
	PROPOSED CURB/GUTTER
	PROPOSED SPILL CURB/GUTTER
	PROPOSED TRANSITION CURB/GUTTER
	EXISTING RETAINING WALL
	EXISTING 1'-FT CONTOUR
	EXISTING 5'-FT CONTOUR
	PROPOSED 1'-FT CONTOUR
	PROPOSED 5'-FT CONTOUR
	EXISTING ASPHALT
	PROPOSED ASPHALT
	PROPOSED HEAVY DUTY ASPHALT
	EXISTING CONCRETE
	PROPOSED CONCRETE
	PROPOSED HEAVY DUTY CONCRETE
	EXISTING SANITARY SEWER
	PROPOSED SANITARY SEWER
	EXISTING SANITARY SEWER MANHOLE
	PROPOSED SANITARY SEWER MANHOLE
	EXISTING SANITARY SEWER CLEANOUT
	EXISTING STORM SEWER
	PROPOSED STORM SEWER
	EXISTING STORM SEWER INLET
	PROPOSED STORM SEWER INLET
	EXISTING STORM SEWER MANHOLE
	PROPOSED STORM SEWER MANHOLE
	PROPOSED INLINE DRAIN
	EXISTING 8" WATER MAIN
	PROPOSED 2" DOMESTIC SERVICE
	PROPOSED 4" FIRE LINE
	EXISTING FIRE HYDRANT
	PROPOSED FIRE HYDRANT
	EXISTING WATER METER
	PROPOSED WATER METER
	PROPOSED METER/BACKFLOW VAULT
	PROPOSED IRRIGATION MANHOLE
	PROPOSED FENCE
	EXISTING FENCE
	PROPOSED TRAFFIC FLOW
	GRADE BREAK
	ROOF DRAIN (RD)
	STREET LIGHT POLE
	FIRE DEPARTMENT CONNECTION
	PARKING LOT LIGHT
	PROPOSED BUILDING LIGHT
	POWER POLE
	FLOWLINE
	EOP
	TOC
	TOW
	BOW
	TBW
	TC
	BOC
	LS
	BACK OF CURB
	LANDSCAPE AREA
	UTILITY PEDESTALS

TYPICAL CONCRETE SECTIONS



TYPICAL CONCRETE SECTIONS

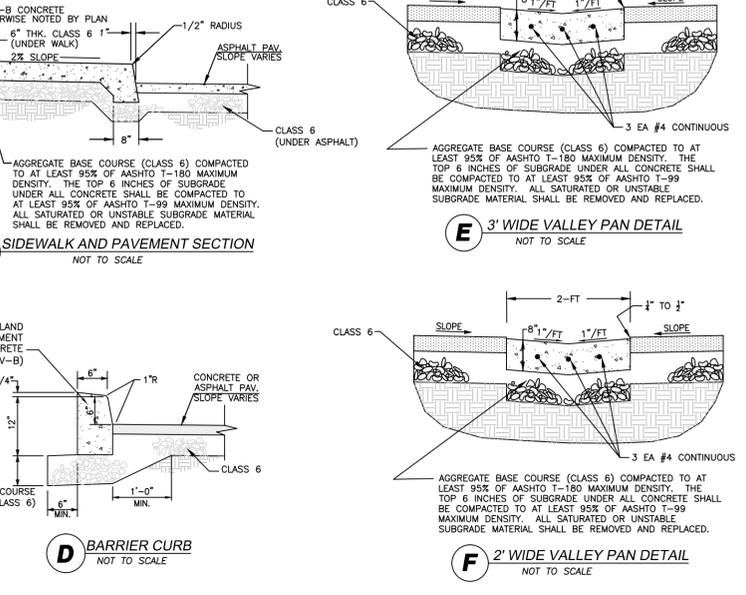

BENCHMARK

60D NAIL
 N: 26287.81
 E: 104125.06
 ELEV: 4668.30
 NAVD88
 NAD83
 (PER CITY OF GRAND JUNCTION)

CITY OF GRAND JUNCTION ENGINEERING

APPROVED FOR CONSTRUCTION FOR ONE YEAR FROM THIS DATE.

BY: _____ DATE: _____

ACCEPTED AS CONSTRUCTED

BY: _____ DATE: _____

NO: _____ ISSUED FOR: _____ DATE: _____

REVIEW COMMENTS RND#1 4-28-15

PROJECT STATUS: 100% CD


DRAWN BY: LMS CHECKED BY: MRA

DATE: 4-10-15 SHEET NO: C-7

PROJECT NO: 1443

"All details, construction, inspections, and testing shall conform to the City of Grand Junction Standard Contract Documents for Capital Improvements Construction. Contractor shall have a copy of the accepted plans and current City of Grand Junction Standard Documents for Capital Improvements Construction on site and available at all times."

Revised

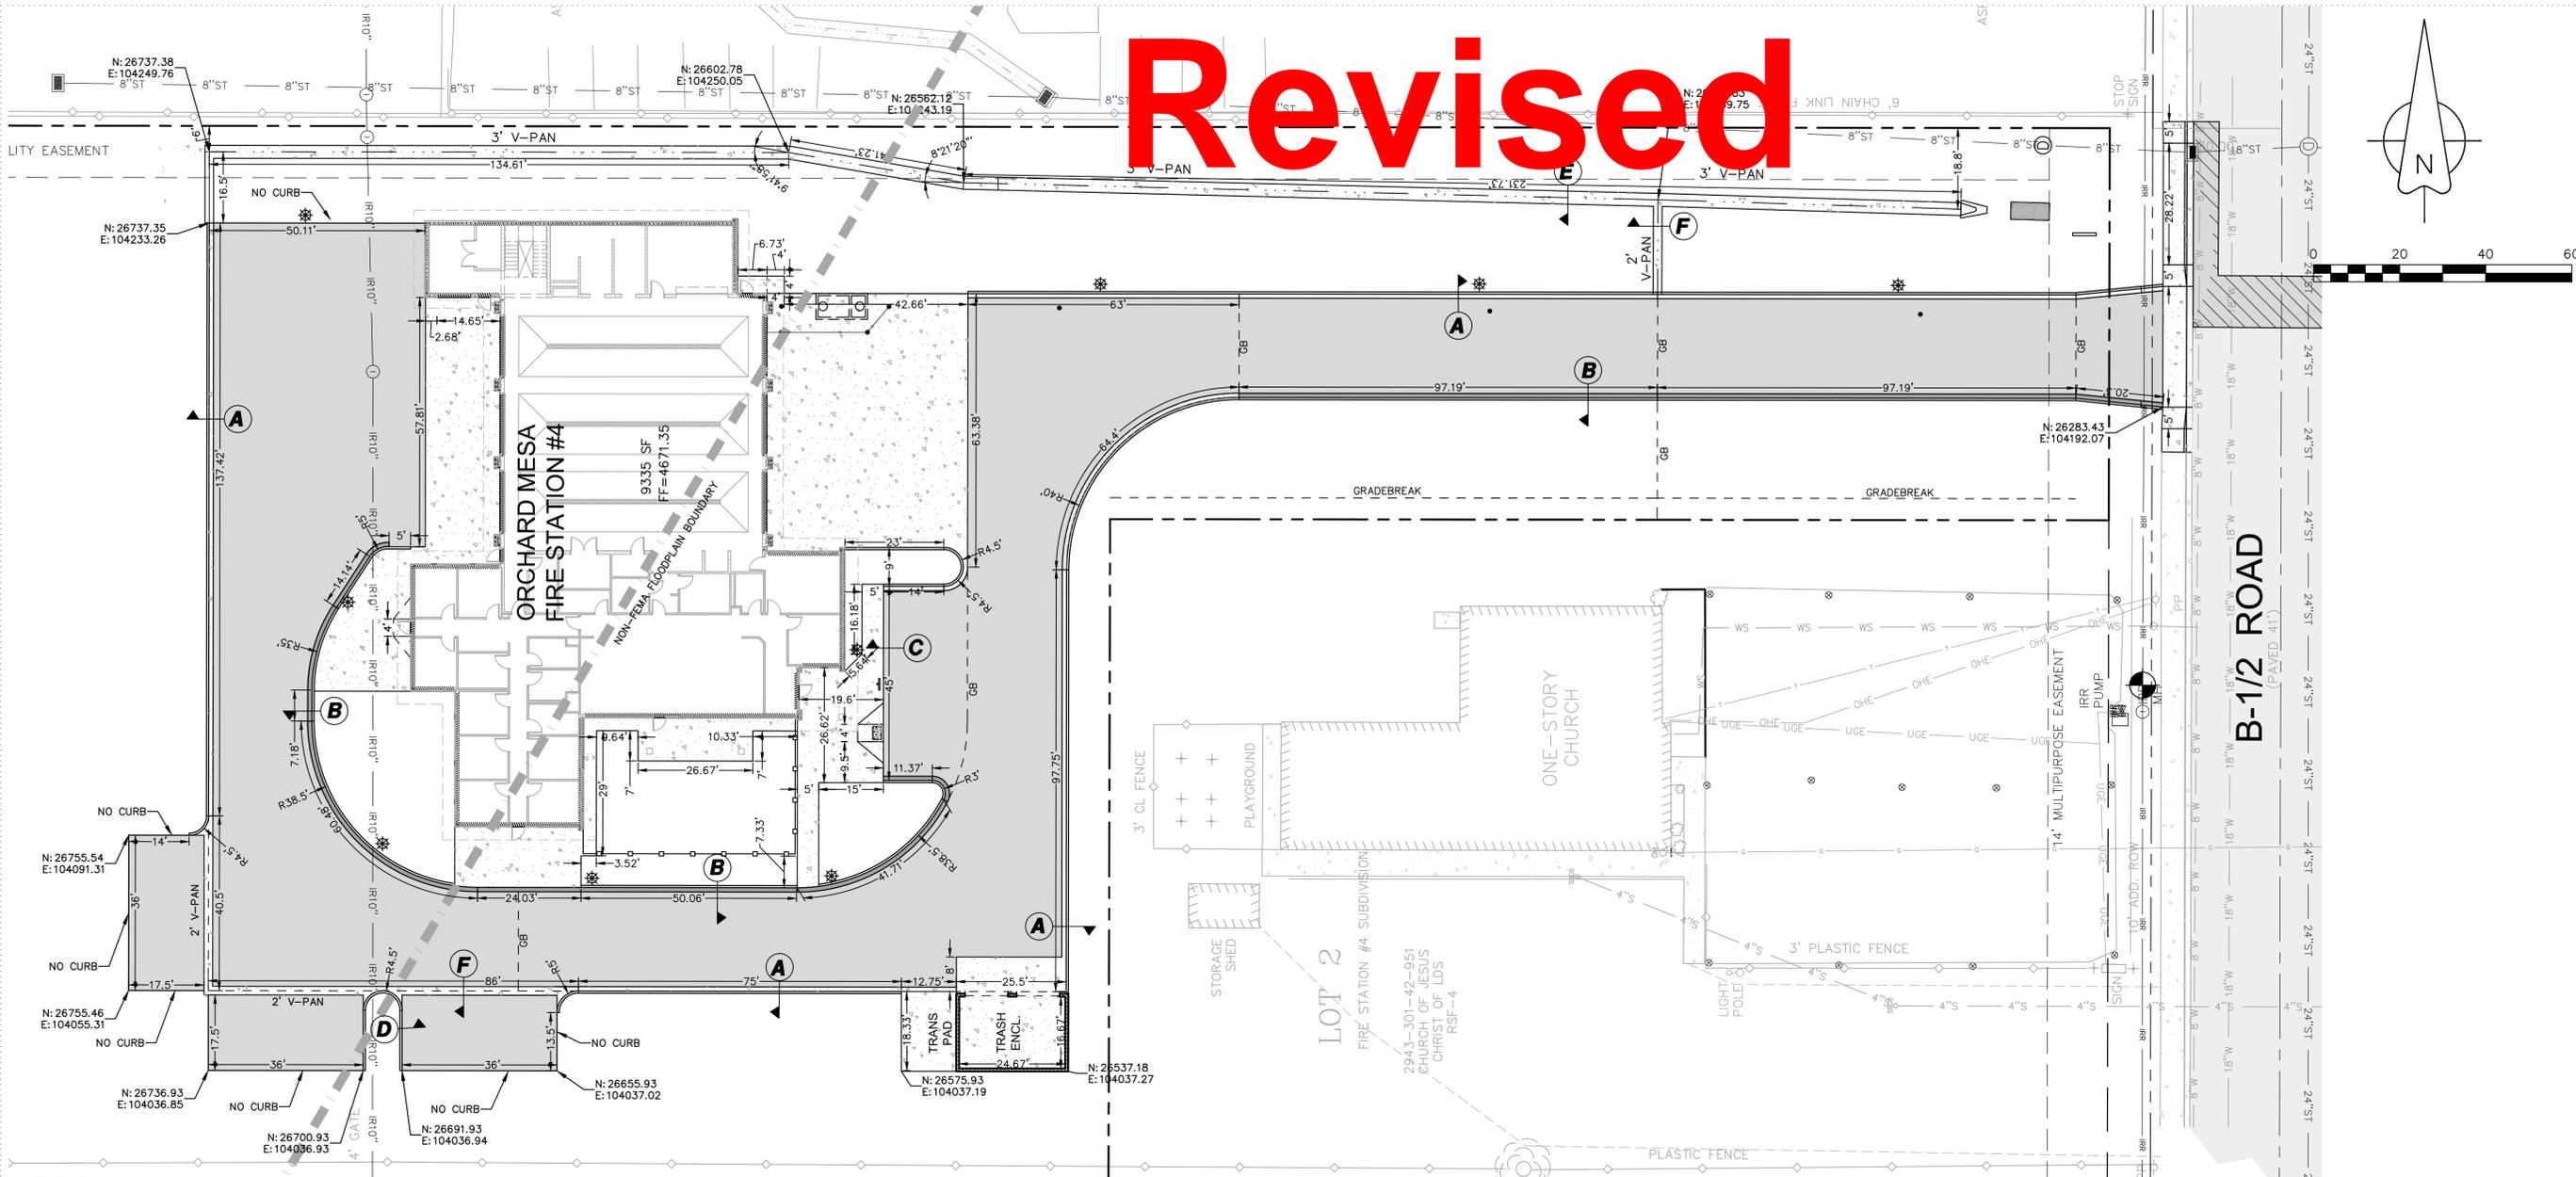

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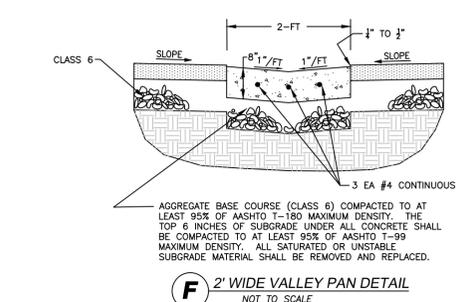
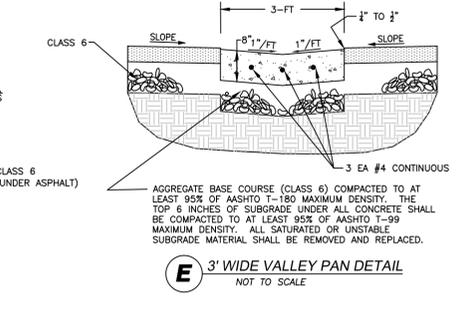
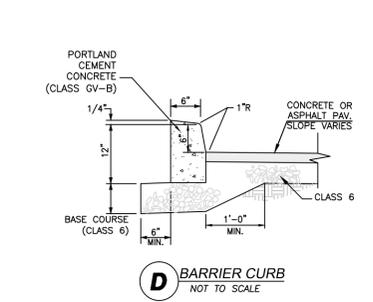
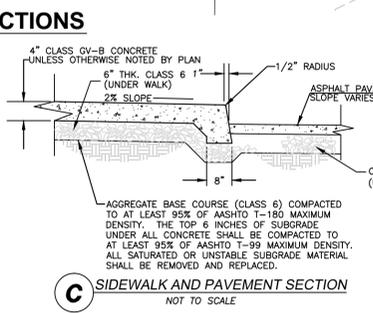
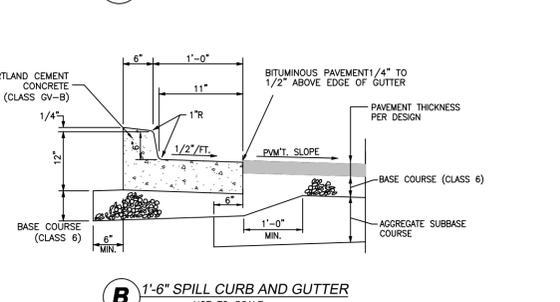
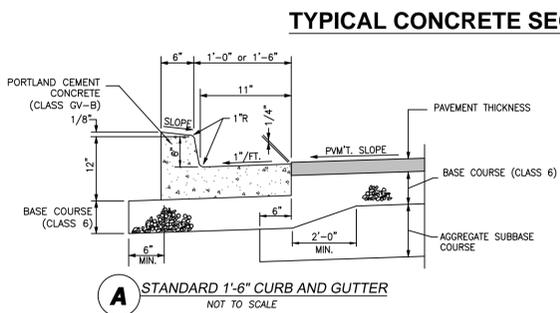


ORCHARD MESA FIRE STATION #4

GRAND JUNCTION, COLORADO

HORIZONTAL CONTROL PLAN

LEGEND	
	PROPERTY LINE
	ADJACENT PROPERTY LINE
	EXISTING EASEMENT
	PROPOSED EASEMENT
	EXISTING BUILDING
	PROPOSED BUILDING
	EXISTING CURB/GUTTER
	PROPOSED CURB/GUTTER
	PROPOSED SPILL CURB/GUTTER
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	EXISTING RETAINING WALL
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	TBW
	TC
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	LS
	LANDSCAPE AREA
	UTILITY PEDESTALS



CITY OF GRAND JUNCTION ENGINEERING
 APPROVED FOR CONSTRUCTION FOR ONE YEAR FROM THIS DATE.

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BY: _____ DATE: _____

NO: _____ ISSUED FOR: _____ DATE: _____

PROJECT STATUS: 100% CD



DRAWN BY: LMS CHECKED BY: MIRA

DATE: 4-10-15 SHEET NO: C-7

PROJECT NO: 1443

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ORCHARD MESA FIRE STATION #4

GRAND JUNCTION, COLORADO

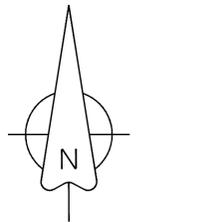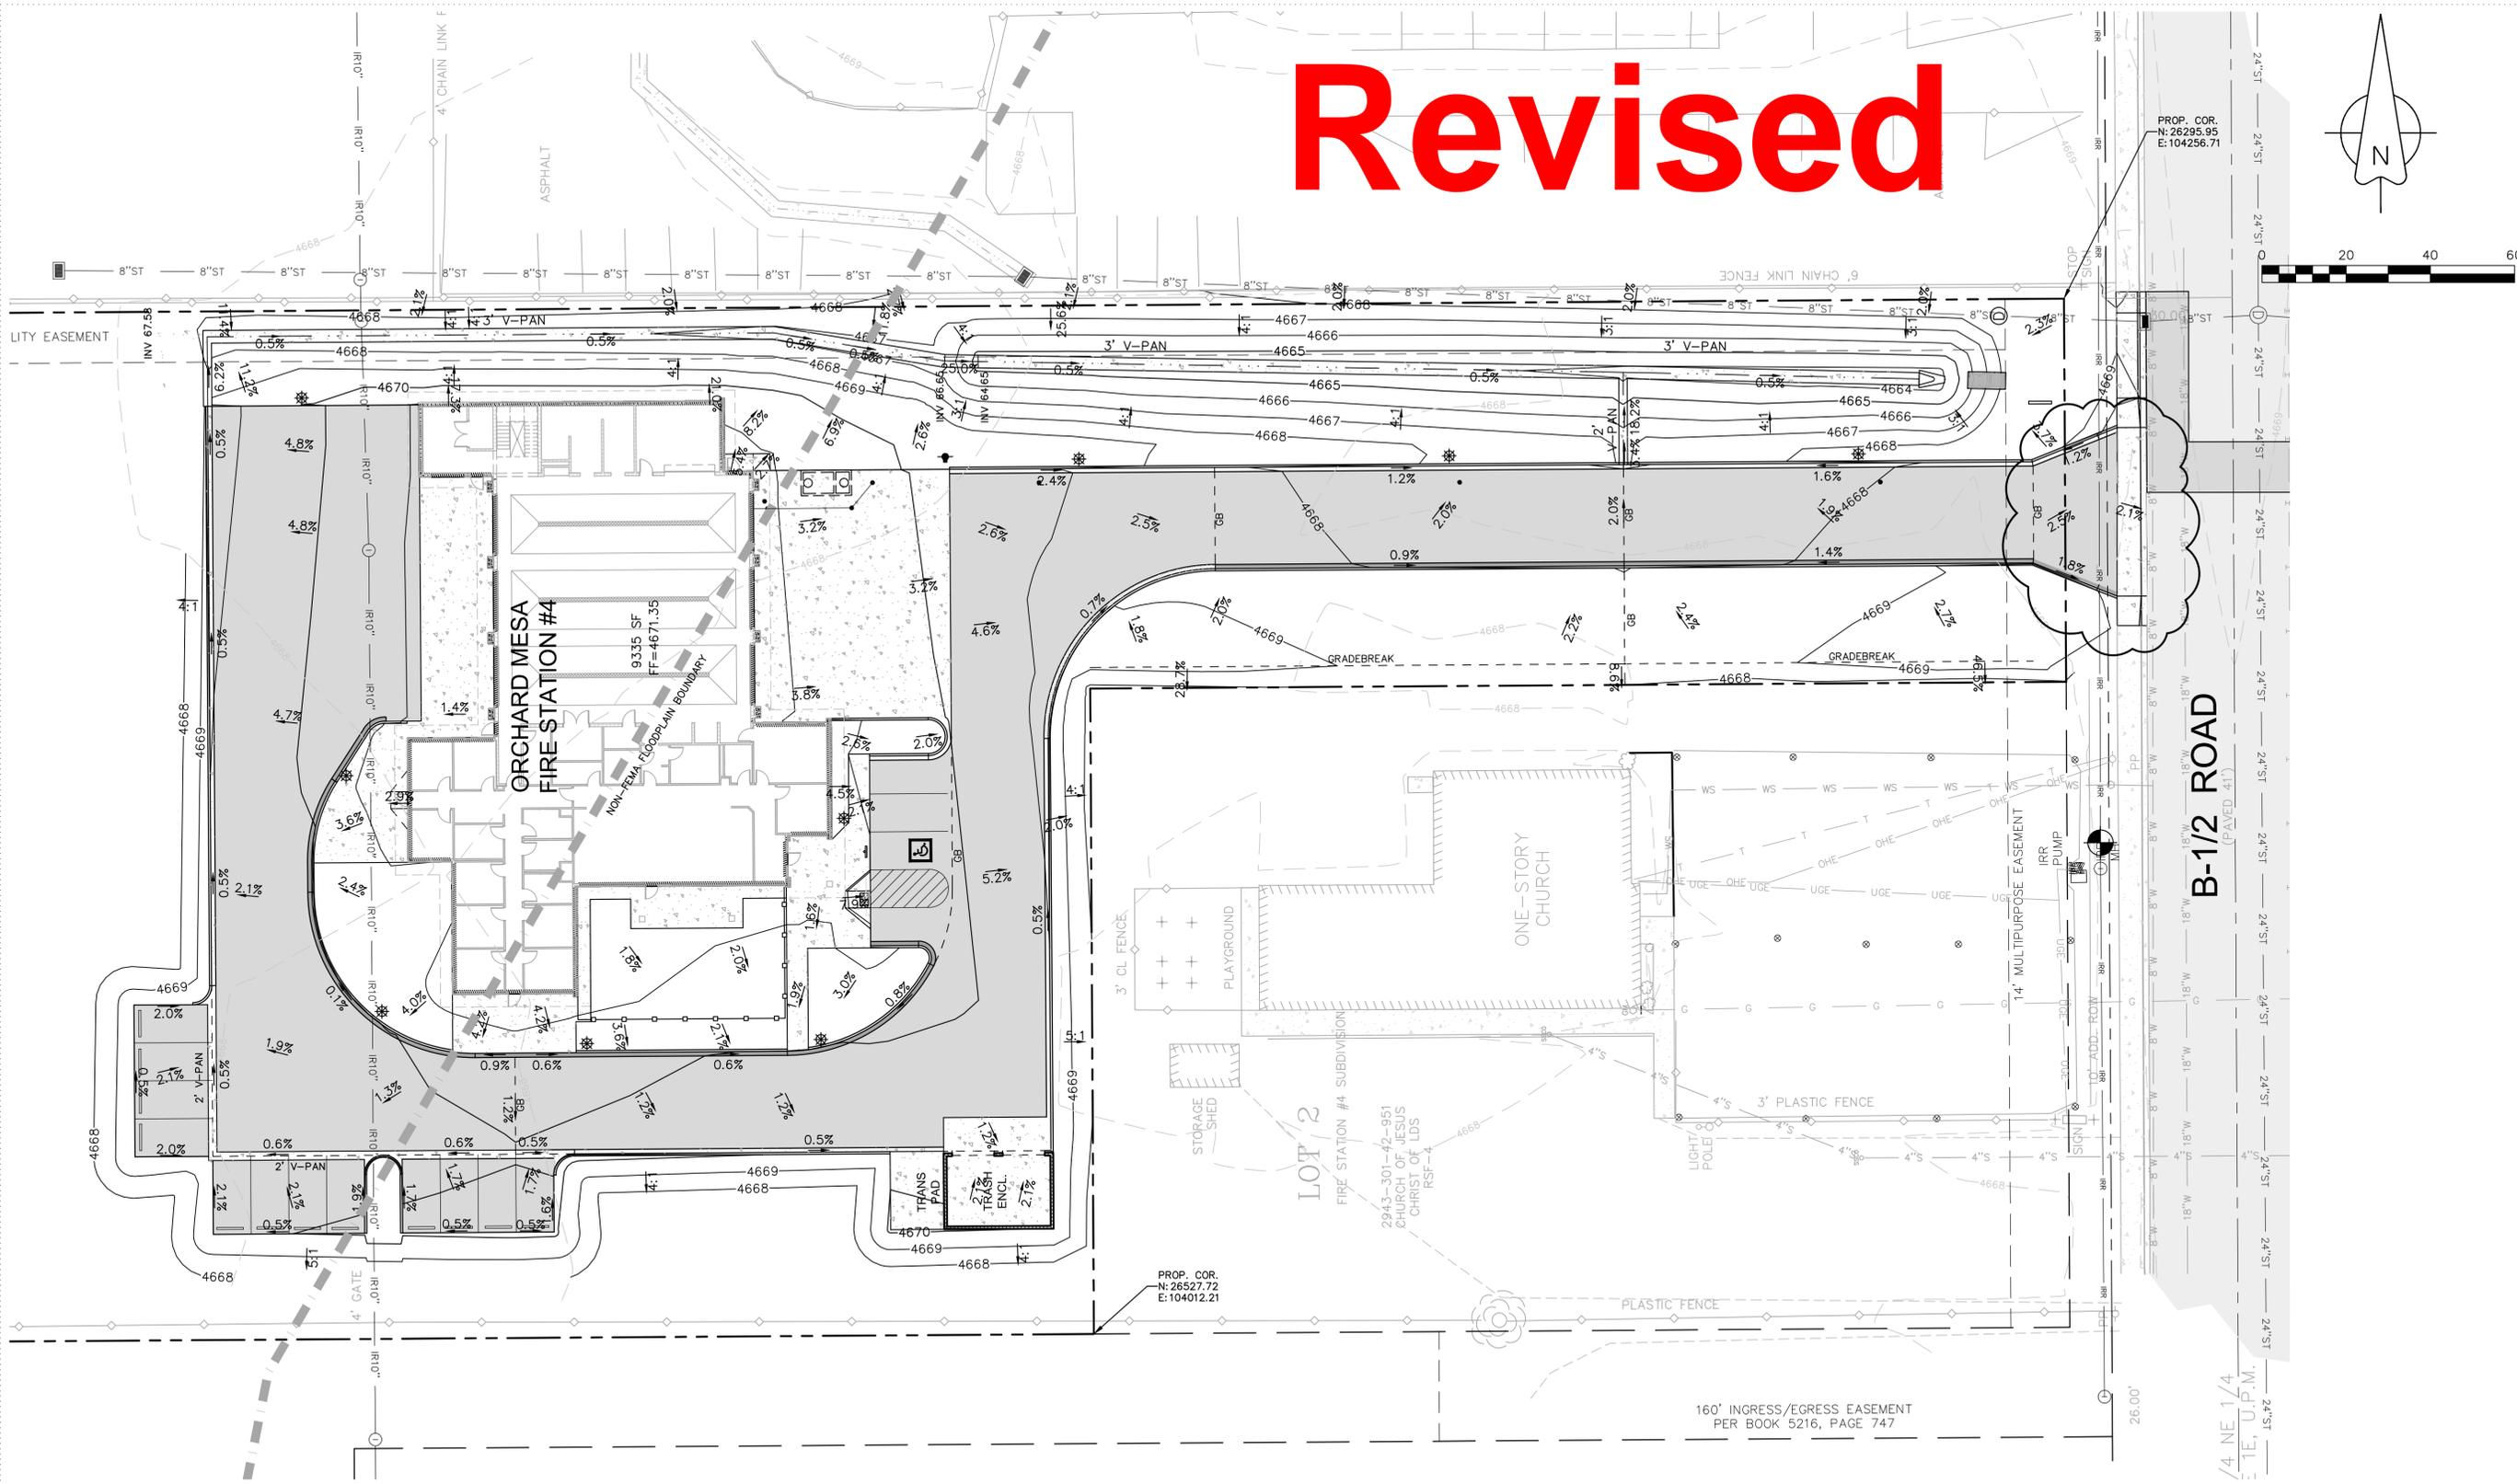OVERALL GRADING PLAN

NO: REVIEW COMMENTS RND#1
ISSUED FOR: 4-28-15
DATE: 4-28-15

PROJECT STATUS: 100% CD

DRAWN BY: LMS CHECKED BY: MRA

DATE: 4-10-15 SHEET NO:

PROJECT NO: 1443 **C-8**


FLOODPLAIN INFORMATION
As shown by plan view, the project site is located within a NON-FEMA 100-year floodplain boundary according to the "Orchard Mesa Flood Hazard Mitigation Report", dated July 2009, and prepared by Ayres Associates. The report identifies a 100-year water surface elevation of approximately 4669.35 (NAVD88) near the center of the site, which shall be used as the floodplain elevation.

BENCHMARK
60D NAIL
N: 26287.81
E: 104125.06
ELEV: 4668.30
NAVD88
NAD83
(PER CITY OF GRAND JUNCTION)

CITY OF GRAND JUNCTION ENGINEERING
APPROVED FOR CONSTRUCTION FOR ONE YEAR FROM THIS DATE.
BY: _____ DATE: _____
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ORCHARD MESA FIRE STATION #4

GRAND JUNCTION, COLORADO

OVERALL GRADING PLAN

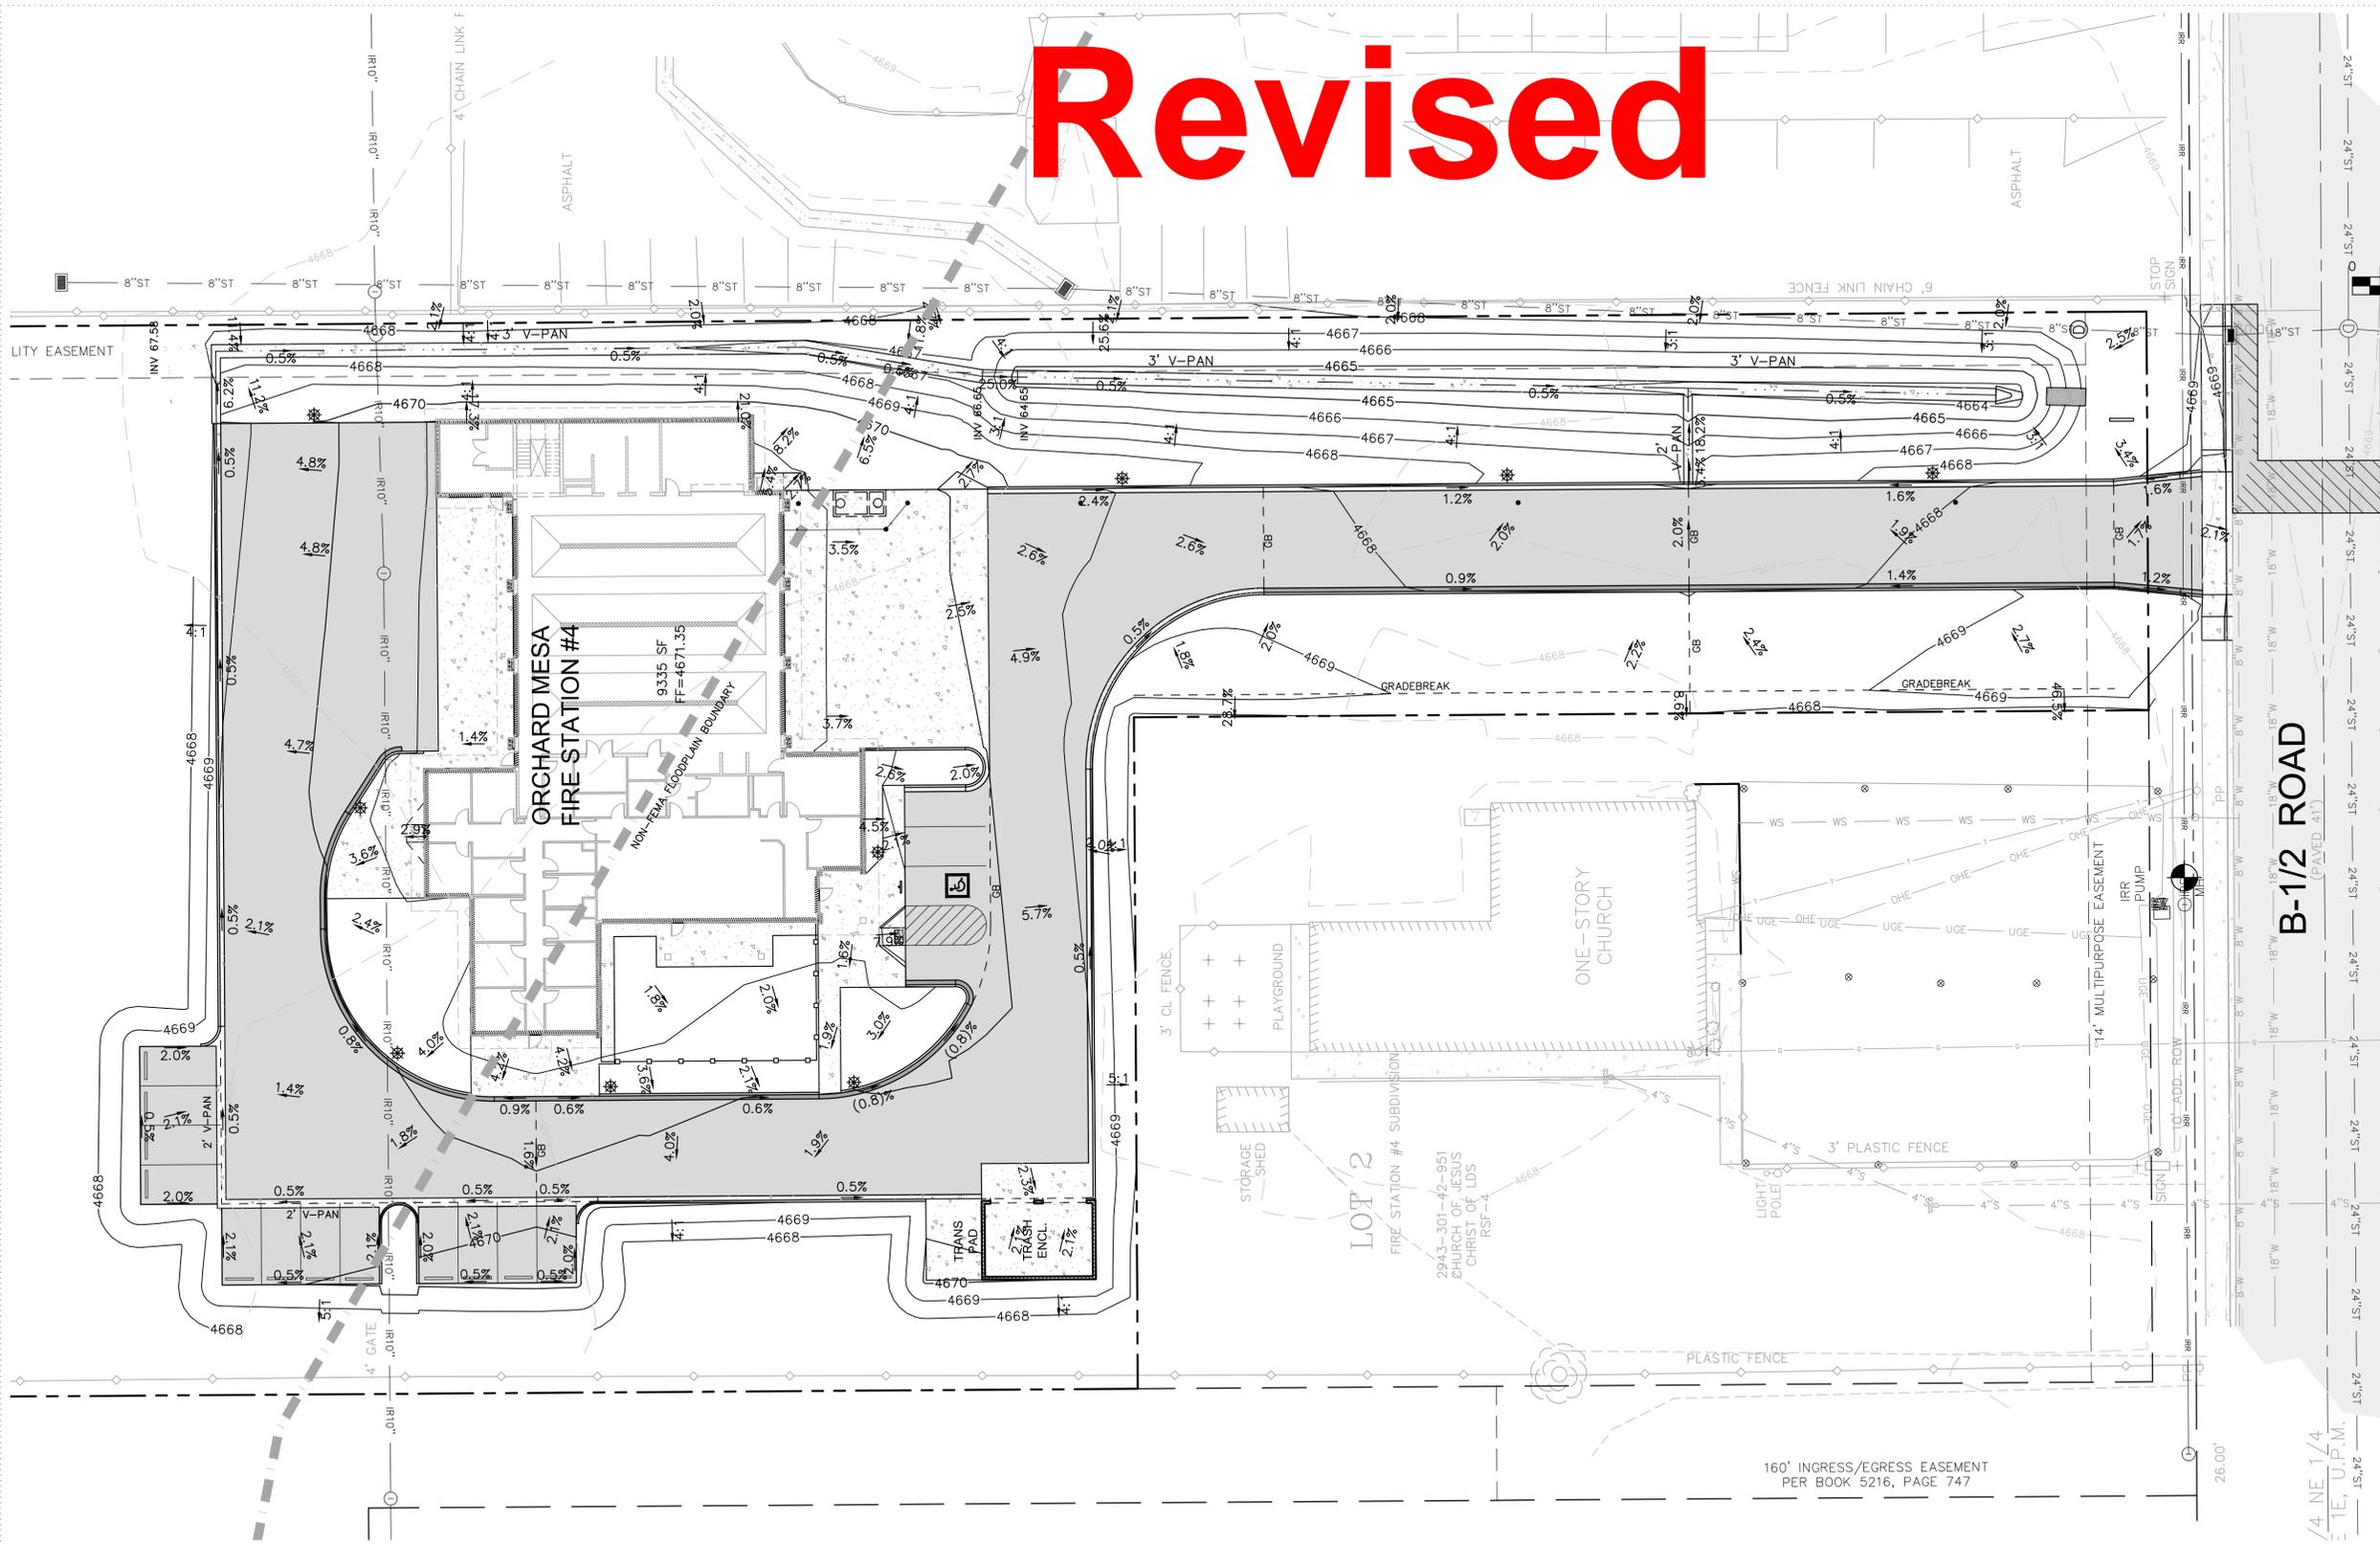NO: _____ ISSUED FOR: _____ DATE: _____



PROJECT STATUS: 100% CD

DRAWN BY: LMS CHECKED BY: MRA

DATE: 4-10-15

SHEET NO.

PROJECT NO: 1443

C-8

CITY OF GRAND JUNCTION ENGINEERING	
APPROVED FOR CONSTRUCTION FOR ONE YEAR FROM THIS DATE.	
BY: _____	DATE: _____
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12/17/2014 3:37:28 PM
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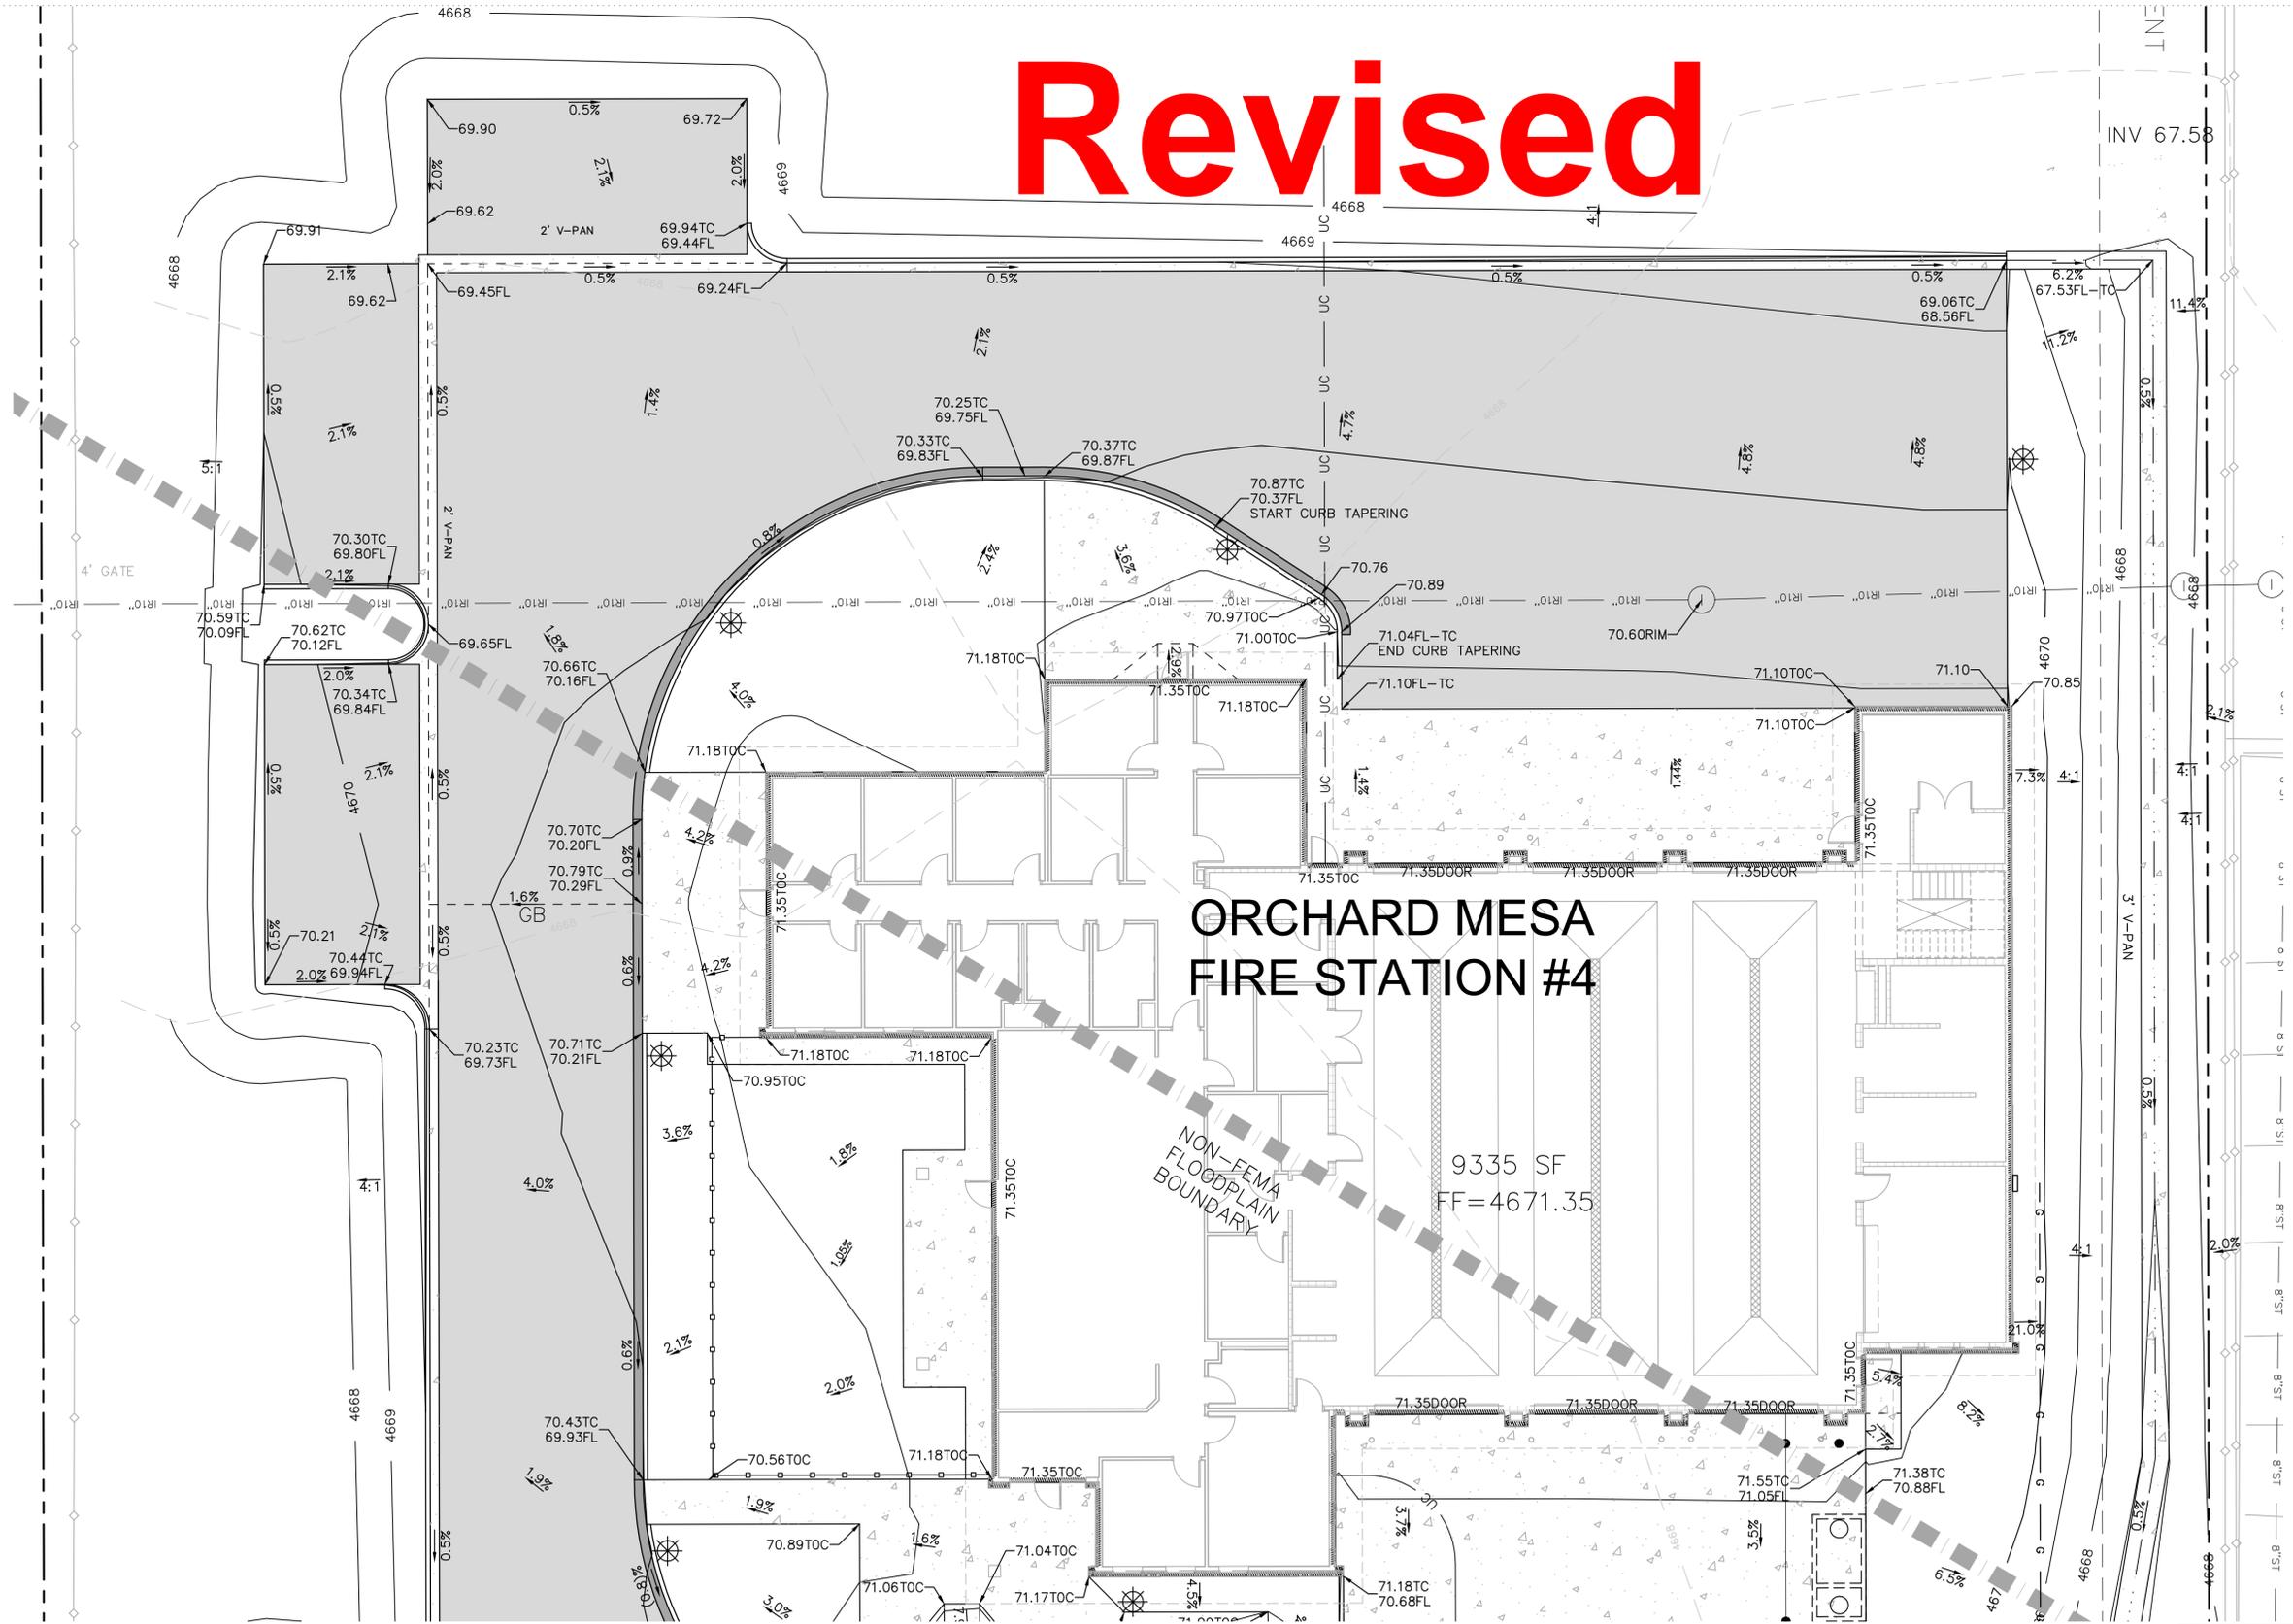
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(970) 242-7540



ORCHARD MESA FIRE STATION #4

9335 SF
FF=4671.35

NON-FEMA
FLOODPLAIN
BOUNDARY



FLOODPLAIN INFORMATION
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CITY OF GRAND JUNCTION ENGINEERING
APPROVED FOR CONSTRUCTION FOR ONE YEAR FROM THIS DATE.
BY: _____ DATE: _____
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BY: _____ DATE: _____

PROJECT STATUS: 100% CD
DRAWN BY: LMS CHECKED BY: MRA
DATE: 4-10-15 SHEET NO. C-9

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STATION #4.dwg

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IRRIGATION NOTES:

1. CONTRACTOR SHALL INSTALL TWO UNDERGROUND PRESSURIZED AUTOMATIC IRRIGATION SYSTEMS FOR THE SITE. SEE THE IRRIGATION PLANS FOR THE DESIGN & PROPOSED LOCATIONS OF THE DITCH WATER IRRIGATION PUMP, IRRIGATION CONTROLLER, AND THE DOMESTIC WATER BACKFLOW PREVENTER.
2. THE LAWN AND DROUGHT TOLERANT GRASS AREAS ARE TO BE IRRIGATED WITH NON-POTABLE DITCH IRRIGATION WATER. A PUMP AND FILTER SHALL BE INSTALLED ACCORDING TO INDUSTRY GUIDELINES. SEE THE IRRIGATION PLANS.
3. A DRIP IRRIGATION SYSTEM SHALL BE INSTALLED TO WATER ALL TREES, SHRUBS, ORNAMENTAL GRASS, AND PERENNIALS. THIS SYSTEM WILL USE POTABLE WATER AND IS TO BE TIED INTO THE DOMESTIC WATER LINE AT AN APPROPRIATE CONNECTING POINT. SEE THE IRRIGATION PLANS.
5. ALL IRRIGATION SYSTEMS SHALL BE INSTALLED BY AN EXPERIENCED LANDSCAPE CONTRACTOR FOR A FULLY FUNCTIONING, FULL-COVERAGE IRRIGATION SYSTEM. THE SYSTEM SHALL BE GUARANTEED BY THE CONTRACTOR FOR A MINIMUM OF ONE YEAR.
6. THE CONTRACTOR SHALL WINTERIZE THE IRRIGATION SYSTEMS IN THE FALL AND PROVIDE SPRING START-UP DURING THE ONE-YEAR WARRANTY PERIOD.



CITY OF GRAND JUNCTION LANDSCAPE REQUIREMENTS:
154,544 SF (3.55 ACRES) SITE OF WHICH
74,350 SF AREA IS DEVELOPED, 80,194 SF LEFT NATIVE

74,350 / 2500 = 30 REQUIRED TREES
74,350 / 300 = 248 REQUIRED SHRUBS

EXISTING TREES ALONG WEST PROPERTY LINE =
22 EXISTING TREES WITH CALIPERS RANGING FROM 4" - 12":

4" CALIPER X 12 = 48" CALIPER
5" CALIPER X 4 = 20" CALIPER
6" CALIPER X 2 = 12" CALIPER
7" CALIPER X 2 = 14" CALIPER
8" CALIPER X 1 = 8" CALIPER
12" CALIPER X 1 = 12" CALIPER
22 TREES = 114" CALIPER

30 TREES REQUIRED X 2" CALIPER = 60" CALIPER REQUIRED
114" EXISTING CALIPER - 60" REQUIRED = 54" CALIPER
ADDITIONAL = NO TREES REQUIRED EXCEPT PER CODE AREAS
INCLUDING: PARKING LOTS PERIMETER, PARKING LOT ISLANDS,
ROAD FRONTAGES, BUFFERS, AND BUILDING PERIMETER.

SHRUB REDUCTION =
54" CALIPER ADDITIONAL X -3 SHRUBS/1" CALIPER ADDITIONAL =
54" ADDITIONAL X -3 = 162 SHRUBS
248 SHRUBS REQUIRED - 162 SHRUBS = 86 SHRUBS REQ.

CONVERT 21 SHRUBS TO PERENNIALS AT THE 3:1 PERENNIAL
TO SHRUB RATIO = 63 PERENNIALS
86 - 21 SHRUBS = 65 SHRUBS REQUIRED

TREES REQUIRED = 18 TREES (2" CALIPER)
TREES PROVIDED = 18 TREES (2" CALIPER)

5-GALLON SHRUBS REQUIRED = 65 SHRUBS (5-GALLON)
5-GALLON SHRUBS PROVIDED = 72 SHRUBS (5-GALLON)

1-GALLON PERENNIALS REQUIRED = 63 PERENNIALS
1-GALLON PERENNIALS PROVIDED = 72 PERENNIALS

ORCHARD MESA FIRE STATION #4

GRAND JUNCTION, COLORADO

LANDSCAPE PLAN

NO: ISSUED FOR: DATE:
ADDENDUM #1 4/28/2015


PROJECT STATUS:
100% CD's

DRAWN BY: JW CHECKED BY: JW

DATE:
04-10-15 SHEET NO:

PROJECT NO:
1443 **L101**

Addendum 1

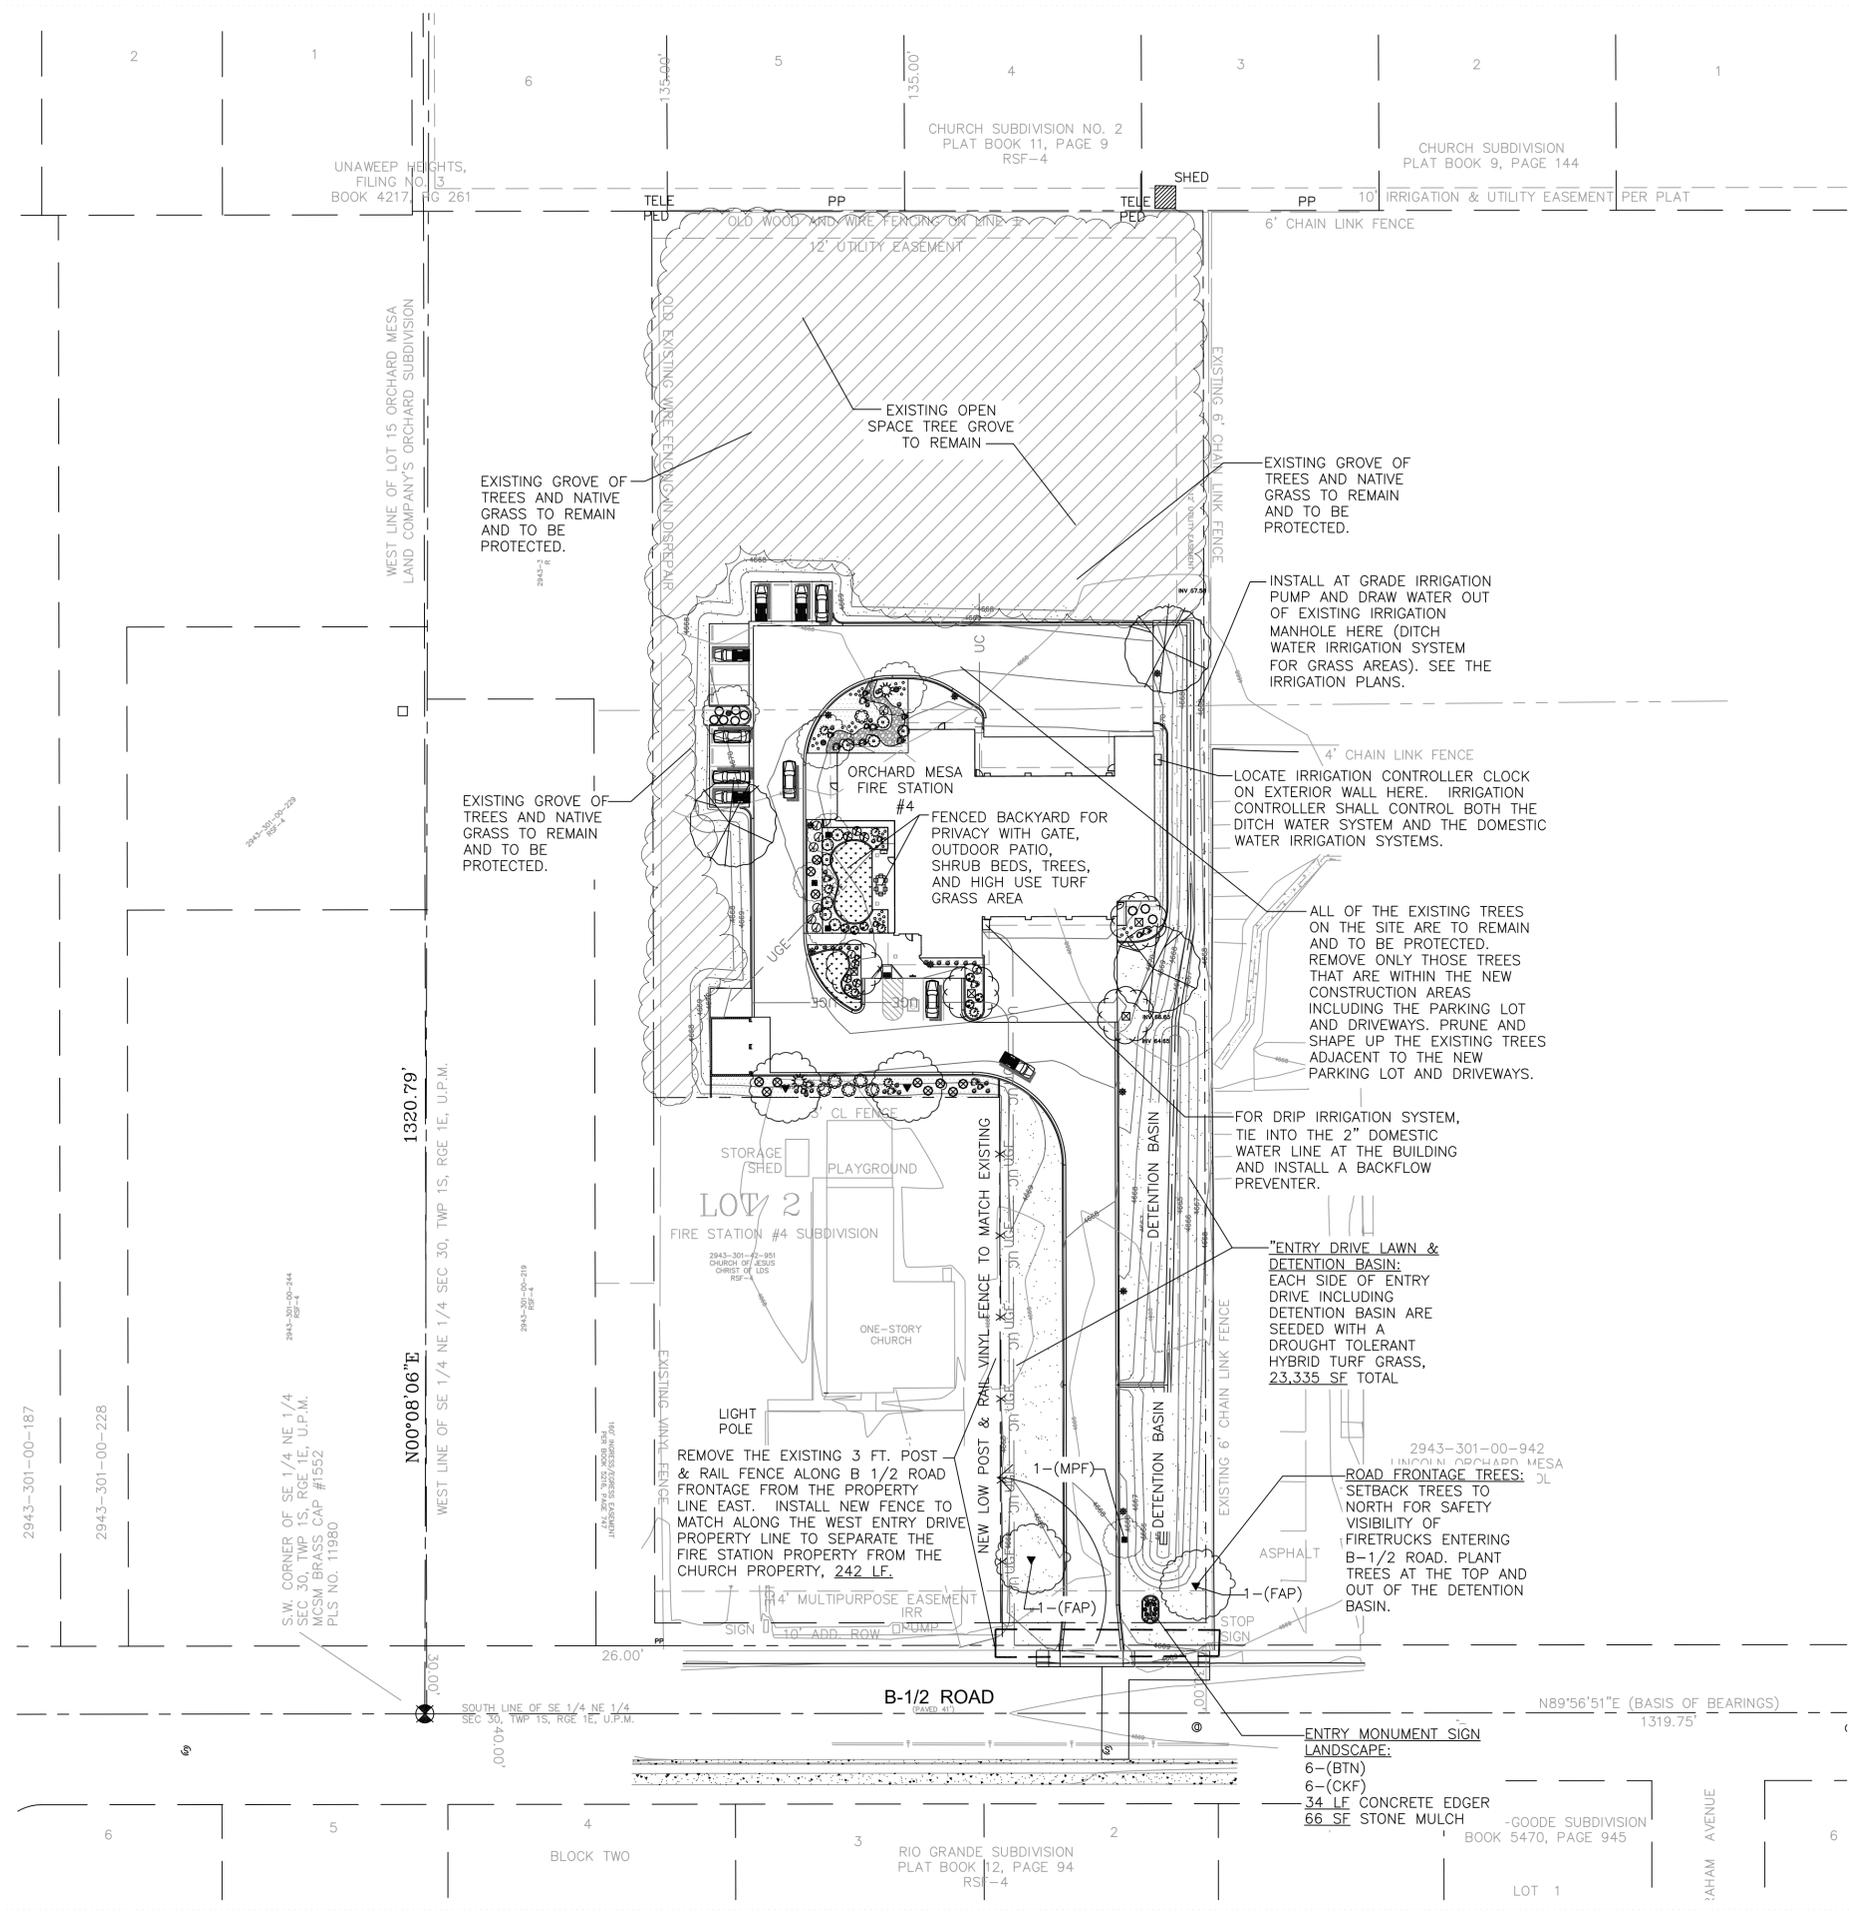

LANDSCAPE MASTER PLAN

Scale: 1" = 40'-0"



Julee Wolverson,
Landscape Architect
61945 Nighthawk Road
Montrose, CO 81403
p: 970.249.9392
c: 970.417.1779
wolverson@montrose.net

CITY OF GRAND JUNCTION COMMUNITY DEVELOPMENT	
BY: _____	DATE: _____
CITY OF GRAND JUNCTION ENGINEERING	
APPROVED FOR CONSTRUCTION FOR ONE YEAR FROM THIS DATE.	
BY: _____	DATE: _____
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**ORCHARD MESA
FIRE STATION #4**

GRAND JUNCTION, COLORADO

**LANDSCAPE
ENLARGEMENT
PLAN**

NO: ISSUED FOR: DATE:
ADDENDUM #1 4/28/2015

PROJECT STATUS:
100% CD's

DRAWN BY: JW CHECKED BY: JW

DATE:
04-10-15 SHEET NO:

PROJECT NO:
1443 **L201**

LANDSCAPE NOTES:

- SOIL AMENDMENT - INCORPORATE 5 CUBIC YARDS/1,000 SF AREA OF PREMIUM 3 ORGANIC COMPOST (TYPE 2) INTO TURF AREAS. AMEND SOIL PER THE GUIDELINES LISTED BELOW TO ADDRESS DEFICIENCIES NOTED IN THE SOIL ANALYSIS:
 - SALT LEVEL EQUAL TO OR LESS THAN 6 MMHOS/EM
 - pH LEVEL EQUAL TO OR LESS THAN 7
 - ORGANIC MATTER CONTENT EQUAL TO OR GREATER THAN 85%
 - NITROGEN: CARBON: BETWEEN 20:1 AND 30:1
 - PARTICLE SIZE: THE COURSER THE BETTER, NOT SILT OR CLAY SIZE PARTICLES
- CONTRACTOR TO UTILIZE STOCKPILED TOPSOIL FROM GRADING OPERATION AS AVAILABLE. TILL INTO TOP 6" OF SOIL.
- FOR GRADING PLAN, REFER TO CIVIL ENGINEER DRAWINGS. ALL TURF GRASS AREAS, BERMS, & SHRUB BEDS DO NOT EXCEED 3:1 SLOPE.
- ALL TREES AND SHRUBS TO RECEIVE A BACK FILL MIXTURE OF 1/3 SOIL CONDITIONER TO 2/3 TOPSOIL.
- ALL TREES TO BE STAKED WITH STAKES PER THE DETAIL. FOR 3" CALIPER DECIDUOUS TREES AND EVERGREEN TREES OVER 8 FT., USE 3 STAKES (STAKE TO GROUND LEVEL).
- ALL PLANTS TO RECEIVE 3" DEPTH OF SHREDDED CEDAR BARK MULCH AROUND THE BASE OF EACH PLANT UNLESS OTHERWISE SPECIFIED. MULCH AROUND BASE OF TREES 2 FT. DIAMETER MINIMUM, AND SHRUBS 1 FT. DIAMETER MINIMUM.
- INSTALL 3" OF SPECIFIED STONE MULCH (NO LANDSCAPE FABRIC) THROUGHOUT ALL NON-TURF GRASS AREAS. SEE THE PLAN FOR LOCATIONS.
- ALL SHRUB BED AREAS AND GRASS AREAS TO BE SEPARATED BY AN EXTRUDED CONCRETE EDGER. SEE THE PLAN FOR LOCATIONS.
- NO PLANT MATERIAL SHALL BE LOCATED WITHIN 3 FT. OF A FIRE HYDRANT.
- PLANT MATERIAL WAS CHOSEN FOR ITS SPECIFIC VARIETY, HEIGHT, AND COLOR. ANY PLANT MATERIAL SUBSTITUTIONS MUST BE APPROVED BY THE LANDSCAPE ARCHITECT PRIOR TO CONSTRUCTION.
- LOCATE AND MARK LOCATIONS OF ALL UTILITIES PRIOR TO INSTALLING PLANT MATERIAL. DO NOT PLANT ANY TREES OR SHRUBS DIRECTLY OVER BURIED UTILITY LINES, OR ANY TREES UNDER OVERHEAD UTILITY LINES.
- WHEN PLANTING TREES OR SHRUBS, THOROUGHLY SOAK PLANTING HOLE WHILE BACKFILLING. PRUNE DEAD OR DAMAGED BRANCHES IMMEDIATELY AFTER PLANTING. FERTILIZE WITH AGRIFORM 21 GRAM PLANT TABLETS, 20-10-5. 6 TABLETS PER TREE, AND 3 PER SHRUB.
- FOR GRASS AREAS, ROTOTILL 5 CY PER 1,000 SF OF SOIL AMENDMENT INTO THE TOP 6" OF TOPSOIL. FINE GRADE AND RAKE SMOOTH. NO CLODS GREATER THAN 2" ALLOWED. INSTALL SOD OR DRILL SEED PER THE SUPPLIER RECOMMENDATIONS.

14. ALL PLANT MATERIAL SHALL CONFORM TO THE AMERICAN STANDARDS FOR NURSERY STOCK, CURRENT EDITION. PLANTING SHALL BE DONE IN CONFORMANCE WITH THE ASSOCIATED LANDSCAPE CONTRACTORS OF COLORADO (A.L.C.C.) SPECIFICATIONS AND SHALL BE MAINTAINED BY THE CONTRACTOR UNTIL FINAL ACCEPTANCE. THE CONTRACTOR SHALL GUARANTEE IRRIGATION SYSTEM AND ALL PLANT MATERIAL FOR A PERIOD OF ONE YEAR FROM FINAL ACCEPTANCE. ANY DEAD OR DYING PLANT SHALL BE REPLACED WITH SAME. THE CONTRACTOR SHALL WINTERIZE IRRIGATION SYSTEM IN FALL AND PROVIDE SPRING START-UP DURING ONE-YEAR WARRANTY PERIOD.

**LANDSCAPE
ENLARGEMENT PLAN**

Scale: 1" = 20'-0"




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Revised



EXISTING GROVE OF TREES AND NATIVE GRASS TO REMAIN AND TO BE PROTECTED.

EXISTING GROVE OF TREES AND NATIVE GRASS TO REMAIN AND TO BE PROTECTED.

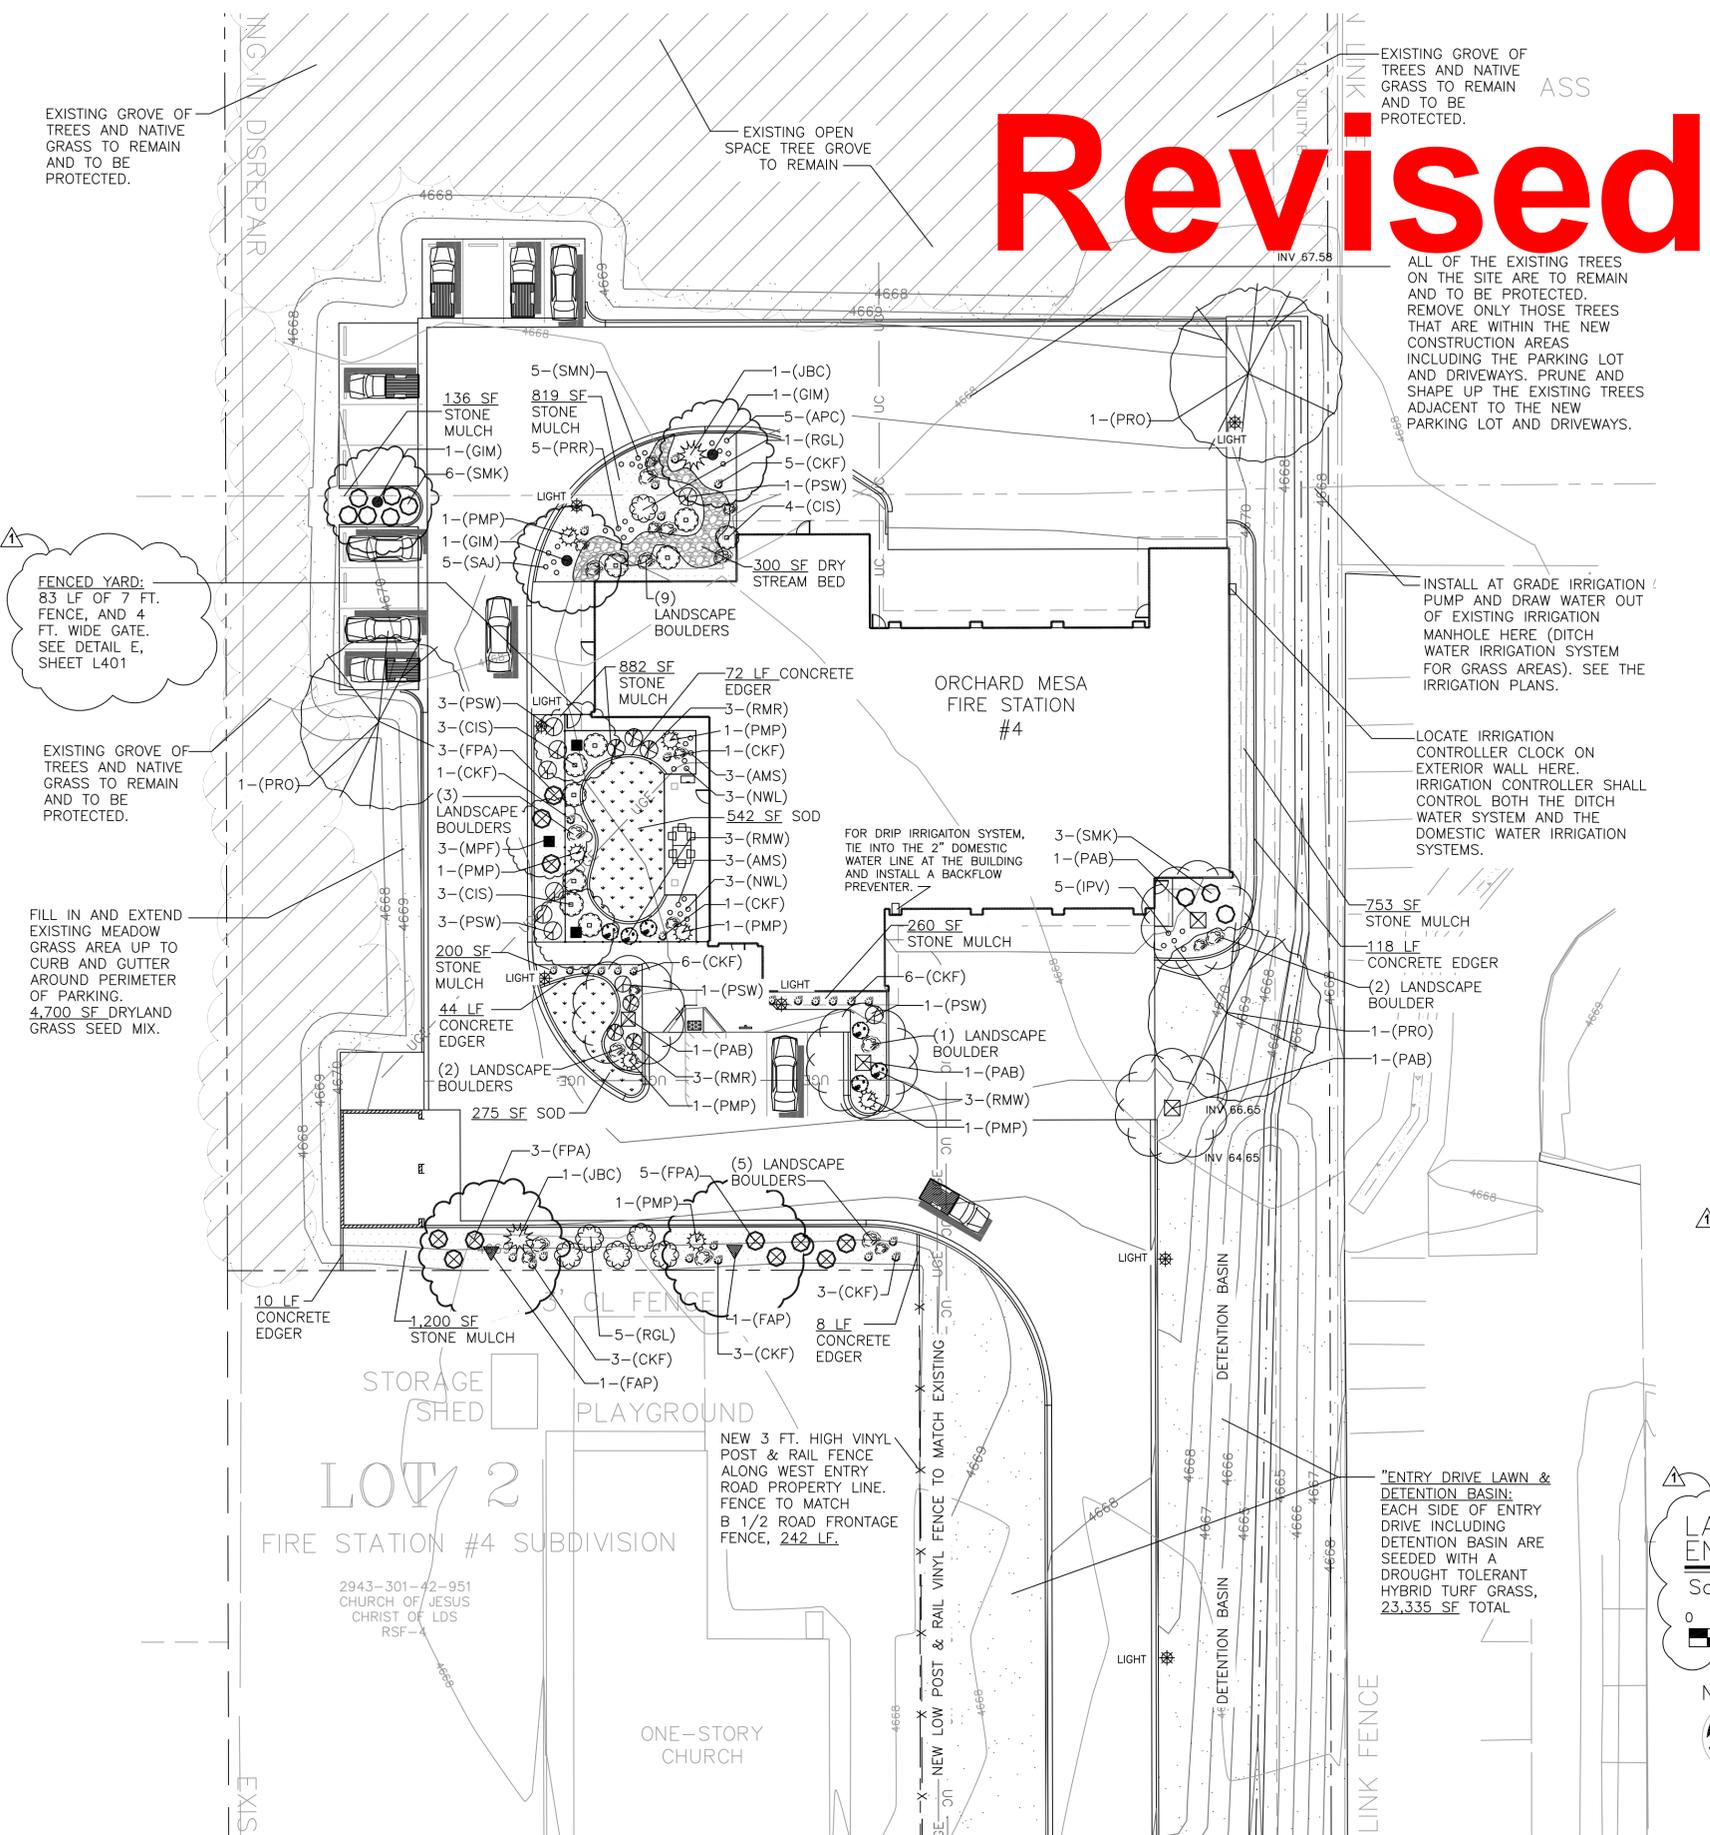FENCED YARD: 83 LF OF 7 FT. FENCE, AND 4 FT. WIDE GATE. SEE DETAIL E, SHEET L401

EXISTING GROVE OF TREES AND NATIVE GRASS TO REMAIN AND TO BE PROTECTED.

FILL IN AND EXTEND EXISTING MEADOW GRASS AREA UP TO CURB AND GUTTER AROUND PERIMETER OF PARKING. 4,700 SF DRYLAND GRASS SEED MIX.

ALL OF THE EXISTING TREES ON THE SITE ARE TO REMAIN AND TO BE PROTECTED. REMOVE ONLY THOSE TREES THAT ARE WITHIN THE NEW CONSTRUCTION AREAS INCLUDING THE PARKING LOT AND DRIVEWAYS. PRUNE AND SHAPE UP THE EXISTING TREES ADJACENT TO THE NEW PARKING LOT AND DRIVEWAYS.

INSTALL AT GRADE IRRIGATION PUMP AND DRAW WATER OUT OF EXISTING IRRIGATION MANHOLE HERE (DITCH WATER IRRIGATION SYSTEM FOR GRASS AREAS). SEE THE IRRIGATION PLANS.

LOCATE IRRIGATION CONTROLLER CLOCK ON EXTERIOR WALL HERE. IRRIGATION CONTROLLER SHALL CONTROL BOTH THE DITCH WATER SYSTEM AND THE DOMESTIC WATER IRRIGATION SYSTEMS.

FOR DRIP IRRIGATION SYSTEM, TIE INTO THE 2" DOMESTIC WATER LINE AT THE BUILDING AND INSTALL A BACKFLOW PREVENTER.

753 SF STONE MULCH
118 LF CONCRETE EDGER
(2) LANDSCAPE BOULDER

"ENTRY DRIVE LAWN & DETENTION BASIN: EACH SIDE OF ENTRY DRIVE INCLUDING DETENTION BASIN ARE SEEDED WITH A DROUGHT TOLERANT HYBRID TURF GRASS, 23,335 SF TOTAL

NEW 3 FT. HIGH VINYL POST & RAIL FENCE ALONG WEST ENTRY ROAD PROPERTY LINE. FENCE TO MATCH B 1/2 ROAD FRONTAGE FENCE, 242 LF.

LOT 2
FIRE STATION #4 SUBDIVISION
2943-301-42-951
CHURCH OF JESUS CHRIST OF LDS
RSF

ONE-STORY CHURCH

Revised

LANDSCAPE NOTES:

- SOIL AMENDMENT – INCORPORATE 5 CUBIC YARDS/1,000 SF AREA OF PREMIUM 3 ORGANIC COMPOST (TYPE 2) INTO TURF AREAS. AMEND SOIL PER THE GUIDELINES LISTED BELOW TO ADDRESS DEFICIENCIES NOTED IN THE SOIL ANALYSIS:
 - SALT LEVEL EQUAL TO OR LESS THAN 6 MMHOS/EM
 - pH LEVEL EQUAL TO OR LESS THAN 7
 - ORGANIC MATTER CONTENT EQUAL TO OR GREATER THAN 85%
 - NITROGEN: CARBON: BETWEEN 20:1 AND 30:1
 - PARTICLE SIZE: THE COURSER THE BETTER, NOT SILT OR CLAY SIZE PARTICLES

- CONTRACTOR TO UTILIZE STOCKPILED TOPSOIL FROM GRADING OPERATION AS AVAILABLE. TILL INTO TOP 6" OF SOIL.
- FOR GRADING PLAN, REFER TO CIVIL ENGINEER DRAWINGS. ALL TURF GRASS AREAS, BERMS, & SHRUB BEDS DO NOT EXCEED 3:1 SLOPE.

- ALL TREES AND SHRUBS TO RECEIVE A BACK FILL MIXTURE OF 1/3 SOIL CONDITIONER TO 2/3 TOPSOIL.

- ALL TREES TO BE STAKED WITH STAKES PER THE DETAIL. FOR 3" CALIPER DECIDUOUS TREES AND EVERGREEN TREES OVER 8 FT., USE 3 STAKES (STAKE TO GROUND LEVEL).

- ALL PLANTS TO RECEIVE 3" DEPTH OF SHREDDED CEDAR BARK MULCH AROUND THE BASE OF EACH PLANT UNLESS OTHERWISE SPECIFIED. MULCH AROUND BASE OF TREES 2 FT. DIAMETER MINIMUM, AND SHRUBS 1 FT. DIAMETER MINIMUM.

- INSTALL 3" OF SPECIFIED STONE MULCH (NO LANDSCAPE FABRIC) THROUGHOUT ALL NON-TURF GRASS AREAS. SEE THE PLAN FOR LOCATIONS.

- ALL SHRUB BED AREAS AND GRASS AREAS TO BE SEPARATED BY AN EXTRUDED CONCRETE EDGER. SEE THE PLAN FOR LOCATIONS.

- LANDSCAPING SHALL BE PLANTED AND MAINTAINED BY THE OWNER, SUCCESSOR, AND/OR ASSIGNS. SHOULD ANY PLANT MATERIAL DIE, IT SHALL BE REPLACED WITH SIMILAR PLANT MATERIAL WITHIN ONE PLANTING SEASON.

- NO PLANT MATERIAL SHALL BE LOCATED WITHIN 3 FT. OF A FIRE HYDRANT.

- PLANT MATERIAL WAS CHOSEN FOR ITS SPECIFIC VARIETY, HEIGHT, AND COLOR. ANY PLANT MATERIAL SUBSTITUTIONS MUST BE APPROVED BY THE LANDSCAPE ARCHITECT PRIOR TO CONSTRUCTION.

- LOCATE AND MARK LOCATIONS OF ALL UTILITIES PRIOR TO INSTALLING PLANT MATERIAL. DO NOT PLANT ANY TREES OR SHRUBS DIRECTLY OVER BURIED UTILITY LINES, OR ANY TREES UNDER OVERHEAD UTILITY LINES.

- WHEN PLANTING TREES OR SHRUBS, THOROUGHLY SOAK PLANTING HOLE WHILE BACKFILLING. PRUNE DEAD OR DAMAGED BRANCHES IMMEDIATELY AFTER PLANTING. FERTILIZE WITH AGRIFORM 21 GRAM PLANT TABLETS, 20-10-5. 6 TABLETS PER TREE, AND 3 PER SHRUB.

- FOR GRASS AREAS, ROTOTILL 5 CY PER 1,000 SF OF SOIL AMENDMENT INTO THE TOP 6" OF TOPSOIL. FINE GRADE AND RAKE SMOOTH. NO CLODS GREATER THAN 2" ALLOWED. INSTALL SOD OR DRILL SEED PER THE SUPPLIER RECOMMENDATIONS.

- ALL PLANT MATERIAL SHALL CONFORM TO THE AMERICAN STANDARDS FOR NURSERY STOCK, CURRENT EDITION. PLANTING SHALL BE DONE IN CONFORMANCE WITH THE ASSOCIATED LANDSCAPE CONTRACTORS OF COLORADO (A.L.C.C.) SPECIFICATIONS. THE CONTRACTOR SHALL GUARANTEE IRRIGATION SYSTEM AND ALL PLANT MATERIAL FOR A PERIOD OF ONE YEAR FROM FINAL ACCEPTANCE. ANY DEAD OR DYING PLANT SHALL BE REPLACED WITH SAME. THE CONTRACTOR SHALL WINTERIZE IRRIGATION SYSTEM IN FALL AND PROVIDE SPRING START-UP DURING ONE-YEAR WARRANTY PERIOD.

LANDSCAPE ENLARGEMENT PLAN

Scale: 1" = 40'-0"



Julie Wolverton,
Landscape Architect



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wolverton@montrose.net

CITY OF GRAND JUNCTION COMMUNITY DEVELOPMENT	
BY: _____	DATE: _____
CITY OF GRAND JUNCTION ENGINEERING	
APPROVED FOR CONSTRUCTION FOR ONE YEAR FROM THIS DATE.	
BY: _____	DATE: _____
ACCEPTED AS CONSTRUCTED	
BY: _____	DATE: _____

CHAMBERLIN ARCHITECTS

437 Main St.
Grand Junction, Colorado 81501
T 970.242.6804

725 Saint Joseph St., Suite B1
Rapid City, South Dakota 57701
T 605.355.6804

www.chamberlinarchitects.com

ORCHARD MESA FIRE STATION #4

GRAND JUNCTION, COLORADO

LANDSCAPE ENLARGEMENT PLAN

NO: _____ ISSUED FOR: _____ DATE: _____




PROJECT STATUS:
100% CD's

DRAWN BY: JW CHECKED BY: JW

DATE:
04-10-15 SHEET NO:

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1443 **L201**

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EXISTING GROVE OF TREES AND NATIVE GRASS TO REMAIN AND TO BE PROTECTED.

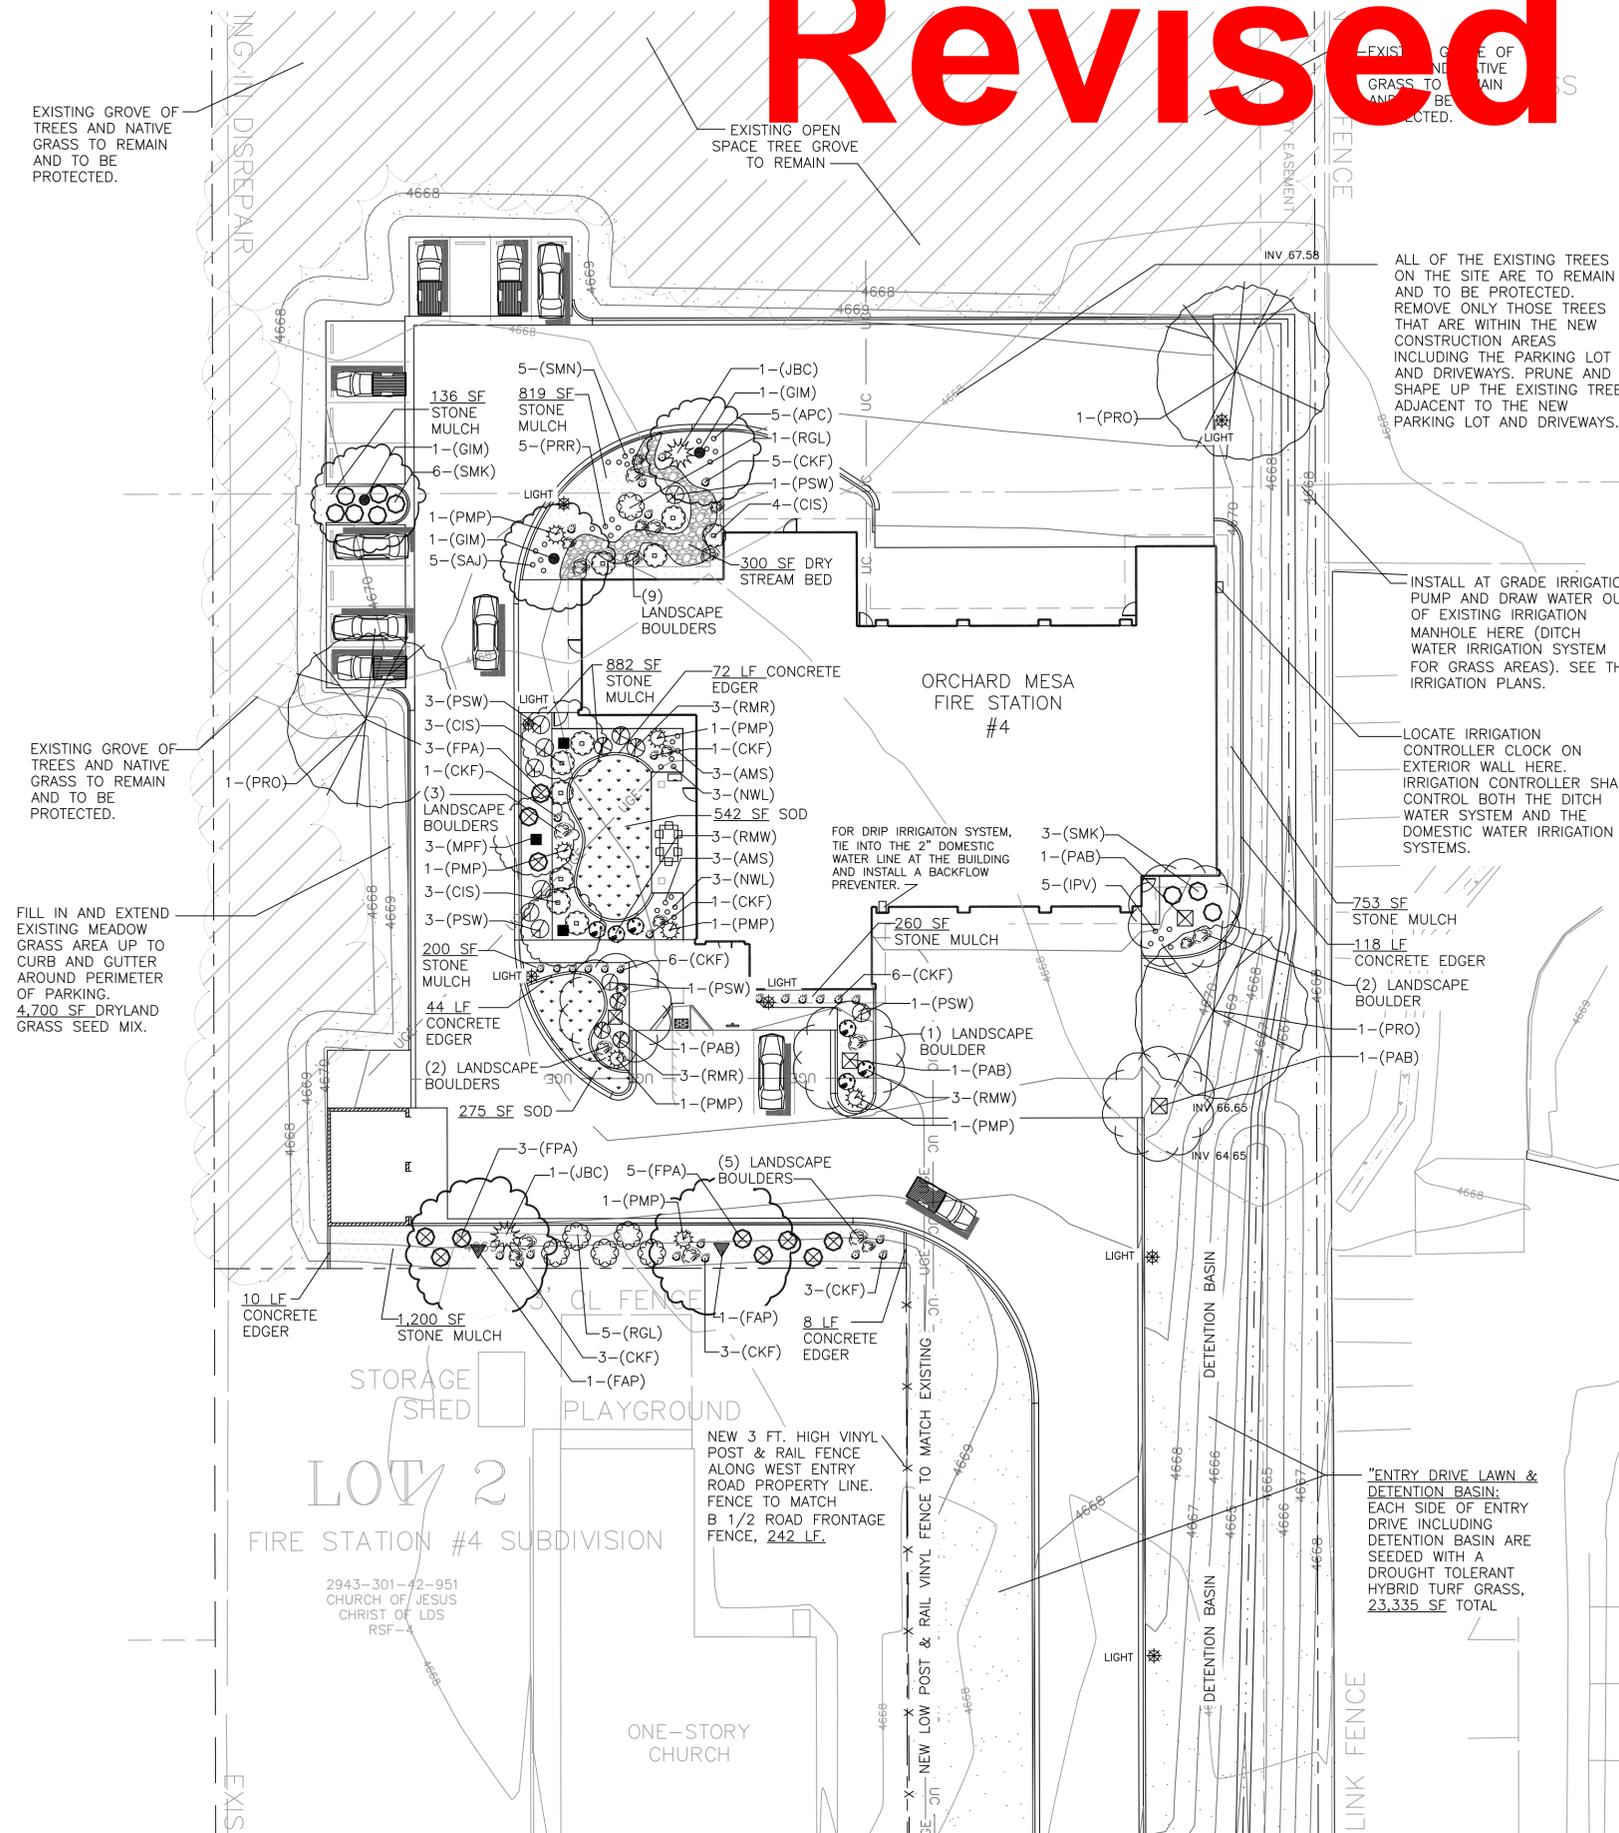EXISTING OPEN SPACE TREE GROVE TO REMAIN

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753 SF STONE MULCH

118 LF CONCRETE EDGER

(2) LANDSCAPE BOULDER

1-(PRO)

1-(PAB)

1-(PMP)

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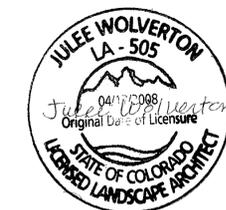
1-(PMP)

1-(PMP)

1-(PMP)

1-(PMP)

1-(PMP)



PLANT LEGEND: TREES

SYM.	SYM.	BOTANICAL NAME:	COMMON NAME:	SIZE:	QUANTITY:	REMARKS:
	(FAP)	FRAXINUS 'AUTUMN PURPLE'	AUTUMN PURPLE ASH	2" CALIPER	4 TOTAL	45' TALL, 30' SPREAD, PURPLE FALL COLOR
	(GIM)	GLEDITSIA TRICANTHOS 'IMPCOLE'	IMPERIAL HONEYLOCUST	2" CALIPER	3 TOTAL	30' TALL, 25' SPREAD, YELLOW FALL COLOR
	(MPF)	MALUS 'PRAIRIE FIRE'	PRAIRIE FIRE CRABAPPLE	2" CALIPER	4 TOTAL	20' TALL, 18' SPREAD, RED PINK SPRING FLOWRS
	(PRO)	POPULUS X ROBUSTA	ROBUSTA COTTONLESS COTTONWOOD	2" CALIPER	3 TOTAL	50' TALL, 30' SPREAD, YELLOW FALL COLOR
	(PAB)	PYRUS 'AUTUMN BLAZE'	AUTUMN BLAZE PEAR (NON-FRUITING VARIETY)	2" CALIPER	4 TOTAL	40' TALL, 25' SPREAD, WHITE FLOWERS, RED FALL

PLANT LEGEND: PERENNIALS

SYM.	SYM.	BOTANICAL NAME:	COMMON NAME:	SIZE:	QUANTITY:	REMARKS:
	(AMS)	ACHILLEA 'MOONSHINE'	MOONSHINE YARROW	1 GALLON	6 TOTAL	2' TALL, 2' SPREAD, YELLOW SUMMER FLOWERS
	(APC)	ARTEMESIA 'POWIS CASTLE'	POWIS CASTLE SAGE	1 GALLON	5 TOTAL	18" TALL, 18" SPREAD, SILVER FOLIAGE
	(IPV)	IRIS PALLIDA 'VARIEGATED'	VARIEGATED IRIS	1 GALLON	5 TOTAL	12" TALL, 12" SPREAD, VARIEGATED FOLIAGE (PURPLE FLOWER SPIKES TO 2 FT)
	(NWL)	NEPETA 'WALKER'S LOW'	WALKER'S LOW CATMINT	1 GALLON	6 TOTAL	12" TALL, 18" SPREAD, PURPLE SUMMER
	(PRR)	PENSTEMON 'RED ROCKS'	RED ROCKS PENSTEMON	1 GALLON	5 TOTAL	12" TALL, 12" SPREAD, PINK SUMMER
	(SMN)	SALVIA 'MAY NIGHT'	MAY NIGHT SALVIA	1 GALLON	5 TOTAL	12" TALL, 12" SPREAD, BLUE SPRING
	(SAJ)	SEDUM 'AUTUMN JOY'	AUTUMN JOY STONECROP	1 GALLON	5 TOTAL	18" TALL, 12" SPREAD, RED FALL FLOWERS

PLANT LEGEND: SHRUBS

SYM.	SYM.	BOTANICAL NAME:	COMMON NAME:	SIZE:	QUANTITY:	REMARKS:
	(BTN)	BERBERIS THUNBERGII AUTROPURPUREA 'NANA'	CRIMSON PIGMY BARBERRY	5 GALLON	6 TOTAL	2' TALL, 2' SPREAD, RED FOLIAGE
	(CIS)	CORNUS ISANTI	ISANTI DOGWOOD	5 GALLON	10 TOTAL	4' TALL, 4' SPREAD, RED STEMS
	(FPA)	FALLUGIA PARADOXA	APACHE PLUME	5 GALLON	11 TOTAL	4' TALL, 4' SPREAD, WHITE SUMMER FLOWERS
	(JBC)	JUNIPERUS HORIZONTALIS 'BLUE CHIP'	BLUE CHIP JUNIPER	5 GALLON	2 TOTAL	2' TALL, 6' SPREAD, BLUE EVERGREEN
	(PSW)	PHYSOCARPUS 'SUMMERWINE'	SUMMERWINE NINEBARK	5 GALLON	9 TOTAL	4' TALL, 4' SPREAD, PURPLE FOLIAGE
	(PMP)	PINUS MUGO PUMILIO	DWARF MUGO PINE	5 GALLON	7 TOTAL	3' TALL, 4' SPREAD, EVERGREEN SHRUB
	(RGL)	RHUS AROMATICA 'GRO-LOW'	GRO-LOW SUMAC	5 GALLON	6 TOTAL	3' TALL, 6' SPREAD, GLOSSY FOLIAGE
	(RMR)	ROSA 'MEIDLAND RED'	RED GROUNDCOVER ROSE	5 GALLON	6 TOTAL	2' TALL, 4' SPREAD, RED FLOWERS
	(RMW)	ROSA 'MEIDLAND WHITE'	WHITE GROUNDCOVER ROSE	5 GALLON	6 TOTAL	2' TALL, 4' SPREAD, WHITE FLOWERS
	(SMK)	SYRINGA 'MISS KIM'	MISS KIM LILAC	5 GALLON	9 TOTAL	4' TALL, 4' SPREAD, PURPLE SPRING FLOWERS

SITE LEGEND: STONE MULCH, EDGER, GRASS, LANDSCAPE BOULDER

SYM.	DESCRIPTION:	QUANTITY:	REMARKS:
	SHREDDED CEDAR BARK MULCH	300 SF	PLACE 3" DEPTH UNDER DRIPLINE OF EACH PLANT. 2 FT DIAMETER AROUND BASE OF TREES, 1 FT. DIAMETER AROUND BASE OF SHRUBS, PERENNIALS, AND ORNAMENTAL GRASSES. BARK MULCH SHALL BE OFFSET FROM PLANT TRUNK A MINIMUM OF 2" NO TOUCH.
	TURF GRASS SOD	817 SF	LOCALLY AVAILABLE TURF GRASS SOD. INSTALL PER THE SUPPLIER RECOMMENDATIONS. PREPARE SOIL WITH 5 CY SOIL CONDITIONER/1,000 SF. ROTOTILL AND FINE GRADE. INSTALL SOD JOINTS TIGHT, ROLL SOD TO ASSURE CONTACT WITH SOIL.
	TURF GRASS SEED (DROUGHT TOLERANT TURF)	28,035 SF	"HERCULES TURF BLEND" TURF GRASS MIXTURE AS AVAILABLE THRU SPENCERSGARDENS.COM. SEED AT THE RATE RECOMMENDED BY THE SUPPLIER FOR 100% COVERAGE. (DENSE, SHORT, DROUGHT TOLERANT, LOW MAINTENANCE, & LOOKS LIKE TURF)
	3/4" SCREENED TAN GRANITE (DESERT SWIRL)	4,316 SF + 468 SF	PLACE 3" DEEP (NO LANDSCAPE FABRIC)
	4"-10" COBBLE DRY STREAM BED	300 SF + 100 SF	MEANDER IN WIDTH AND DIRECTION. INSTALL PER THE DETAIL SHOWN ON SHEET L401.
	4"x6" EXTRUDED CONCRETE LANDSCAPE EDGER	286 LF	EXTRUDED 4"x6" CONCRETE LANDSCAPE EDGER. SEE THE DETAIL ON SHEET L401.
	LANDSCAPE BOULDER	11 MEDIUM 11 LARGE	BURY 2" DEPTH, SEE THE DETAIL ON SHEET L401 FOR TYPE, SIZES, AND INSTALLATION.
	3 FT. HIGH POST AND RAIL WHITE VINYL FENCE TO MATCH EXISTING	242 LF	INSTALL BY FENCE CONTRACTOR PER INDUSTRY STANDARDS.
	7 FT. HIGH COMMERCIAL GRADE DECORATIVE FENCE AND 4 FT. WIDE PEDESTRIAN GATE., BLACK COLOR	98 LF	AMERISTAR MFG. 7 FT. MONTAGE COMMERCIAL CLASSIC 3/4 RAIL, BLACK COLOR. INSTALL BY FENCE CONTRACTOR PER THE MFG. SPECS AND THE DETAIL ON SHEET L401.

PLANT LEGEND: ORNAMENTAL GRASS

SYM.	SYM.	BOTANICAL NAME:	COMMON NAME:	SIZE:	QUANTITY:	REMARKS:
	(CKF)	CALAMAGROSTIS 'KARL FOERSTER'	KARL FOERSTER FEATHER REED GRASS	1 GALLON	35 TOTAL	4' TALL, 2' SPREAD, ORNAMENTAL GRASS

ORCHARD MESA FIRE STATION #4

GRAND JUNCTION, COLORADO

LANDSCAPE LEGENDS

NO: ISSUED FOR: DATE:
 ADDENDUM #1 4/28/2015
 ADDENDUM #3 6/02/2015
 PROPOSAL #3 6/16/2015

PROJECT STATUS:
100% CD's

DRAWN BY: JW CHECKED BY: JW

DATE:
04-10-15 SHEET NO:

PROJECT NO:
1443 **L301**

Julie Wolverton,
Landscape Architect



61945 Nighthawk Road
Montrose, CO 81403
p: 970.249.9392
c: 970.417.1779
wolverton@montrose.net

CITY OF GRAND JUNCTION COMMUNITY DEVELOPMENT

BY: _____ DATE: _____

CITY OF GRAND JUNCTION ENGINEERING

APPROVED FOR CONSTRUCTION FOR ONE YEAR FROM THIS DATE.

BY: _____ DATE: _____

ACCEPTED AS CONSTRUCTED

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PLANT LEGEND: TREES

SYM.	SYM.	BOTANICAL NAME:	COMMON NAME:	SIZE:	QUANTITY:	REMARKS:
	(FAP)	FRAXINUS 'AUTUMN PURPLE'	AUTUMN PURPLE ASH	2" CALIPER	4 TOTAL	45' TALL, 30' SPREAD, PURPLE FALL COLOR
	(GIM)	GLEDITSIA TRICANTHOS 'IMPCOLE'	IMPERIAL HONEYLOCUST	2" CALIPER	3 TOTAL	30' TALL, 25' SPREAD, YELLOW FALL COLOR
	(MPF)	MALUS 'PRAIRIE FIRE'	PRAIRIE FIRE CRABAPPLE	2" CALIPER	4 TOTAL	20' TALL, 18' SPREAD, RED PINK SPRING FLOWERS
	(PRO)	POPULUS X ROBUSTA	ROBUSTA COTTONLESS COTTONWOOD	2" CALIPER	3 TOTAL	50' TALL, 30' SPREAD, YELLOW FALL COLOR
	(PAB)	PYRUS 'AUTUMN BLAZE'	AUTUMN BLAZE PEAR (NON-FRUITING VARIETY)	2" CALIPER	4 TOTAL	40' TALL, 25' SPREAD, WHITE FLOWERS, RED FALL

PLANT LEGEND: PERENNIALS

SYM.	SYM.	BOTANICAL NAME:	COMMON NAME:	SIZE:	QUANTITY:	REMARKS:
	(IS)	HELIOPSIS 'MOONSHINE'	MOONSHINE YARROW	1 GALLON	6 TOTAL	2' TALL, 2' SPREAD, YELLOW SUMMER FLOWERS
	(C)	LEUCANESA 'POWIS CASTLE'	POWIS CASTLE SAGE	1 GALLON	5 TOTAL	18" TALL, 18" SPREAD, SILVER FOLIAGE
	(IPV)	IRIS PALLIDA 'VARIEGATED'	VARIEGATED IRIS	1 GALLON	5 TOTAL	12" TALL, 12" SPREAD, VARIEGATED FOLIAGE (PURPLE FLOWER SPIKES TO 2 FT)
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Revised

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	(RGL)	RHUS AROMATICA 'GRO-LOW'	GRO-LOW SUMAC	5 GALLON	6 TOTAL	3' TALL, 6' SPREAD, GLOSSY FOLIAGE
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ORCHARD MESA FIRE STATION #4

GRAND JUNCTION, COLORADO

LANDSCAPE LEGENDS

NO: ISSUED FOR: DATE:
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Julie Wolverson,
Landscape Architect

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	(MPF)	MALUS 'PRAIRIE FIRE'	PRAIRIE FIRE CRABAPPLE	2" CALIPER	4 TOTAL	20' TALL, 18' SPREAD, RED PINK SPRING FLOWERS
	(PRO)	POPULUS X ROBUSTA	ROBUSTA COTTONLESS COTTONWOOD	2" CALIPER	3 TOTAL	50' TALL, 30' SPREAD, YELLOW FALL COLOR
	(PAB)	PYRUS 'AUTUMN BLAZE'	AUTUMN BLAZE PEAR (NON-FRUITING VARIETY)	2" CALIPER	4 TOTAL	40' TALL, 25' SPREAD, WHITE FLOWERS, RED FALL

PLANT LEGEND: PERENNIALS

SYM.	SYM.	BOTANICAL NAME:	COMMON NAME:	SIZE:	QUANTITY:	REMARKS:
	(AMS)	ACHILLEA 'MOONSHINE'	MOONSHINE YARROW	1 GALLON	6 TOTAL	2' TALL, 2' SPREAD, YELLOW SUMMER FLOWERS
	(APC)	ARTEMESIA 'POWIS CASTLE'	POWIS CASTLE SAGE	1 GALLON	5 TOTAL	18" TALL, 18" SPREAD, SILVER FOLIAGE
	(IPV)	IRIS PALLIDA 'VARIEGATED'	VARIEGATED IRIS	1 GALLON	5 TOTAL	12" TALL, 12" SPREAD, VARIEGATED FOLIAGE (PURPLE FLOWER SPIKES TO 2 FT)
	(NWL)	NEPETA 'WALKER'S LOW'	WALKER'S LOW CATMINT	1 GALLON	6 TOTAL	12" TALL, 18" SPREAD, PURPLE SUMMER
	(PRR)	PENSTEMON 'RED ROCKS'	RED ROCKS PENSTEMON	1 GALLON	5 TOTAL	12" TALL, 12" SPREAD, PINK SUMMER
	(SMN)	SALVIA 'MAY NIGHT'	MAY NIGHT SALVIA	1 GALLON	5 TOTAL	12" TALL, 12" SPREAD, BLUE SPRING
	(SAJ)	SEDUM 'AUTUMN JOY'	AUTUMN JOY STONECROP	1 GALLON	5 TOTAL	18" TALL, 12" SPREAD, RED FALL FLOWERS

PLANT LEGEND: SHRUBS

SYM.	SYM.	BOTANICAL NAME:	COMMON NAME:	SIZE:	QUANTITY:	REMARKS:
	(BTN)	BERBERIS THUNBERGII AUTROPURPUREA 'NANA'	CRIMSON PIGMY BARBERRY	5 GALLON	6 TOTAL	2' TALL, 2' SPREAD, RED FOLIAGE
	(CIS)	CORNUS ISANTI	ISANTI DOGWOOD	5 GALLON	10 TOTAL	4' TALL, 4' SPREAD, RED STEMS
	(FPA)	FALLUGIA PARADOXA	APACHE PLUME	5 GALLON	11 TOTAL	4' TALL, 4' SPREAD, WHITE SUMMER FLOWERS
	(JBC)	JUNIPERUS HORIZONTALIS 'BLUE CHIP'	BLUE CHIP JUNIPER	5 GALLON	2 TOTAL	2' TALL, 6' SPREAD, BLUE EVERGREEN
	(PSW)	PHYSCARPUS 'SUMMERWINE'	SUMMERWINE NINEBARK	5 GALLON	9 TOTAL	4' TALL, 4' SPREAD, PURPLE FOLIAGE
	(PMP)	PINUS MUGO PUMILIO	DWARF MUGO PINE	5 GALLON	7 TOTAL	3' TALL, 4' SPREAD, EVERGREEN SHRUB
	(RGL)	RHUS AROMATICA 'GRO-LOW'	GRO-LOW SUMAC	5 GALLON	6 TOTAL	3' TALL, 6' SPREAD, GLOSSY FOLIAGE
	(RMR)	ROSA 'MEIDILAND RED'	RED GROUNDCOVER ROSE	5 GALLON	6 TOTAL	2' TALL, 4' SPREAD, RED FLOWERS
	(RMW)	ROSA 'MEIDILAND WHITE'	WHITE GROUNDCOVER ROSE	5 GALLON	6 TOTAL	2' TALL, 4' SPREAD, WHITE FLOWERS
	(SMK)	SYRINGA 'MISS KIM'	MISS KIM LILAC	5 GALLON	9 TOTAL	4' TALL, 4' SPREAD, PURPLE SPRING FLOWERS

PLANT LEGEND: ORNAMENTAL GRASS

SYM.	SYM.	BOTANICAL NAME:	COMMON NAME:	SIZE:	QUANTITY:	REMARKS:
	(CKF)	CALAMAGROSTIS 'KARL FOERSTER'	KARL FOERSTER FEATHER REED GRASS	1 GALLON	35 TOTAL	4' TALL, 2' SPREAD, ORNAMENTAL GRASS

SITE LEGEND: STONE MULCH, EDGER, GRASS, LANDSCAPE BOULDER

SYM.	DESCRIPTION:	QUANTITY:	REMARKS:
	SHREDDED CEDAR BARK MULCH	300 SF	PLACE 3" DEPTH UNDER DRIPLINE OF EACH PLANT. 2 FT DIAMETER AROUND BASE OF TREES, 1 FT. DIAMETER AROUND BASE OF SHRUBS, PERENNIALS, AND ORNAMENTAL GRASSES. BARK MULCH SHALL BE OFFSET FROM PLANT TRUNK A MINIMUM OF 2" NO TOUCH.
	TURF GRASS SOD	817 SF	LOCALLY AVAILABLE TURF GRASS SOD. INSTALL PER THE SUPPLIER RECOMMENDATIONS. PREPARE SOIL WITH 5 CY SOIL CONDITIONER/1,000 SF. ROTOTILL AND FINE GRADE. INSTALL SOD JOINTS TIGHT, ROLL SOD TO ASSURE CONTACT WITH SOIL.
	TURF GRASS SEED (DROUGHT TOLERANT TURF)	28,035 SF	"HERCULES TURF BLEND" TURF GRASS MIXTURE AS AVAILABLE THRU SPENCERSGARDENS.COM. SEED AT THE RATE RECOMMENDED BY THE SUPPLIER FOR 100% COVERAGE. (DENSE, SHORT, DROUGHT TOLERANT, LOW MAINTENANCE, & LOOKS LIKE TURF)
	3/4" SCREENED TAN GRANITE (DESERT SWIRL)	4,316 SF	PLACE 3" DEEP (NO LANDSCAPE FABRIC)
	4"-10" COBBLE DRY STREAM BED	300 SF	MEANDER IN WIDTH AND DIRECTION. INSTALL PER THE DETAIL SHOWN ON SHEET L401.
	4"X6" EXTRUDED CONCRETE LANDSCAPE EDGER	286 LF	EXTRUDED 4"X6" CONCRETE LANDSCAPE EDGER. SEE THE DETAIL ON SHEET L401.
	LANDSCAPE BOULDER	11 MEDIUM 11 LARGE	BURY 2" DEPTH, SEE THE DETAIL ON SHEET L401 FOR TYPE, SIZES, AND INSTALLATION.
	3 FT. HIGH POST AND RAIL WHITE VINYL FENCE TO MATCH EXISTING	242 LF	INSTALL BY FENCE CONTRACTOR PER INDUSTRY STANDARDS.

**ORCHARD MESA
FIRE STATION #4**

GRAND JUNCTION, COLORADO

**LANDSCAPE
LEGENDS**

NO: ISSUED FOR: DATE:



PROJECT STATUS:
100% CD's

DRAWN BY: JW CHECKED BY: JW

DATE:
04-10-15 SHEET NO:

PROJECT NO:
1443 **L301**

Julie Wolverton,
Landscape Architect










61945 Nighthawk Road
Montrose, CO 81403
p: 970.249.9392
c: 970.417.1779
wolverton@montrose.net

CITY OF GRAND JUNCTION COMMUNITY DEVELOPMENT	
BY: _____	DATE: _____
CITY OF GRAND JUNCTION ENGINEERING	
APPROVED FOR CONSTRUCTION FOR ONE YEAR FROM THIS DATE.	
BY: _____	DATE: _____
ACCEPTED AS CONSTRUCTED	
BY: _____	DATE: _____

"All details, construction, inspections, and testing shall conform to the City of Grand Junction Standard Contract Documents for Capital Improvements Construction. Contractor shall have a copy of the accepted plans and current City of Grand Junction Standard Documents for Capital Improvements Construction on site and available at all times."

Revised

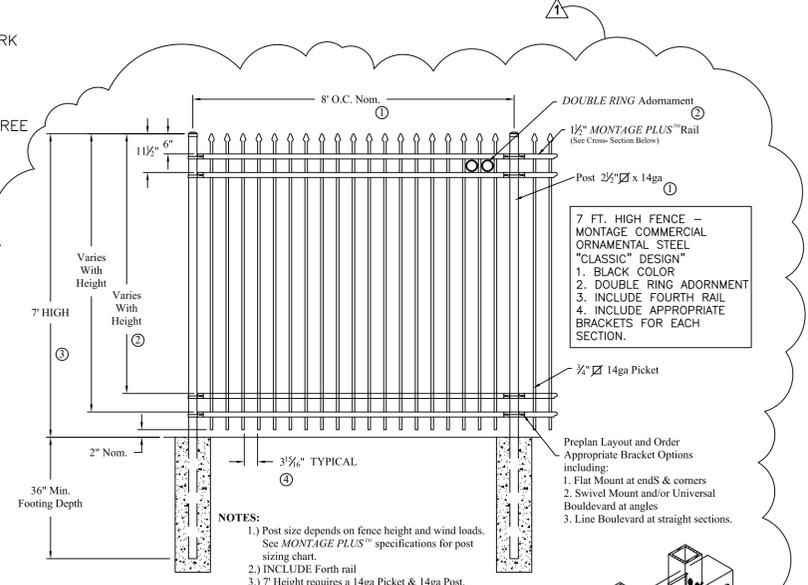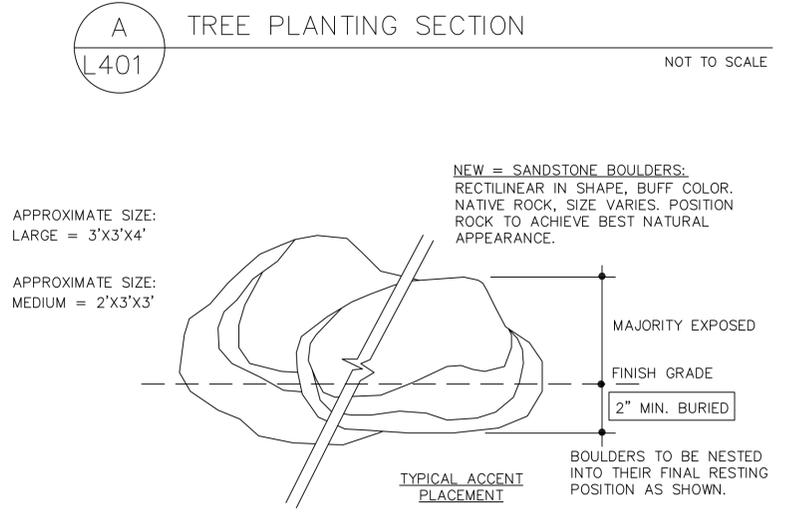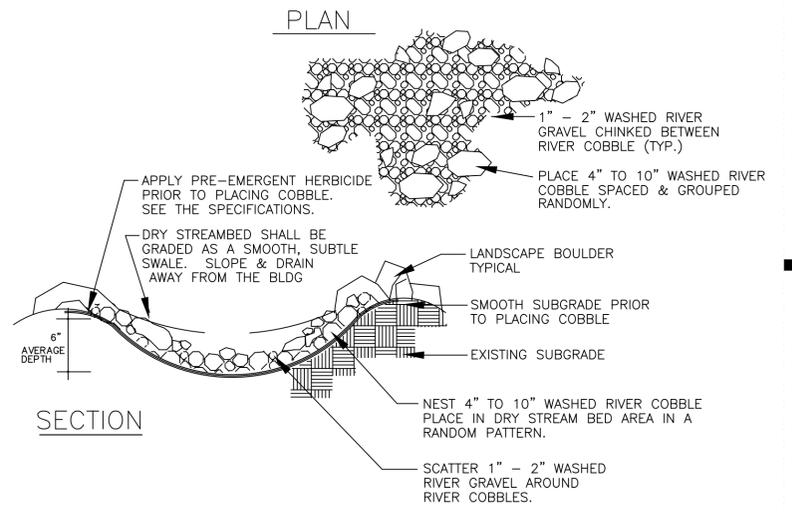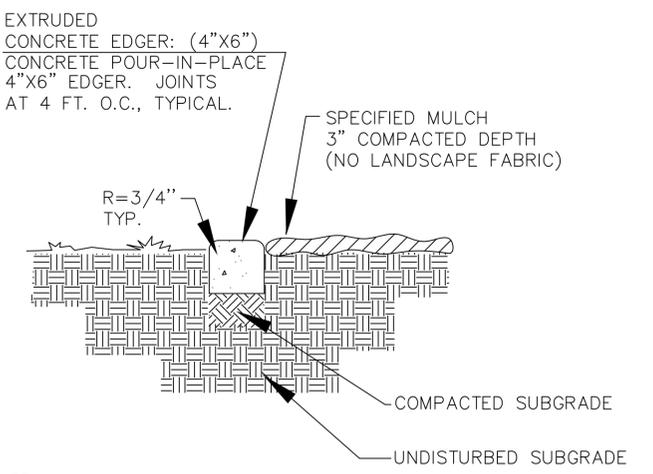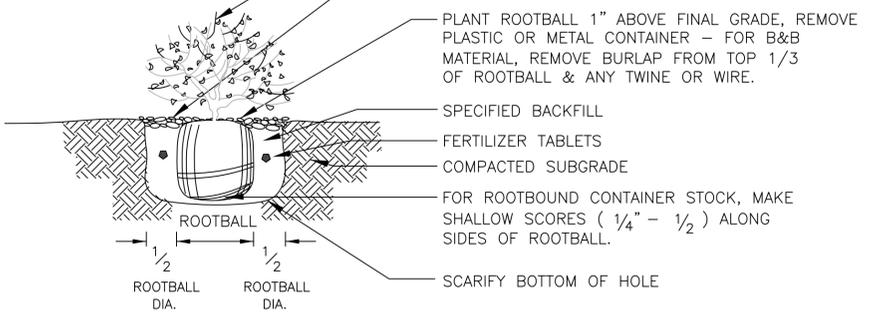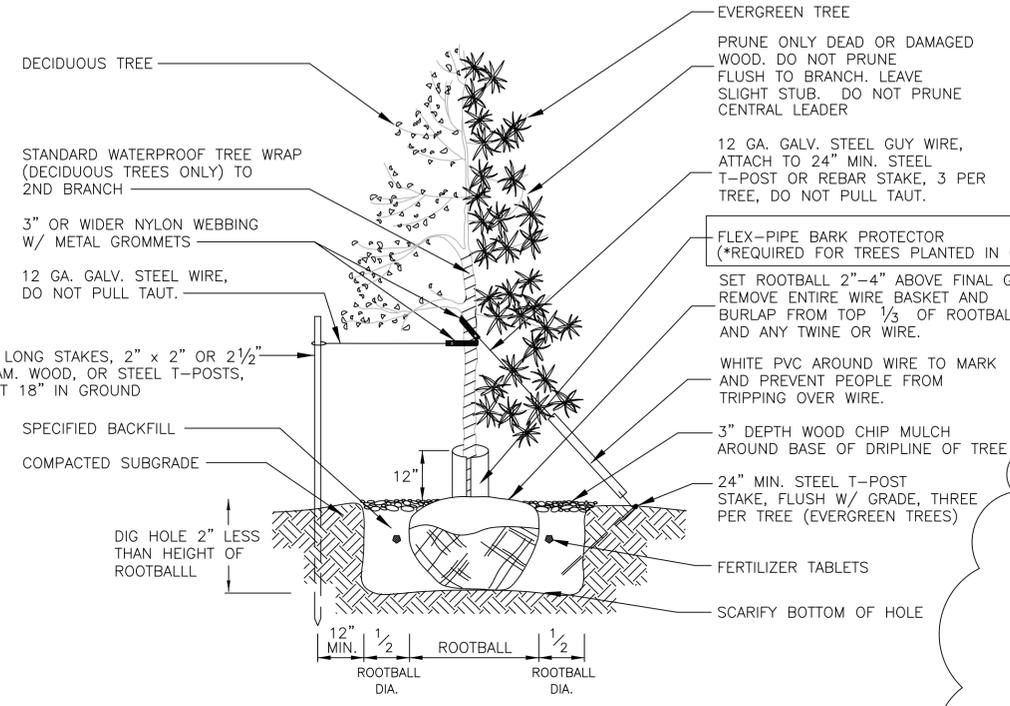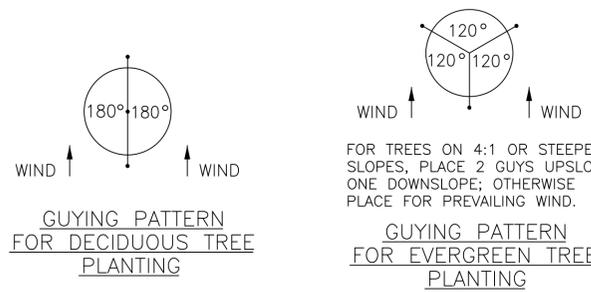

NOTE:

1. WIDTH OF DRY STREAM BED SHALL VARY IN WIDTH FROM APPROX. 3 FT. WIDE MIN. TO 6 FT. WIDE MAX.

2. LANDSCAPE BOULDERS SHALL BE NESTED IN GROUPS IN A RANDOM FASHION ALONG THE EDGES AND THROUGHOUT THE DRY STREAM BED AS SHOWN ON THE DWGS.

3. APPLY A PRE-EMERGENT HERBICIDE THROUGHOUT STREAM BED AREA BEFORE PLACEMENT OF COBBLE (TYP.)

4. INSTALL DRY STREAM BED TO LOOK AS NATURAL AS POSSIBLE WITH VARYING ROCK SIZES, GROUPINGS OF BOULDERS, AND VARYING WIDTH. LANDSCAPE ARCHITECT MUST APPROVE LAYOUT.

COMMERCIAL STRENGTH WELDED STEEL PANEL PRE-ASSEMBLED

MONTAGE COMMERCIAL CLASSIC 3/4-RAIL

DR: NJB SH: 1of1 SCALE: DO NOT SCALE

CK: BS Date: 09/21/11 REV: d

1555 N. Mingo Tulsa, OK 74116 1-888-333-3422 www.ameristarfence.com

AMERISTAR

Julee Wolverton, Landscape Architect

61945 Nighthawk Road Montrose, CO 81403 p: 970.249.9392 c: 970.417.1779 wolvertont@montrose.net

CITY OF GRAND JUNCTION COMMUNITY DEVELOPMENT

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CHAMBERLIN ARCHITECTS

CHAMBERLIN ARCHITECTS

437 Main St. Grand Junction, Colorado 81501 T 970.242.6804

725 Saint Joseph St., Suite B1 Rapid City, South Dakota 57701 T 605.355.6804

www.chamberlinarchitects.com



ORCHARD MESA FIRE STATION #4

GRAND JUNCTION, COLORADO

LANDSCAPE DETAILS

ISSUED FOR: _____ DATE: _____

ADDENDUM #1 4/28/2015

PROJECT STATUS: 100% CD's


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DATE: 04-10-15 SHEET NO: _____


PROJECT NO: 1443 **L401**

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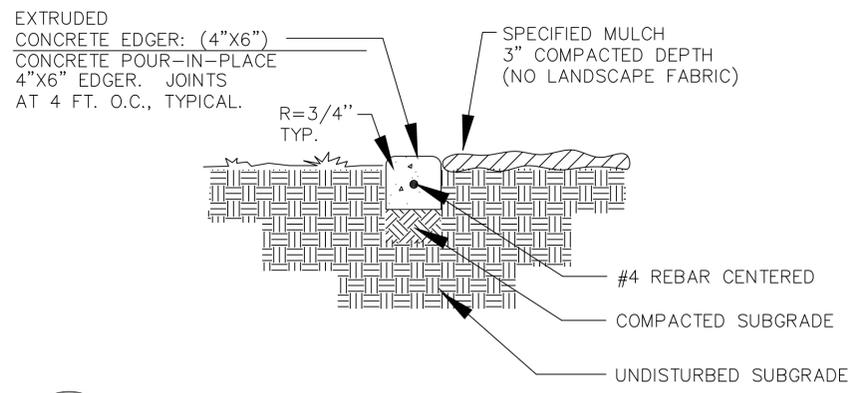
Revised




ALL TREES REQUIRE (3) BUBBLERS PER TREE

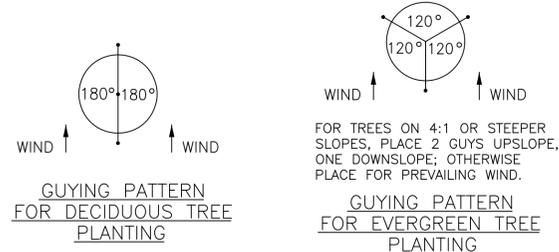

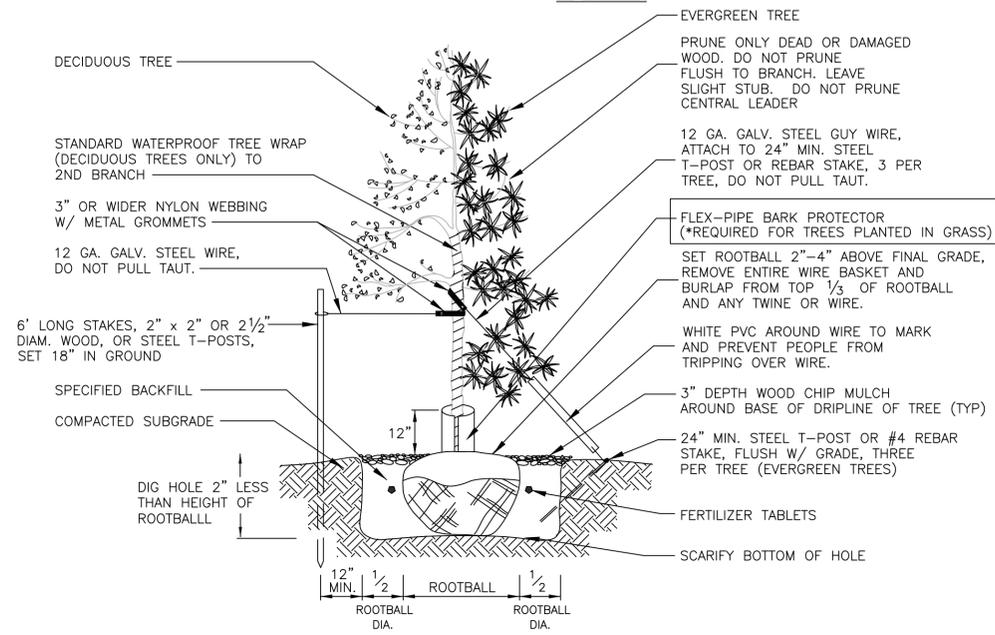
A TREE PLANTING SECTION
L401 NOT TO SCALE




C CONCRETE EDGER / STONE MULCH
L401 NOT TO SCALE

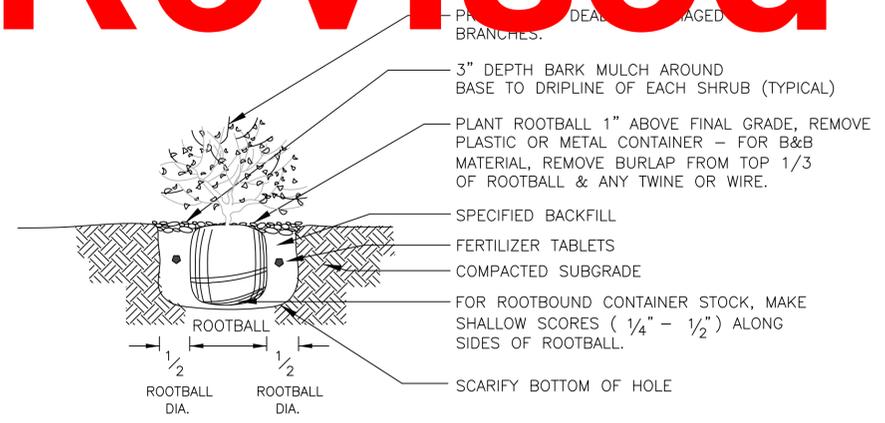



B SHRUB & PERENNIAL PLANTING SECTION
L401 NOT TO SCALE

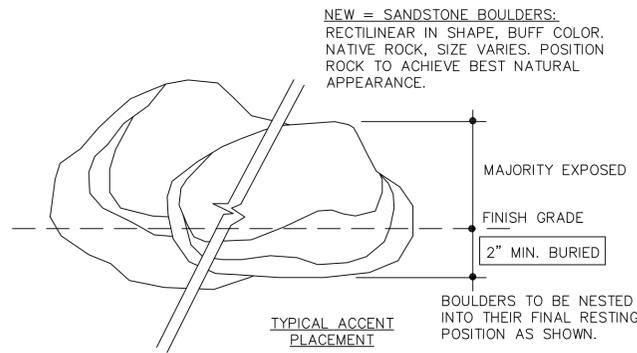

1. PLACEMENT OF LANDSCAPE BOULDERS REFERS TO BOULDERS PLACED IN THE GROUND 2" MIN BURIED BELOW GRADE AND REMAINDER EXPOSED ABOVE FINISH GRADE, TYPICAL.
2. CARE SHALL BE TAKEN DURING PLACEMENT AND HANDLING TO AVOID UNNATURAL SCARRING OF THE EXPOSED SURFACE.

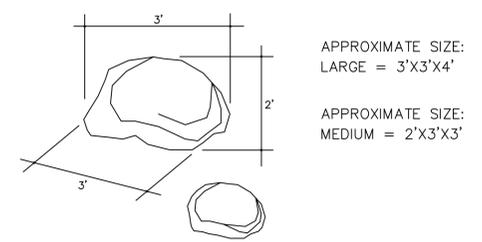

D LANDSCAPE BOULDERS
L401 NOT TO SCALE

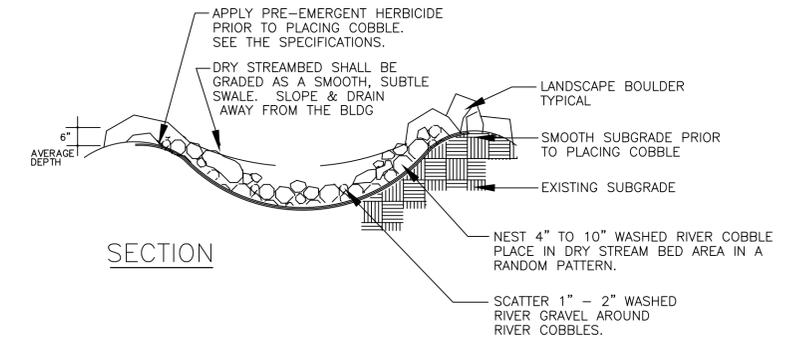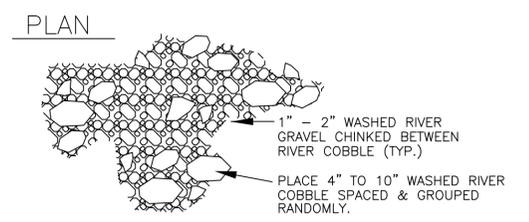

- NOTE:
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E DRY STREAM BED DETAIL
L401 NOT TO SCALE

Julee Wolverton,
Landscape Architect



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CITY OF GRAND JUNCTION COMMUNITY DEVELOPMENT	
By: _____	DATE: _____
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ORCHARD MESA FIRE STATION #4

GRAND JUNCTION, COLORADO

LANDSCAPE DETAILS

ISSUED FOR: _____ DATE: _____



PROJECT STATUS:
100% CD's

DRAWN BY: JW CHECKED BY: JW

DATE:
04-10-15 SHEET NO. _____

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ORCHARD MESA
FIRE STATION #4


GRAND JUNCTION, COLORADO

IRRIGATION
PLAN

NO: ISSUED FOR: DATE:

PROJECT STATUS:
100% CD's
DRAWN BY: B.G.V. CHECKED BY: J.J.S.


DATE:
04-29-2015 SHEET NO:
PROJECT NO:
1443
2015-0002 **IR101**

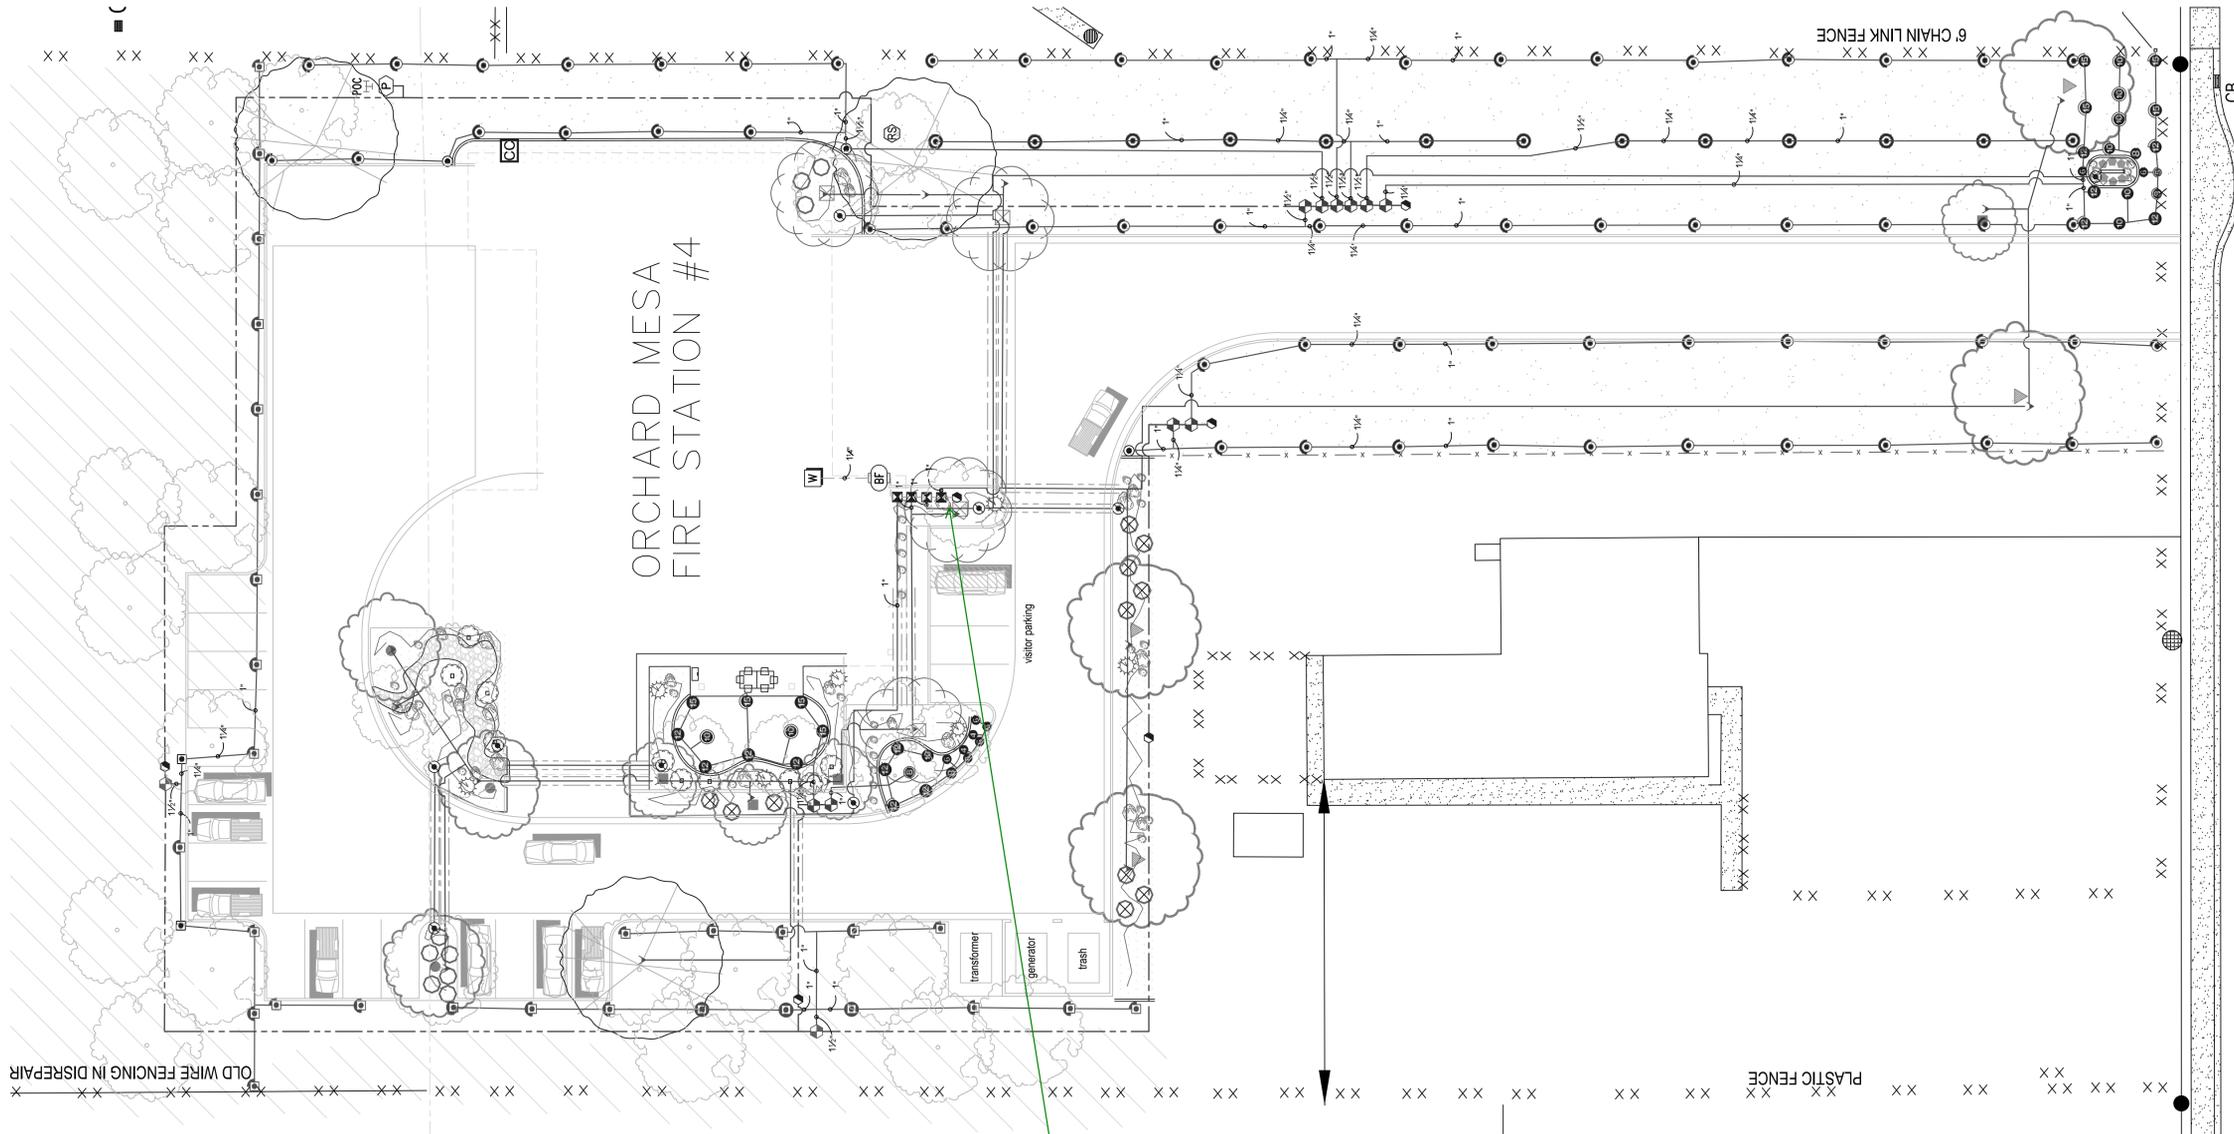

(PAVED 41')


FCI Constructors, Inc.
Request for Information 008R1
Detailed RFIs Grouped by RFI Number

Grand Junction Fire Station #4 2884 B 1/2 Road, Grand Junction, CO 81503	Project # 15-14-008 Tel: 970-258-1214 Fax: 970-434-7583	FCI Constructors, Inc. - GJ
RFI # 008R1	Date Created: 6/29/2015	
Answer Company	Answered By	Author Company
FCI Constructors, Inc. - GJ	FCI Constructors, Inc. - GJ	FCI Constructors, Inc. - GJ
P. O. Box 1787 Grand Junction, CO 81502	Adam Chuter	
Co-Respondent	Author RFI Number	
Subject	Discipline	Category
Location of Irrigation Backflow Preventer	Landscaping	Clarification and Approval
Company Name	Contact Name	Capable
FCI Constructors, Inc. - GJ	Crisp Field	1
FCI Constructors, Inc. - GJ	Stan Kiser	1
City of Grand Junction	Lee Casper	1
Question	Date Required	7/1/2015
RE: IR101_05 Attachment 8 - Revised station to show the proposed installation of the irrigation line with a blow out at the interior of the building. This configuration will need no valve box in the drive outside.		
Suggestion		
Answer	Date Answered	
For documentation only.		

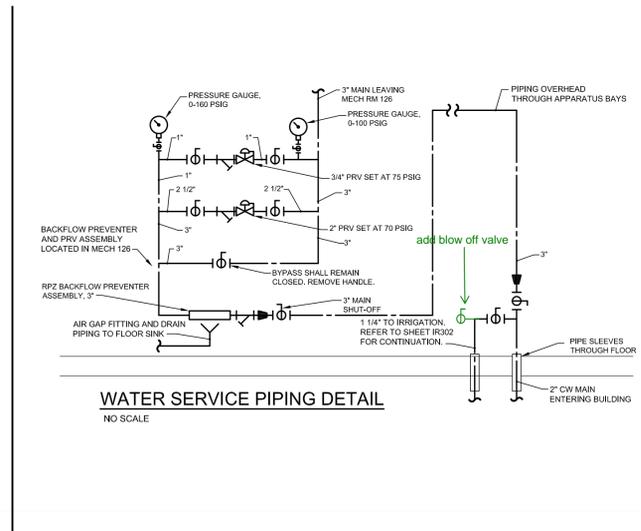

WATER SERVICE PIPING DETAIL
NO SCALE

PSK-1	LOCATION: FOOT
1 W/IN/300V	3/16IN - 03/25/15
REVISION: REVISED WATER SERVICE PIPING DETAIL	
DATE: 6/29/2015	BY: DCR
SCALE: NO SCALE	
PROJECT NO: 1443	
SHEET NO: 1443	
PROJECT NAME: FIRE STATION #4	

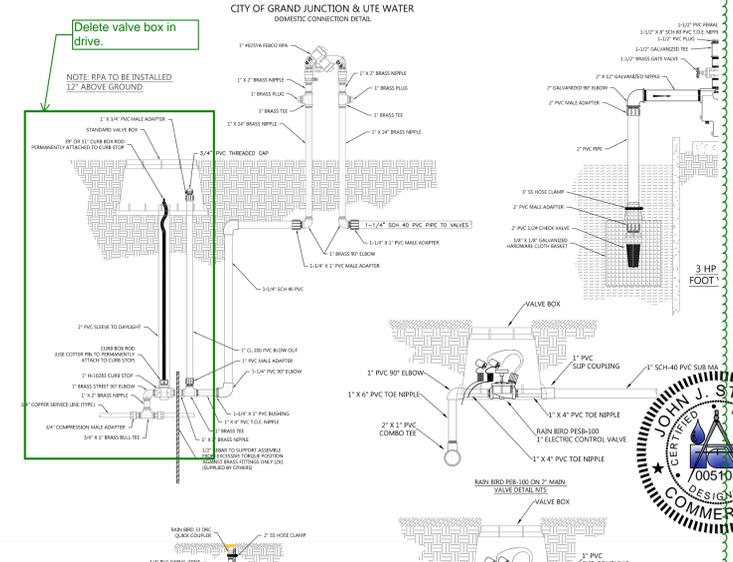

Grand Junction Pipe & Supply
Irrigation Design Department
2868 I-70 Bus. Loop
Grand Jct, CO 81501
(970) 243-4604

Design Date: 04-29-2015
Drawing Number: 2015-0002

Designed By: B.G.V.
Checked By: J.J.S.



IRRIGATION SCHEDULE

SYMBOL	MANUFACTURER/MODEL/DESCRIPTION	QTY	ARC
	Rain Bird 1804-SAM-PRS 5 Series MPR Turf Spray 4.0" Pop-Up Sprinkler with Co-Molded Wiper Seal. 1/2" NPT Female Threaded Inlet. With Seal-A-Matic Check Valve. Pressure Regulating.	1	180
	Rain Bird 1804-SAM-PRS 8 Series MPR Turf Spray 4.0" Pop-Up Sprinkler with Co-Molded Wiper Seal. 1/2" NPT Female Threaded Inlet. With Seal-A-Matic Check Valve. Pressure Regulating.	1	360
	Rain Bird 1804-SAM-PRS 8 Series MPR Turf Spray 4.0" Pop-Up Sprinkler with Co-Molded Wiper Seal. 1/2" NPT Female Threaded Inlet. With Seal-A-Matic Check Valve. Pressure Regulating.	1	180
	Rain Bird 1804-SAM-PRS 10 Series MPR Turf Spray 4.0" Pop-Up Sprinkler with Co-Molded Wiper Seal. 1/2" NPT Female Threaded Inlet. With Seal-A-Matic Check Valve. Pressure Regulating.	4	360
	Rain Bird 1804-SAM-PRS 10 Series MPR Turf Spray 4.0" Pop-Up Sprinkler with Co-Molded Wiper Seal. 1/2" NPT Female Threaded Inlet. With Seal-A-Matic Check Valve. Pressure Regulating.	2	180
	Rain Bird 1804-SAM-PRS 12 Series MPR Turf Spray 4.0" Pop-Up Sprinkler with Co-Molded Wiper Seal. 1/2" NPT Female Threaded Inlet. With Seal-A-Matic Check Valve. Pressure Regulating.	4	90
	Rain Bird 1804-SAM-PRS 15 Series MPR Turf Spray 4.0" Pop-Up Sprinkler with Co-Molded Wiper Seal. 1/2" NPT Female Threaded Inlet. With Seal-A-Matic Check Valve. Pressure Regulating.	3	180
	Rain Bird 1804-SAM-PRS 15 Series MPR Turf Spray 4.0" Pop-Up Sprinkler with Co-Molded Wiper Seal. 1/2" NPT Female Threaded Inlet. With Seal-A-Matic Check Valve. Pressure Regulating.	2	90
	Rain Bird 1804-SAM-PRS VAN Series Turf Spray 4.0" Pop-Up Sprinkler with Co-Molded Wiper Seal. 1/2" NPT Female Threaded Inlet. With Seal-A-Matic Check Valve. Pressure Regulating.	2	Adj
	Rain Bird 1804-SAM-PRS VAN Series Turf Spray 4.0" Pop-Up Sprinkler with Co-Molded Wiper Seal. 1/2" NPT Female Threaded Inlet. With Seal-A-Matic Check Valve. Pressure Regulating.	7	Adj
	Rain Bird 1804-SAM-PRS HE-VAN Series Turf Spray 4.0" Pop-Up Sprinkler with Co-Molded Wiper Seal. 1/2" NPT Female Threaded Inlet. With Seal-A-Matic Check Valve. Pressure Regulating.	2	Adj
	Rain Bird 1804-SAM-PRS HE-VAN Series Turf Spray 4.0" Pop-Up Sprinkler with Co-Molded Wiper Seal. 1/2" NPT Female Threaded Inlet. With Seal-A-Matic Check Valve. Pressure Regulating.	3	Adj
	Rain Bird 1804-SAM-PRS HE-VAN Series Turf Spray 4.0" Pop-Up Sprinkler with Co-Molded Wiper Seal. 1/2" NPT Female Threaded Inlet. With Seal-A-Matic Check Valve. Pressure Regulating.	9	Adj
	Rain Bird 1804-SAM-PRS HE-VAN Series Turf Spray 4.0" Pop-Up Sprinkler with Co-Molded Wiper Seal. 1/2" NPT Female Threaded Inlet. With Seal-A-Matic Check Valve. Pressure Regulating.	3	Adj
	Rain Bird R-VAN-1724 RD-1804-SAM-P45 Turf Rotator, 17'-24' Hand Adjustable Rotary Stream, w/RD-1800 turf spray body, 4.0" Pop-Up. With Seal-A-Matic Check Valve and 45 psi in-stem pressure regulation.	3	CST
	Rain Bird R-1724 RD-1804-SAM-P45 Turf Rotator, 17'-24' Rotary Stream, w/RD-1800 turf spray body on 4.0" pop-up, with check valve and 45 psi in-stem pressure regulator. 1/2" NPT Female Threaded Inlet.	13	360
	Rain Bird R-1724 RD-1804-SAM-P45 Turf Rotator, 17'-24' Rotary Stream, w/RD-1800 turf spray body on 4.0" pop-up, with check valve and 45 psi in-stem pressure regulator. 1/2" NPT Female Threaded Inlet.	58	180
	Rain Bird R-1724 RD-1804-SAM-P45 Turf Rotator, 17'-24' Rotary Stream, w/RD-1800 turf spray body on 4.0" pop-up, with check valve and 45 psi in-stem pressure regulator. 1/2" NPT Female Threaded Inlet.	4	90
	Rain Bird R-VAN-1724 RD-1806-SAM-P45 (2) Turf Rotator, 17'-24' Hand Adjustable Rotary Stream, w/RD-1800 turf spray body, 6.0" Pop-Up. With Seal-A-Matic Check Valve and 45 psi in-stem pressure regulation.	2	CST
	Rain Bird R-1724 RD-1806-SAM-P45 (2) Turf Rotator, 17'-24' Rotary Stream, w/RD-1800 turf spray body on 6.0" pop-up, with check valve and 45 psi in-stem pressure regulator. 1/2" NPT Female Threaded Inlet.	3	360



Rain Bird R-1724 RD-1806-SAM-P45 (2)
Turf Rotator, 17'-24' Rotary Stream, w/RD-1800 turf spray body on 6.0" pop-up, with check valve and 45 psi in-stem pressure regulator. 1/2" NPT Female Threaded Inlet.

18 180




Rain Bird R-1724 RD-1806-SAM-P45 (2)
Turf Rotator, 17'-24' Rotary Stream, w/RD-1800 turf spray body on 6.0" pop-up, with check valve and 45 psi in-stem pressure regulator. 1/2" NPT Female Threaded Inlet.

8 90



Rain Bird 1804-SAM-PRS With Hunter PCN-25 Bubbler Nozzles
4.0" Pop-Up Sprinkler with Co-Molded Wiper Seal. 1/2" NPT Female Threaded Inlet. With Seal-A-Matic Check Valve. Pressure Regulating.

18 360

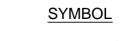

1" PVC Pipe Transition Point above grade
Pipe transition point from PVC lateral to drip tubing with riser to above grade installation.

9



3/4" Drip Tube

678.9 I.F.



Rain Bird X CZ-100-PRB-LC 1"
Medium Plus Flow Drip Control Kit, for Light Commercial Uses. 1" PGA Valve, with 1" Pressure Regulating 40psi Basket Filter. 5gpm to 20gpm.

4



Rain Bird PESB (2) 1"
1", 1-1/2", 2" Plastic Industrial Valves. Low Flow Operating Capability, Globe Configuration. With Scrubber Technology for Reliable Performance in Dirty Water Irrigation Applications.

10



Rain Bird PESB (2) 1-1/2"
1", 1-1/2", 2" Plastic Industrial Valves. Low Flow Operating Capability, Globe Configuration. With Scrubber Technology for Reliable Performance in Dirty Water Irrigation Applications.

2




Rain Bird 33-DLRC 3/4"
3/4" Brass Quick-Coupling Valve, with Corrosion-Resistant Stainless Steel Spring, Locking Thermoplastic Rubber Cover, Double Track Key Lug, and 2-Piece Body.

6



Febco 825YA 1" Reduced Pressure Backflow Preventer

1

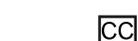


Rain Bird ESP4-SMTE with (2) ESP-SM6 Modules
Outdoor Smart Modular Control System for Residential and Light Commercial Use. Wall Mount, Tipping Bucket Rain Sensor that Measures Rainfall.

1



Rain Bird Rain Sensor With Rainfall and Temperature Data

1

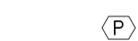

MUNRO LP200B 2-HP Irrigation Pump

1



Irrigation Water Point Of Connection (Existing Irrigation Manhole)

1



2" Domestic Water Supply Line (Tap Location For Domestic System)

1



Irrigation Lateral Line: PVC Class 200 SDR 21 1"
PVC Class 200 irrigation pipe.

2,240 I.F.



Irrigation Lateral Line: PVC Class 200 SDR 21 1 1/4"
PVC Class 200 irrigation pipe.

460 I.F.



Irrigation Lateral Line: PVC Class 200 SDR 21 1 1/2"
PVC Class 200 irrigation pipe.

300 I.F.



Irrigation Lateral Line: PVC Schedule 40
PVC Class 200 irrigation pipe.

1500 I.F.



Irrigation Mainline: PVC Class 200 SDR 21 2"
PVC Class 200 irrigation pipe.

1100 I.F.




Irrigation Mainline: PVC Schedule 40 1 1/4"

100 I.F.



Pipe Sleeve: PVC Schedule 80
4" or 2" Sch-40 Sleeving

440 I.F.

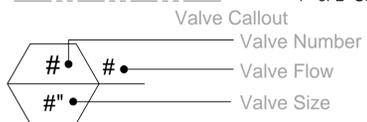


ORCHARD MESA FIRE STATION #4

GRAND JUNCTION, COLORADO

IRRIGATION LEGEND

NO: ISSUED FOR: DATE:

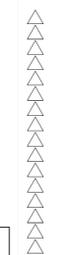

**Grand Junction
Pipe & Supply**
Irrigation Design Department
2868 I-70 Bus. Loop
Grand Jct, CO 81501
(970) 243-4604

Design Date: 04-29-2015	Designed By: B.G.V.
Drawing Number: 2015-0002	Checked By: J.J.S.

PROJECT STATUS:
100% CD's

DRAWN BY: B.G.V. CHECKED BY: J.J.S.

DATE: **04-29-2015** SHEET NO:

PROJECT NO: **IR201**
1443
2015-0002

IRRIGATION SCHEDULE

Revised

SYMBOL	MANUFACTURER/MODEL/DESCRIPTION	QTY	ARC	SYMBOL	MANUFACTURER/MODEL/DESCRIPTION	QTY	ARC
⊕	Rain Bird 1804-SAM-PRS 5 Series MPR Turf Spray 4.0" Pop-Up Sprinkler with Co-Molded Wiper Seal. 1/2" NPT Female Threaded Inlet. With Seal-A-Matic Check Valve. Pressure Regulating.	1	180	⊕	Rain Bird R-1724 RD-1806-SAM-P45 (2) Turf Rotator, 17'-24' Rotary Stream, w/RD-1800 turf spray body on 6.0" pop-up, with check valve and 45 psi in-stem pressure regulator. 1/2" NPT Female Threaded Inlet.	18	180
⊗	Rain Bird 1804-SAM-PRS 8 Series MPR Turf Spray 4.0" Pop-Up Sprinkler with Co-Molded Wiper Seal. 1/2" NPT Female Threaded Inlet. With Seal-A-Matic Check Valve. Pressure Regulating.	1	360	⊗	Rain Bird R-1724 RD-1806-SAM-P45 (2) Turf Rotator, 17'-24' Rotary Stream, w/RD-1800 turf spray body on 6.0" pop-up, with check valve and 45 psi in-stem pressure regulator. 1/2" NPT Female Threaded Inlet.	8	90
⊗	Rain Bird 1804-SAM-PRS 8 Series MPR Turf Spray 4.0" Pop-Up Sprinkler with Co-Molded Wiper Seal. 1/2" NPT Female Threaded Inlet. With Seal-A-Matic Check Valve. Pressure Regulating.	1	180	⊗	Rain Bird 1804-SAM-PRS With Hunter PCN-25 Bubbler Nozzles 4.0" Pop-Up Sprinkler with Co-Molded Wiper Seal. 1/2" NPT Female Threaded Inlet. With Seal-A-Matic Check Valve. Pressure Regulating.	18	360
⊕	Rain Bird 1804-SAM-PRS 10 Series MPR Turf Spray 4.0" Pop-Up Sprinkler with Co-Molded Wiper Seal. 1/2" NPT Female Threaded Inlet. With Seal-A-Matic Check Valve. Pressure Regulating.	4	360	⊕	1" PVC Pipe Transition Point above grade Pipe transition point from PVC lateral to drip tubing with riser to above grade installation.	9	
⊕	Rain Bird 1804-SAM-PRS 10 Series MPR Turf Spray 4.0" Pop-Up Sprinkler with Co-Molded Wiper Seal. 1/2" NPT Female Threaded Inlet. With Seal-A-Matic Check Valve. Pressure Regulating.	2	180	⊕	3/4" Drip Tube	678.9 l.f.	
⊗	Rain Bird 1804-SAM-PRS 12 Series MPR Turf Spray 4.0" Pop-Up Sprinkler with Co-Molded Wiper Seal. 1/2" NPT Female Threaded Inlet. With Seal-A-Matic Check Valve. Pressure Regulating.	4	90	⊗	Rain Bird PGA-PRS-D- Globe 1" 1", 1-1/2", 2" Electric Remote Control Valve, Globe. With Pressure Regulator Module.	4	
⊗	Rain Bird 1804-SAM-PRS 15 Series MPR Turf Spray 4.0" Pop-Up Sprinkler with Co-Molded Wiper Seal. 1/2" NPT Female Threaded Inlet. With Seal-A-Matic Check Valve. Pressure Regulating.	3	180	⊗	Rain Bird PESB (2) 1" 1", 1-1/2", 2" Plastic Industrial Valves. Low Flow Operating Capability, Globe Configuration. With Scrubber Technology for Reliable Performance in Dirty Water Irrigation Applications.	10	
⊗	Rain Bird 1804-SAM-PRS 15 Series MPR Turf Spray 4.0" Pop-Up Sprinkler with Co-Molded Wiper Seal. 1/2" NPT Female Threaded Inlet. With Seal-A-Matic Check Valve. Pressure Regulating.	2	90	⊗	Rain Bird PESB (2) 1-1/2" 1", 1-1/2", 2" Plastic Industrial Valves. Low Flow Operating Capability, Globe Configuration. With Scrubber Technology for Reliable Performance in Dirty Water Irrigation Applications.	2	
④	Rain Bird 1804-SAM-PRS VAN Series Turf Spray 4.0" Pop-Up Sprinkler with Co-Molded Wiper Seal. 1/2" NPT Female Threaded Inlet. With Seal-A-Matic Check Valve. Pressure Regulating.	2	Adj	⊗	Rain Bird 33-DLRC 3/4" 3/4" Brass Quick-Coupling Valve, with Corrosion-Resistant Stainless Steel Spring, Locking Thermoplastic Rubber Cover, Double Track Key Lug, and 2-Piece Body.	6	
⊕	Rain Bird 1804-SAM-PRS VAN Series Turf Spray 4.0" Pop-Up Sprinkler with Co-Molded Wiper Seal. 1/2" NPT Female Threaded Inlet. With Seal-A-Matic Check Valve. Pressure Regulating.	7	Adj	⊗	Febco 825YA 1" Reduced Pressure Backflow Preventer	1	
⊗	Rain Bird 1804-SAM-PRS HE-VAN Series Turf Spray 4.0" Pop-Up Sprinkler with Co-Molded Wiper Seal. 1/2" NPT Female Threaded Inlet. With Seal-A-Matic Check Valve. Pressure Regulating.	2	Adj	⊗	Rain Bird ESP4-SMTE with (2) ESP-SM6 Moudules Outdoor Smart Modular Control System for Residential and Light Commercial Use. Wall Mount, Tipping Bucket Rain Sensor that Measures Rainfall.	1	
⊕	Rain Bird 1804-SAM-PRS HE-VAN Series Turf Spray 4.0" Pop-Up Sprinkler with Co-Molded Wiper Seal. 1/2" NPT Female Threaded Inlet. With Seal-A-Matic Check Valve. Pressure Regulating.	3	Adj	⊗	Rain Bird Rain Sensor With Rainfall and Temperature Data	1	
⊕	Rain Bird 1804-SAM-PRS HE-VAN Series Turf Spray 4.0" Pop-Up Sprinkler with Co-Molded Wiper Seal. 1/2" NPT Female Threaded Inlet. With Seal-A-Matic Check Valve. Pressure Regulating.	9	Adj	⊗	MUNRO LP200B 2-HP Irrigation Pump	1	
⊕	Rain Bird 1804-SAM-PRS HE-VAN Series Turf Spray 4.0" Pop-Up Sprinkler with Co-Molded Wiper Seal. 1/2" NPT Female Threaded Inlet. With Seal-A-Matic Check Valve. Pressure Regulating.	3	Adj	⊗	Irrigation Water Point Of Connection (Existing Irrigation Manhole)	1	
⊕	Rain Bird R-VAN-1724 RD-1804-SAM-P45 Turf Rotator, 17'-24' Hand Adjustable Rotary Stream, w/RD-1800 turf spray body, 4.0" Pop-Up. With Seal-A-Matic Check Valve and 45 psi in-stem pressure regulation.	3	CST	⊗	2" Domestic Water Supply Line (Tap Location For Domestic System)	1	
⊕	Rain Bird R-1724 RD-1804-SAM-P45 Turf Rotator, 17'-24' Rotary Stream, w/RD-1800 turf spray body on 4.0" pop-up, with check valve and 45 psi in-stem pressure regulator. 1/2" NPT Female Threaded Inlet.	13	360	⊗	Irrigation Lateral Line: PVC Class 200 SDR 21 1" PVC Class 200 irrigation pipe.	2,240 l.f.	
⊕	Rain Bird R-1724 RD-1804-SAM-P45 Turf Rotator, 17'-24' Rotary Stream, w/RD-1800 turf spray body on 4.0" pop-up, with check valve and 45 psi in-stem pressure regulator. 1/2" NPT Female Threaded Inlet.	58	180	⊗	Irrigation Lateral Line: PVC Class 200 SDR 21 1 1/4" PVC Class 200 irrigation pipe.	460 l.f.	
⊕	Rain Bird R-1724 RD-1804-SAM-P45 Turf Rotator, 17'-24' Rotary Stream, w/RD-1800 turf spray body on 4.0" pop-up, with check valve and 45 psi in-stem pressure regulator. 1/2" NPT Female Threaded Inlet.	4	90	⊗	Irrigation Lateral Line: PVC Class 200 SDR 21 1 1/2" PVC Class 200 irrigation pipe.	300 l.f.	
⊕	Rain Bird R-1724 RD-1804-SAM-P45 Turf Rotator, 17'-24' Rotary Stream, w/RD-1800 turf spray body on 4.0" pop-up, with check valve and 45 psi in-stem pressure regulator. 1/2" NPT Female Threaded Inlet.	4	90	⊗	Irrigation Lateral Line: PVC Schedule 40 PVC Class 200 irrigation pipe.	1500 l.f.	
⊕	Rain Bird R-VAN-1724 RD-1806-SAM-P45 (2) Turf Rotator, 17'-24' Hand Adjustable Rotary Stream, w/RD-1800 turf spray body, 6.0" Pop-Up. With Seal-A-Matic Check Valve and 45 psi in-stem pressure regulation.	2	CST	⊗	Irrigation Mainline: PVC Class 200 SDR 21 2" PVC Class 200 irrigation pipe.	1100 l.f.	
⊕	Rain Bird R-1724 RD-1806-SAM-P45 (2) Turf Rotator, 17'-24' Rotary Stream, w/RD-1800 turf spray body on 6.0" pop-up, with check valve and 45 psi in-stem pressure regulator. 1/2" NPT Female Threaded Inlet.	3	360	⊗	Irrigation Mainline: PVC Schedule 40 1 1/4" PVC Class 200 irrigation pipe.	100 l.f.	
				⊗	Pipe Sleeve: PVC Schedule 80 4" or 2" Sch-40 Sleevling	440 l.f.	

SYMBOL



SYMBOL



ORCHARD MESA FIRE STATION #4

GRAND JUNCTION, COLORADO

IRRIGATION LEGEND

NO. ISSUED FOR: DATE:



PROJECT STATUS:
100% CD's

DRAWN BY: B.G.V. CHECKED BY: J.J.S.

DATE: 04-10-2015 SHEET NO:

PROJECT NO: 1443 IR201
2015-0002

**Grand Junction
Pipe & Supply**
Irrigation Design Department
2868 I-70 Bus. Loop
Grand Jct, CO 81501
(970) 243-4604

Design Date: 04-10-2015	Designed By: B.G.V.
Drawing Number: 2015-0002	Checked By: J.J.S.

IRRIGATION NOTES:

- All work shall be per existing county or state code and is subject to inspection and approval by appropriate inspectors and/or owner representative. Installer to be responsible for all installation standards, practices and all permit requirements.
- Julee Wolverton Landscapes have provided all base and planting information. Any discrepancies between said information and these irrigation plans shall be their responsibility. The installer will assume all costs and liabilities associated with any and all field changes to the system design.
- The system is designed to operate from the source with a flow of 28-30 gallons per minute (GPM) at 55 pounds per square inch (PSI) at the pump. (Irrigation Water Supply)
- This is designed to operate from a domestic water connection with the source providing a flow of 10-12 gallons per minute (GPM) at 75 pounds per square inch (PSI) with a 1" 825 RPYA Backflow Device. Unless otherwise noted on the plans, source flow and pressure are the responsibility of others.
- All pipe to be sleeved wherever concrete, asphalt, or any hard surfaces are to be overlaid. All sleeves to be 2 times the diameter of the pipe to be sleeved. Main line sleeves to have an additional 4" inch sleeve in parallel for control wires.
- Irrigation plan is a diagrammatic single line drawing. Any components shown on plan outside of landscape are shown for clarity only. Multiple pipes may be installed in the same trench when proper pipe spacing can be maintained.
- Main line to be buried 24" (inch) to top of pipe.
- Control wires to be routed with main line and attached at 24" increments with plastic wire ties or duct tape. Wire should be a looped common and one hot wire to each valve with extra wires in valve box. Wire splices to be located in a 10" (inch) round or larger valve box at least.
- Swing pipe to be used on all sprinkler heads under 6 GPM and swing joints on all heads over 6 GPM. Maximum length of swing pipe to be 5' (foot).
- Isolation valves to be located in 10" (inch) round valve box or larger.
- For obstructions (Electrical Transformers, Trees, Fire Hydrants, etc...), that will interfere with proper coverage of sprinkler heads, will require the addition of properly patterned heads around obstruction as to provide head to head coverage to all irrigated areas.
- Sprinkler heads to be set perpendicular to finished grade and adjusted to prevent over spray onto non irrigated areas.
- Laterals are sized at transitions only, segments that are not noted will be the same size as adjacent segments. Up stream segments will never be smaller than any down stream segments on the same lateral.

VALVE SCHEDULE

NUMBER	MODEL	SIZE	TYPE	PSI	PSI @ POC	GPM	PRECIP
<u>Domestic Water System</u>							
1	Rain Bird X CZ-100-PRB-LC Control Zone Kit	1"	SHRUB AREA FOR DRIP EMITTERS		39.80	6.12	0.30 in/h
2	Rain Bird X CZ-100-PRB-LC Control Zone Kit	1"	TREE ZONE WITH PCN BUBBLERS		45.99	10.0	30.64 in/h
3	Rain Bird X CZ-100-PRB-LC Control Zone Kit	1"	SHRUB AREA FOR DRIP EMITTERS		38.94	10.0	0.30 in/h
4	Rain Bird X CZ-100-PRB-LC Control Zone Kit	1"	TREE ZONE WITH PCN BUBBLERS		44.81	9.00	30.64 in/h
<u>Irrigation Water System</u>							
5	Rain Bird PESB (2)	1-1/2"	Turf Rotary	50.63	51.42	28.49	0.41 in/h
6	Rain Bird PESB (2)	1-1/2"	Turf Rotary	49.28	50.16	28.49	0.51 in/h
7	Rain Bird PESB (2)	1"	Turf Spray	32.59	50.81	12.97	1.85 in/h
8	Rain Bird PESB (2)	1"	Turf Spray	32.28	50.81	10.50	3.22 in/h
9	Rain Bird PESB (2)	1"	Turf Rotary	50.53	50.81	19.94	0.36 in/h
10	Rain Bird PESB (2)	1"	Turf Rotary	50.50	50.77	19.32	0.34 in/h
11	Rain Bird PESB (2)	1"	Turf Rotary	51.64	51.92	25.76	0.36 in/h
12	Rain Bird PESB (2)	1"	Turf Rotary	52.99	53.29	26.67	0.56 in/h
13	Rain Bird PESB (2)	1"	Turf Rotary	51.67	51.94	24.84	0.35 in/h
14	Rain Bird PESB (2)	1"	Turf Rotary	50.57	50.86	25.69	0.32 in/h
15	Rain Bird PESB (2)	1"	Turf Rotary	51.28	51.54	23.86	0.35 in/h
16	Rain Bird PESB (2)	1"	Turf Spray	35.95	51.54	19.77	2.29 in/h

WATERING SCHEDULE

NUMBER	MODEL	TYPE	PRECIP	IN./WEEK	MIN./WEEK	GAL./WEEK	GAL./DAY
<u>Domestic Water System</u>							
1	Rain Bird X CZ-100-PRB-LC Control Zone Kit	SHRUB AREA FOR DRIP EMITTERS	0.30 in/h	1.40	280		
2	Rain Bird X CZ-100-PRB-LC Control Zone Kit	TREE ZONE WITH PCN BUBBLERS	30.64 in/h	1.40	3		
3	Rain Bird X CZ-100-PRB-LC Control Zone Kit	SHRUB AREA FOR DRIP EMITTERS	0.30 in/h	1.40	280		
4	Rain Bird X CZ-100-PRB-LC Control Zone Kit	TREE ZONE WITH PCN BUBBLERS	30.64 in/h	1.40	3		
<u>Irrigation Water System</u>							
5	Rain Bird PESB	Turf Rotary	0.41 in/h	1.40	207	5,897	2,948
6	Rain Bird PESB	Turf Rotary	0.51 in/h	1.40	167	4,758	2,379
7	Rain Bird PESB	Turf Spray	1.85 in/h	1.40	46	596.7	198.9
8	Rain Bird PESB	Turf Spray	3.22 in/h	1.40	27	283.6	94.5
9	Rain Bird PESB	Turf Rotary	0.36 in/h	1.40	235	4,686	2,343
10	Rain Bird PESB	Turf Rotary	0.34 in/h	1.40	245	4,733	2,367
11	Rain Bird PESB	Turf Rotary	0.36 in/h	1.40	235	6,054	3,027
12	Rain Bird PESB	Turf Rotary	0.56 in/h	1.40	150	4,001	2,000
13	Rain Bird PESB	Turf Rotary	0.35 in/h	1.40	243	6,036	3,018
14	Rain Bird PESB	Turf Rotary	0.32 in/h	1.40	264	6,782	3,391
15	Rain Bird PESB	Turf Rotary	0.35 in/h	1.40	238	5,679	2,839
16	Rain Bird PESB	Turf Spray	2.29 in/h	1.40	37	731.6	243.9
TOTALS:							
			2,660	50,238	24,850		



**ORCHARD MESA
FIRE STATION #4**

GRAND JUNCTION, COLORADO

**IRRIGATION
NOTES &
DETAILS**

NO: ISSUED FOR: DATE:




PROJECT STATUS:
100% CD's

DRAWN BY: B.G.V. CHECKED BY: J.J.S.

DATE:
04-29-2015 SHEET NO:

PROJECT NO:
1443
2015-0002

IR301

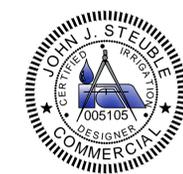


**Grand Junction
Pipe & Supply**
Irrigation Design Department
2868 I-70 Bus. Loop
Grand Jct, CO 81501
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Design Date: 04-29-2015	Designed By: B.G.V.
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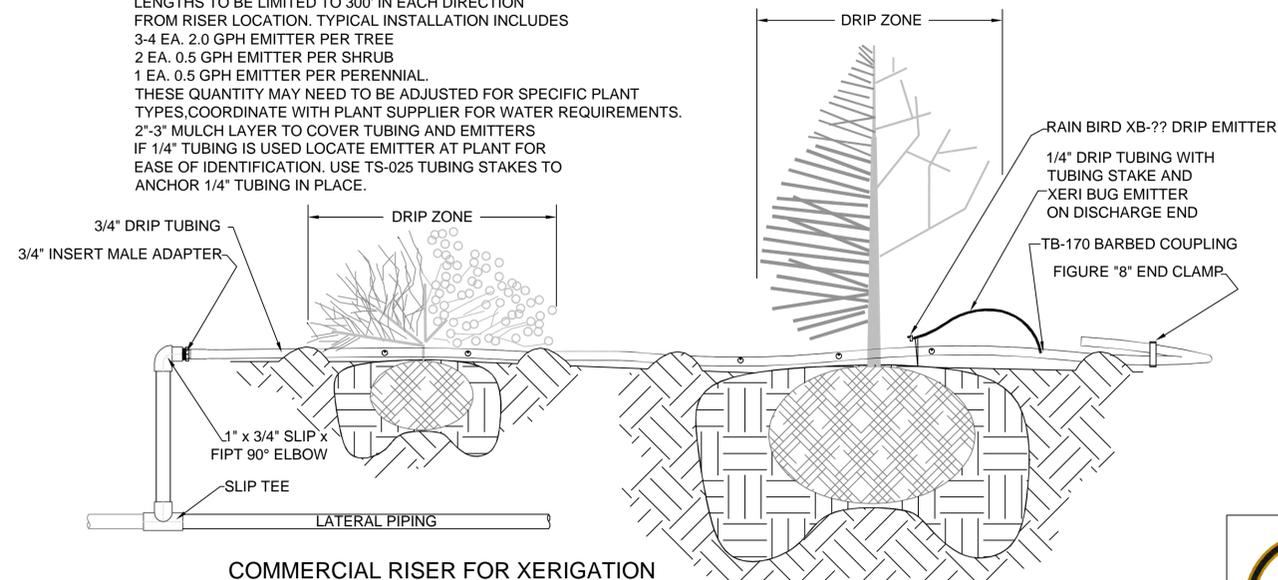
Revised

IRRIGATION NOTES:

- All work shall be per existing county or state code and is subject to inspection and approval by appropriate inspectors and/or owner representative. Installer to be responsible for all installation standards, practices and all permit requirements.
- Julee Wolverton** has provided all base and planting information. Any discrepancies between said information and these irrigation plans shall be their responsibility. The installer will assume all costs and liabilities associated with any and all field changes to the system design.
- The system is designed to operate from the irrigation water source with a flow of **28-30** gallons per minute (GPM) at **55** pounds per square inch (PSI) at the pump. (Irrigation Water Supply)
- This is designed to operate from a domestic water connection with the source providing a flow of **10-12** gallons per minute (GPM) at **75** pounds per square inch (PSI) with a 1" 825 RPYA Backflow Device. Unless otherwise noted on the plans, source flow and pressure are the responsibility of others.
- All pipe to be sleeved wherever concrete, asphalt, or any hard surfaces are to be overlaid. All sleeves to be 2 times the diameter of the pipe to be sleeved. Main line sleeves to have an additional 4" inch sleeve in parallel for control wires.
- Irrigation plan is a diagrammatic single line drawing. Any components shown on plan outside of landscape are shown for clarity only. Multiple pipes may be installed in the same trench when proper pipe spacing can be maintained.
- Main line to be buried 24" (inch) to top of pipe.
- Control wires to be 2-Wire Control Path In A 1" PVC "Electrical" Conduit With A Tracer Wire. 2 Wire Control Path To Be Hunter Or Rain Bird
- Swing pipe to be used on all sprinkler heads under 6 GPM and swing joints on all heads over 6 GPM. Maximum length of swing pipe to be 5' (foot).
- Isolation valves to be located in 10" (inch) round valve box or larger.
- For obstructions (Electrical Transformers, Trees, Fire Hydrants, etc...), that will interfere with proper coverage of sprinkler heads, will require the addition of properly patterned heads around obstruction as to provide head to head coverage to all irrigated areas.
- Sprinkler heads to be set perpendicular to finished grade and adjusted to prevent over spray onto non irrigated areas.
- Laterals are sized at transitions only, segments that are not noted will be the same size as adjacent segments. Up stream segments will never be smaller than any down stream segments on the same lateral.
- Valve boxes located in beds shall be tan /brown in color. Valve boxes in turf areas shall be green in color



NOTE:
EACH RISER HAS A MAXIMUM RATING OF 10 GPM=600 GPH WHICH IS EQUAL TO 600 XB-10 DRIP EMBITTERS. TUBING LENGTHS TO BE LIMITED TO 300' IN EACH DIRECTION FROM RISER LOCATION. TYPICAL INSTALLATION INCLUDES 3-4 EA. 2.0 GPH Emitter PER TREE 2 EA. 0.5 GPH Emitter PER SHRUB 1 EA. 0.5 GPH Emitter PER PERENNIAL. THESE QUANTITY MAY NEED TO BE ADJUSTED FOR SPECIFIC PLANT TYPES. COORDINATE WITH PLANT SUPPLIER FOR WATER REQUIREMENTS. 2'-3" MULCH LAYER TO COVER TUBING AND EMBITTERS IF 1/4" TUBING IS USED LOCATE Emitter AT PLANT FOR EASE OF IDENTIFICATION. USE TS-025 TUBING STAKES TO ANCHOR 1/4" TUBING IN PLACE.

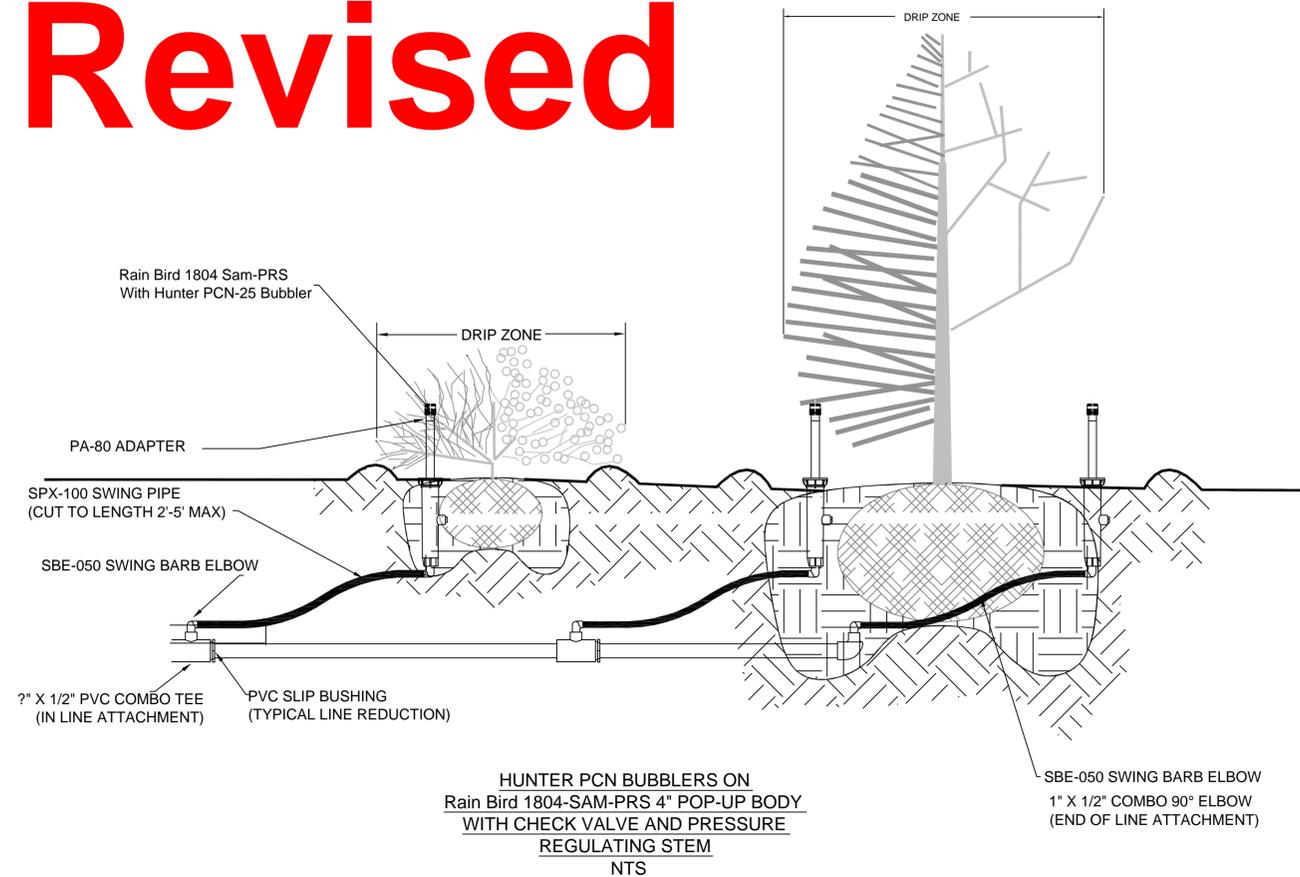

COMMERCIAL RISER FOR XERIGATION

ORCHARD MESA FIRE STATION #4

GRAND JUNCTION, COLORADO

IRRIGATION NOTES & DETAILS

NO: ISSUED FOR: DATE:



PROJECT STATUS:
100% CD's

DRAWN BY: B.G.V. CHECKED BY: J.J.S.


















DATE:
04-10-2015 SHEET NO:

PROJECT NO:
1443
2015-0002

IR301

	Grand Junction Pipe & Supply Irrigation Design Department 2868 I-70 Bus. Loop Grand Jct, CO 81501 (970) 243-4604	
	Design Date: 04-10-2015	Designed By: B.G.V.
Drawing Number: 2015-0002	Checked By: J.J.S.	PROJECT NO: 1443 2015-0002

CITY OF GRAND JUNCTION & UTE WATER
DOMESTIC CONNECTION DETAIL

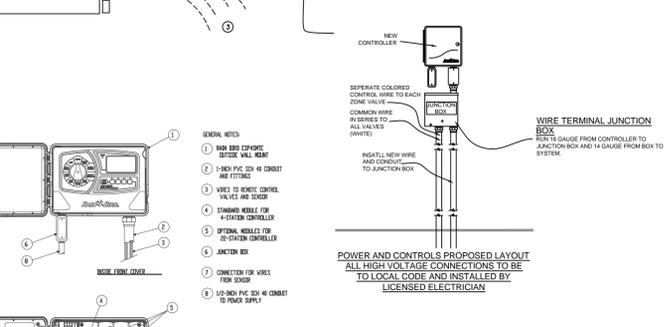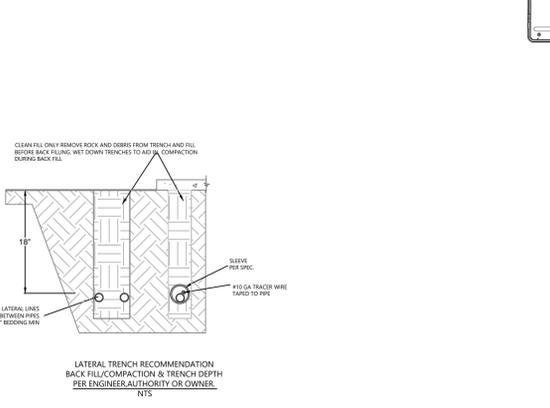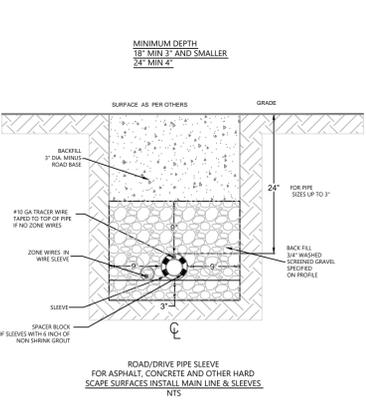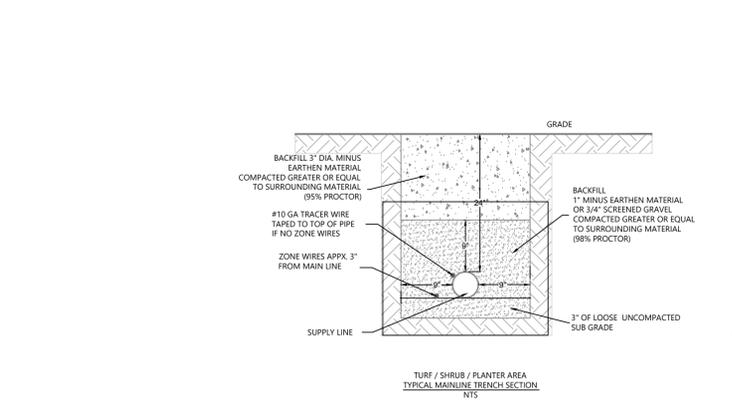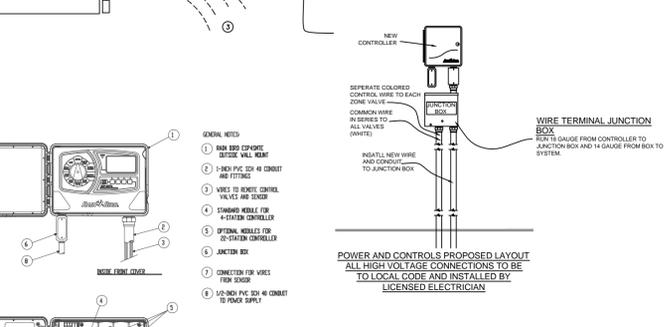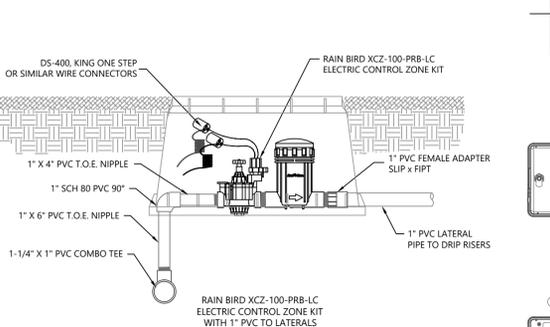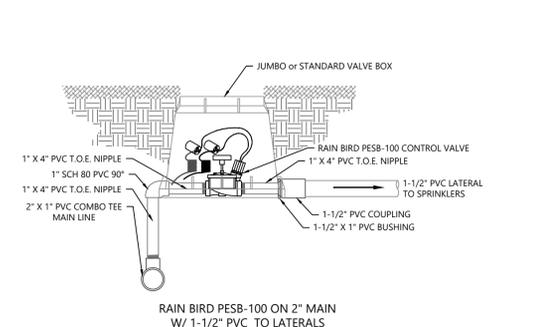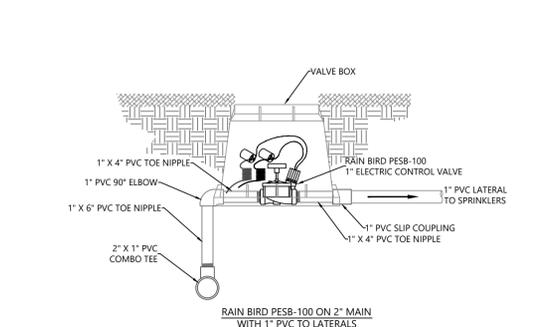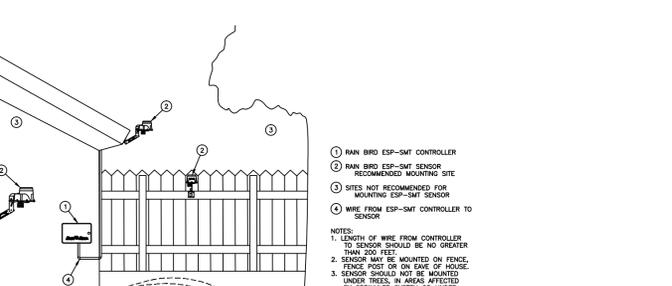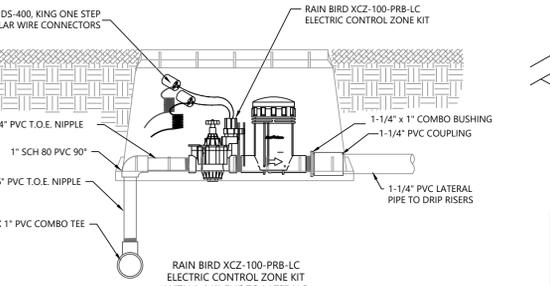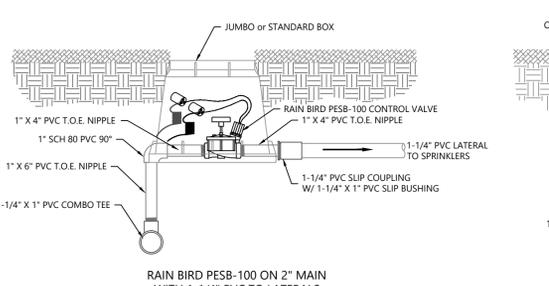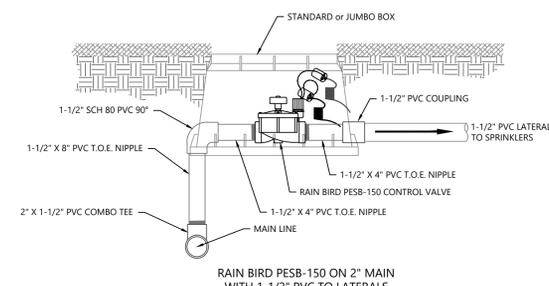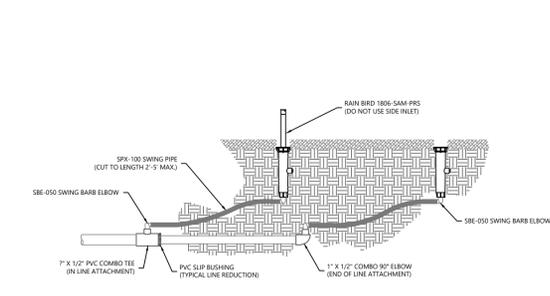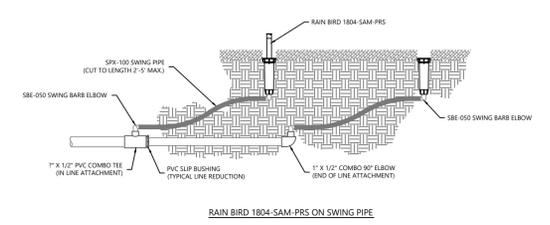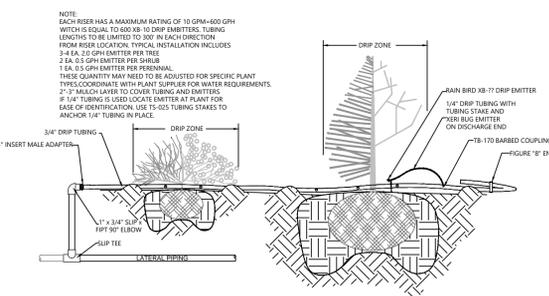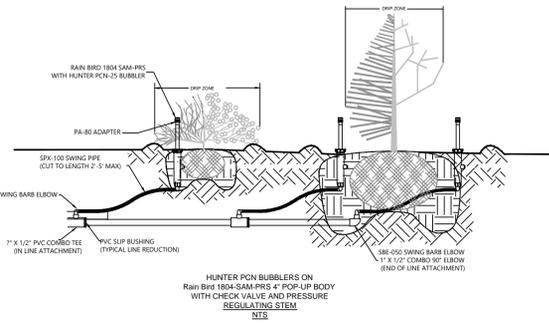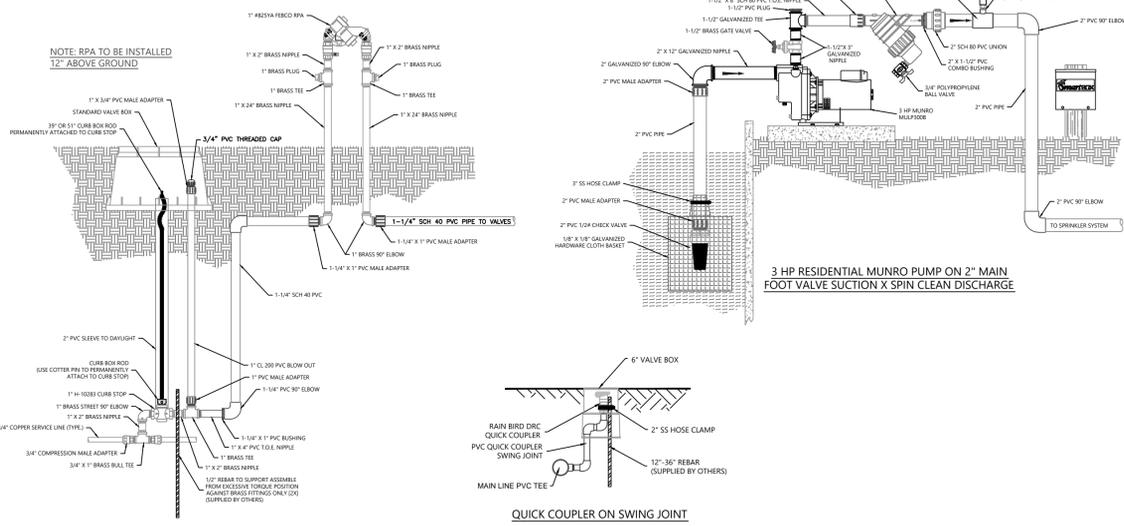


ORCHARD MESA
FIRE STATION #4

GRAND JUNCTION, COLORADO

IRRIGATION
DETAILS

NO: ISSUED FOR: DATE:

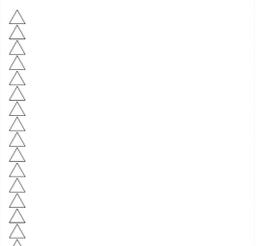

PROJECT STATUS:
100% CD's
DRAWN BY: B.G.V. CHECKED BY: J.J.S.
DATE:
04-29-2015 SHEET NO:
PROJECT NO:
1443
2015-0002

Grand Junction Pipe & Supply
Irrigation Design Department
2868 I-70 Bus. Loop
Grand Jct, CO 81501
(970) 243-4604

Design Date: 04-29-2015
Drawing Number: 2015-0002



Designed By: B.G.V.
Checked By: J.J.S.




CITY OF GRAND JUNCTION & UTE WATER
DOMESTIC CONNECTION DETAIL

Revised


NOTE: RPA TO BE INSTALLED
12" ABOVE GROUND

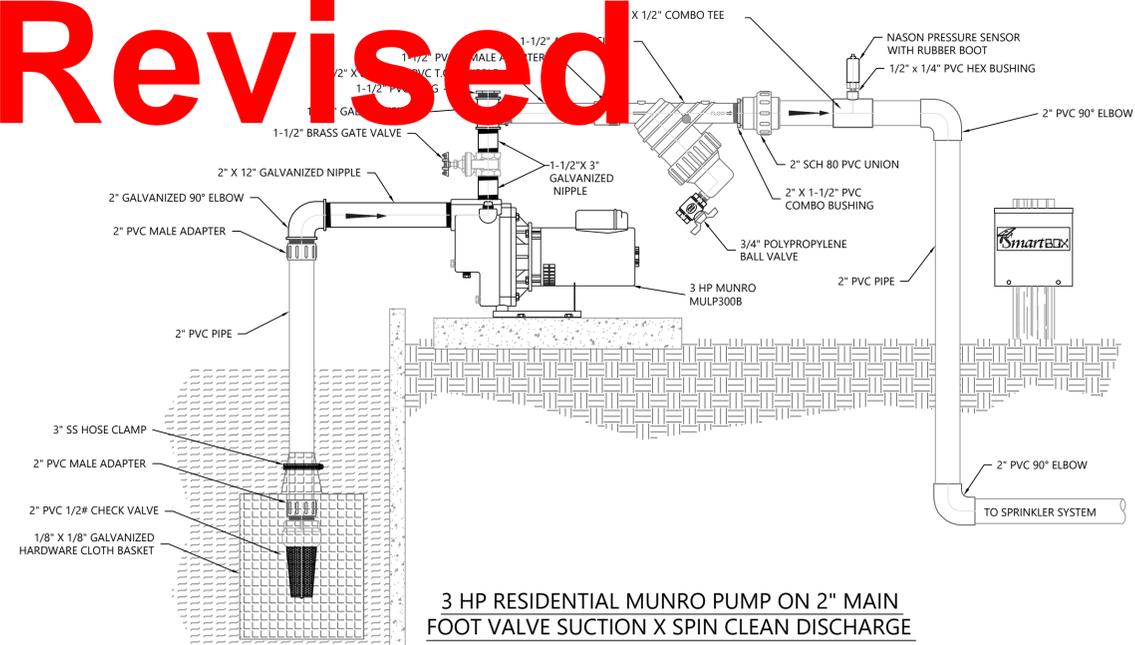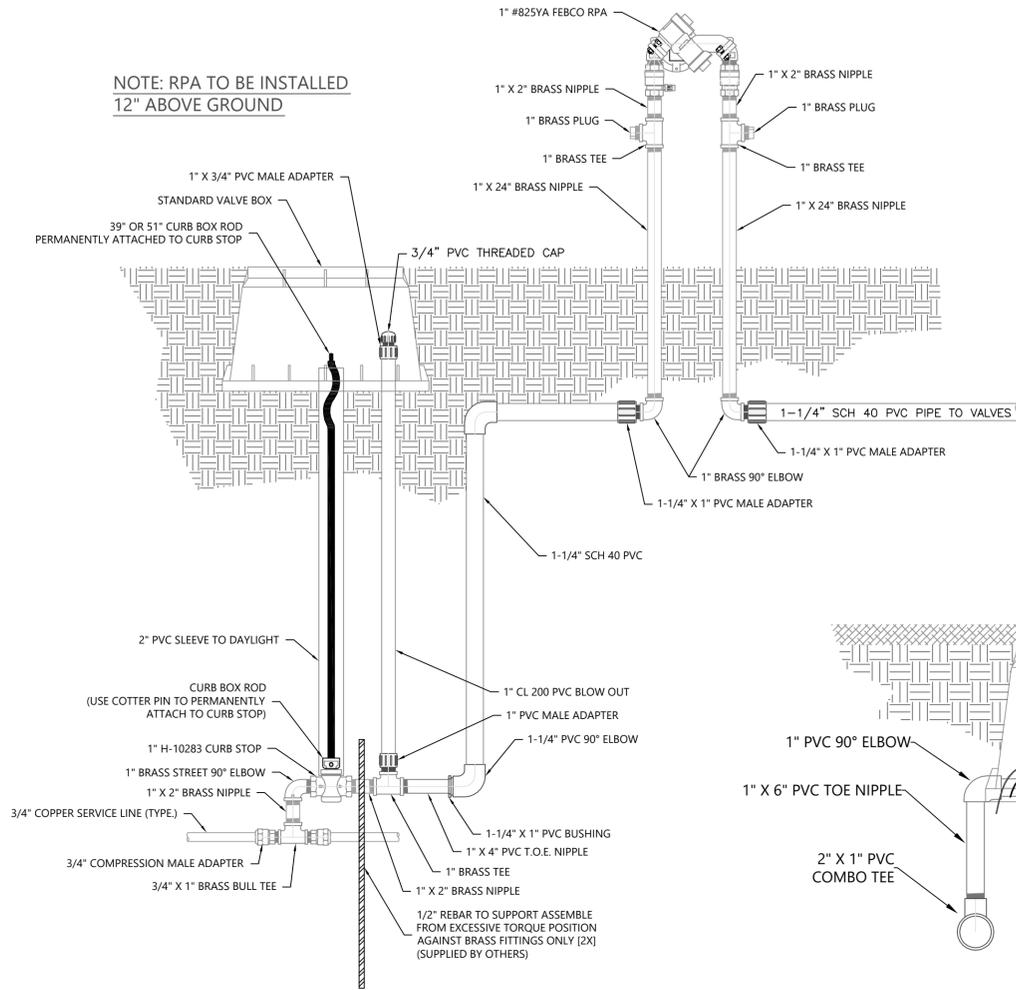


3 HP RESIDENTIAL MUNRO PUMP ON 2" MAIN
FOOT VALVE SUCTION X SPIN CLEAN DISCHARGE

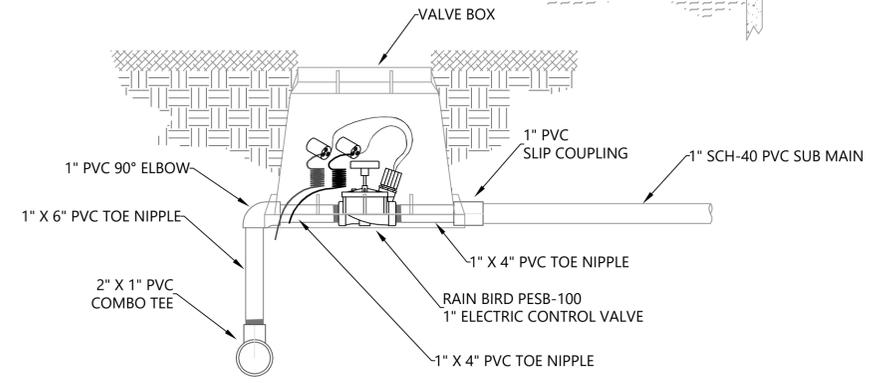


RAIN BIRD PEB-100 ON 2" MAIN
VALVE DETAIL NTS

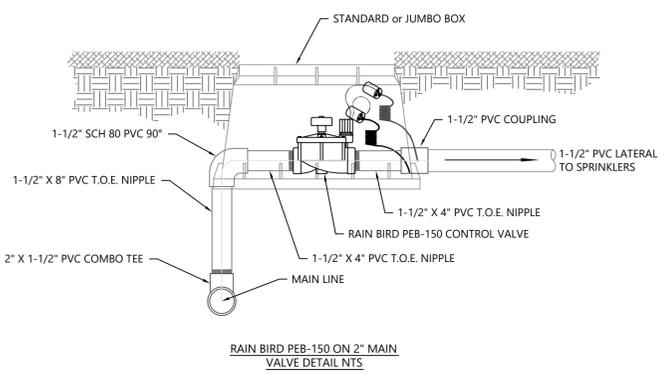


RAIN BIRD PEB-150 ON 2" MAIN
VALVE DETAIL NTS

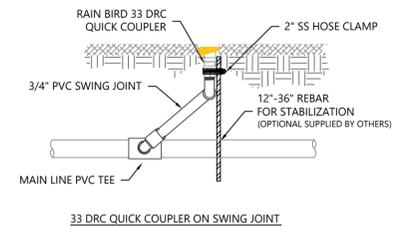


33 DRC QUICK COUPLER ON SWING JOINT

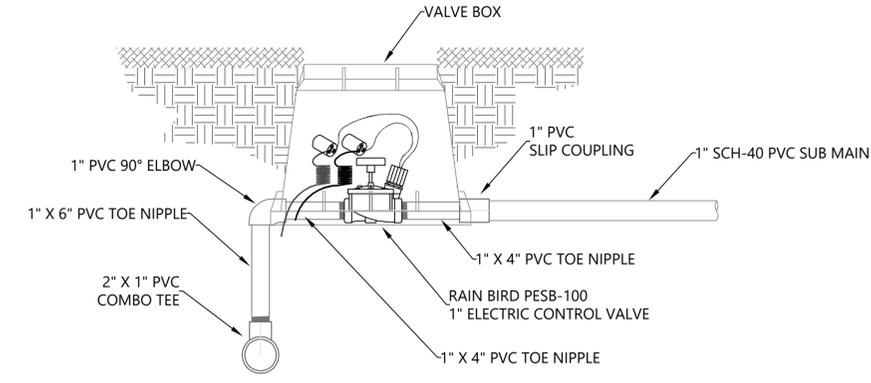


RAIN BIRD PEB-100 ON 2" MAIN
VALVE DETAIL NTS

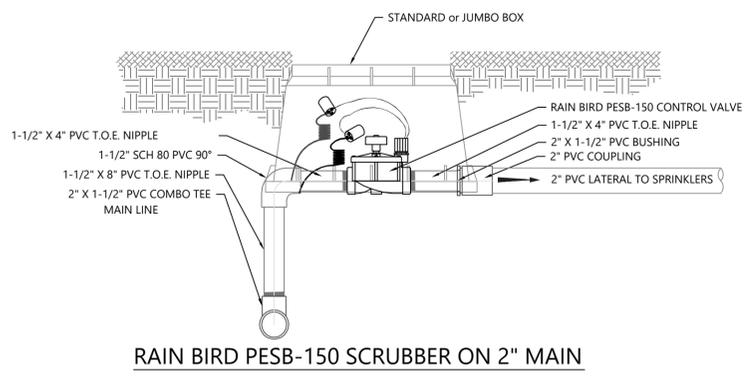

RAIN BIRD PESB-150 SCRUBBER ON 2" MAIN

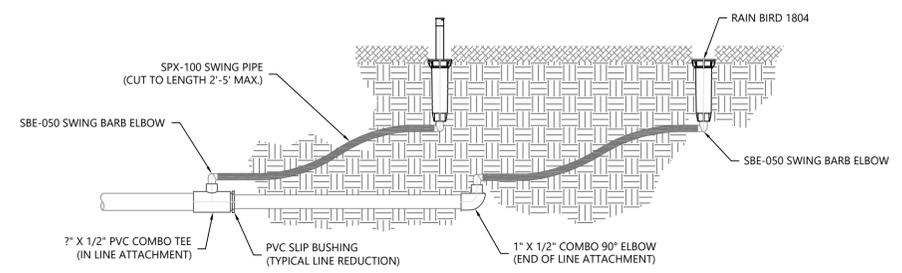

RAIN BIRD 1804 ON SWING PIPE

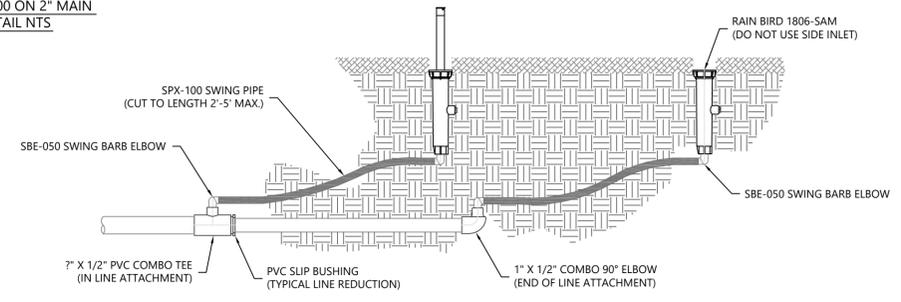

RAIN BIRD 1806-SAM ON SWING PIPE

ORCHARD MESA FIRE STATION #4

GRAND JUNCTION, COLORADO

IRRIGATION DETAILS

NO: ISSUED FOR: DATE:



PROJECT STATUS:
100% CD's

DRAWN BY: B.G.V. CHECKED BY: J.J.S.

DATE:
04-10-2015 SHEET NO:

PROJECT NO:
1443 IR302
2015-0002




**Grand Junction
Pipe & Supply**
Irrigation Design Department
2868 I-70 Bus. Loop
Grand Jct, CO 81501
(970) 243-4604

Design Date: 04-10-2015	Designed By: B.G.V.
Drawing Number: 2015-0002	Checked By: J.J.S.

ARCHITECTURAL ABBREVIATIONS

ABV	above	EF	exhaust fan	HSS	hollow structural steel	OPH	opposite hand	SHT	sheet
ACC	accessories	EG	etched glass/glazing	HT	height	OPP	opposite	SHTG	sheathing
AFF	above finished floor	EIFS	exterior insul finish sys	HVAC	heating /vent /air cond	OSB	oriented strand board	SIM	similar
ALT	alternate	EJ	expansion joint	HWD	hardwood	OTS	open to structure	SND	sanitary napkin dispenser
AL	aluminum	EL	elevation					SNV	sanitary napkin vendor
APC	acoustical panel ceiling	ELEC	electric (al)	INCL	include (d) (ing)	PB	particle board	SPEC	specification
ARCH	architect (ural)	EM	emergency	INSUL	insulate (d) (ing)	PERF	perforate	SPKR	speaker
ASPH	asphalt	EWC	electric water cooler	INT	interior	PERIM	perimeter	SQ	square
A/C	air conditioning	EWG	end wall corner guard	INV	invert	PLAM	plastic laminate	SS	solid surface
		EQ	equal			PLT	plate	SST	stainless steel
BCS	baby changing station	EXG	existing	JST	joist	PNL	panel	STD	standard
BD	board	EXH	exhaust	JT	joint	PNT	paint (ed)	STL	steel
BLDG	building	EXP	exposed			PR	pair	STOR	storage
BLKG	blocking	EXT	exterior	L	length, angle	PROJ	projector, projection	STR	structural
BO	bottom of			LAM	laminated (d)	PSF	pounds per square foot	SUSP	suspended
BRG	bearing	FBO	furnished by owner	LAB	lavatory	PT	pounds per square inch	T	tread
		FD	floor drain	LB	lavatory	PTD	pressure treated	TB	towel bar
CBU	ceemititious backer unit	FDN	foundation	LF	lineal foot	PTN	paper towel dispenser	TEL	telephone
CG	corner guard	FE	fire extinguisher	LG	laminated glass, glazing	PVC	polyvinyl choiride	T.O.	top of
CJ	control joint	FEC	fire extinguisher cabinet	LIN	linoleum	PVMT	pavement	TOC	top of concrete
CLG	ceiling	FEP	finished end panel	LR	louver	PWD	plywood	TOS	top of steel
CLR	clear (ance)	FFE	finished floor elevation	LT	light			TOW	top of wall
CMU	concrete masonry unit	FIN	finish			QT	quarry tile	TPD	toilet paper dispenser
CNRG	corner guard	FLG	flashing	MA	match			TS	tube steel
COL	column	FLR	floor (ing)	MAS	masonry	R	riser, radius	TYP	typical
CONC	concrete	FLUR	fluorescent	MATL	material	RB	rubber base	T&G	tongue and groove
CONT	continuous or continue	FO	face of	MAX	maximum	REC	recycling		
CORR	corridor	FRMG	framing	MECH	mechanic (al)	RCMD	recommend (ed) (ations)		
CPT	carpet (ed)	FRP	fiber reinforced plastic	MFR	reference	RE	reference		
CSMT	casement	FT	foot (feet)	FT	foot (feet)	REF	refrigerator		
CT	ceramic tile	FTG	footing	MH	manhole	REIN	reinforce (d) (ing)		
CTR	center	FV	field verify	MIN	minimum	REQ	required		
CU	condensing unit			MISC	miscellaneous	REV	revision (s), revised		
CWOG	center wall on grid	GA	gage, gauge	MLD	molding, moulding	RD	roof drain		
		GAL	gallon	MMB	membrane	RFG	roofing		
DBL	double	GALV	galvanized	MO	masonry opening	RH	robe hook		
DEMO	demolish / demolition	GB	grab bar	MT	mount (ed) (ing)	RM	room		
DF	drinking fountain	GC	general contractor	MTL	metal	RO	rough opening		
DIM	dimension (s)	GL	glass, glazing	N	north	ROW	right of way		
DIR	direction	GWB	gypsum wallboard	N/A	not applicable	RR	restroom		
DISP	dispenser	GYP	gypsum	NIC	not in contract	RTU	roof top unit		
DN	down			NOM	nominal	RUB	rubber		
DR	door	HAS	headed anchor stud	NTS	not to scale				
DS	downspout	HB	hose bibb	NECY	necessary	S	south		
DTL	detail	HCP	handicap (ed)			SAG	susp acoustic grid		
DWG	drawing	HDR	header			SC	shower curtain rod & hooks		
DWR	drawer	HDW	hardware			SCH	schedule		
		HM	hollow metal			SD	soap dispenser		
E	east	HOR	horizontal						
EA	each	HP	heat pump						
EC	evaporative cooler	HR	hose reel						

SYMBOLS

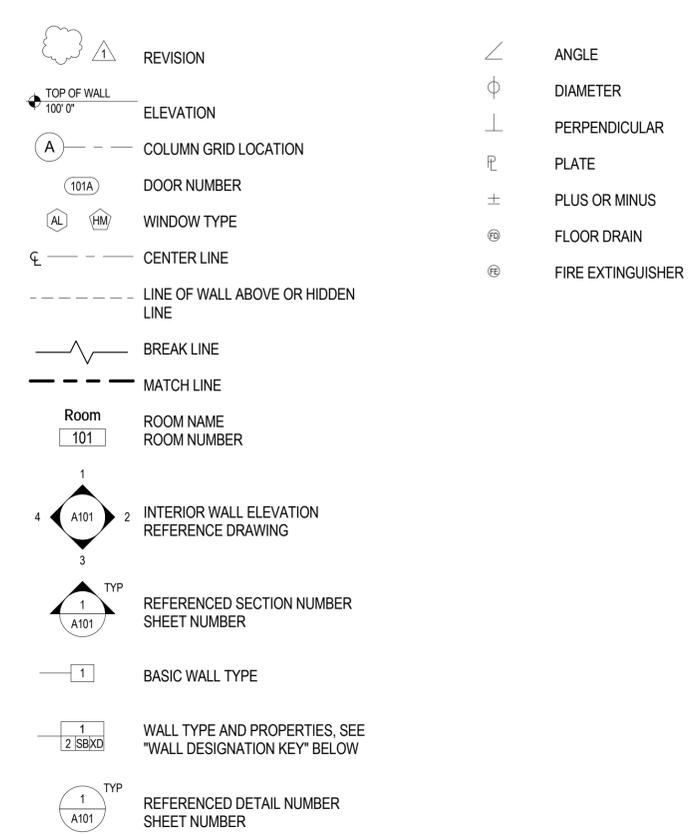


GENERAL NOTES

- COMPLY WITH ALL MANUFACTURERS RECOMMENDATIONS AND INDUSTRY STANDARDS RELEVANT TO THE WORK HEREIN.
- ALL DIMENSIONS ARE FROM FACE OF FINISH UNO.
- ALL ALIGNMENTS ARE FACE OF FINISH UNO.
- FIELD VERIFY ALL DIMENSIONS AND ROUGH OPENINGS PRIOR TO FABRICATION AND/OR INSTALLATION. PROVIDE 1/2-HR RATED WALLS SEPARATING SLEEPING UNITS (PER GA FILE NO. WP 3514).

CHAMBERLIN ARCHITECTS
437 Main St.
Grand Junction, Colorado 81501
T 970.242.6904

725 Saint Joseph St., Suite B1
Rapid City, South Dakota 57701
T 605.355.6804

www.chamberlinarchitects.com

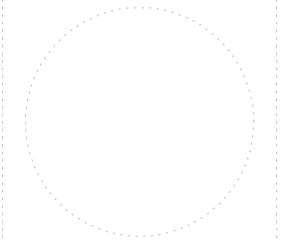

ORCHARD MESA
FIRE STATION #4

GRAND JUNCTION, COLORADO

NOTES, SYMBOLS,
ABBREVIATIONS
AND WALL TYPES

NO: ISSUED FOR: DATE:



PROJECT STATUS: 100% CDs

DRAWN BY: Author CHECKED BY: Checker

DATE: 04/10/2015 SHEET NO:

PROJECT NO: 1443 **A001**

ARCHITECT'S
SUPPLEMENTAL INSTRUCTIONS

PROJECT:	Orchard Mesa Fire Station #4	ARCHITECT'S SUPPLEMENTAL INSTRUCTION NO: Four (4)
OWNER:	City of Grand Junction	ARCHITECT: Chamberlin Architects 437 Main Street Grand Junction, CO 81501
TO:	FCI Constructors, Inc. 3070 I-70 B, Bldg A Grand Junction, CO 81504	ARCHITECT'S PROJECT NO: 1443
		DATE OF ISSUANCE: July 29, 2015



The Work shall be carried out in accordance with the following supplemental instructions issued in accordance with the Contract Documents without change in Contract Sum or Contract Time. Preceding in accordance with these instructions indicates your acknowledgment that there will be no change in the Contract Sum or Contract Time.

- Sheet A001, Wall Types, Wall Types 1, 1A & 10. Change text to read: "30-MIN FIRE RATING - UL U407, APPLIES TO WALLS WITH HEAVY DASHED LINE AS INDICATED ON SHEET A002, LIFE SAFETY PLAN".
- Sheet A001, Wall Types, Wall Types 5 & 5A. Delete "2-HR FIRE RATING - UL U906".

Attachments: None

ARCHITECT: Chamberlin Architects, P.C.

BY: Jonathan West
S:\1443 - Orchard Mesa Fire Station #4\6. CONSTRUCTION\AS\ASH004.1443.doc

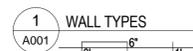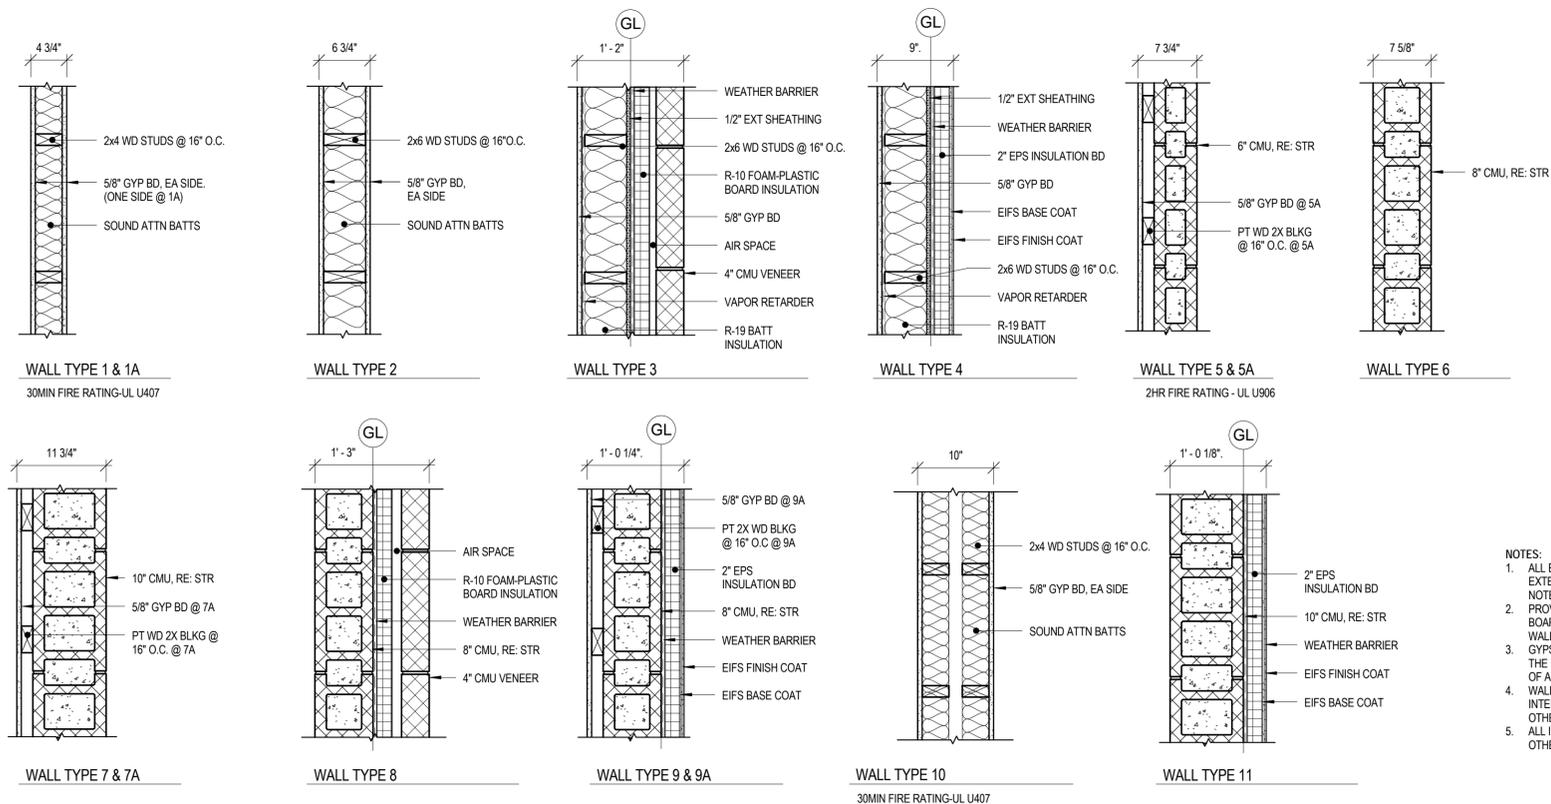

- NOTES:
- ALL EXTERIOR WALL TYPES ARE SHOWN WITH THE EXTERIOR WALL FACING RIGHT UNLESS OTHERWISE NOTED.
 - PROVIDE GLASS MAT WATER-RESISTANT BACKER BOARD IN LIEU OF GYPSUM WALL BOARD BEHIND ALL WALL TILE.
 - GYPSUM BOARD SHALL BE MOISTURE-RESISTANT AT THE FOLLOWING LOCATIONS: WALLS AND CEILINGS OF ALL RESTROOMS AND SHOWERS
 - WALL TYPE CHANGES OCCUR AT CORNERS OR INTERSECTIONS OF WALLS UNLESS NOTED OTHERWISE.
 - ALL INTERIOR WALLS TO BE TYPE 1 UNLESS NOTED OTHERWISE.

4/10/2015 11:08:37 AM

GENERAL NEW CONSTRUCTION NOTES

- DO NOT SCALE DRAWINGS. IF DIMENSIONS ARE IN QUESTION THE CONTRACTOR SHALL BE RESPONSIBLE FOR OBTAINING CLARIFICATION FROM THE ARCHITECT PRIOR TO CONTINUING CONSTRUCTION.
- ITEMS NOT NOTED ON THE DRAWINGS SHALL BE CONSIDERED THE SAME AS NOTED ITEMS WHICH ARE GRAPHICALLY REPRESENTED IN THE SAME MANNER.
- PROVIDE TREATED SOLID WOOD BLOCKING FOR ALL WALL EQUIPMENT, TOILET ACCESSORIES, MILLWORK AND OTHER WALL MOUNTED ITEMS. CONTRACTOR SHALL CAULK AT THE INTERFACE OF INTERIOR FACES OF DOOR FRAMES WITH ADJACENT MATERIALS THOUGH JOINT MAY NOT BE VISIBLE.
- PROVIDE TRANSITION STRIPS BETWEEN FLOOR MATERIALS OF DISSIMILAR HEIGHTS. CENTER TRANSITION STRIPS UNDER DOORS OR OTHER PLACES OUT OF SIGHT.
- PROVIDE POSITIVE SLOPE ON ALL FLOOR DRAINS MINIMUM OF 1/8" : 12". SLOPE FLOOR ALL AROUND FROM ADJACENT WALLS TO FLOOR DRAINS. DO NOT DEPRESS ONLY THE AREA IMMEDIATELY AROUND THE DRAIN.
- REFER TO THE MECHANICAL, ELECTRICAL, AND PLUMBING DRAWINGS FOR THE LOCATIONS OF PIPING, VENTS, DUCTS, CURBS, FANS AND OTHER ITEMS WHICH PENETRATE THE ROOF PLANE.
- DOOR JAMB LOCATION OFF FACE OF WALL IS 4", TYPICAL, UNLESS NOTED OTHERWISE.






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CHAMBERLIN ARCHITECTS
ENLARGED PLAN - GJFD LOGO
ASK-6
A101

ORCHARD MESA FIRE STATION #4

GRAND JUNCTION, COLORADO

FLOOR PLAN

NO: ISSUED FOR: DATE:

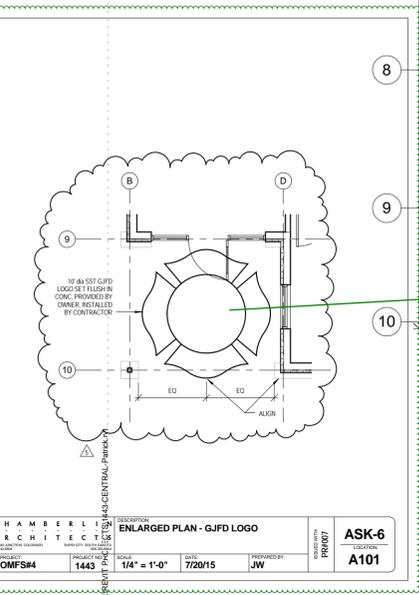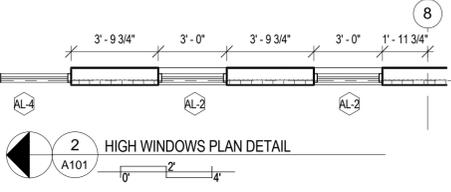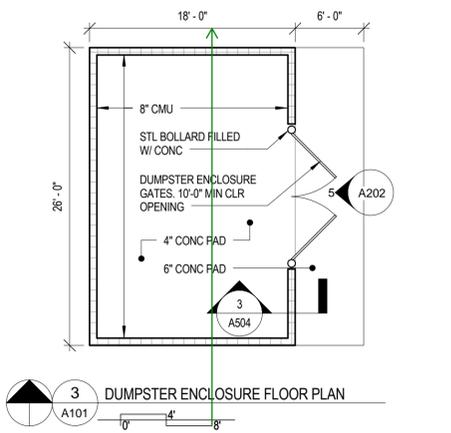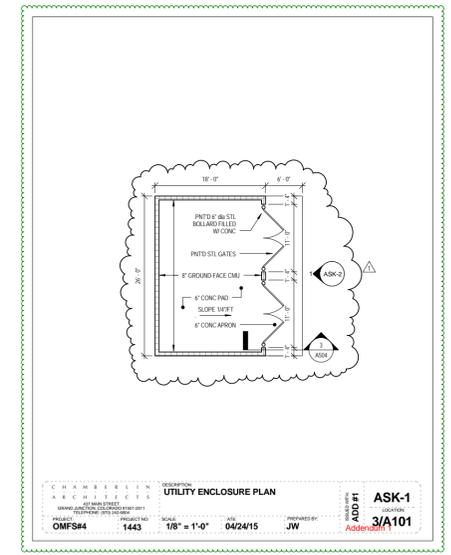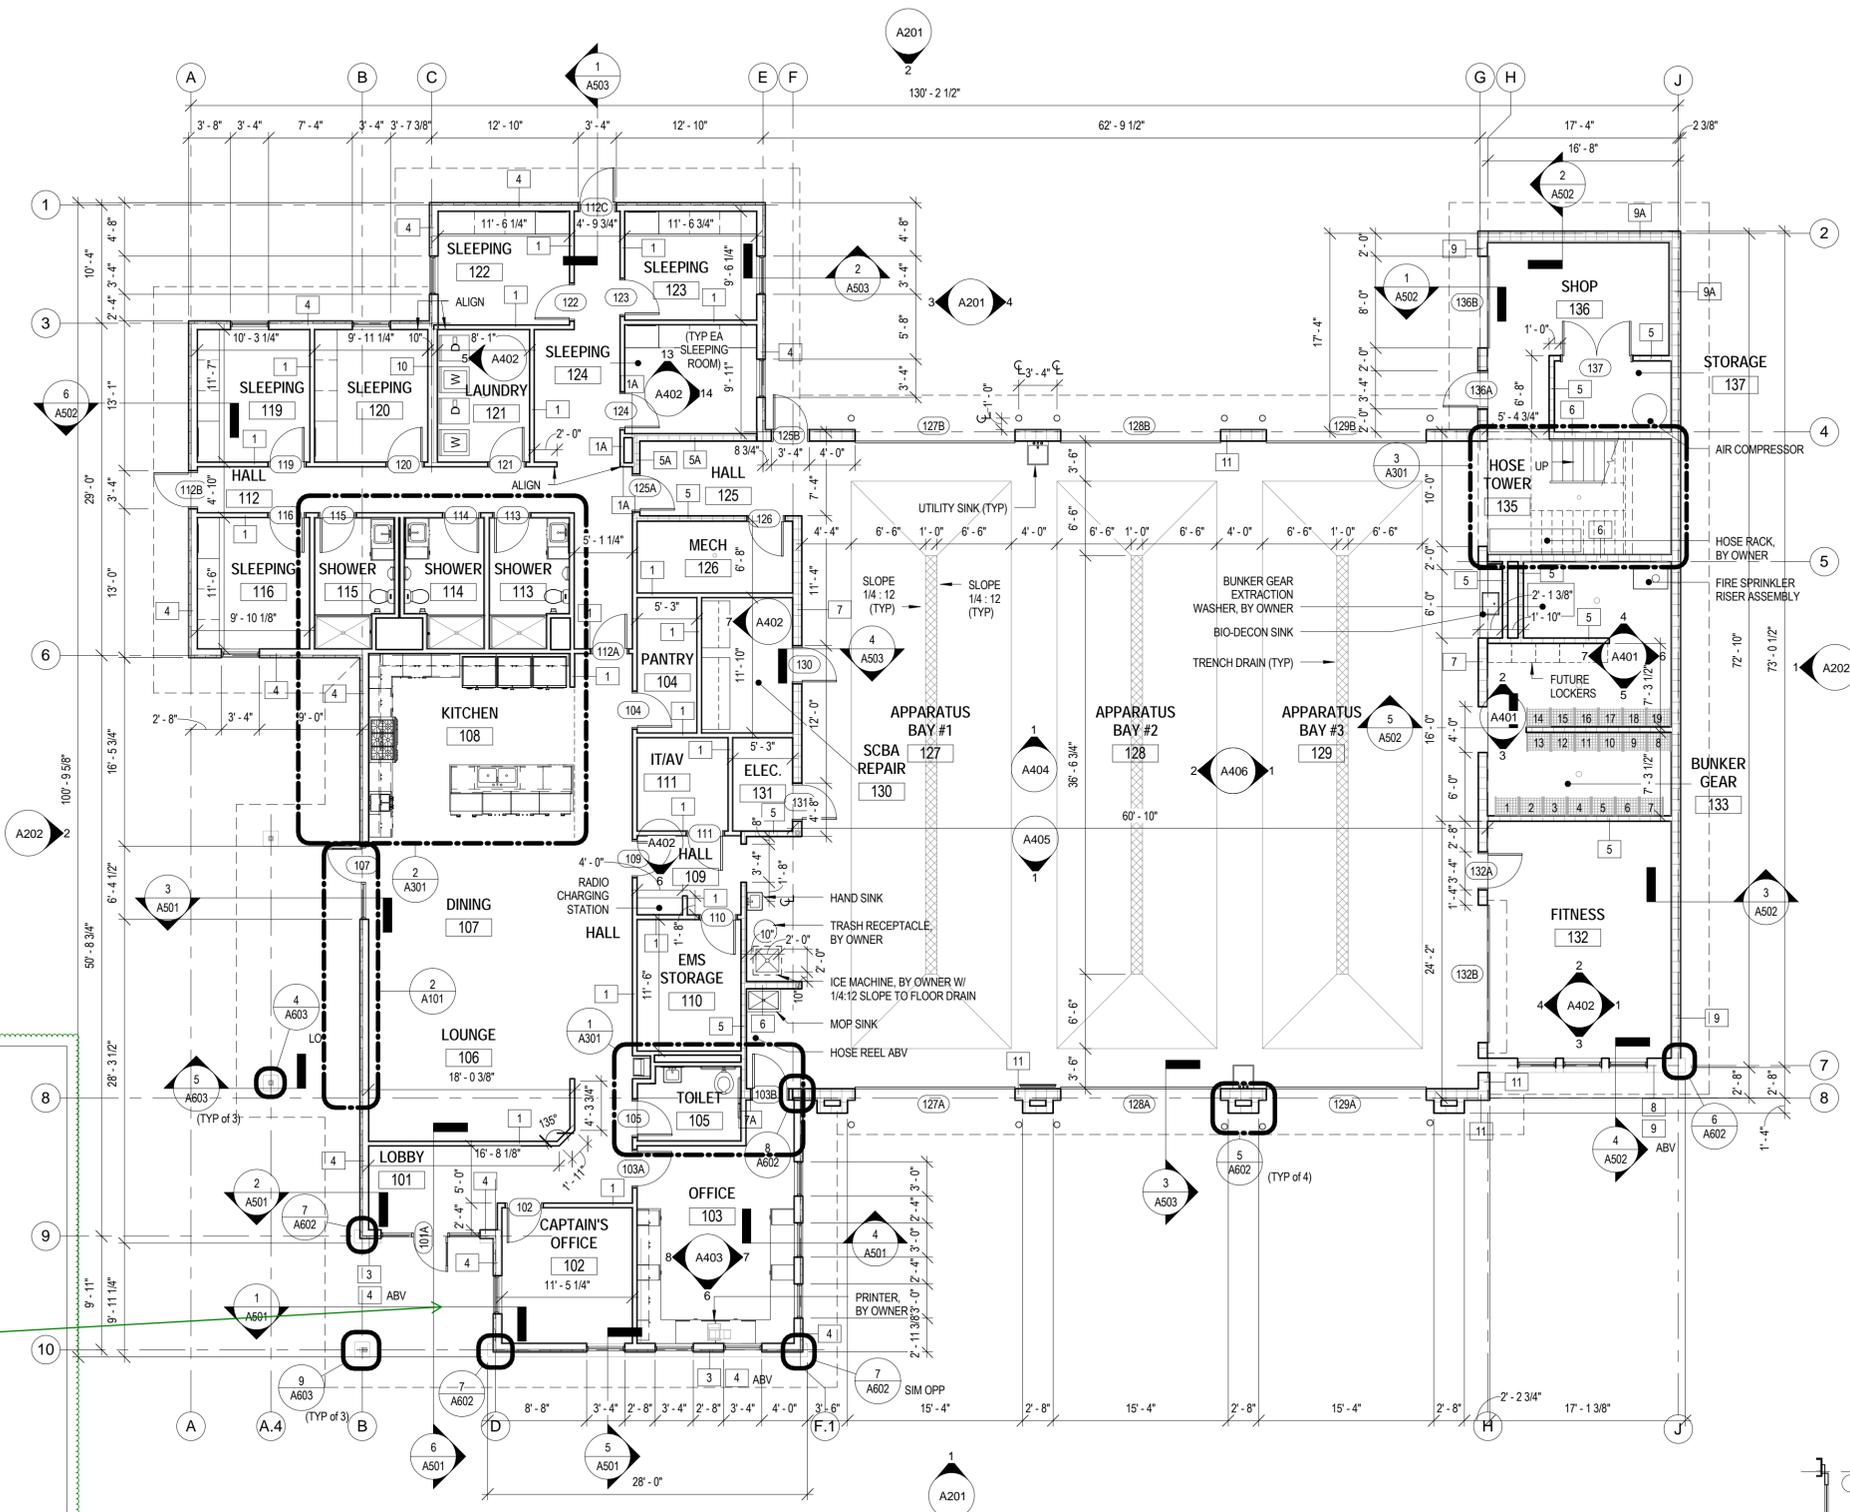PROJECT STATUS: 100% CDs

DRAWN BY: JW CHECKED BY: Checker

DATE: 04/10/2015 SHEET NO:

PROJECT NO: 1443 A101

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LEGEND

	GYP BD, PAINT		6" X 4" RECESSED LINEAR FLUORESCENT WALL WASH, RE: ELEC		PENDANT, RE: ELEC		SUPPLY AIR GRILLE, RE: MECH	NOTE: CENTER LIGHT FIXTURES IN SPACE AS SHOWN ON REFLECTED CEILING PLANS WHEN LIGHT FIXTURES ARE NOT DIMENSIONED. (TYP)
	2X4 ACOUSTICAL PANEL CEILING. BALANCE TILE AND GRID AT EDGES IN ROOMS, UNO.		SUSPENDED LINEAR STRIP LIGHT, RE: ELEC		DOWNLIGHT, RE: ELEC		EXHAUST FAN, RE: MECH	
	2X2 ACOUSTICAL PANEL CEILING. BALANCE TILE AND GRID AT EDGES IN ROOMS, UNO.		UNDERCABINET LIGHT, RE: ELEC		WALL SCONCE, RE: ELEC		RETURN AIR GRILLE, RE: MECH	
			2X4 RECESSED LIGHT, RE: ELEC		2X2 RECESSED LIGHT, RE: ELEC		EXIT SIGN, RE: ELEC	

RFI # 041 Date Created: 10/13/2015

Answer Company	Answered By	Author Company	Authorized By
City of Grand Junction 250 North 5th Street Grand Junction, CO 81501	Lee Cooper	FCI Constructors, Inc. - GJ P. O. Box 1767 Grand Junction, CO 81502	Adam Shuler

Co-Respondent	Author RFI Number






Subject	Discipline	Category
10-7-15 IT Walk	Special Systems/Electrical	Information

Cc: Company Name	Contact Name	Copies	Notes
FCI Constructors, Inc. - GJ	Craig Reid	1	
Canyon Electric	Steve Bergman	1	
Hunter Drywall	Kevin Hunter	1	
Grand Mesa Mechanical, Inc.	Greg Martin	1	

Question Date Required: 10/20/2015
Just to confirm from our IT walk yesterday and call this morning. We need to proceed with
1) make the IT room ceiling a hard lid vs. a grid ceiling
2) confirm we can still use the AC unit with some possible modifications for mounting in the IT room
3) mount the light fixture in the IT room on the East wall vs. ceiling
4) move the domestic water lines to the south side of the IT room with the isolation valves by the door
5) proceed with the added electrical work for the lounge TV
6) add a 4" and 1" conduit for IT to cross the entry hall hard lid where the cable tray work work.

Suggestion

Answer Date Answered: 10/13/2015
Items 1 - 6 sound correct to me.
Thanks,
Lee
Lee Cooper, P.E.

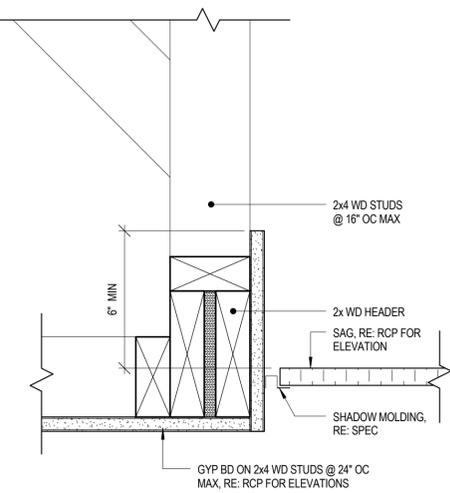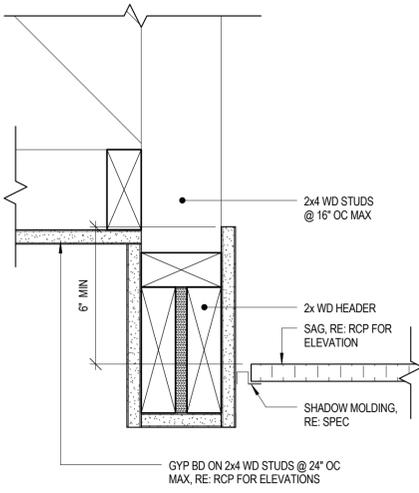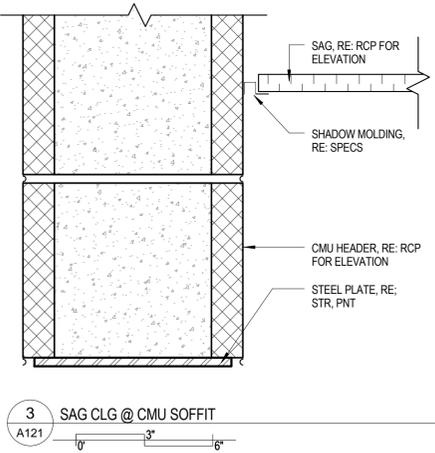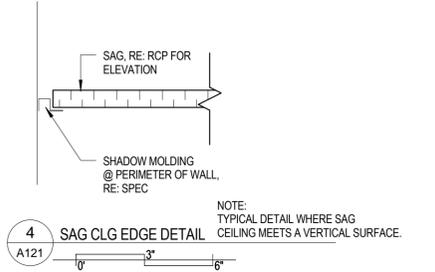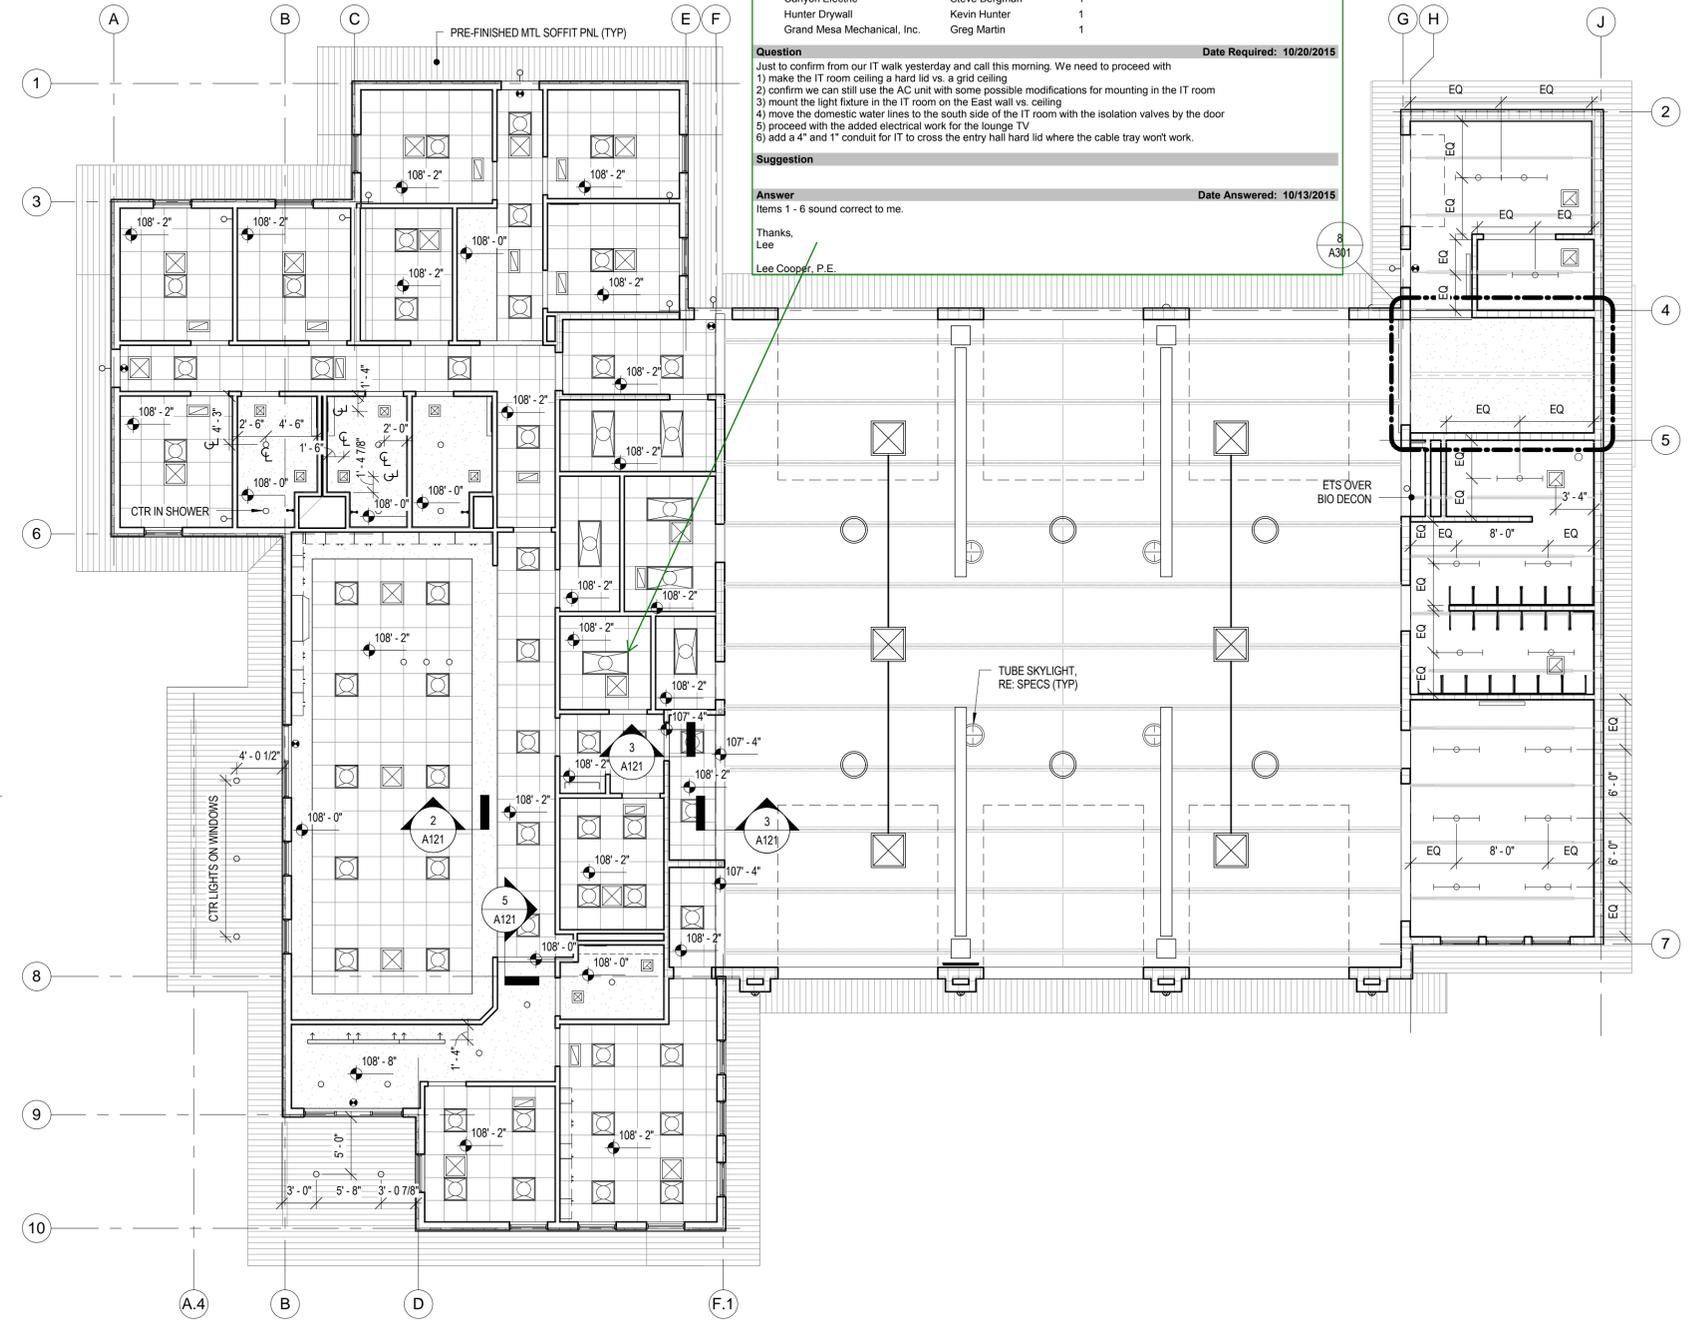

ORCHARD MESA FIRE STATION #4

GRAND JUNCTION, COLORADO

REFLECTED CEILING PLAN


NO: ISSUED FOR: DATE:

PROJECT STATUS: 100% CDs


DRAWN BY: JW CHECKED BY: Checker

DATE: 04/10/2015 SHEET NO:

PROJECT NO: 1443 **A121**

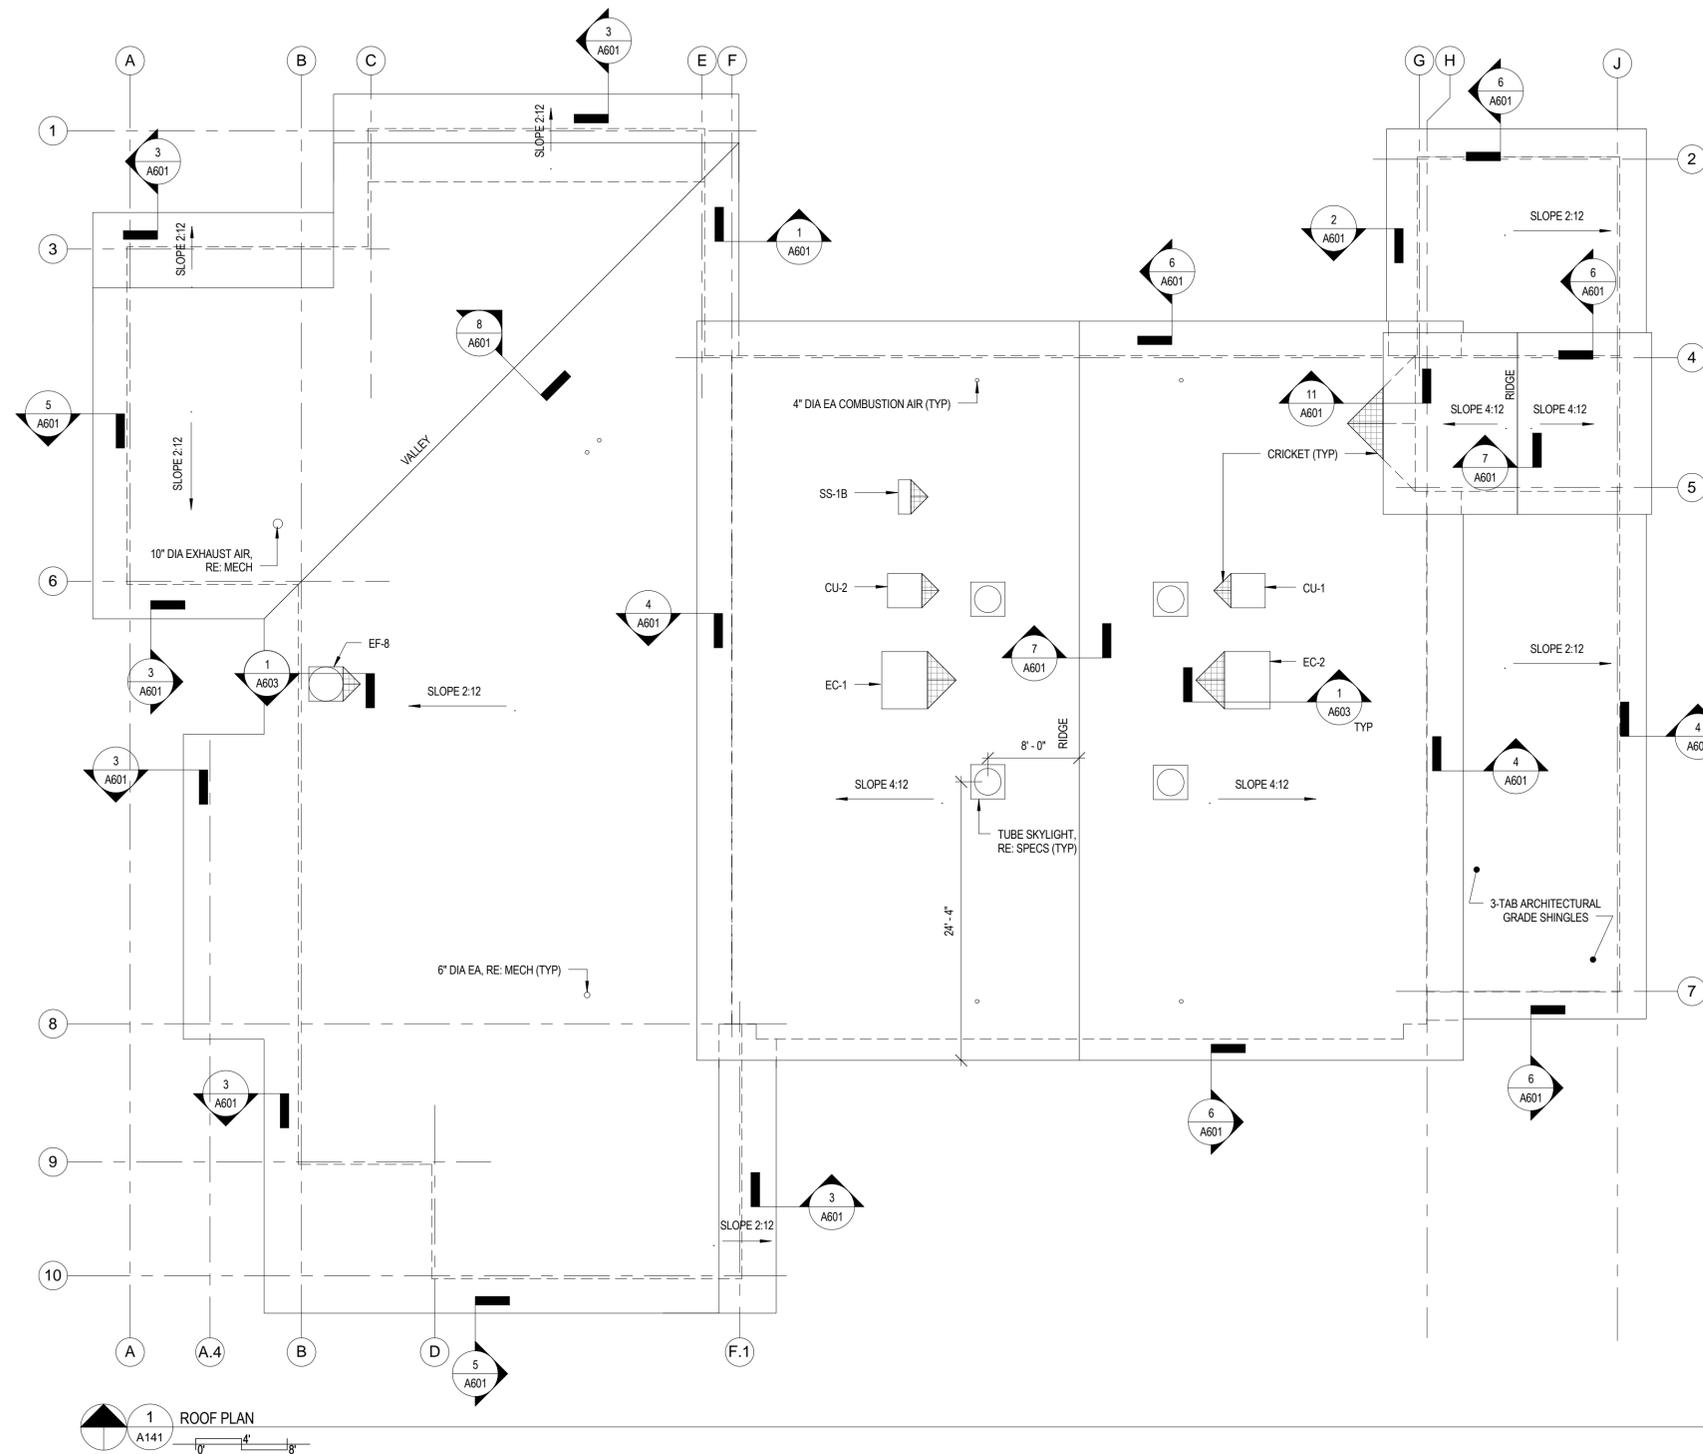

1 ROOF PLAN
A141
10' 4' 8'

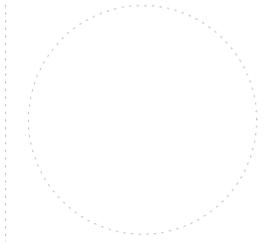

ORCHARD MESA
FIRE STATION #4

GRAND JUNCTION, COLORADO

ROOF PLAN

NO: ISSUED FOR: DATE:



PROJECT STATUS: 100% CDs



DRAWN BY: JW CHECKED BY: Checker

DATE: 04/10/2015 SHEET NO:

PROJECT NO: 1443 **A141**

FURNITURE SCHEDULE					
ITEM	TAG	MANUFACTURER	MODEL NUMBER	DESCRIPTION	COLORS
1	BD			BED	
3	C1			OFFICE TASK CHAIR	
4	C2			OFFICE DESK CHAIR	
5	C3			DINING CHAIR	
6	D1			DESK SYSTEM	
7	L1			RECLINER	
9	T2			NIGHT STAND	


NOTE: FFE SHOWN FOR COORDINATION ONLY. ALL FFE BY OTHERS.

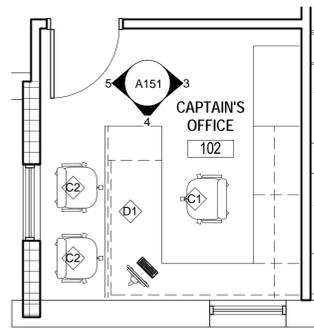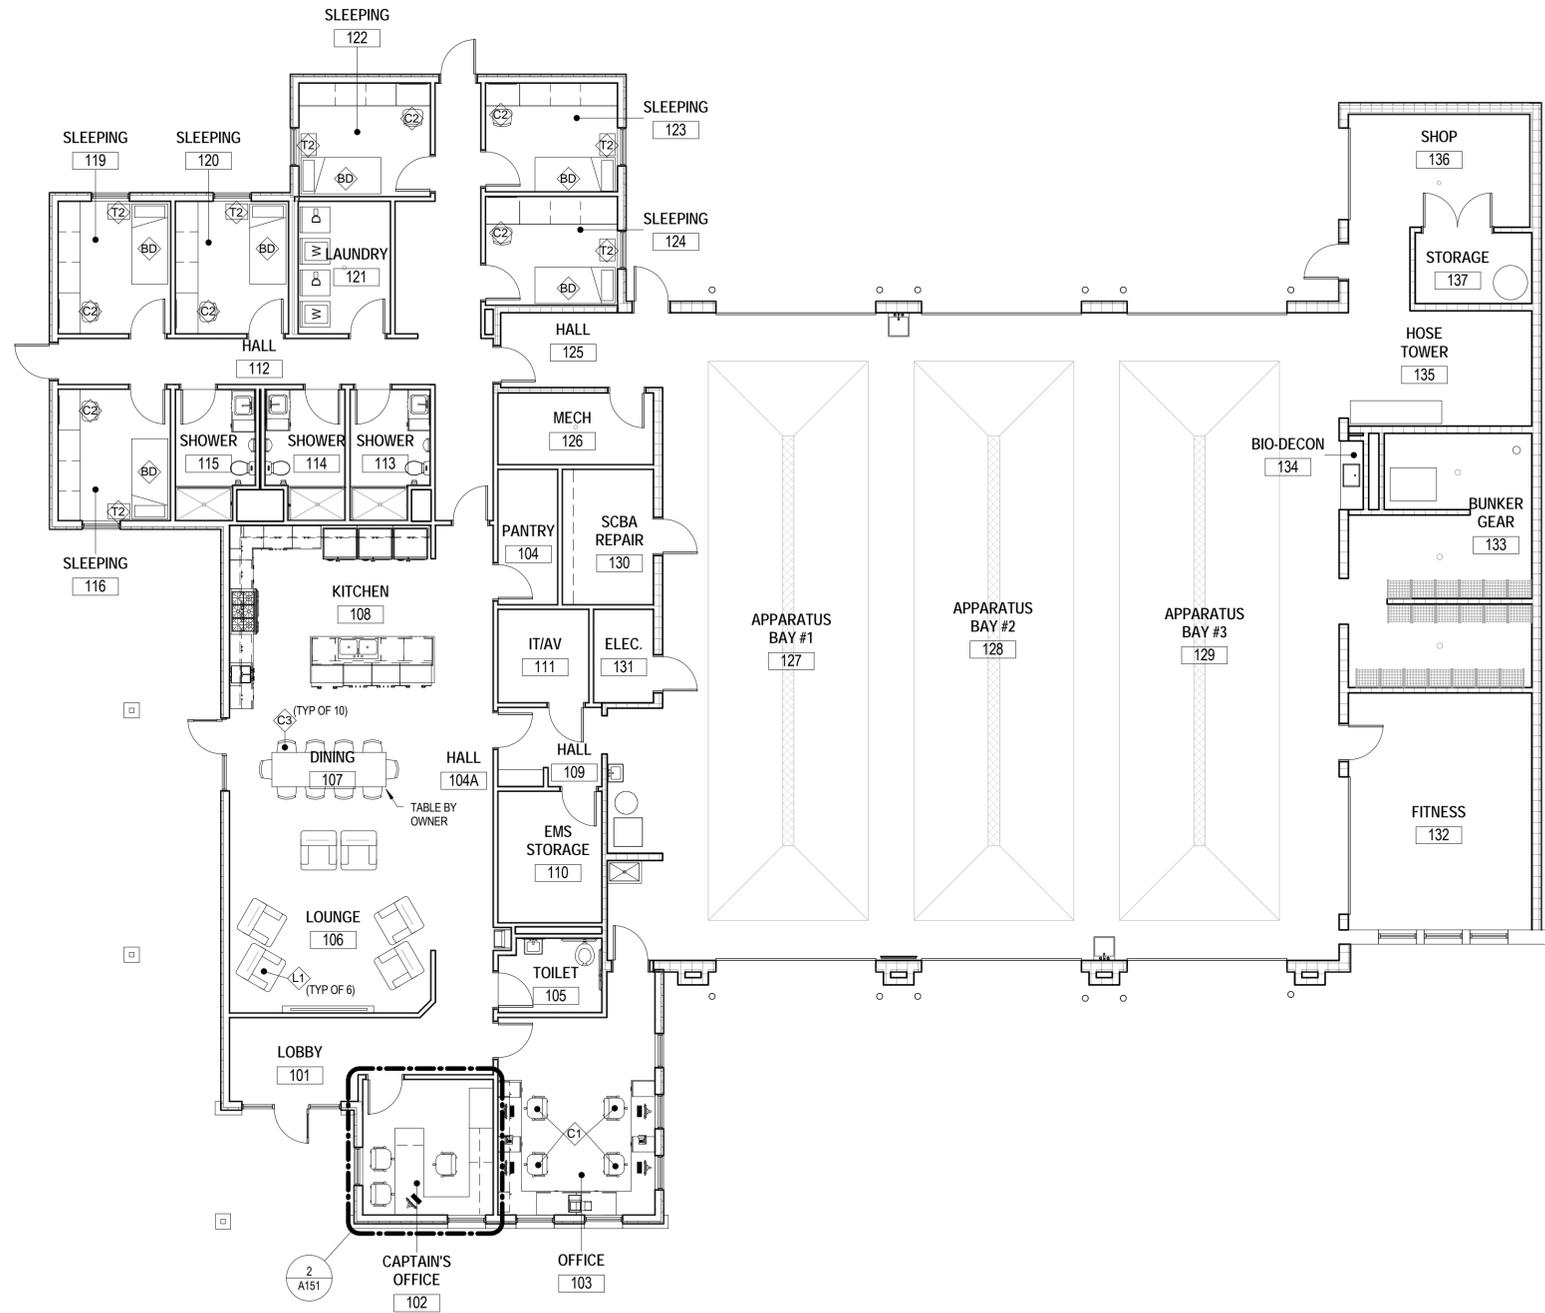


NOTE: LOCATE 2 GROMMETS IN THE FIELD WITH THE OWNER FOR WIRE MANAGEMENT. PROVIDE WIRE MANAGEMENT TRAYS UNDER THE WORKSURFACE FROM THE GROMMET TO THE ELECTRIC AND DATA WALL OUTLETS FOR WIRE MANAGEMENT.

2 ENLARGED DESK D1
A151


1 FURNITURE PLAN
A151

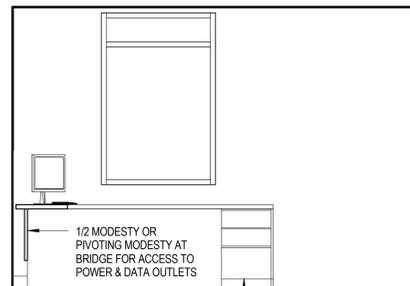

5 DESK D1 WEST ELEVATION
A151

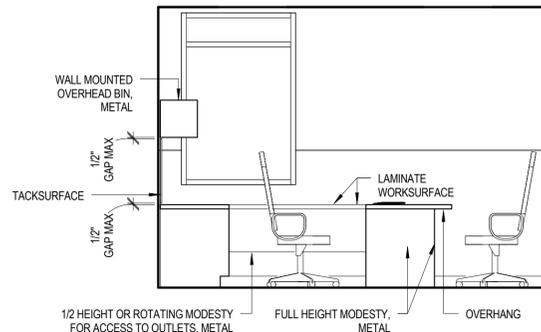

4 DESK D1 SOUTH ELEVATION
A151

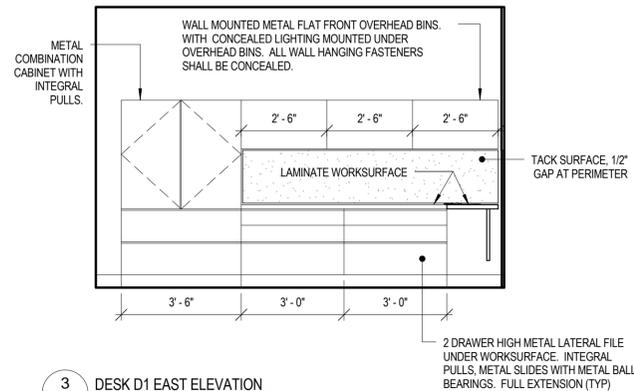

3 DESK D1 EAST ELEVATION
A151

FFE LEGEND

— NEW FURNITURE

◆◆ NEW FURNITURE TAG, RE: FURNITURE PRODUCT BINDER OR FURNITURE SCHEDULE FOR SPECIFICATIONS

Room
101 ROOM NAME
101 ROOM NUMBER

1
4 A101 2
3 INTERIOR WALL ELEVATION REFERENCE DRAWING

ORCHARD MESA FIRE STATION #4

GRAND JUNCTION, COLORADO

FURNITURE, FIXTURES, AND EQUIPMENT FOR REFERENCE ONLY

NO: ISSUED FOR: DATE:




PROJECT STATUS: 100% CDs

DRAWN BY: css CHECKED BY: Checker

DATE: 04/10/2015 SHEET NO:

PROJECT NO: 1443 **A151**

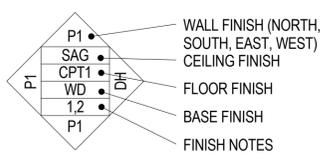

NOTES:
 COLORS, RE: INTERIOR COLOR SCHEDULE A741
 PATTERN AT WALLS, RE: INTERIOR ELEVATIONS A401-A406
 PATTERN AT CEILINGS, RE: REFLECTED CEILING PLAN A121
 FLOOR FINISH TRANSITIONS, RE: A701
 L - CORNER GUARD
 CJ - CONTROL JOINT

WALL FINISHES

P# - CMU OR GYPSUM WALLBOARD W/ PAINT
 CMU - SEALED CONCRETE MASONRY UNIT
 CT# - CERAMIC TILE

CEILING FINISH



SAG - SUSPENDED ACOUSTICAL PANEL CEILING.
 P# - GYPSUM WALLBOARD WITH PAINT.
 EXP - EXPOSED TO STRUCTURE.

FLOOR FINISHES

SPC - STAINED & POLISHED CONCRETE
 CONC - SEALED CONCRETE
 CT# - CERAMIC TILE.
 CPT - CARPET TILE.
 RUB - RUBBER, RESILIENT ATHLETIC FLOORING. FURNISHED AND INSTALLED BY OWNER.
BASE FINISHES
 CT# - CERAMIC TILE.
 RUB - RUBBER BASE.
 CMU - CONCRETE MASONRY UNIT.

FINISH NOTES

1. PROVIDE RUB BASE AT GWB.
2. PROVIDE 3/4" PLYWOOD ON INDICATED WALLS FOR MOUNTING EQUIPMENT, PNT P2.
3. PAINT GUARDRAIL AND HANDRAIL P4.
4. CONTINUE POLISHED CONCRETE UNDER CPT IN LIVING AREA (TYP).
5. PLACE CONTROL JOINTS IN CONC ALONG GRIDLINES, UNO.
6. PROVIDE EPOXY PAINT TO 8'-0" AFF.
7. RE: DETAIL 8/A402 FOR TYPICAL TILE WAINSCOT PATTERN.

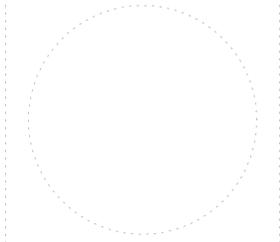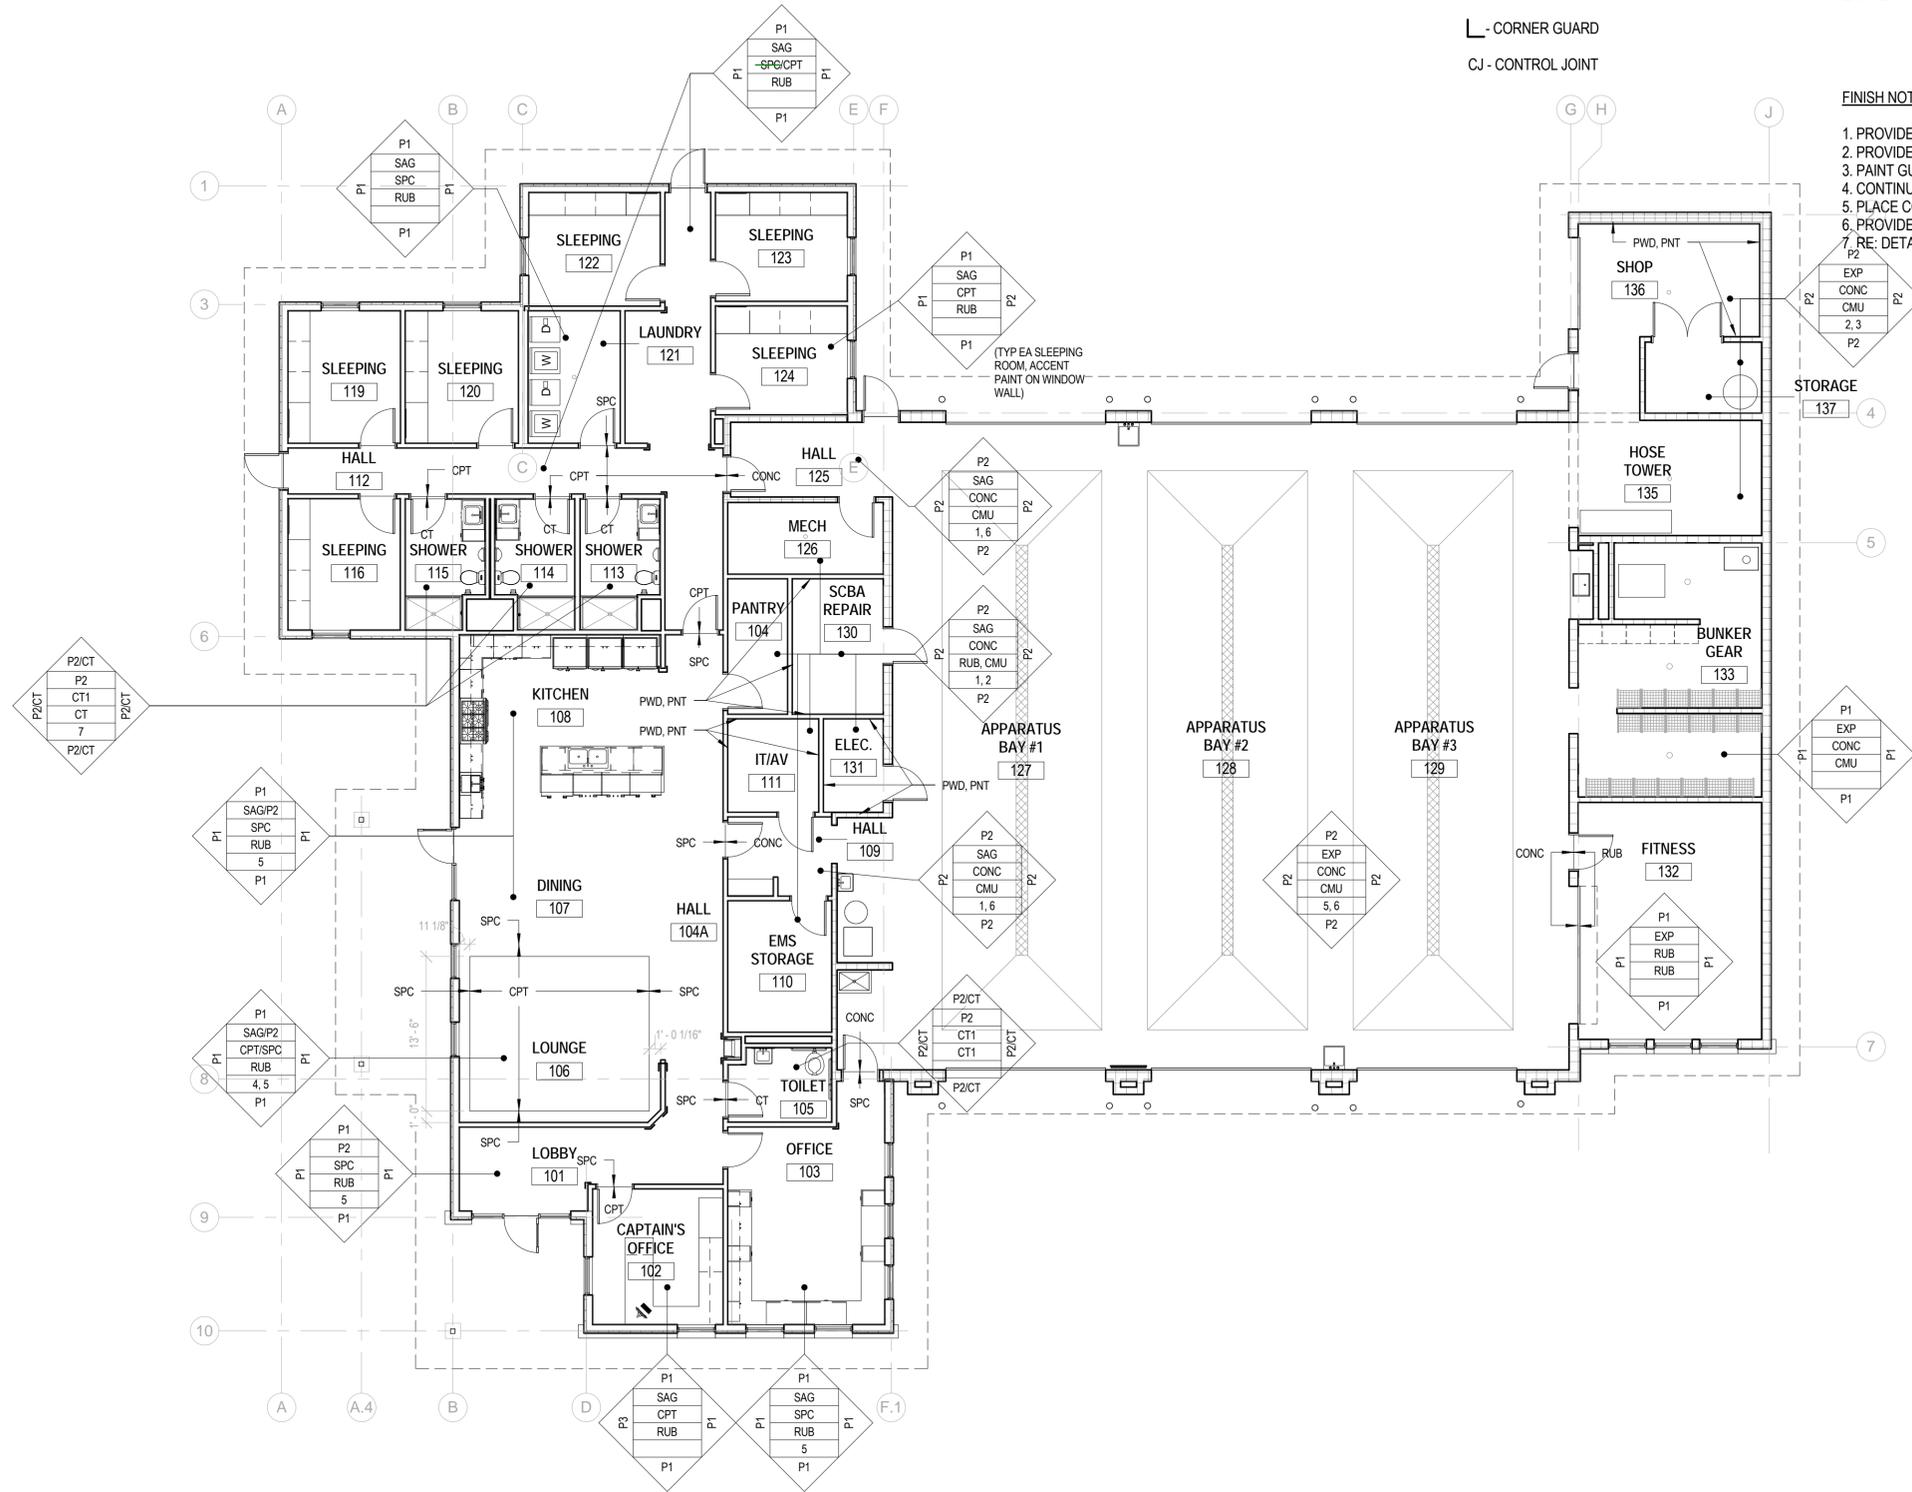

ORCHARD MESA FIRE STATION #4

GRAND JUNCTION, COLORADO

INTERIOR FINISH PLAN

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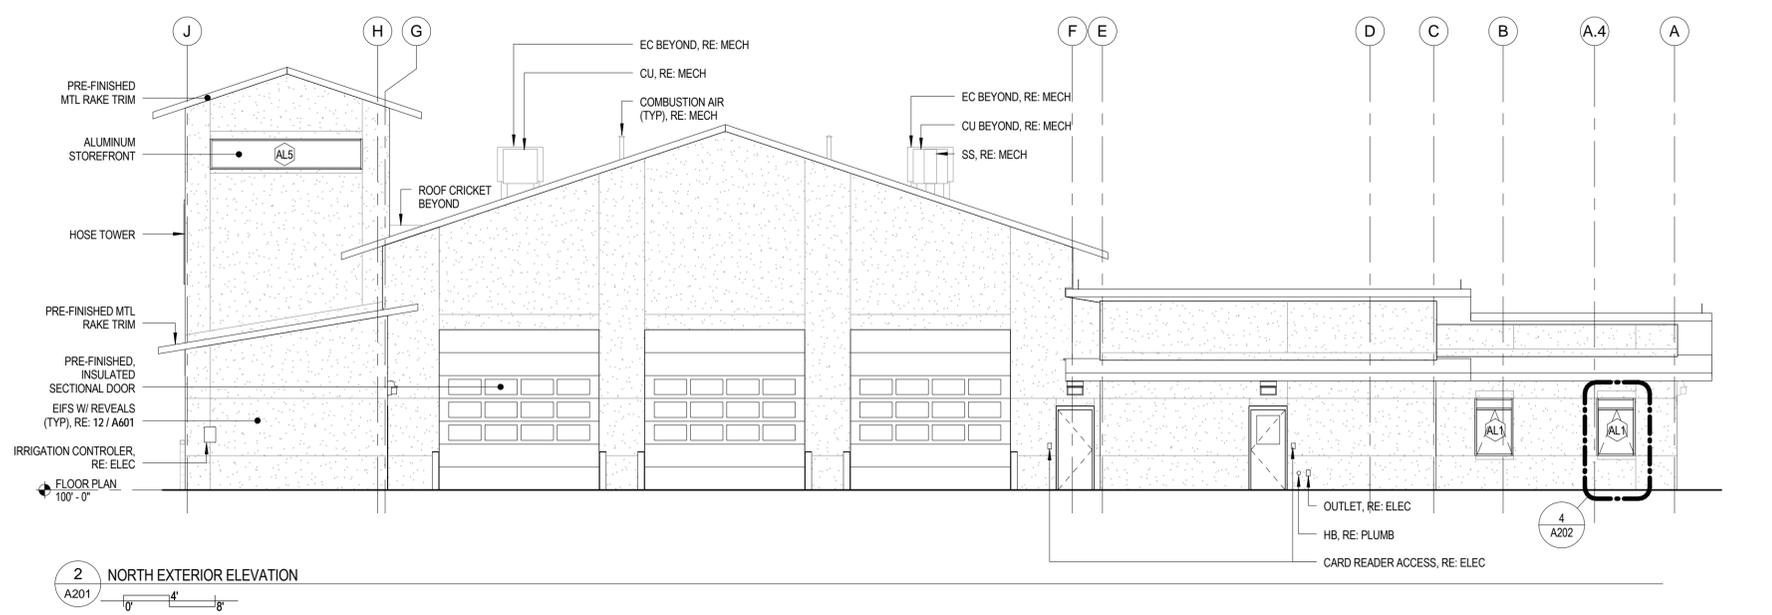
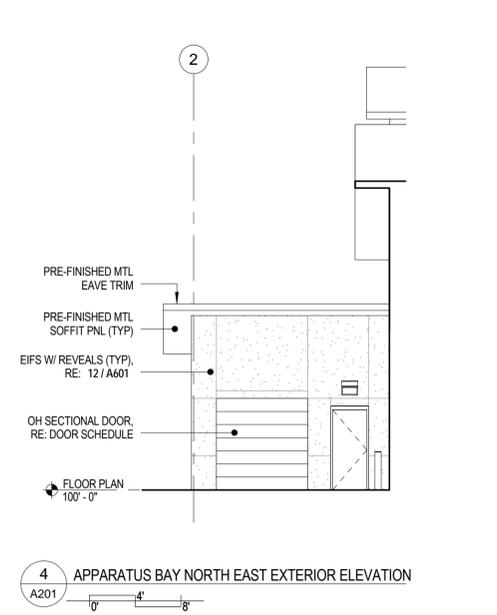
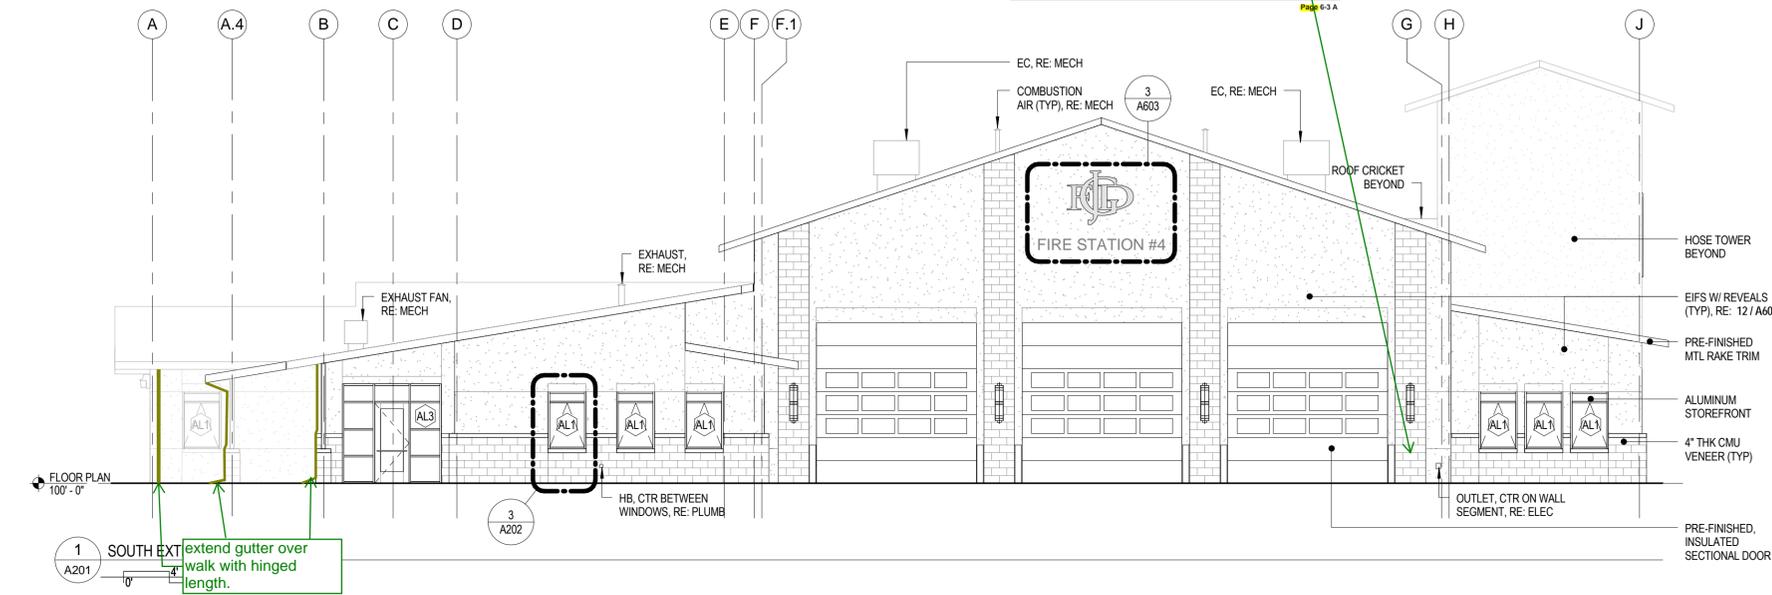
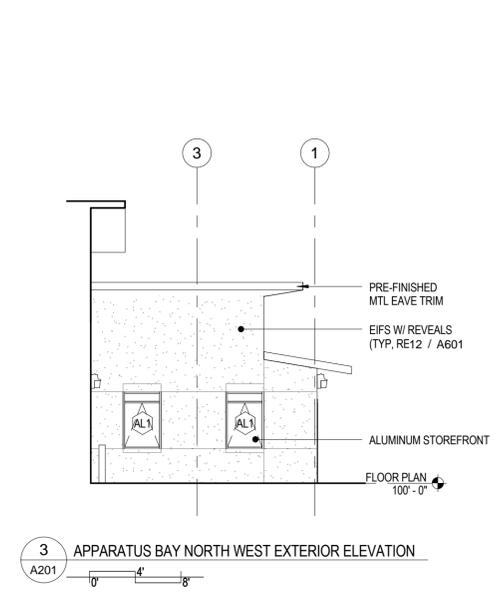
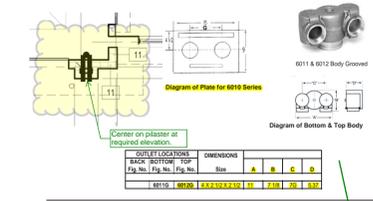
DATE: 04/10/2015 SHEET NO:

PROJECT NO: 1443 **A161**


1 FINISH PLAN
 A161

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Client	City of Grand Junction	Project Name	Orchard Mesa Fire Station #4
Architect	Chamberlin Architects	Project No.	1443
Contractor	City of Grand Junction	Issue No.	1
Engineer	City of Grand Junction	Issue Date	04/10/2015
Designer	City of Grand Junction	Issue Description	Issue 1: Final Elevation



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ORCHARD MESA
FIRE STATION #4

GRAND JUNCTION, COLORADO

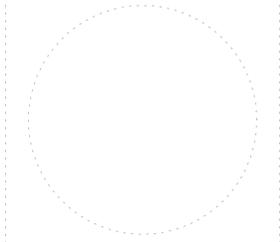EXTERIOR
ELEVATIONS

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PROJECT STATUS: 100% CDs
DRAWN BY: Aaron CHECKED BY: Checker
DATE: 04/10/2015 SHEET NO:
PROJECT NO: 1443

A201

ORCHARD MESA
FIRE STATION #4

GRAND JUNCTION, COLORADO

EXTERIOR
ELEVATIONS

NO: ISSUED FOR: DATE:





PROJECT STATUS: 100% CDs

DRAWN BY: JW CHECKED BY: Checker





DATE: 04/10/2015 SHEET NO:

PROJECT NO: 1443 **A202**

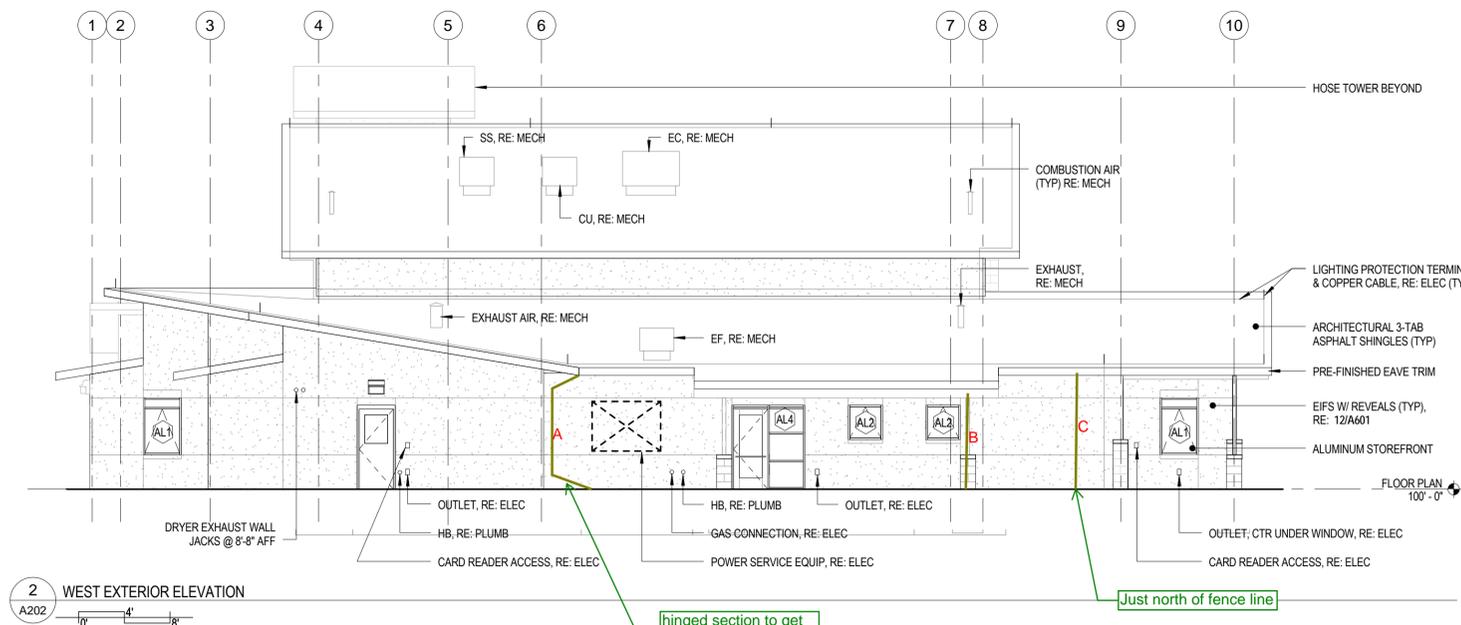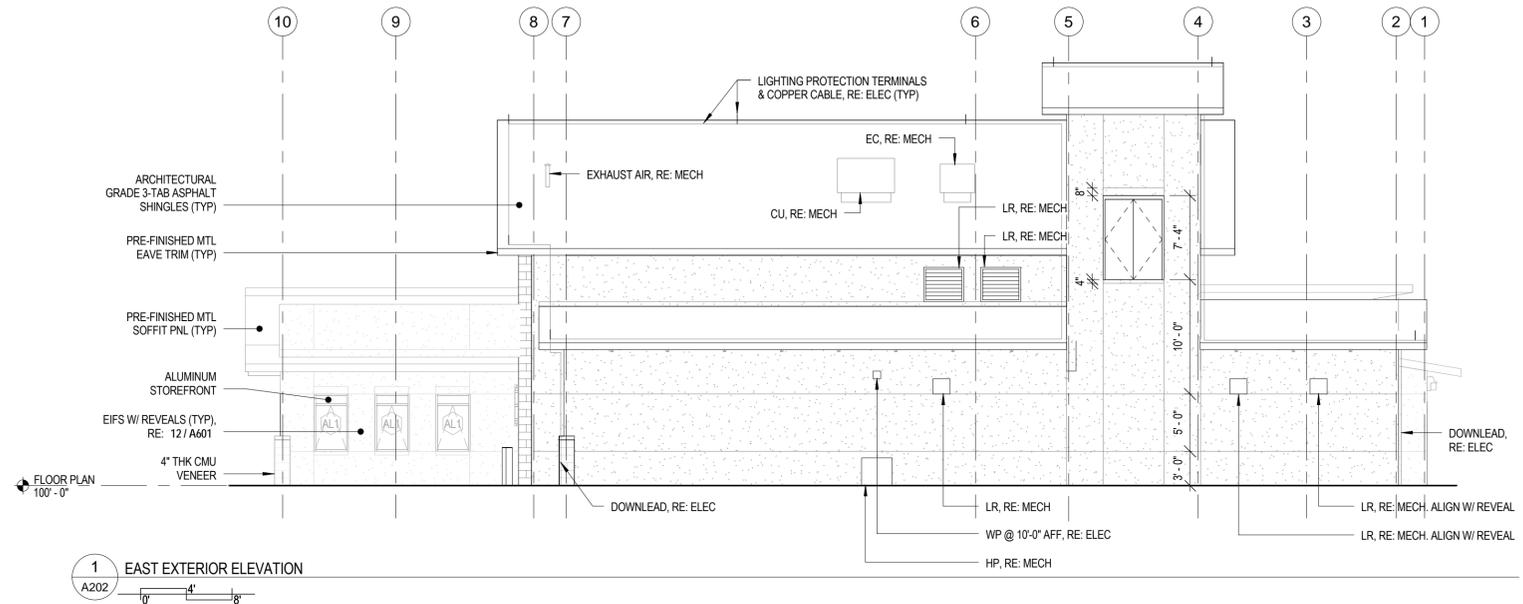

hinged section to get drainage over walks
Typical at all locations


Just north of fence line

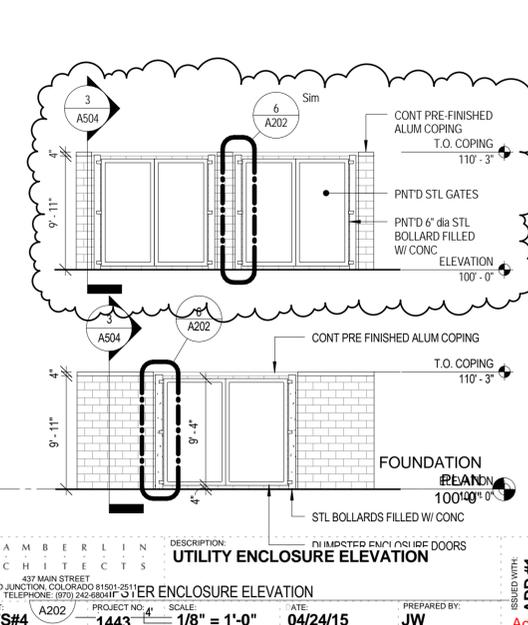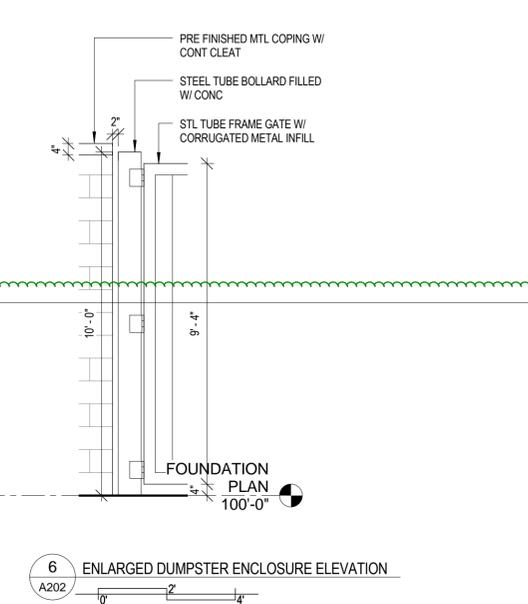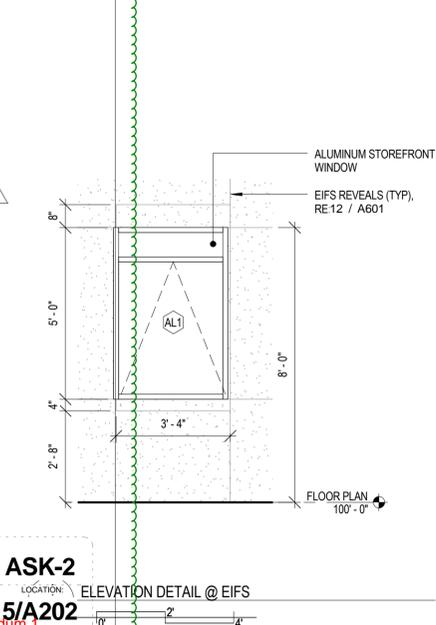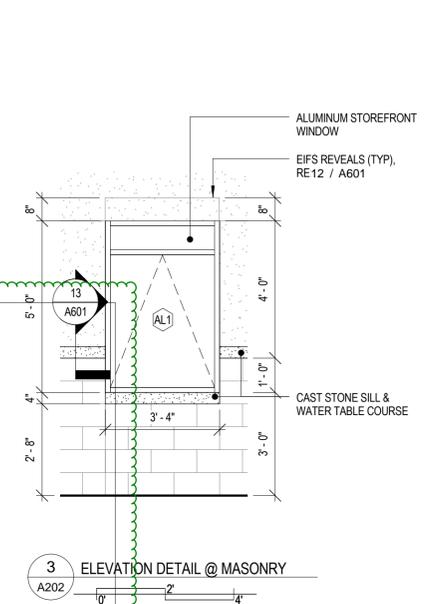


CHAMBERLIN ARCHITECTS
437 MAIN STREET
GRAND JUNCTION, COLORADO 81501-2511
TELEPHONE: (970) 242-6804
PROJECT: OMF#4 A202 PROJECT NO: 1443 SCALE: 1/8" = 1'-0" DATE: 04/24/15 PREPARED BY: JW
DESCRIPTION: DUMPSTER ENCLOSURE DOORS
UTILITY ENCLOSURE ELEVATION
ISSUED WITH: ADD #1 ASK-2 LOCATION: 5/A202 Addendum 1

4/10/2015 11:08:59 AM
CURRENT PROJECTS \1443-CENTRAL-PLAN.rvt


Subject	Discipline	Category	
Door 135 Installation	Architectural	Owner Request and/or Owner Furnishing	
Cc: Company Name Contact Name Copies Notes			
FCl Constructors, Inc. - GJ	Craig Reid	1	
FCl Constructors, Inc. - GJ	Stan Kiser	1	
City of Grand Junction	Lee Cooper	1	
Question			Date Required: 9/1/2015
Per OAC discussions Door 135 is to be installed to swing into the stairwell. It is to be centered on the wall it is installed in and the frame should be installed so the doors can swing 180 degrees. Are any hardware changes required at this opening?			
Suggestion			Date Answered: 8/27/2015
No hardware changes necessary.			
8/27/15 - JMW			

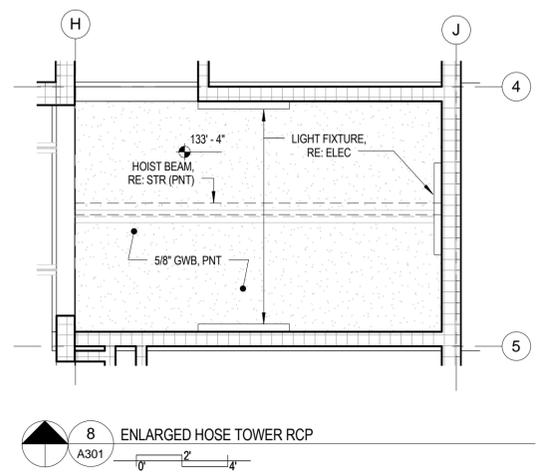


8 ENLARGED HOSE TOWER RCP
A301

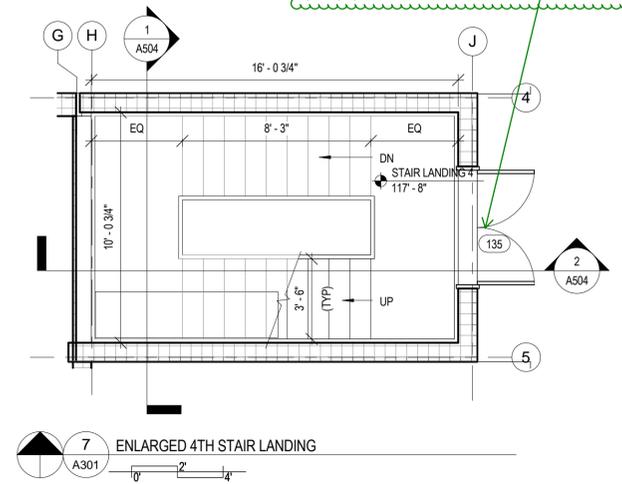


7 ENLARGED 4TH STAIR LANDING
A301

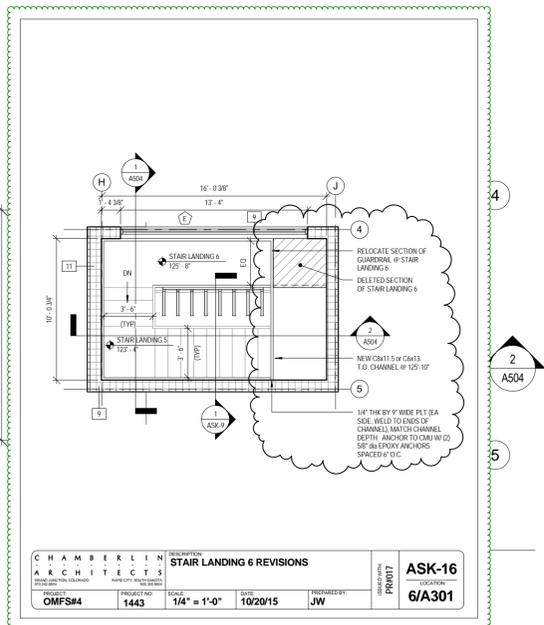


STAIR LANDING 6 REVISIONS
ASK-16
A301

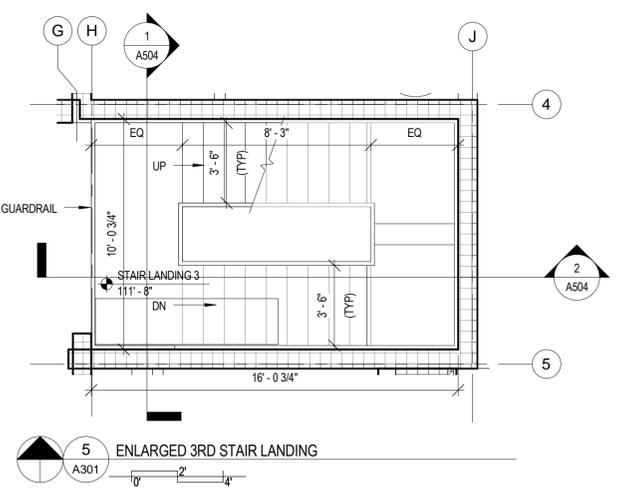


5 ENLARGED 3RD STAIR LANDING
A301

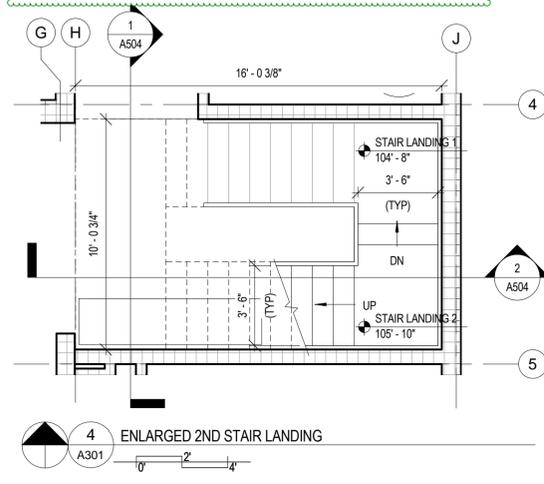


4 ENLARGED 2ND STAIR LANDING
A301

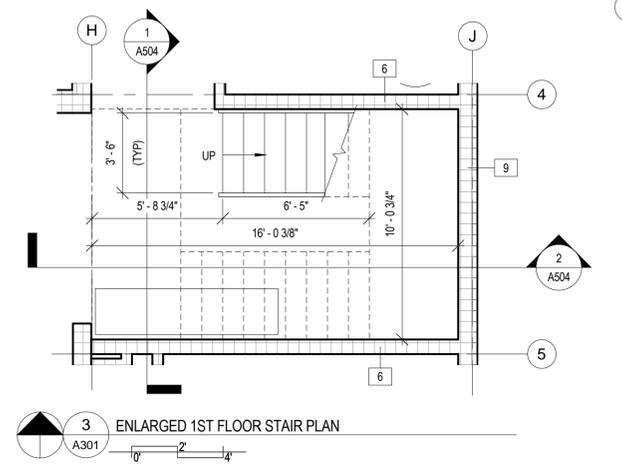


3 ENLARGED 1ST FLOOR STAIR PLAN
A301

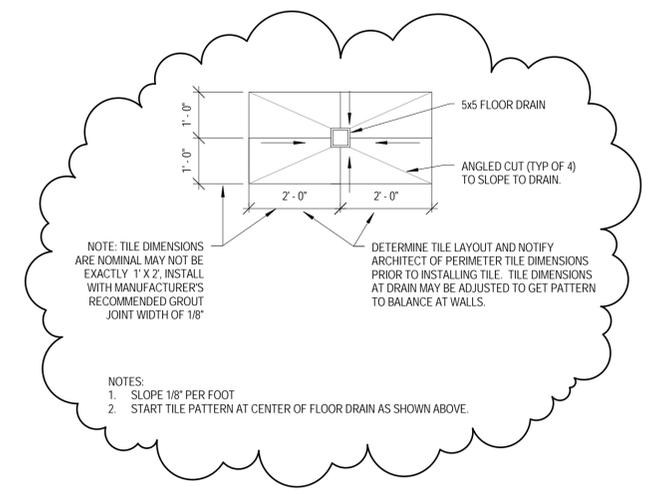

CHAMBERLIN ARCHITECTS		DESCRIPTION: REVISED FLOOR DRAIN SKETCH		PROJECT NO: 1443		SCALE: 1/2" = 1'-0"		DATE: 8/4/15		PREPARED BY: CSS		ISSUED WITH: ASH#005		9 LOCATION: A301	
PROJECT: OMFS#4		PROJECT NO: 1443		SCALE: 1/2" = 1'-0"		DATE: 8/4/15		PREPARED BY: CSS		ISSUED WITH: ASH#005		9 LOCATION: A301			

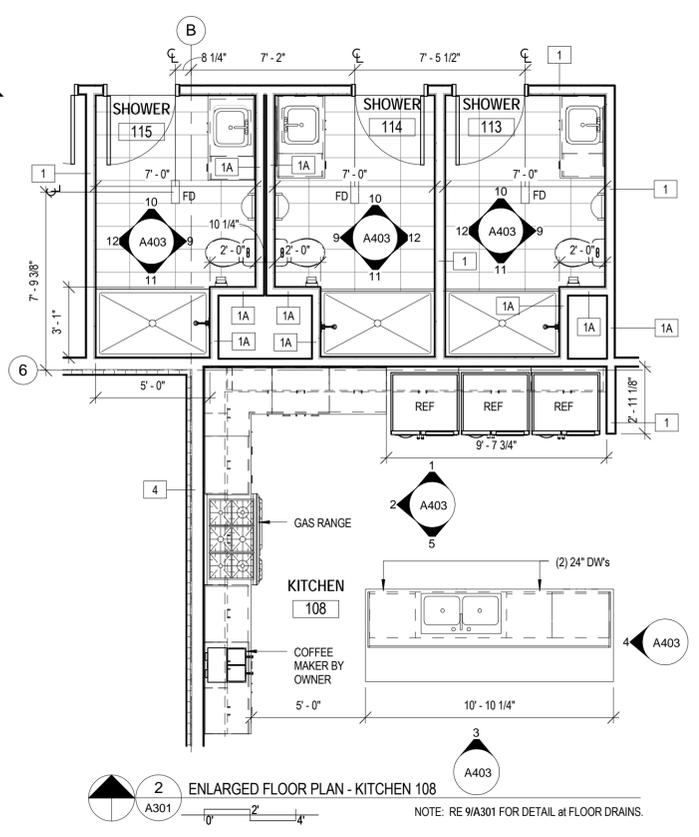

2 ENLARGED FLOOR PLAN - KITCHEN 108
A301

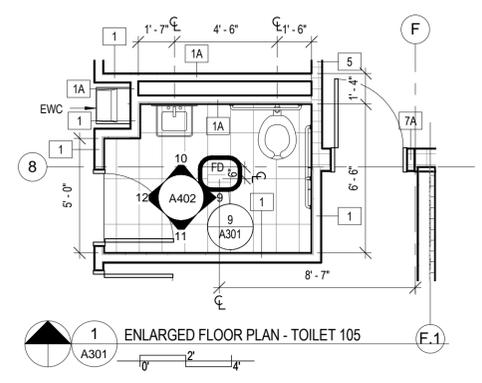

1 ENLARGED FLOOR PLAN - TOILET 105
A301

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ORCHARD MESA FIRE STATION #4

GRAND JUNCTION, COLORADO

ENLARGED FLOOR PLANS

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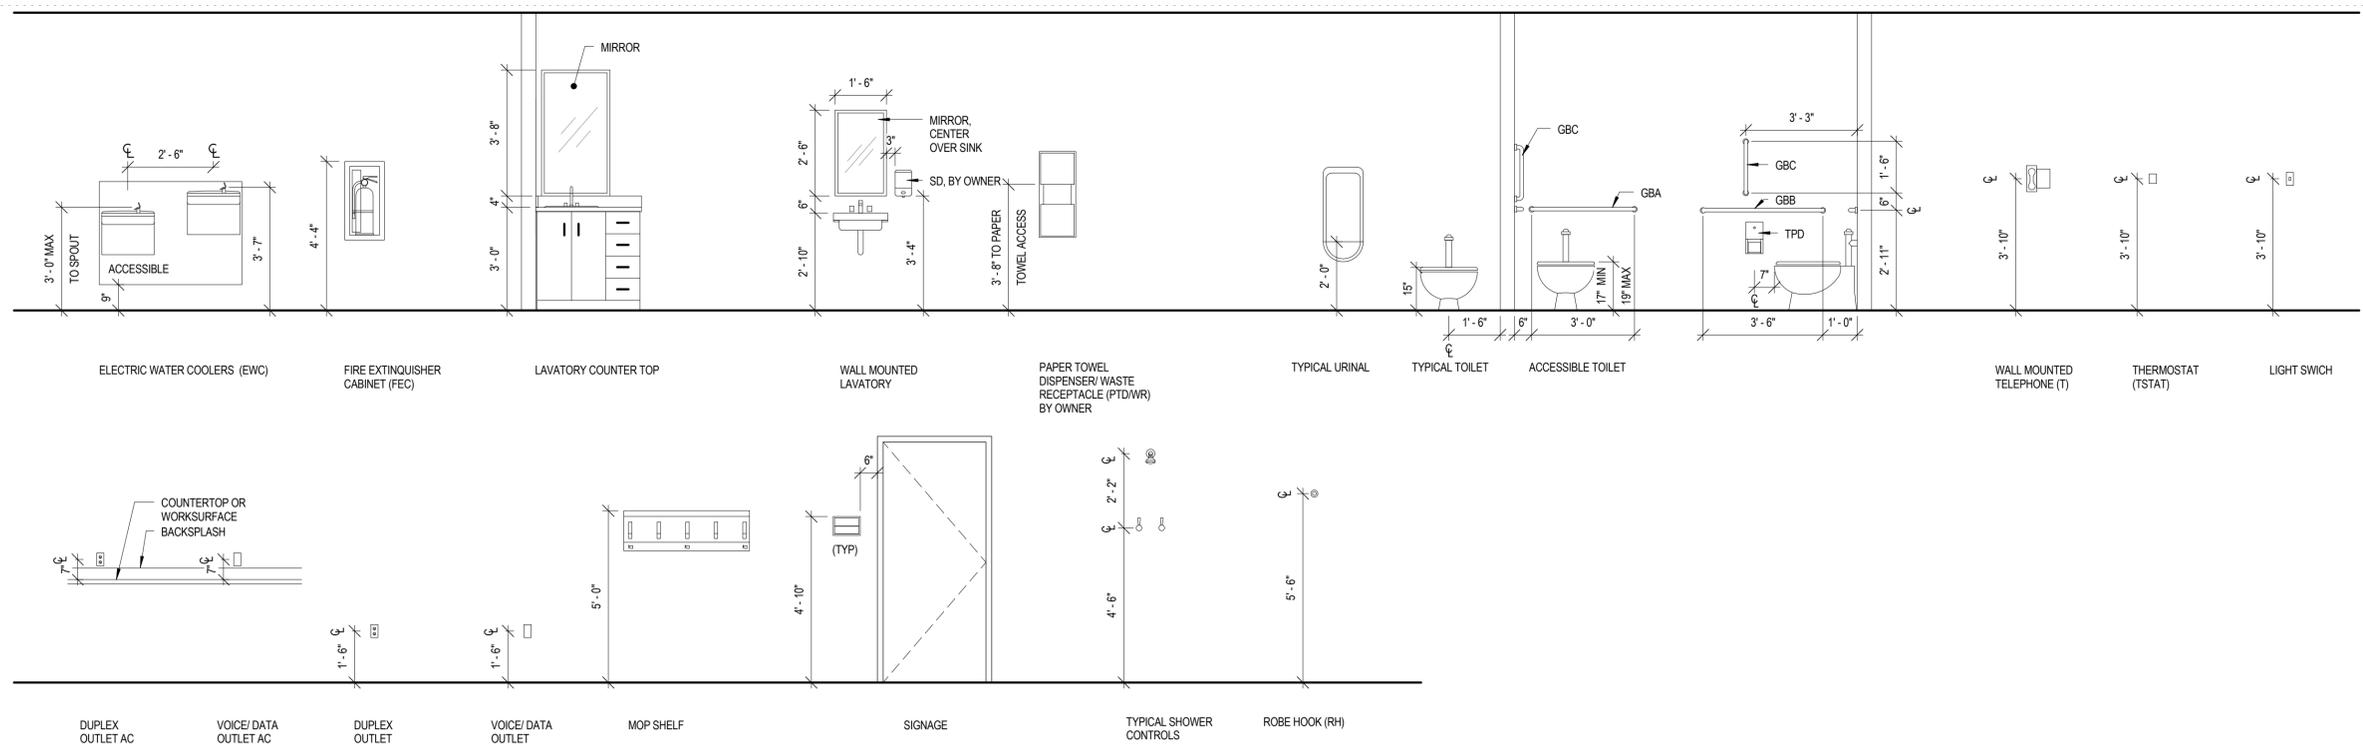
PROJECT STATUS: 100% CDs

DRAWN BY: JW CHECKED BY: Checker

DATE: 04/10/2015 SHEET NO:

PROJECT NO: 1443 **A301**







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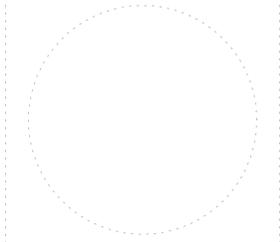
1 TYPICAL ELEVATION HEIGHTS

A401 0' 2' 4'

NOTE: PROVIDE TREATED WD BLOCKING AT ALL WALL MOUNTED ACCESSORIES



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ORCHARD MESA FIRE STATION #4

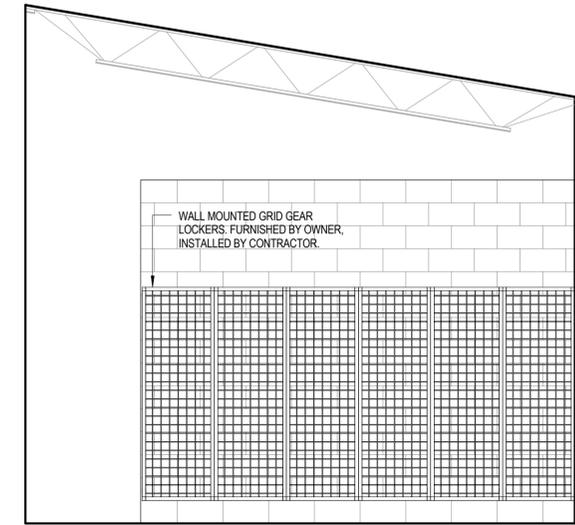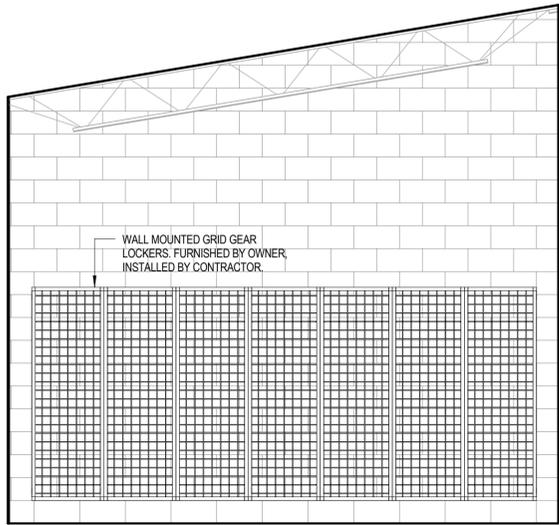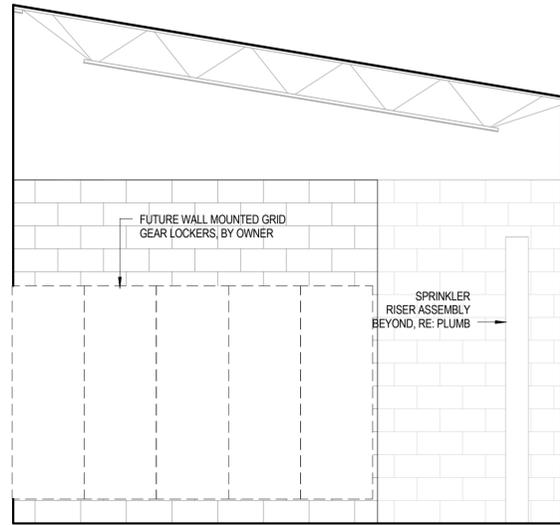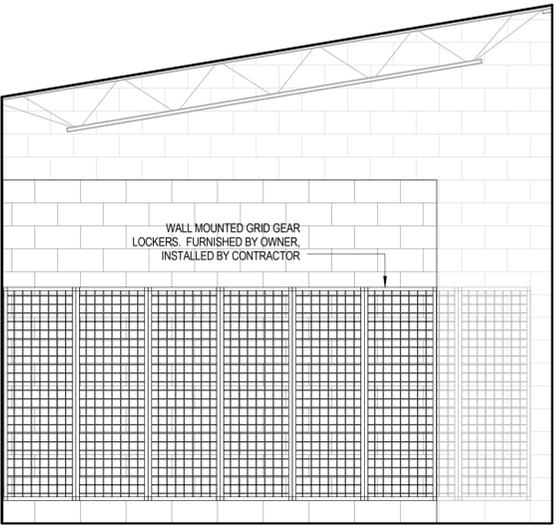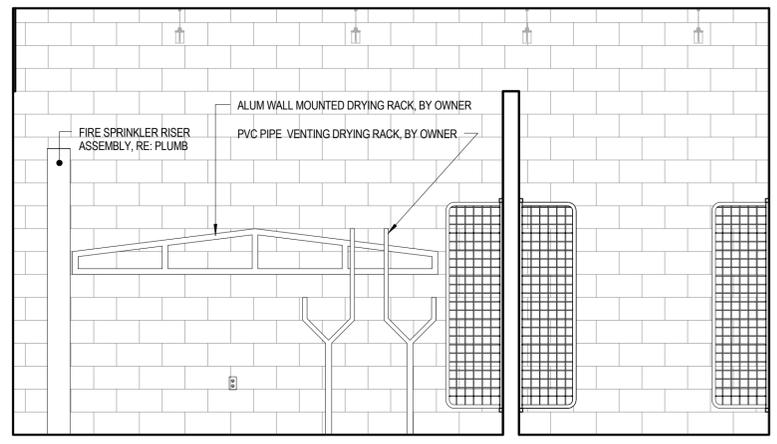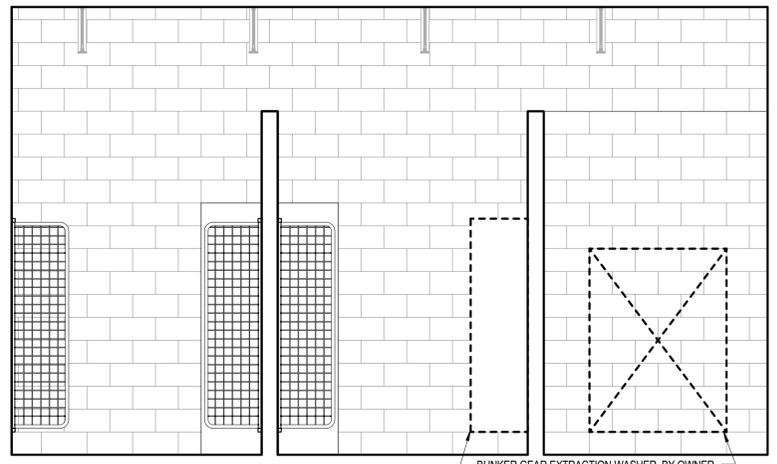GRAND JUNCTION, COLORADO

INTERIOR ELEVATIONS

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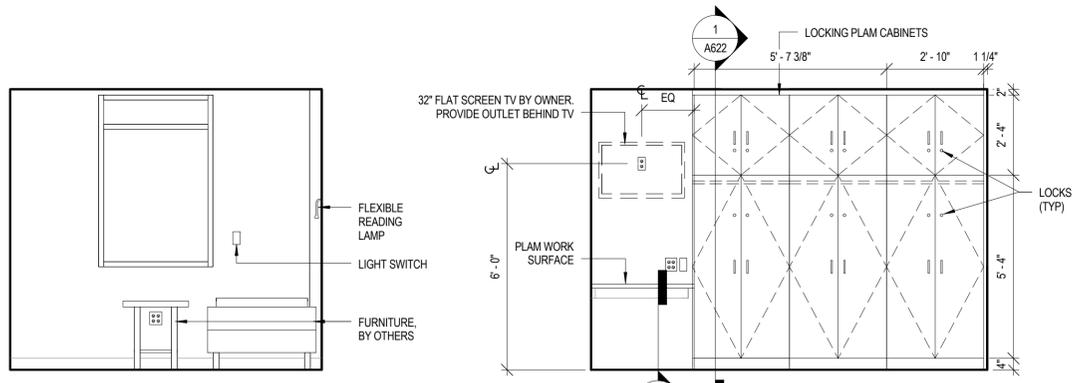
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PROJECT NO: 1443 **A401**

CURRENT PROJECTS 1443-CENTRAL-Parade.rvt


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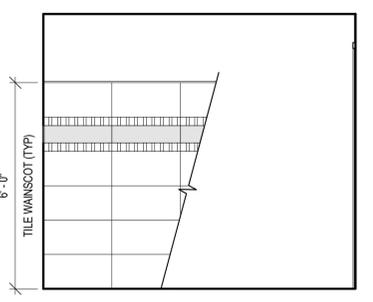


14 TYPICAL SLEEPING UNIT WINDOW ELEVATION
A402


13 TYPICAL SLEEPING CASEWORK
A402




12 TOILET 105 WEST
A402

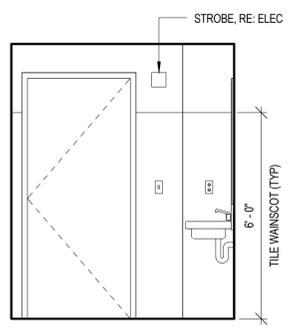


11 TOILET 105 SOUTH
A402

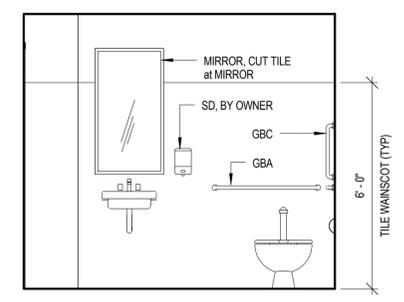


10 TOILET 105 NORTH
A402

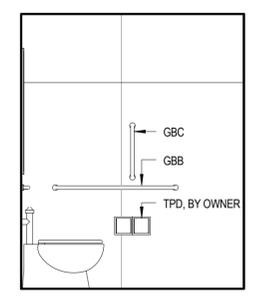


9 TOILET 105 EAST
A402

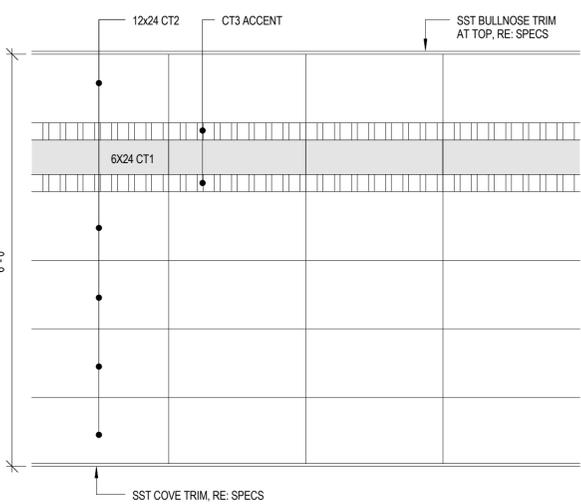


8 TYPICAL TILE WAINSCOT PATTERN
A402

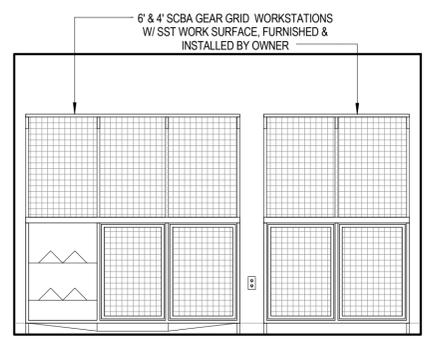


7 SCBA REPAIR 130 WEST
A402

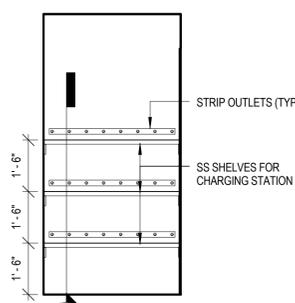


6 HALL 109 SOUTH
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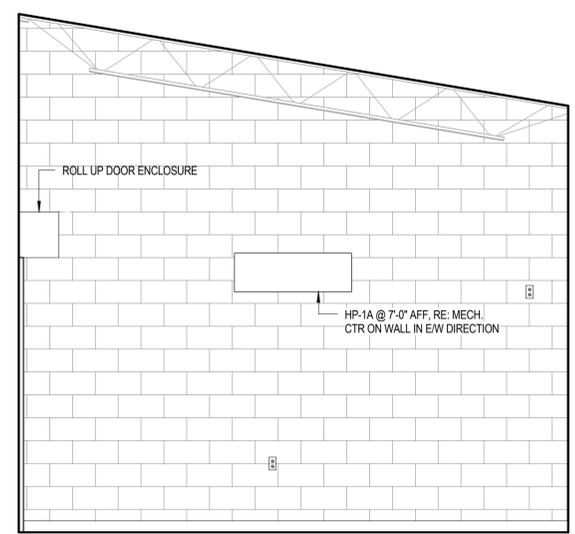
5 LAUNDRY 121 WEST
A402

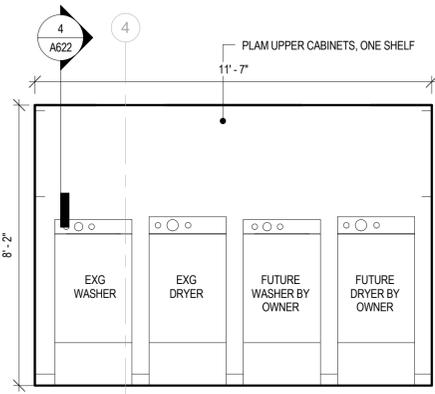


4 FITNESS 132 WEST
A402

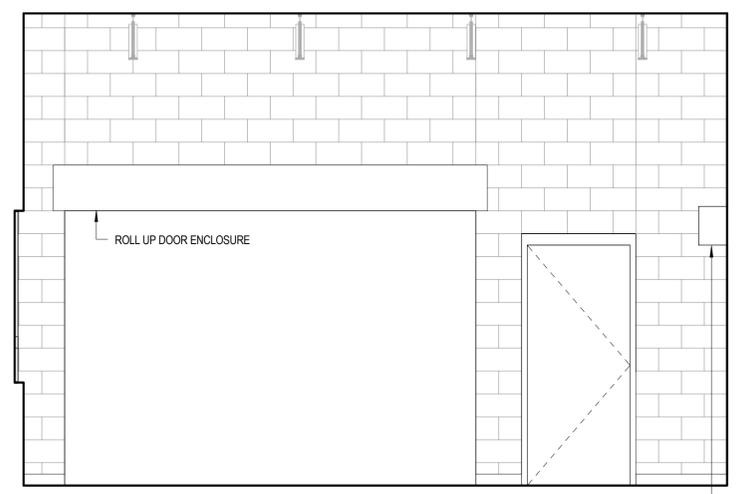


3 FITNESS 132 SOUTH
A402

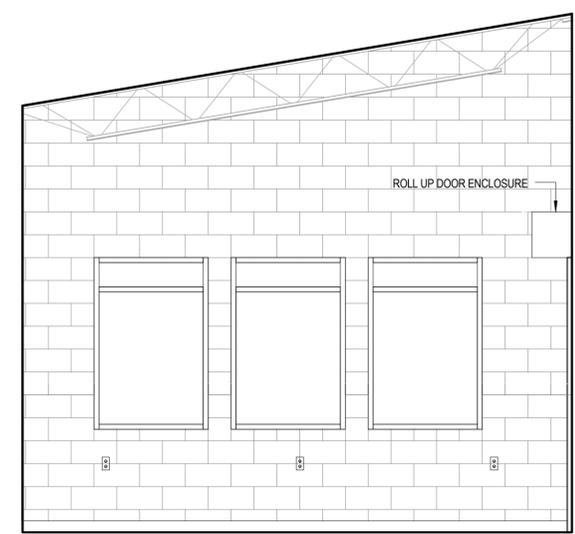

2 FITNESS 132 NORTH
A402

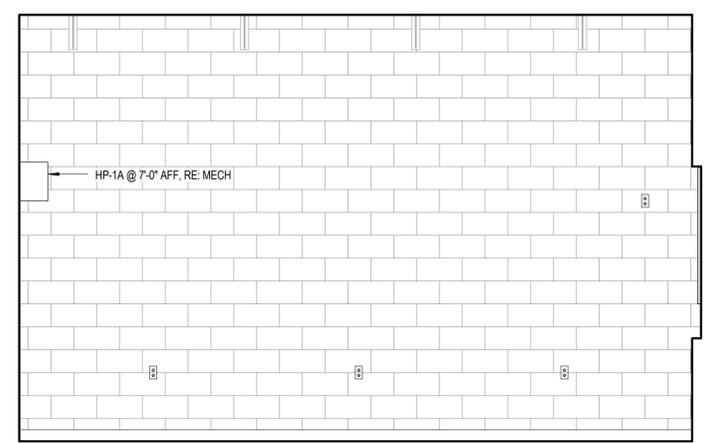

1 FITNESS 132 EAST
A402

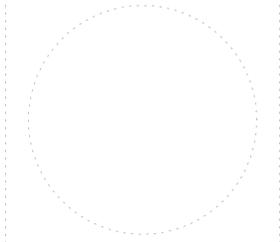

ORCHARD MESA FIRE STATION #4

GRAND JUNCTION, COLORADO

INTERIOR ELEVATIONS

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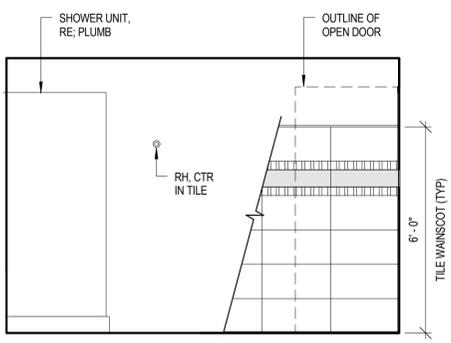
PROJECT NO: 1443 **A402**

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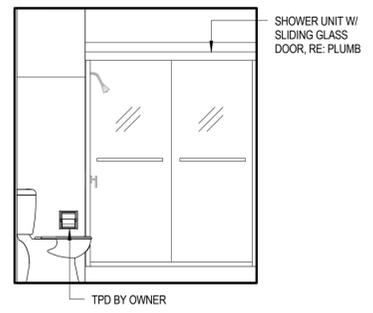
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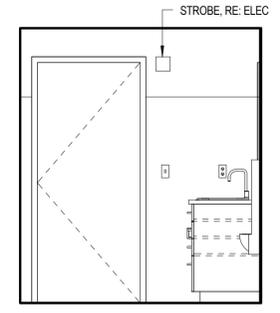
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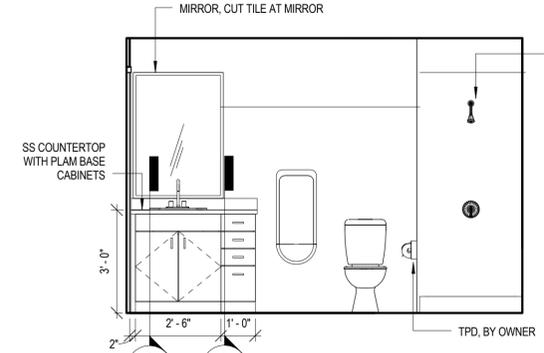
12 SHOWER 113 & 115 WEST, 114 EAST OPH
A403




11 SHOWER 113 & 115 SOUTH, 114 SOUTH OPH
A403




10 SHOWER 113 & 115 NORTH, 114 NORTH OPH
A403




9 SHOWER 113 & 115 EAST, 114 WEST OPH
A403

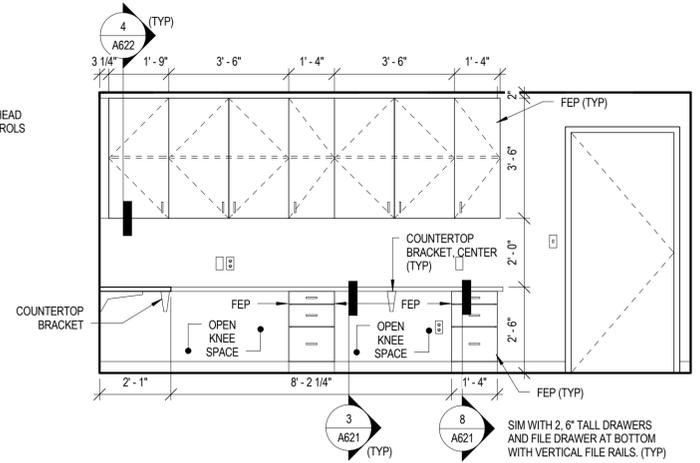


8 OFFICE 103 WEST
A403

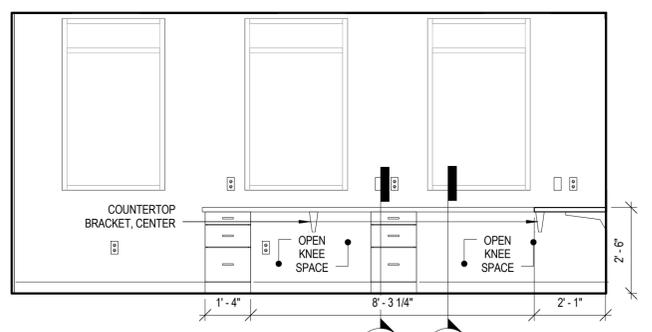


7 OFFICE 103 EAST
A403

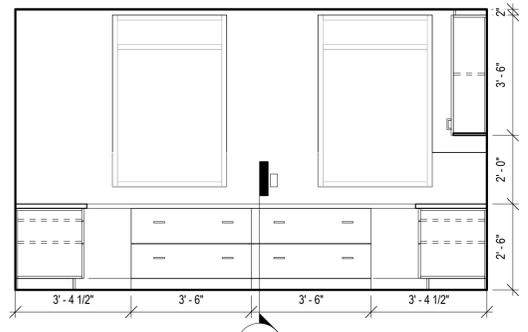


6 OFFICE 103 SOUTH
A403

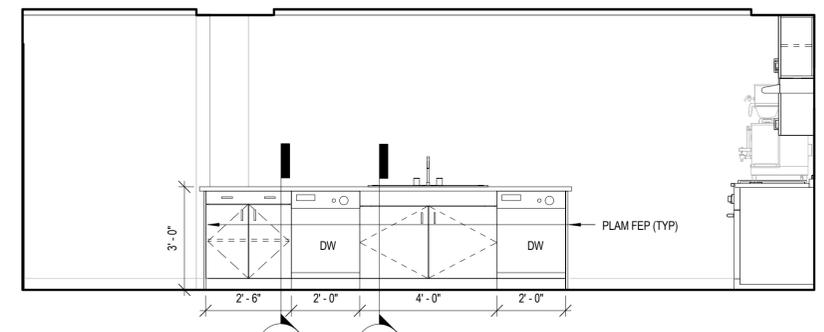


5 KITCHEN ISLAND SOUTH
A403

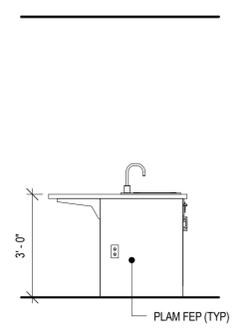

4 KITCHEN ISLAND WEST, EAST SIM OPH
A403

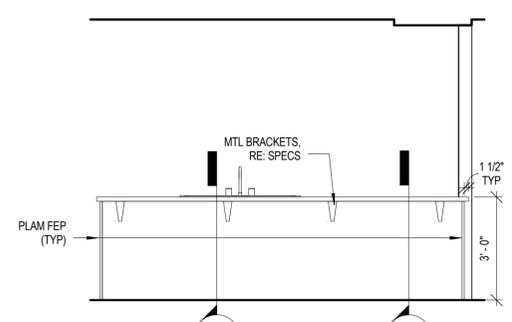


3 KITCHEN ISLAND NORTH
A403

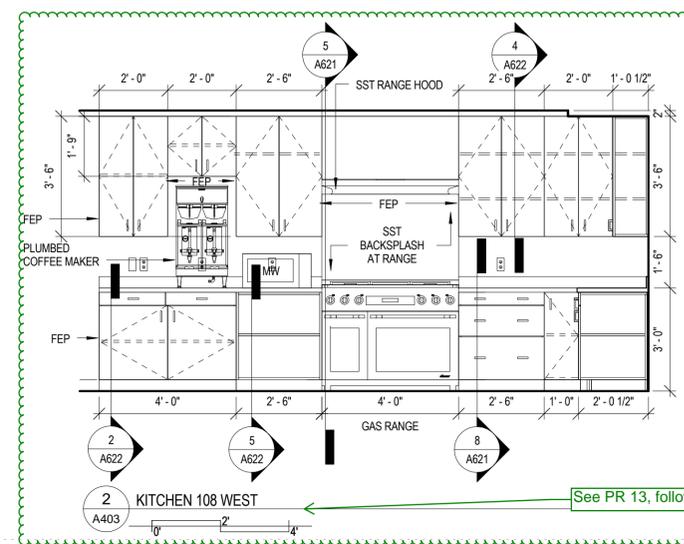

2 KITCHEN 108 WEST
A403

See PR 13, following page

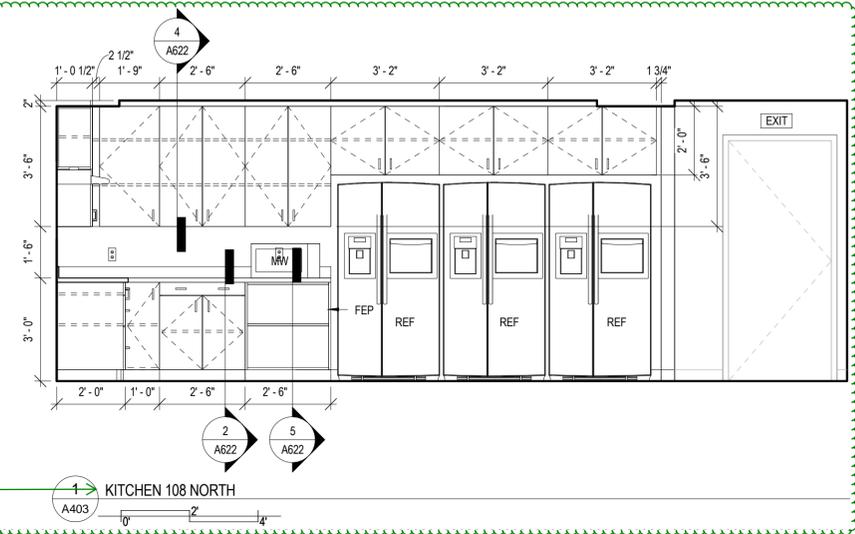

1 KITCHEN 108 NORTH
A403

ORCHARD MESA FIRE STATION #4

GRAND JUNCTION, COLORADO

INTERIOR ELEVATIONS

NO: ISSUED FOR: DATE:

PROJECT STATUS: 100% CDs


DRAWN BY: Author CHECKED BY: Checker

DATE: 04/10/2015 SHEET NO:


PROJECT NO: 1443 **A403**

CURRENT PROJECTS 1443-CENTRAL-Parade.rvt


©2015 CHAMBERLIN ARCHITECTS

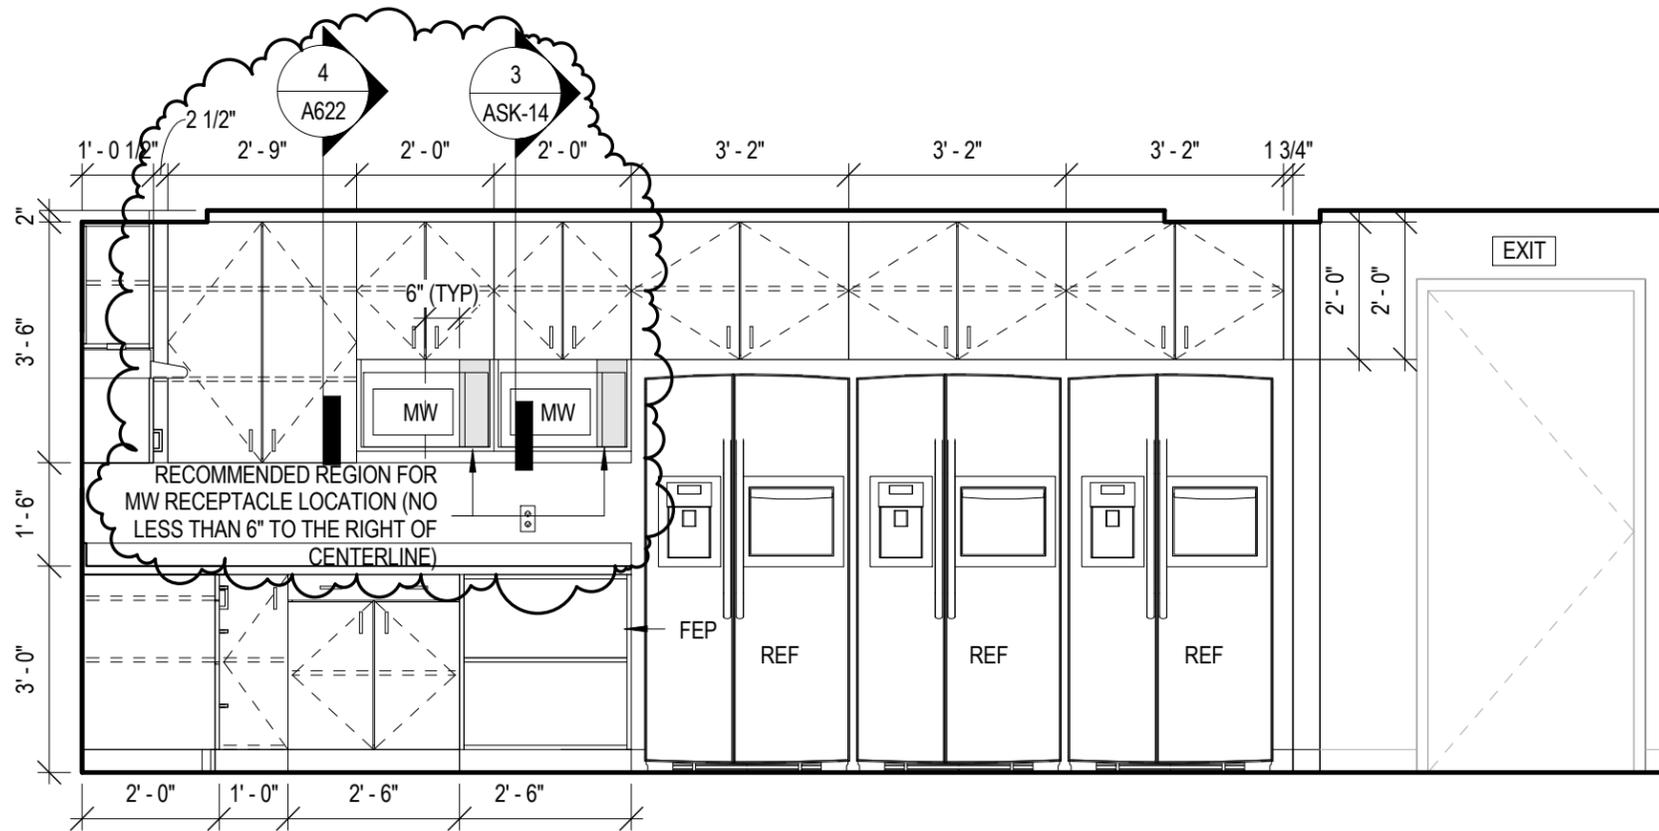

1 ASK 14 KITCHEN 108 NORTH

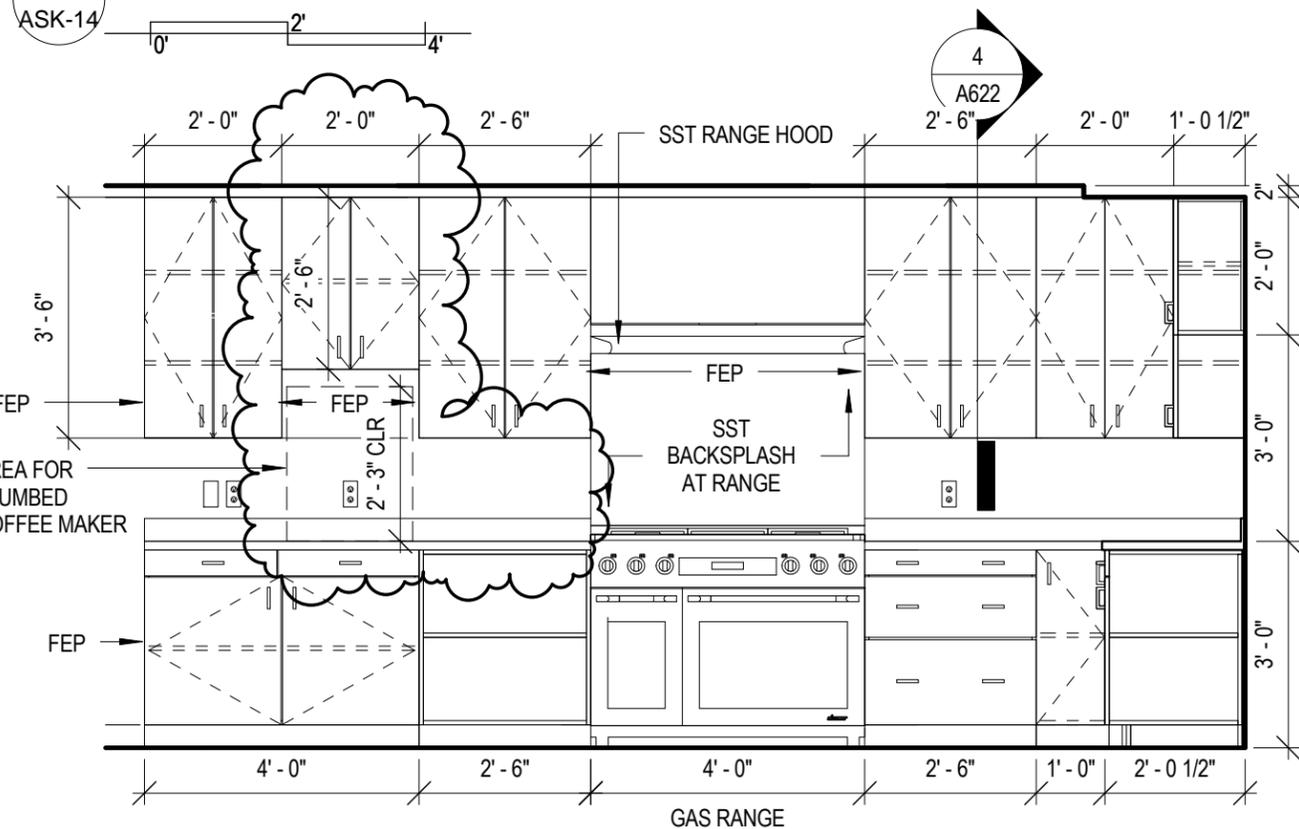


2 ASK 14 KITCHEN 108 WEST

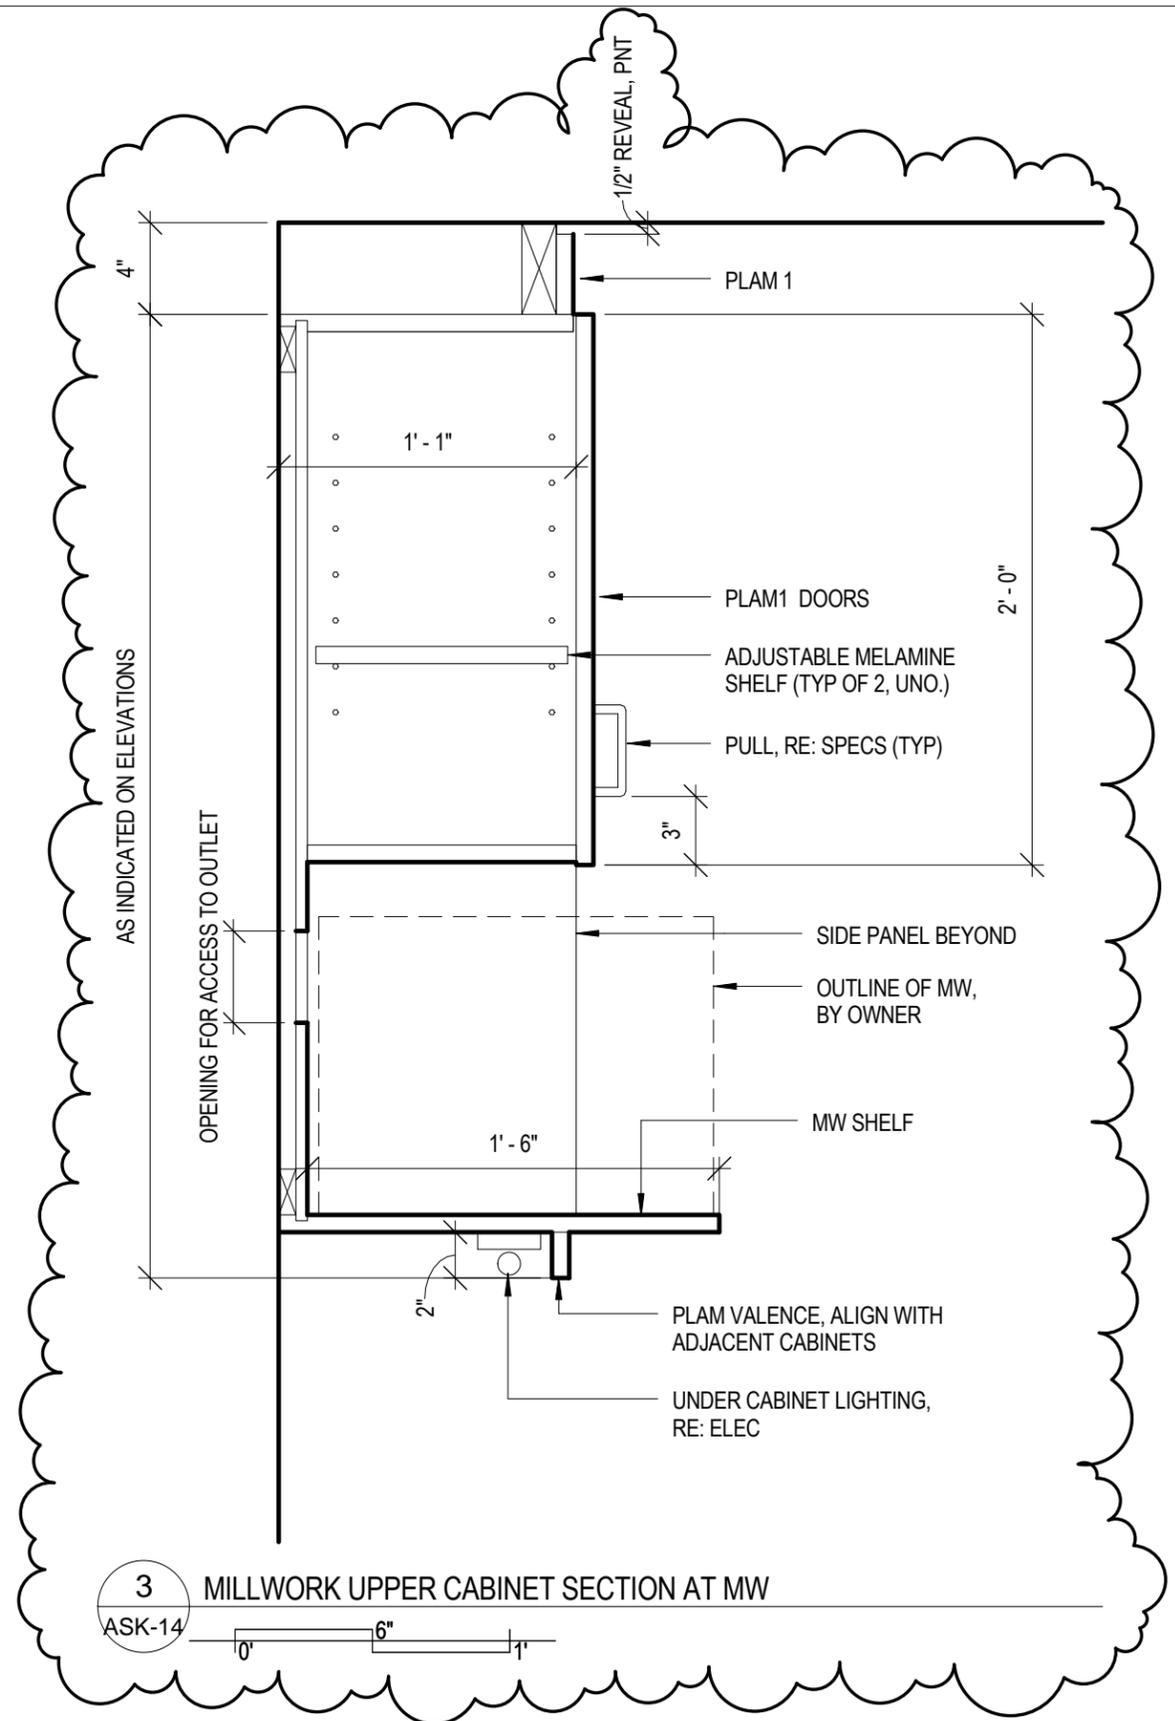

3 MILLWORK UPPER CABINET SECTION AT MW

C H A M B E R L I N A R C H I T E C T S <small>GRAND JUNCTION, COLORADO 970.242.6804</small>		<small>RAPID CITY, SOUTH DAKOTA 605.355.6804</small>		DESCRIPTION: PR #13 TO RELOCATE MICROWAVES AND ADJUST UPPER CABINET AT COFFEE MAKER		ISSUED WITH: PR#0013	1&2 <small>LOCATION:</small> A403
PROJECT: OMFS#4	PROJECT NO: 1443	SCALE: As indicated	DATE: 9/15/15	PREPARED BY: CSS			

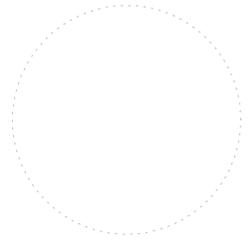

ORCHARD MESA
FIRE STATION #4

GRAND JUNCTION, COLORADO

INTERIOR
ELEVATIONS

NO: ISSUED FOR: DATE:




PROJECT STATUS: 100% CDs


DRAWN BY: Author CHECKED BY: Checker

DATE:
04/10/2015 SHEET NO:

PROJECT NO:
1443 **A404**

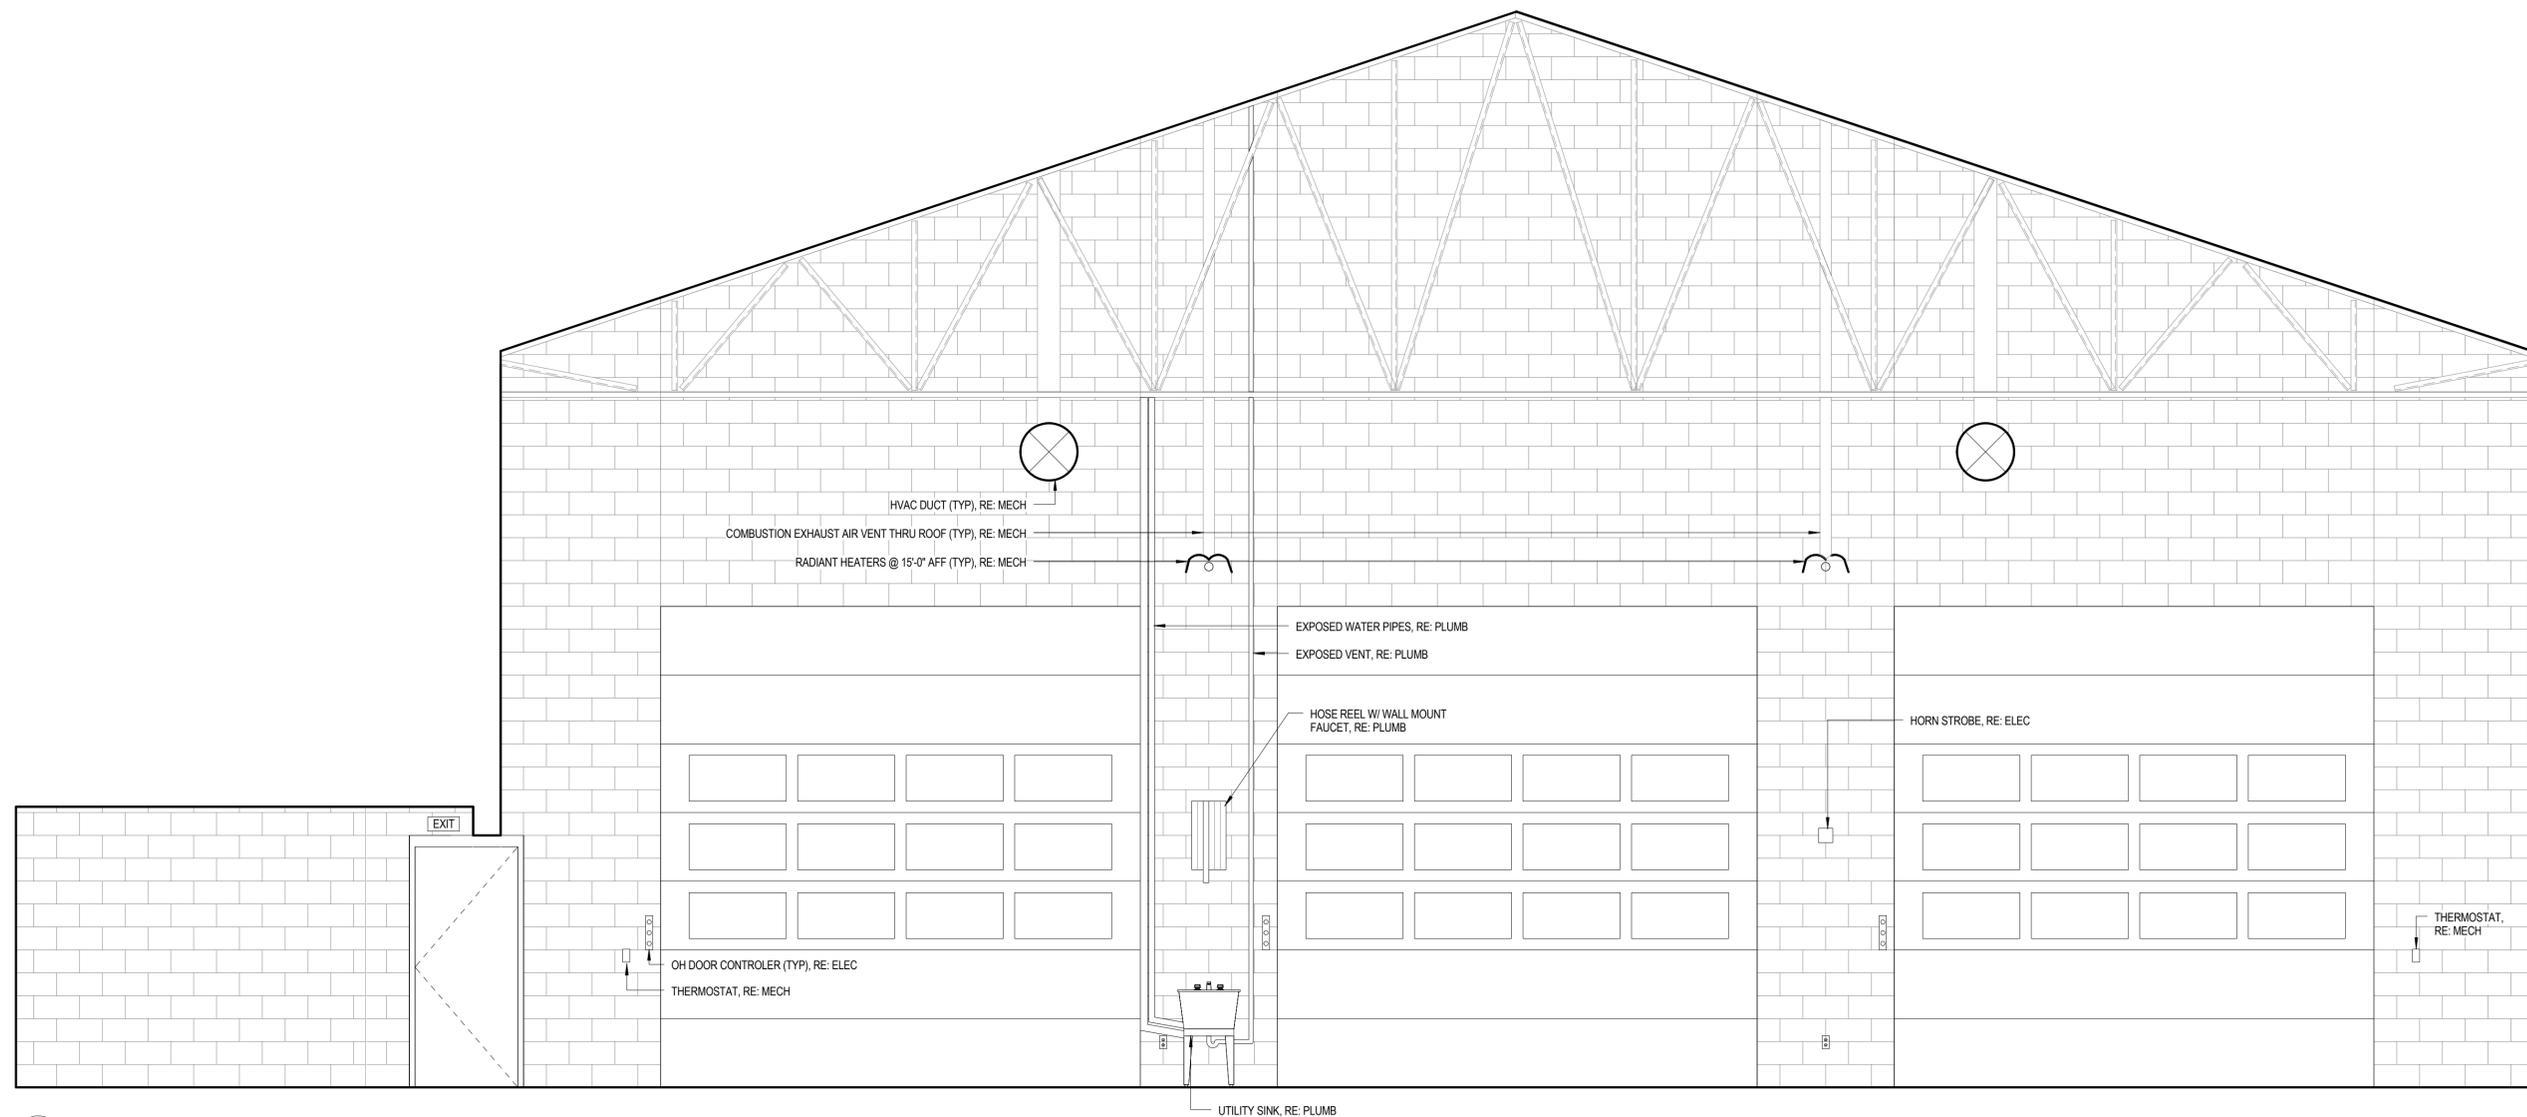

1 APPARATUS BAY NORTH
A404

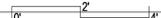



ORCHARD MESA
FIRE STATION #4

GRAND JUNCTION, COLORADO

INTERIOR
ELEVATIONS

NO: ISSUED FOR: DATE:




PROJECT STATUS: 100% CDs


DRAWN BY: Author CHECKED BY: Checker

DATE: 04/10/2015 SHEET NO:

PROJECT NO: 1443 **A405**

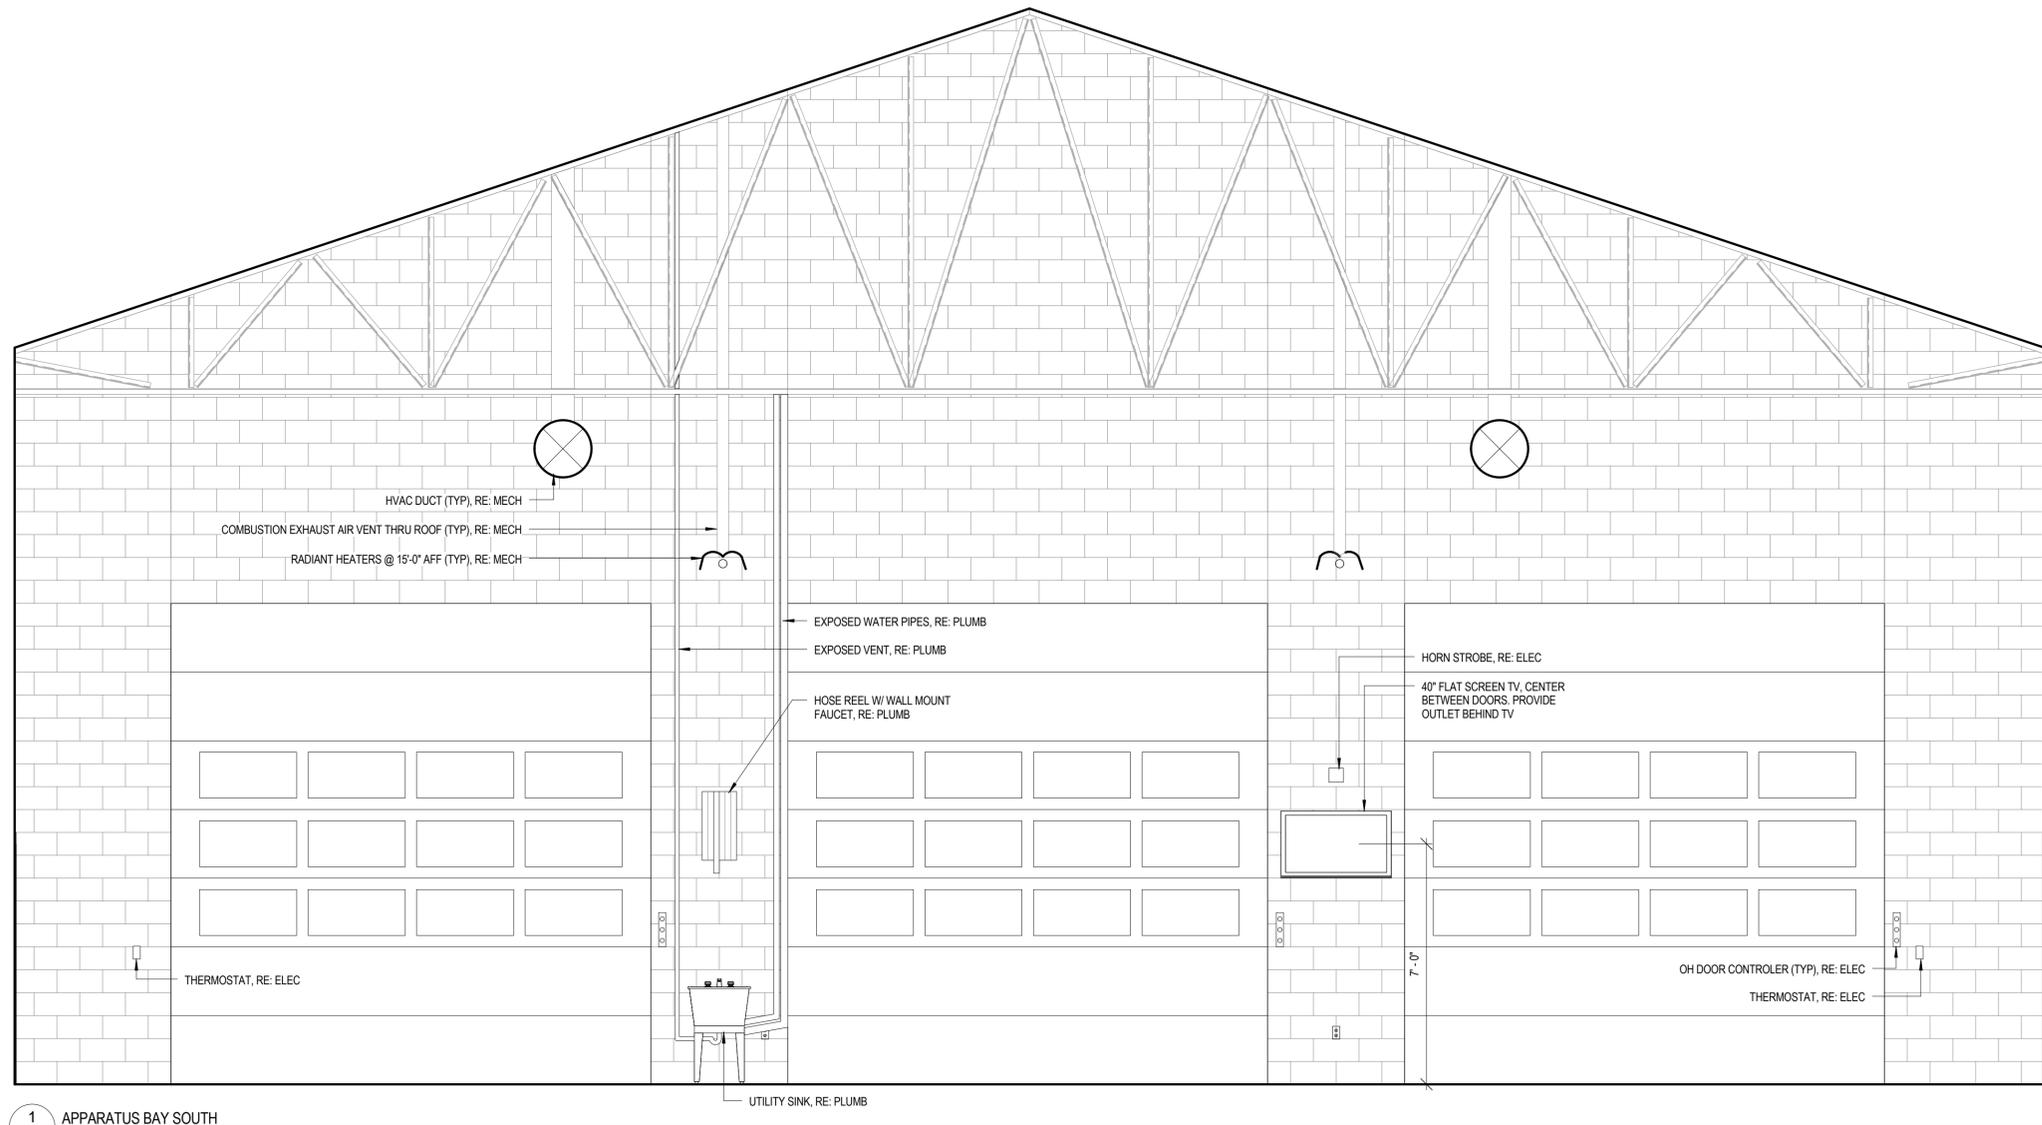

1 APPARATUS BAY SOUTH
A405

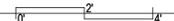

ARCHITECT'S SUPPLEMENTAL INSTRUCTIONS

PROJECT: Orchard Mesa Fire Station #4
 OWNER: City of Grand Junction
 TO: FCI Constructors, Inc.
 3070 I-70 B, Bldg A
 Grand Junction, CO 81504


ARCHITECT'S SUPPLEMENTAL INSTRUCTION NO: Seven (7)
 ARCHITECT: Chamberlin Architects
 437 Main Street
 Grand Junction, CO 81501
 ARCHITECT'S PROJECT NO: 1443
 DATE OF ISSUANCE: August 28, 2015

The Work shall be carried out in accordance with the following supplemental instructions issued in accordance with the Contract Documents without change in Contract Sum or Contract Time. Proceeding in accordance with these instructions indicates your acknowledgment that there will be no change in the Contract Sum or Contract Time.


- Per on-site meeting with architect, structural engineer, electrician & superintendent all electrical conduit runs (and associated boxes) at masonry shear wall locations to be surface mounted. Existing conduit (and box) on Grid Line F near corner of Mech 126 to be abandoned in place and filled with concrete. Existing conduit (and box) on Grid Line 8 (east of Door 103B) to remain. Alerting system boxes to be field modified for surface mounting. All exposed electrical conduits and boxes to be painted to match adjacent wall color.

Attachments: none

ARCHITECT: Chamberlin Architects, P.C.
 BY: Jonathan West
 S:\1443 - Orchard Mesa Fire Station #4\6. CONSTRUCTION\AS\AS1007.1443.doc

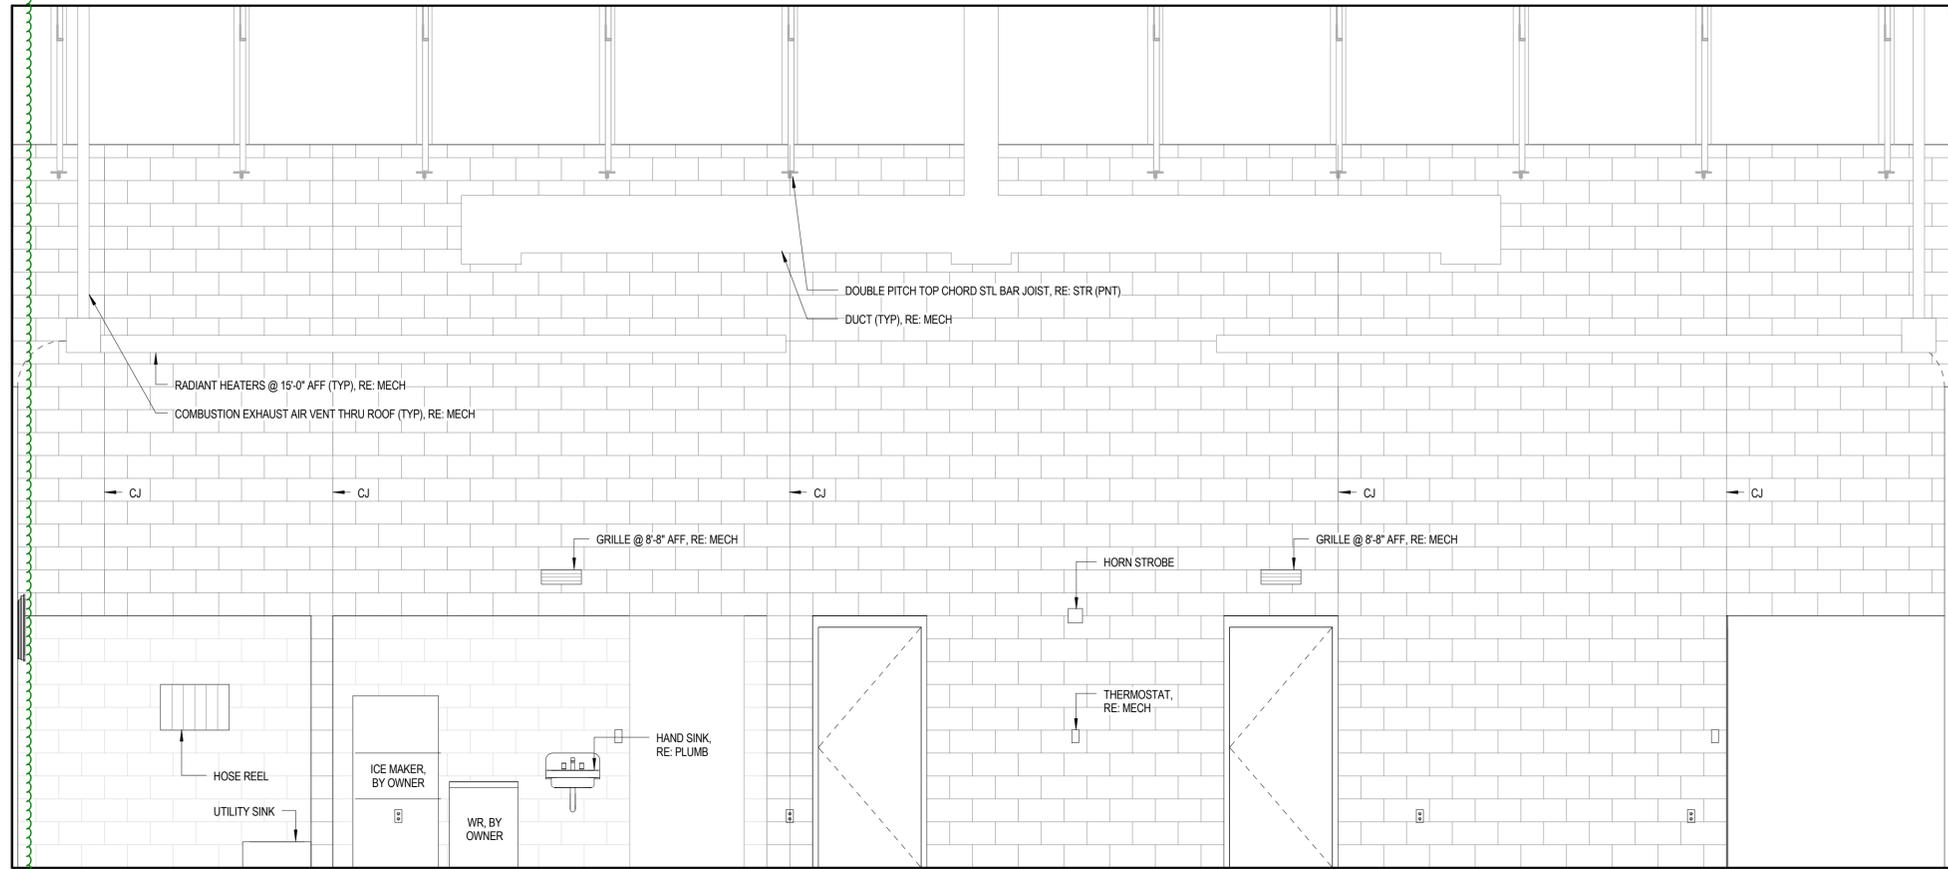

2 APPARATUS BAY WEST
 A406

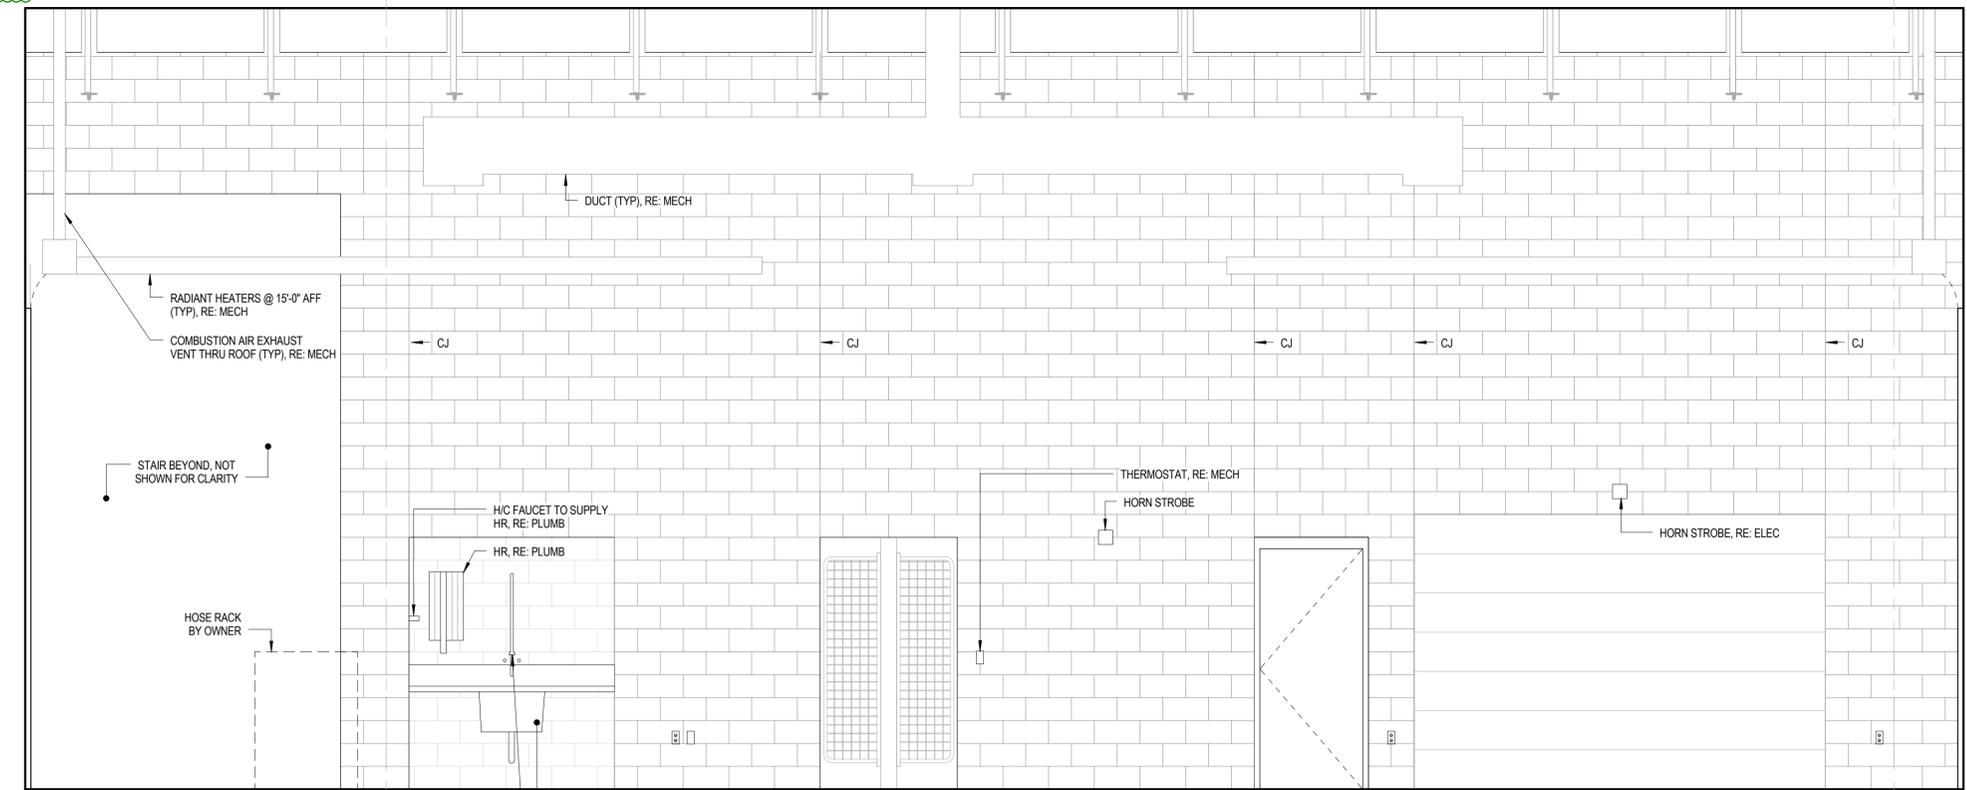

1 APPARATUS BAY EAST
 A406

ORCHARD MESA FIRE STATION #4

GRAND JUNCTION, COLORADO

INTERIOR ELEVATIONS

NO: ISSUED FOR: DATE:




PROJECT STATUS: 100% CDs

DRAWN BY: Author CHECKED BY: Checker

DATE: 04/10/2015 SHEET NO:

PROJECT NO: 1443 **A406**

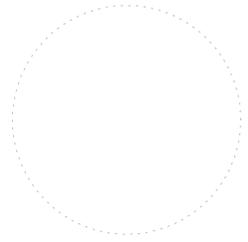

ORCHARD MESA FIRE STATION #4

GRAND JUNCTION, COLORADO

WALL SECTIONS


NO: ISSUED FOR: DATE:

PROJECT STATUS: 100% CDs


DRAWN BY: JW CHECKED BY: Checker

DATE: 04/10/2015 SHEET NO:


PROJECT NO: 1443 **A501**

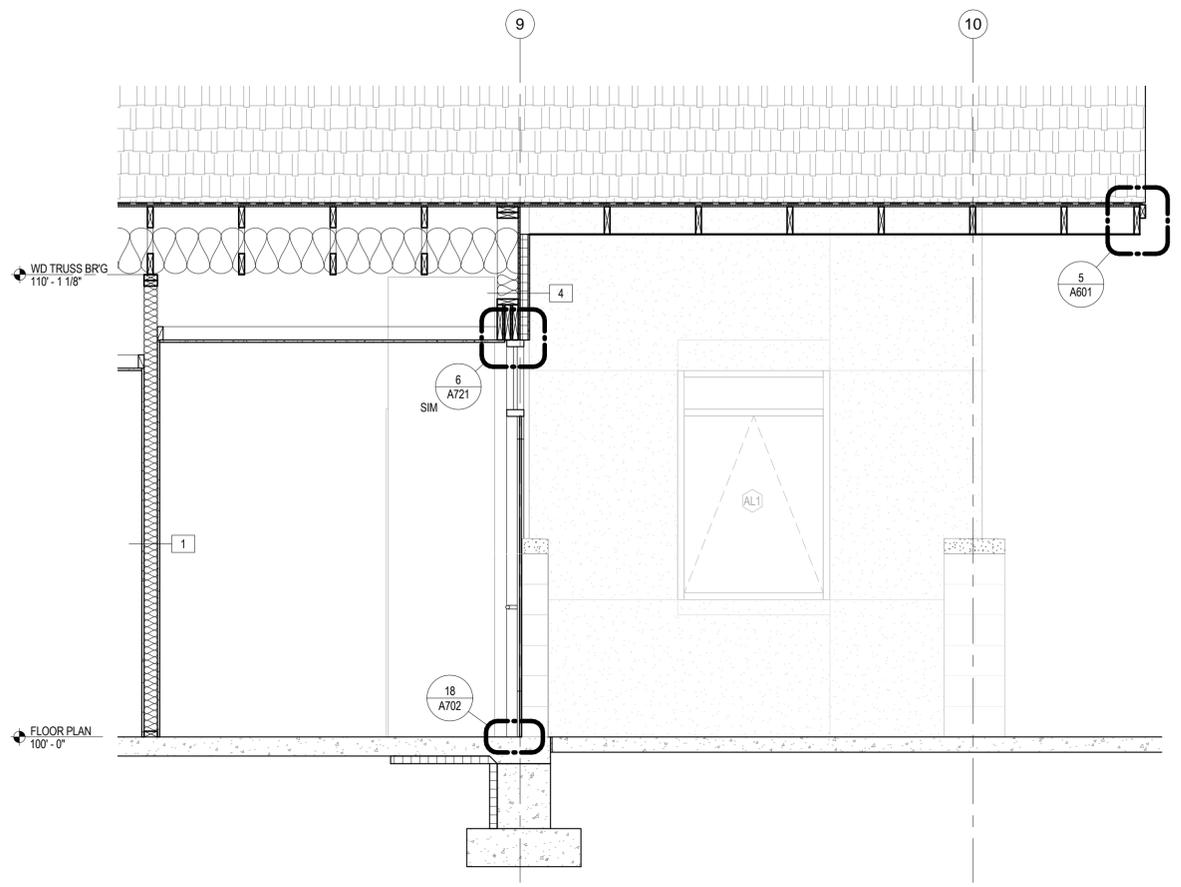


6 WALL SECTION 3
A501 1" = 1/2"

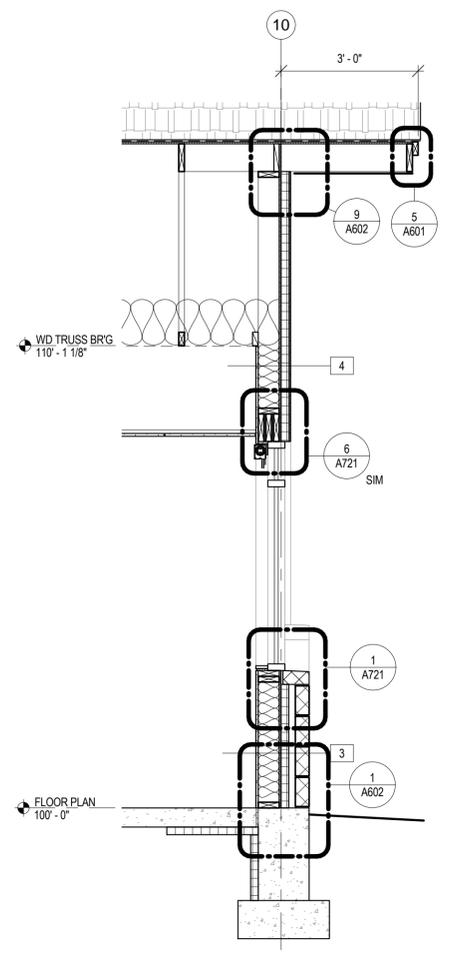


5 WALL SECTION 2
A501 1" = 1/2"

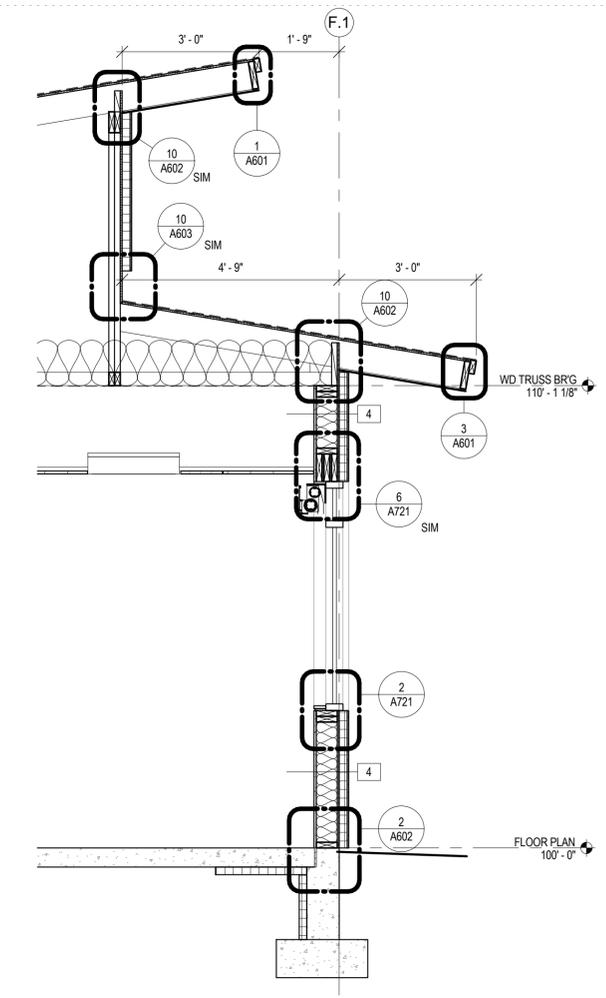


4 WALL SECTION 1
A501 1" = 1/2"

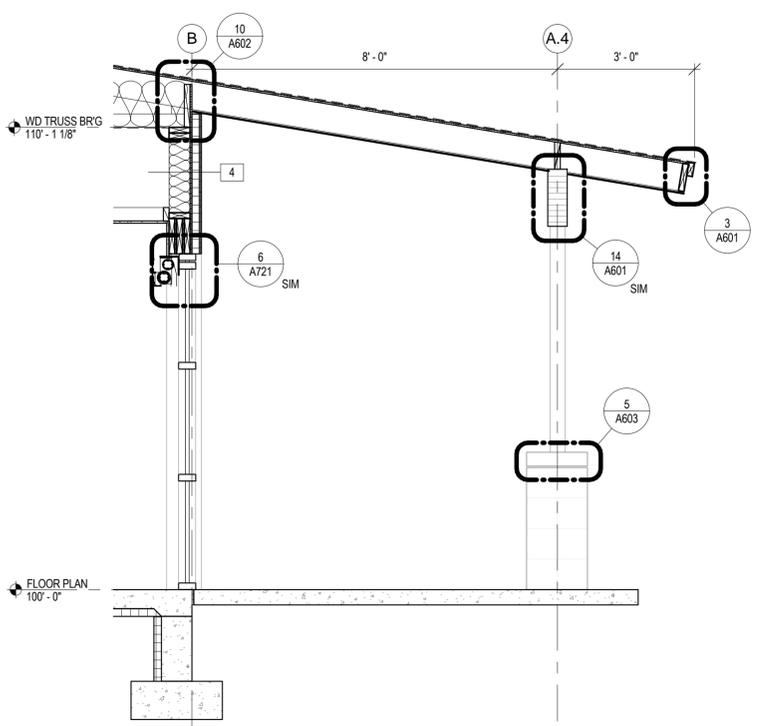


3 WALL SECTION 6
A501 1" = 1/2"

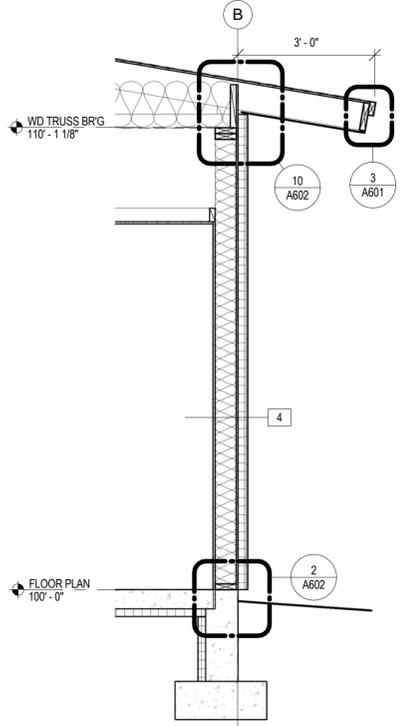

2 WALL SECTION 5
A501 1" = 1/2"

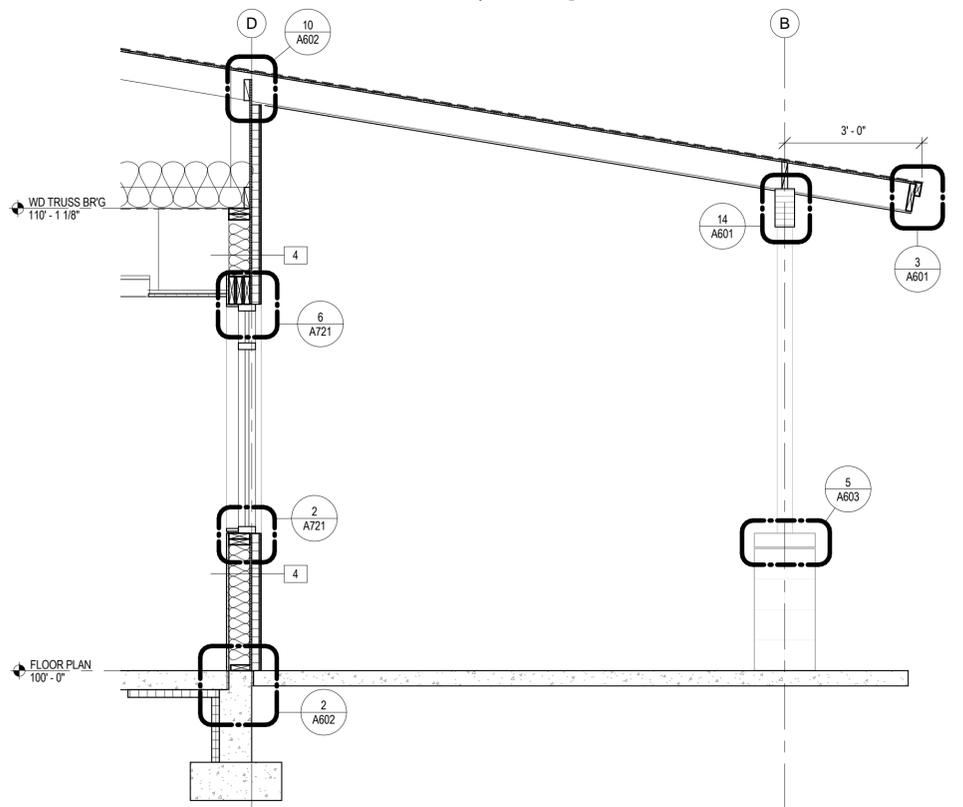

1 WALL SECTION 4
A501 1" = 1/2"

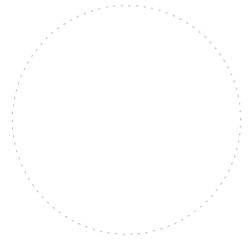

ORCHARD MESA
FIRE STATION #4

GRAND JUNCTION, COLORADO

WALL SECTIONS

NO: ISSUED FOR: DATE:





PROJECT STATUS: 100% CDs

DRAWN BY: JW CHECKED BY: Checker

DATE: 04/10/2015 SHEET NO:

PROJECT NO: 1443 **A502**

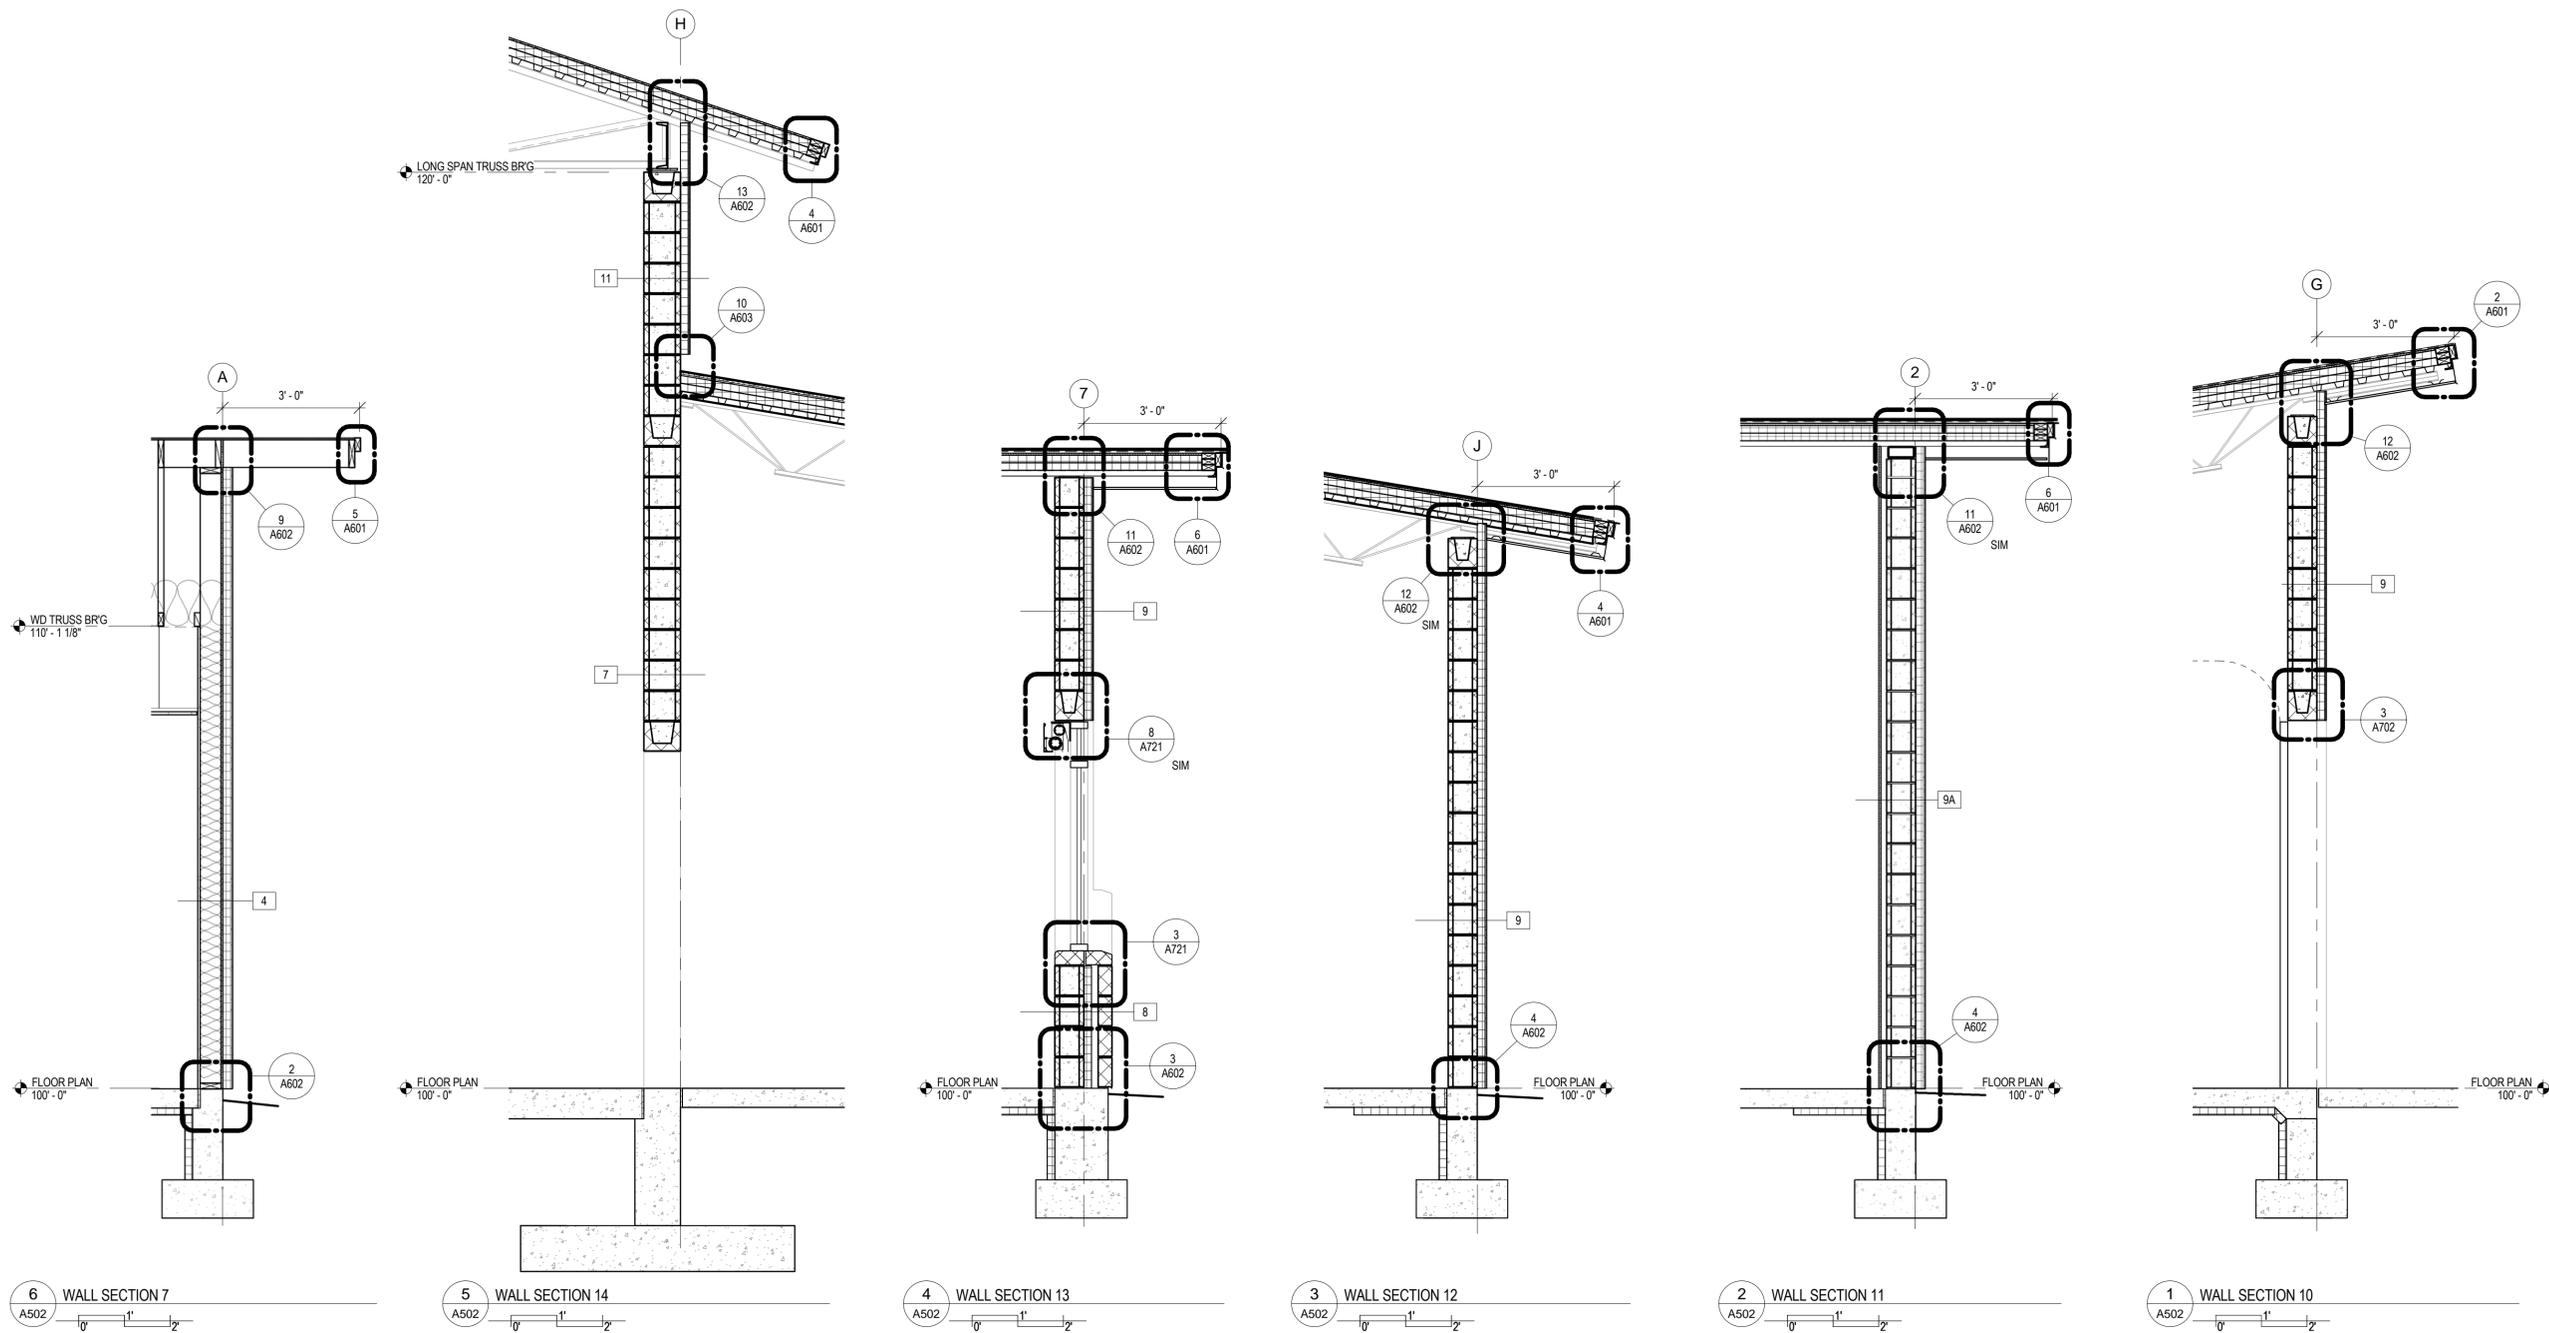

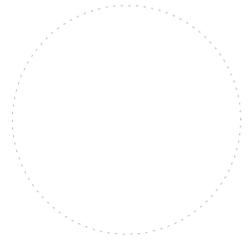

ORCHARD MESA
FIRE STATION #4

GRAND JUNCTION, COLORADO

WALL SECTIONS

NO. ISSUED FOR: DATE:







PROJECT STATUS: 100% CDs

DRAWN BY: JW CHECKED BY: Checker

DATE: 04/10/2015 SHEET NO:

PROJECT NO: 1443 **A503**

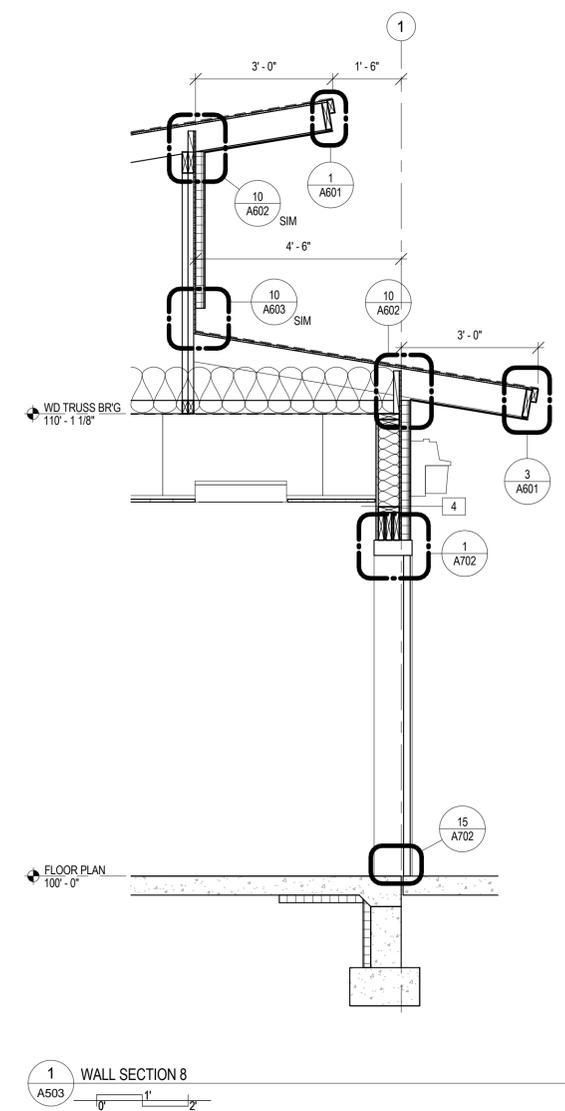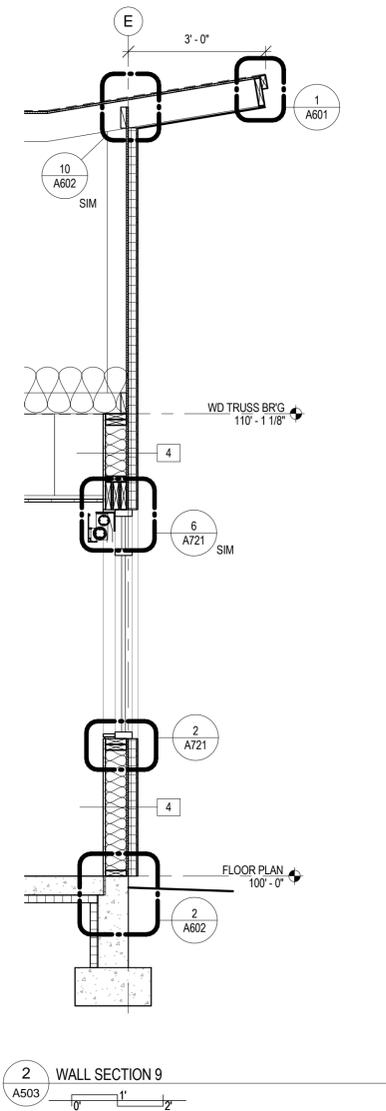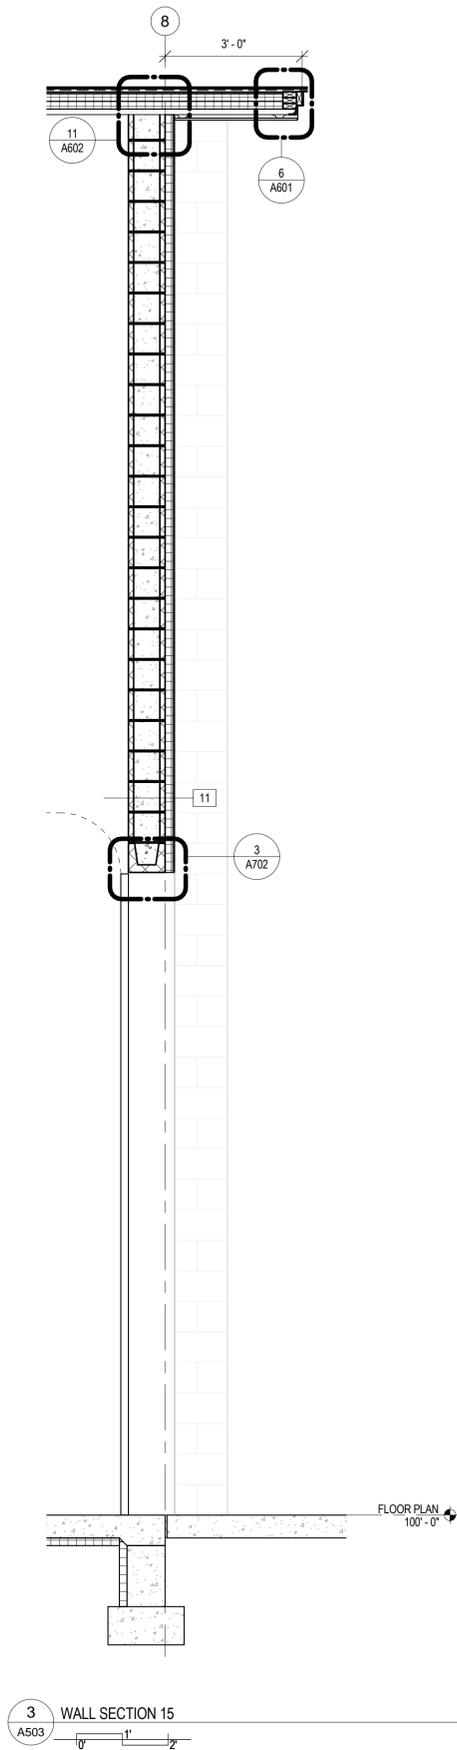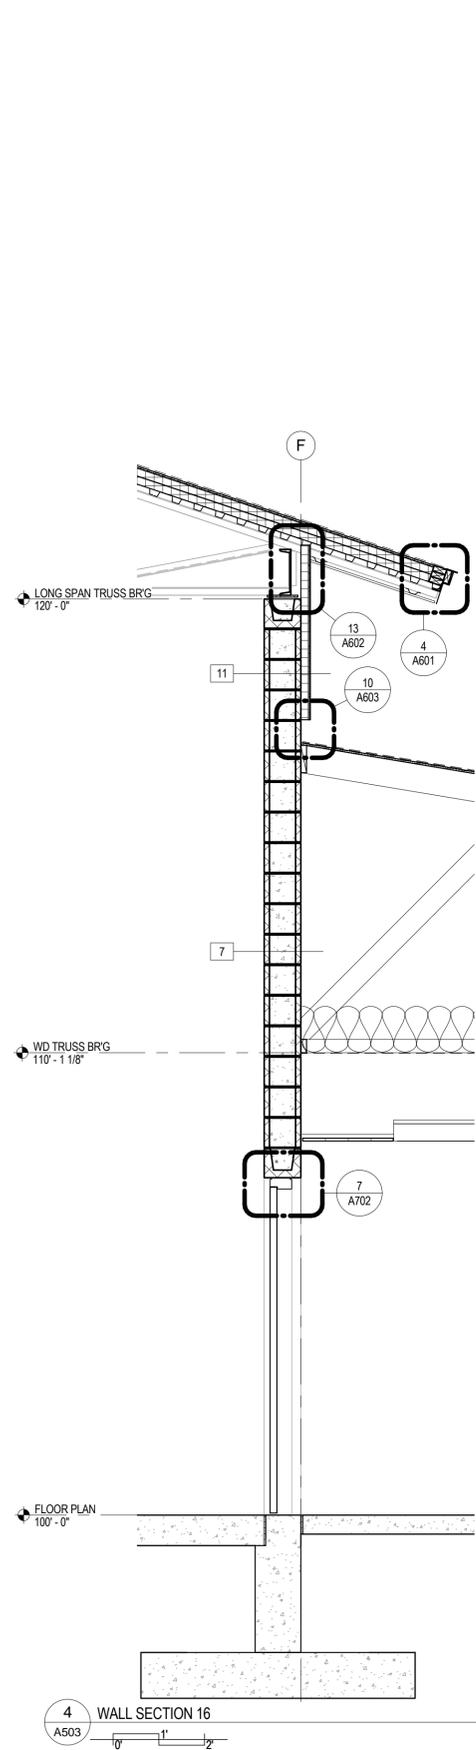

4/10/2015 12:00:26 PM

ORCHARD MESA FIRE STATION #4

GRAND JUNCTION, COLORADO

WALL SECTIONS

NO. ISSUED FOR: DATE:

- 1
- 2
- 3
- 4
- 5
- 6
- 7
- 8
- 9
- 10
- 11
- 12
- 13
- 14
- 15
- 16
- 17
- 18
- 19
- 20


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DRAWN BY: JW CHECKED BY: Checker


DATE: 04/10/2015 SHEET NO:

PROJECT NO: 1443 **A504**


©2012 CHAMBERLIN ARCHITECTS

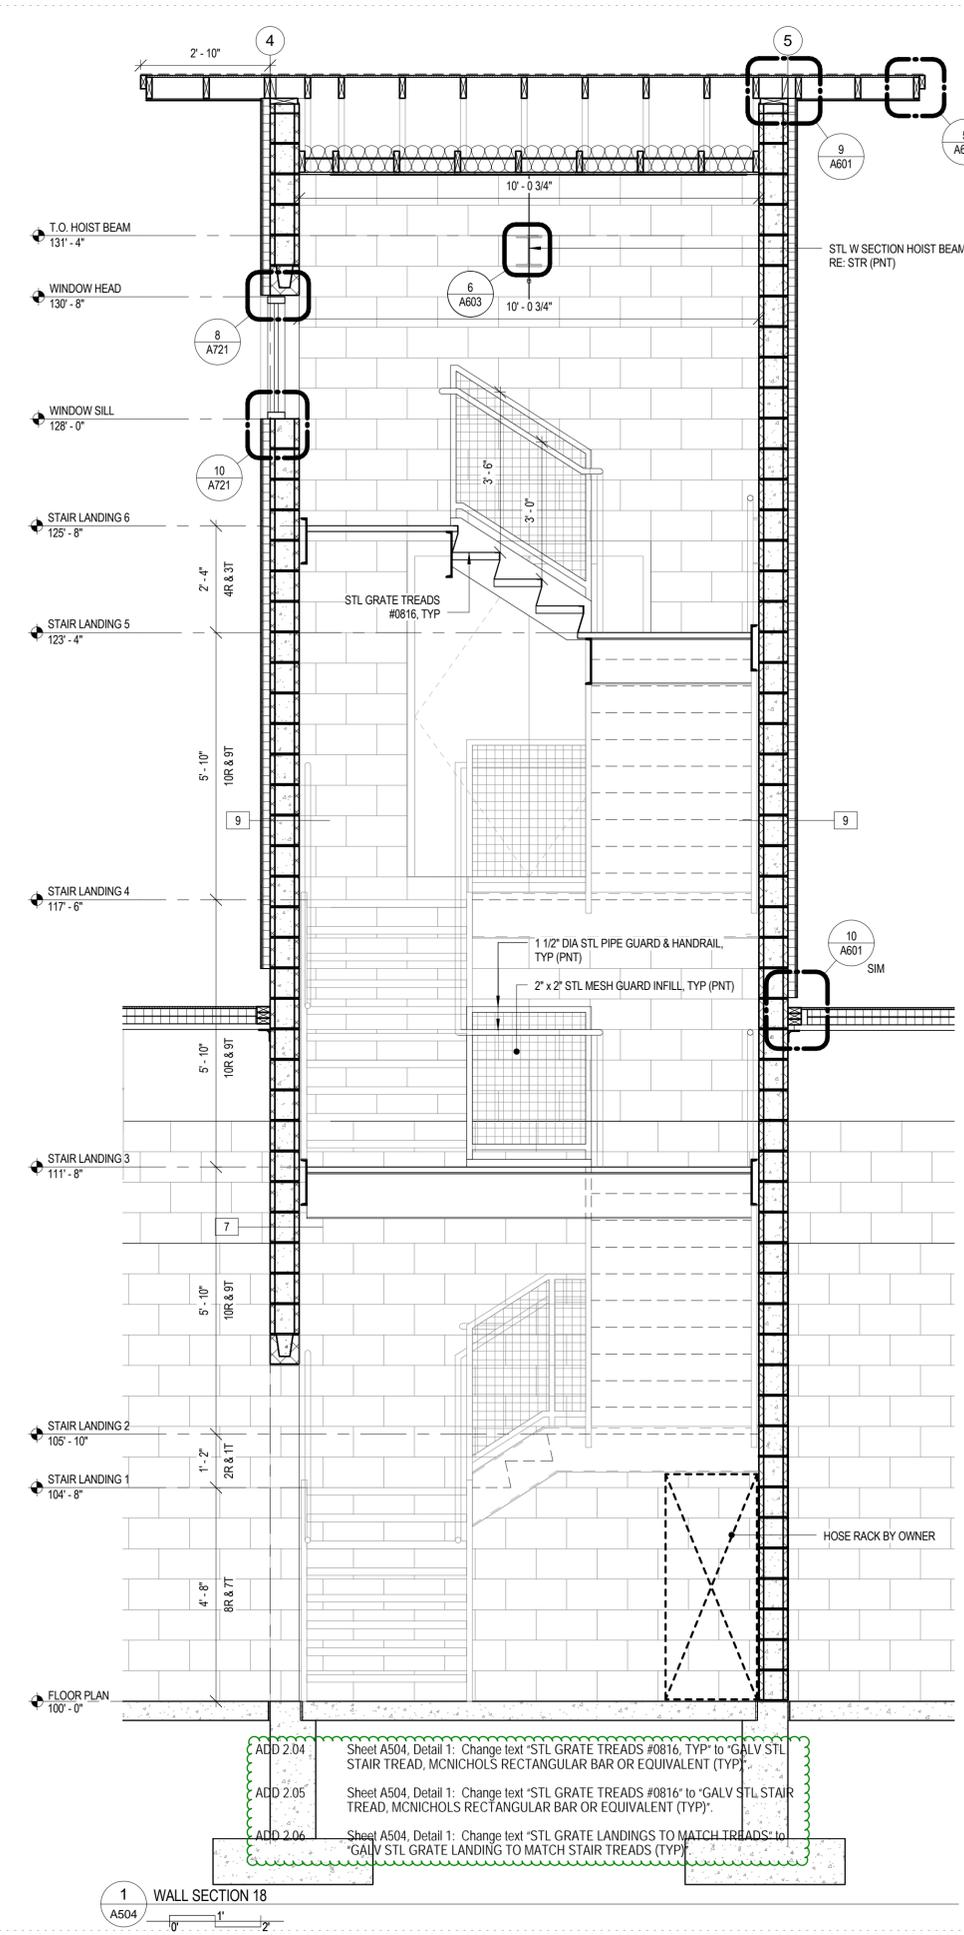

1 WALL SECTION 18
A504

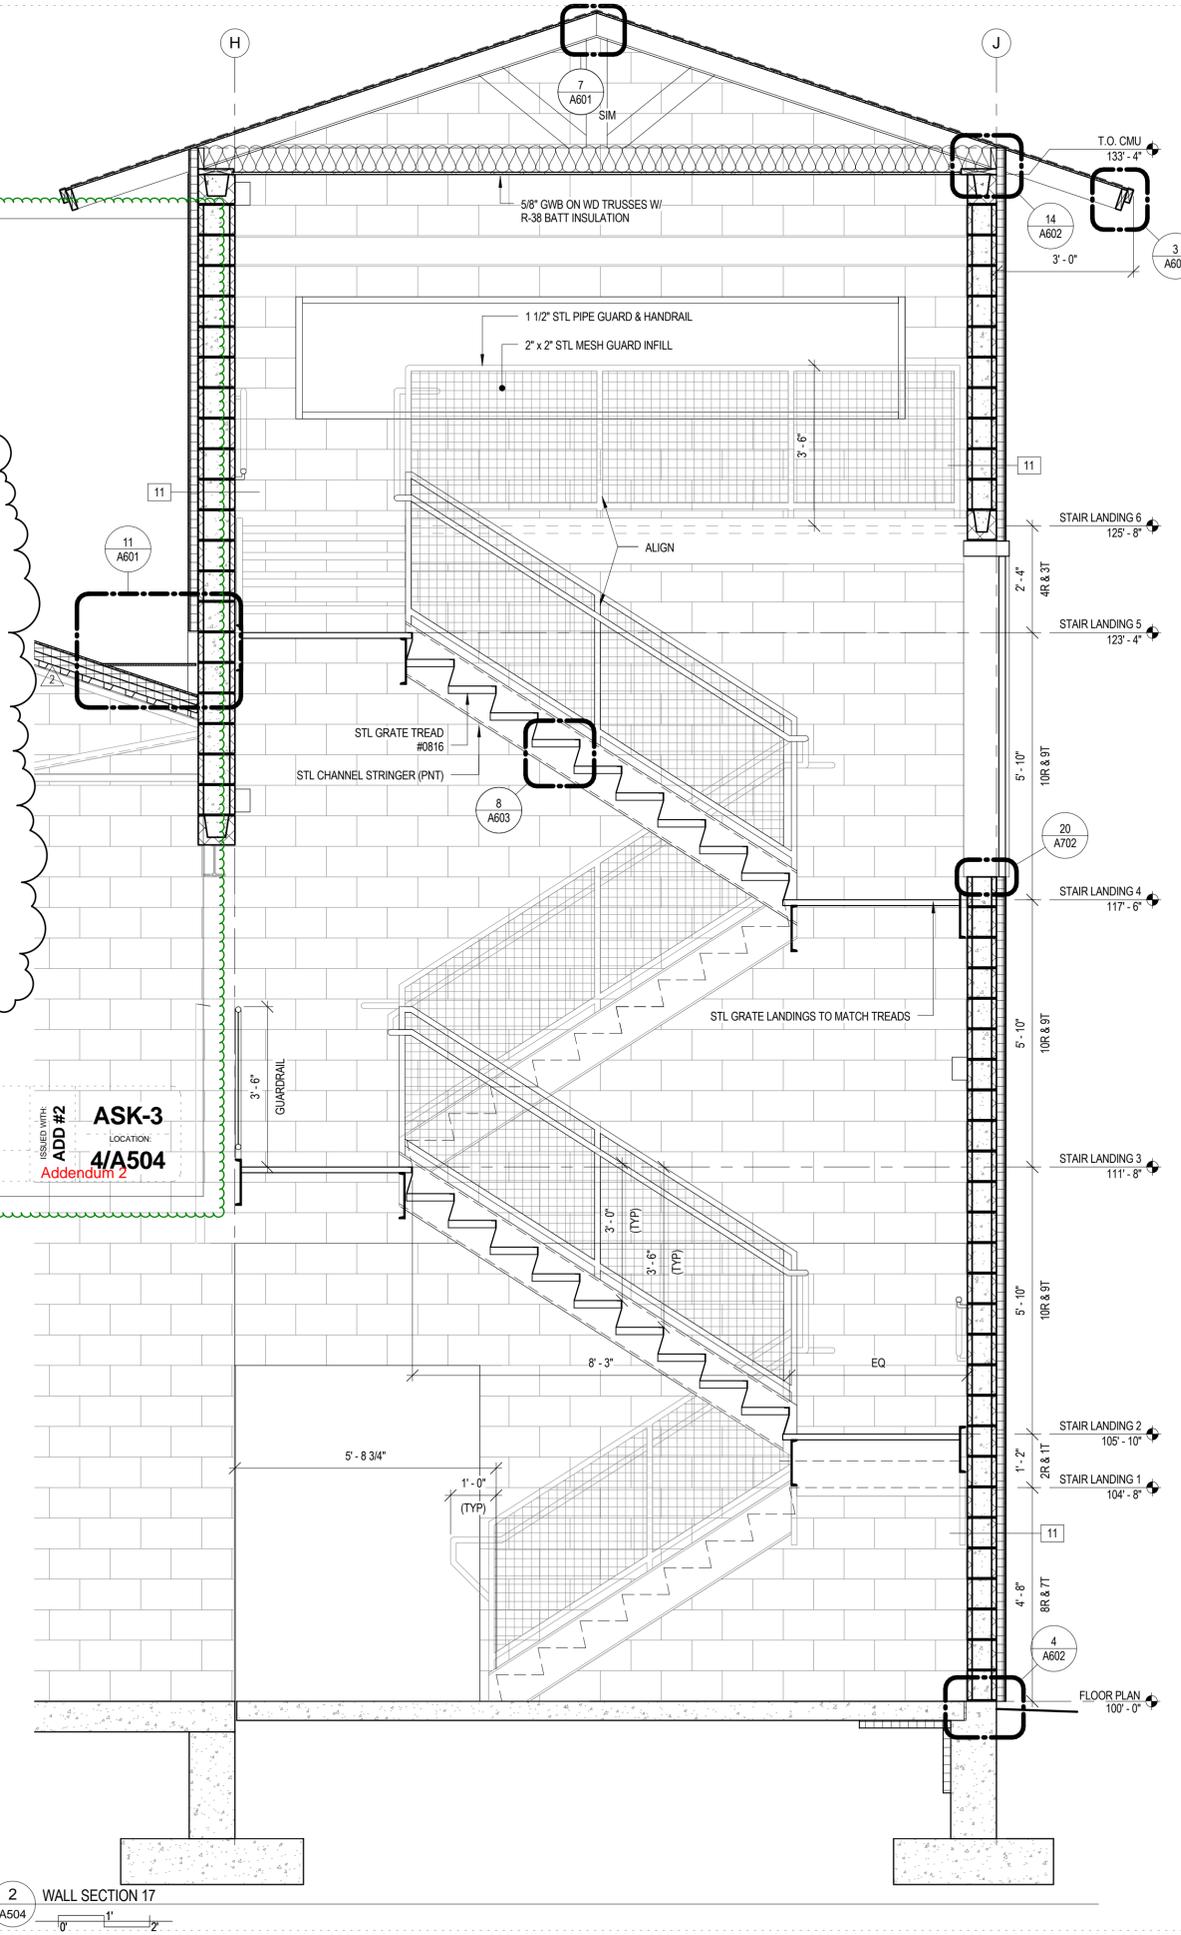

2 WALL SECTION 17
A504

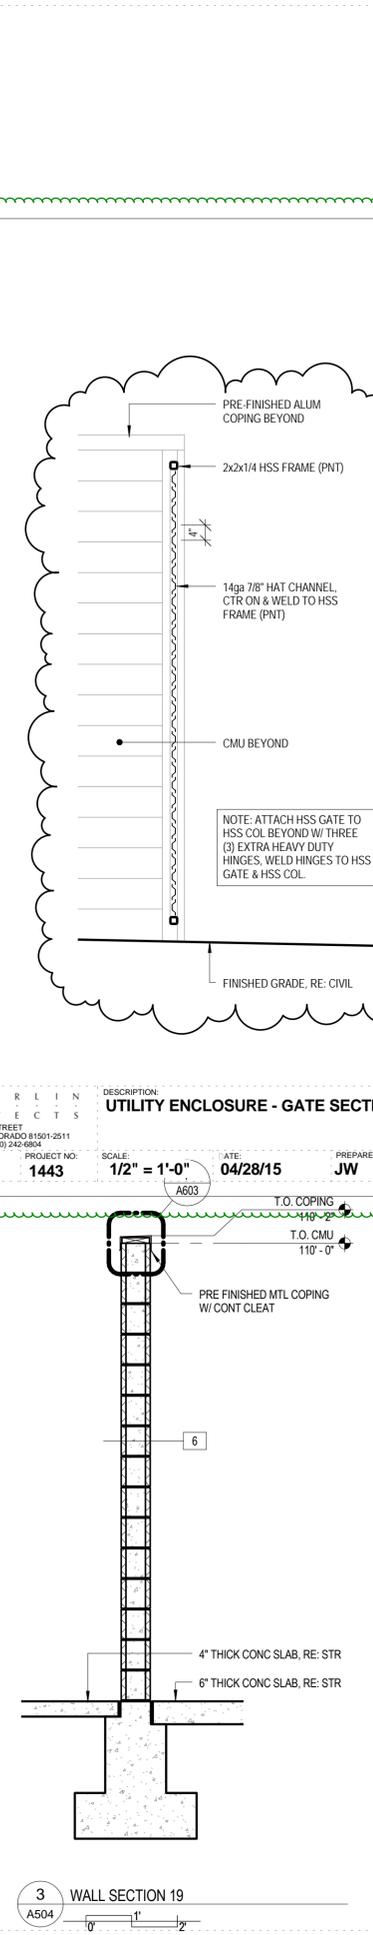

3 WALL SECTION 19
A504

DESCRIPTION: **UTILITY ENCLOSURE - GATE SECTION**

DATE: 04/28/15

SCALE: 1/2" = 1'-0"

PROJECT NO: 1443

PREPARED BY: JW

ISSUED WITH: **ADD #2 ASK-3**

LOCATION: **4/A504**

ADDENDUM 2

CHAMBERLIN ARCHITECTS
437 MAIN STREET
GRAND JUNCTION, COLORADO 81501-2511
TELEPHONE: (970) 242-6904

PROJECT: **OMFS#4**

CURRENT PROJECTS 1443-CENTRAL-ParadeYr

PROPOSAL REQUEST

FIELD OWNER ARCHITECT CONTRACTOR

PROJECT: Orchard Mesa Fire Station #4 PROPOSAL REQUEST NO: Ten (10)
 OWNER: City of Grand Junction 250 N. 5th Street Grand Junction, CO 81501 DATE: July 30, 2016 ARCHITECT'S PROJECT NO: 1443
 TO: FCI Constructors, Inc. 3070 I-70 B, Bldg A Grand Junction, CO 81504 CONTRACT DATED: December 18, 2014

Please submit an itemized quotation for changes in the Contract Sum and/or Time incident to proposed modifications to the Contract Documents described herein.

THIS IS NOT A CHANGE ORDER NOR A DIRECTION TO PROCEED WITH THE WORK DESCRIBED HEREIN.


Description:

1. Add TS hose rack assembly as illustrated in the attached Sketches ASK-8 & ASK-9.
2. Add belay tie off assembly as illustrated in the attached Sketches ASK-10 & SSK-5.


Attachments: ASK-8; ASK-9; ASK-10; SSK-5

ARCHITECT: Chamberlin Architects, P.C.
 BY: Jonathan West


S:\1443 - Orchard Mesa Fire Station #4\6. CONSTRUCTION\PROPOSAL REQUESTS\PR#010.1443.doc

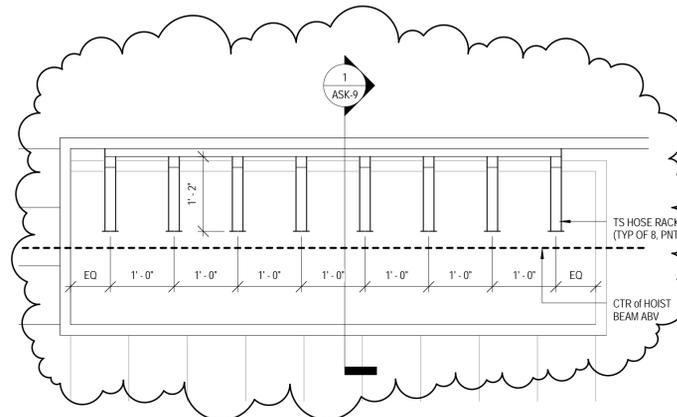

CHAMBERLIN ARCHITECTS		DESCRIPTION: HOSE TOWER - HOSE RACK PLAN		ISSUED WITH: PR#010		LOCATION: ASK-8	
PROJECT: OMFS#4	PROJECT NO: 1443	SCALE: 3/4" = 1'-0"	DATE: 7/30/15	PREPARED BY: JW			

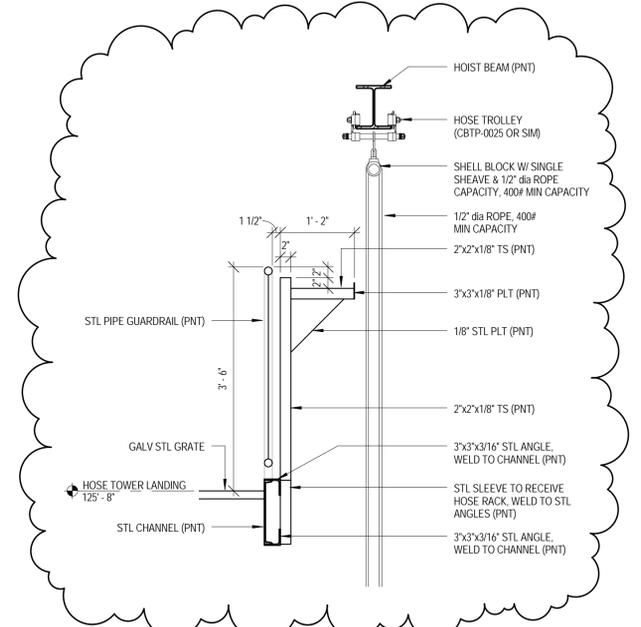

CHAMBERLIN ARCHITECTS		DESCRIPTION: HOSE TOWER - HOSE RACK SECTION		ISSUED WITH: PR#010		LOCATION: ASK-9	
PROJECT: OMFS#4	PROJECT NO: 1443	SCALE: 3/4" = 1'-0"	DATE: 7/30/15	PREPARED BY: JW			

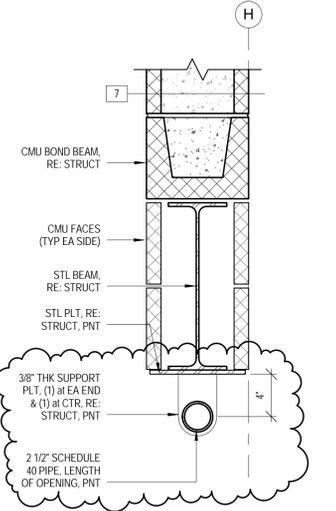

CHAMBERLIN ARCHITECTS		DESCRIPTION: BELAY TIE OFF DTL		ISSUED WITH: PR#010		LOCATION: ASK-10	
PROJECT: OMFS#4	PROJECT NO: 1443	SCALE: 1 1/2" = 1'-0"	DATE: 7/30/15	PREPARED BY: JW			

PROPOSAL REQUEST

FIELD OWNER ARCHITECT CONTRACTOR

PROJECT: Orchard Mesa Fire Station #4 PROPOSAL REQUEST NO: Eleven (11)
 OWNER: City of Grand Junction 250 N. 5th Street Grand Junction, CO 81501 DATE: July 31, 2016 ARCHITECT'S PROJECT NO: 1443
 TO: FCI Constructors, Inc. 3070 I-70 B, Bldg A Grand Junction, CO 81504 CONTRACT DATED: December 18, 2014

Please submit an itemized quotation for changes in the Contract Sum and/or Time incident to proposed modifications to the Contract Documents described herein.

THIS IS NOT A CHANGE ORDER NOR A DIRECTION TO PROCEED WITH THE WORK DESCRIBED HEREIN.


Description:

1. Add removable rails (one at 119'-0" AFF and one at 120'-6" AFF) at Door 135 as illustrated in the attached Sketch ASK-12.


Attachments: ASK-12

ARCHITECT: Chamberlin Architects, P.C.
 BY: Jonathan West

S:\1443 - Orchard Mesa Fire Station #4\6. CONSTRUCTION\PROPOSAL REQUESTS\PR#011.1443.doc

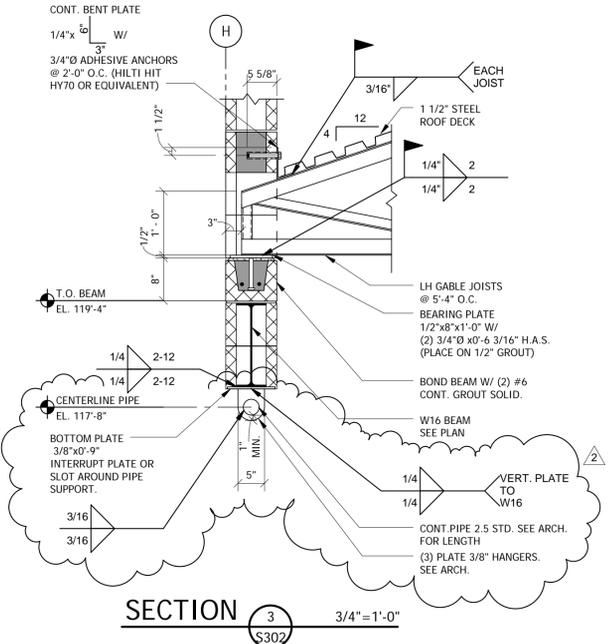

CHAMBERLIN ARCHITECTS		DESCRIPTION: DETAIL REVISION		ISSUED WITH: PR#10		LOCATION: SSK-5	
PROJECT: O.M.F.S. #4	PROJECT NO: 14.108	SCALE: AS NOTED	DATE: 07/30/15	PREPARED BY: KDN			
							LOCATION: S302

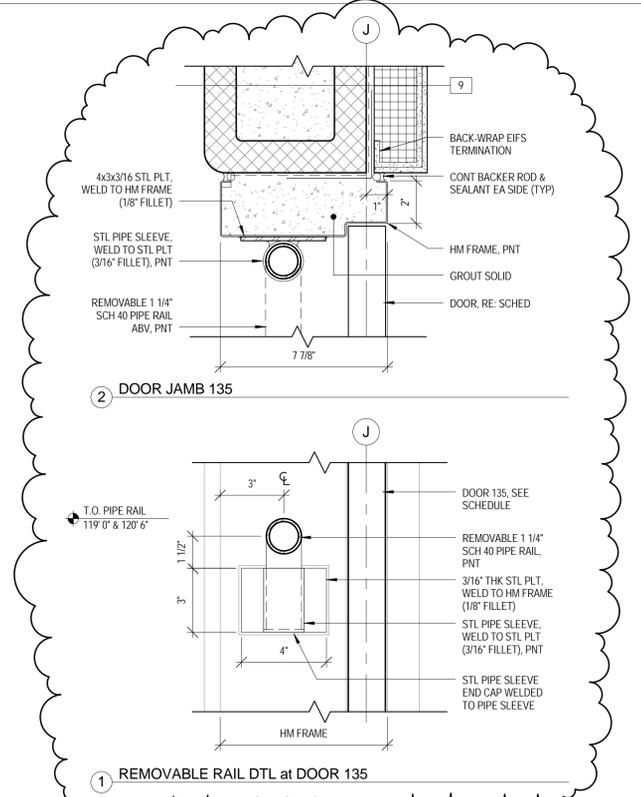


CHAMBERLIN ARCHITECTS		DESCRIPTION: REMOVABLE RAIL at DOOR 135 DTLs		ISSUED WITH: PR#011		LOCATION: ASK-12	
PROJECT: OMFS#4	PROJECT NO: 1443	SCALE: 3" = 1'-0"	DATE: 7/31/15	PREPARED BY: JW			

CHAMBERLIN ARCHITECTS

437 Main St.
Grand Junction, Colorado 81501
T 970.242.6904

725 Saint Joseph St., Suite B1
Rapid City, South Dakota 57701
T 605.355.6804

www.chamberlinarchitects.com

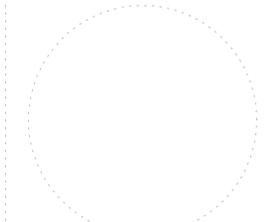

ORCHARD MESA
FIRE STATION #4

GRAND JUNCTION, COLORADO

ARCHITECTURAL
DETAILS


NO: ISSUED FOR: DATE:

PROJECT STATUS: 100% CDs


DRAWN BY: JW CHECKED BY: Checker

DATE:
04/10/2015 SHEET NO.


PROJECT NO:
1443 **A601**

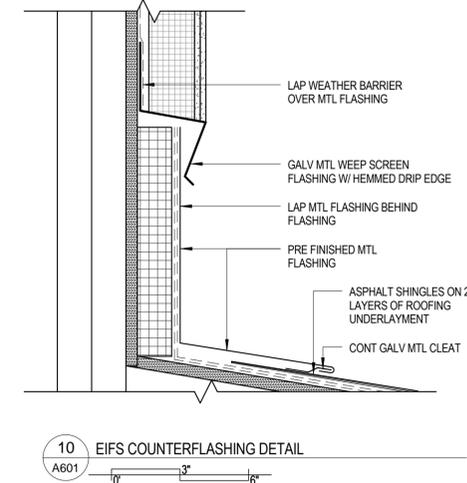


10 EIFS COUNTERFLASHING DETAIL
A601

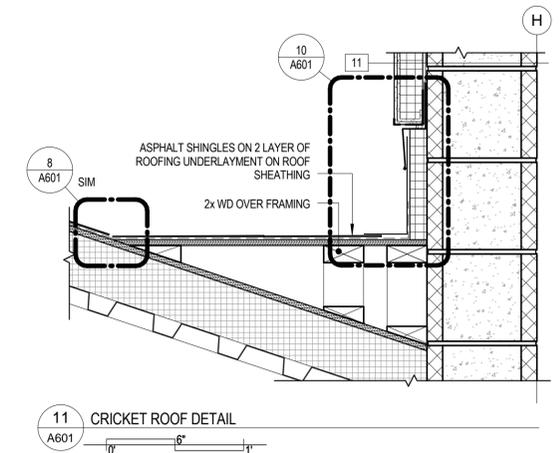


11 CRICKET ROOF DETAIL
A601

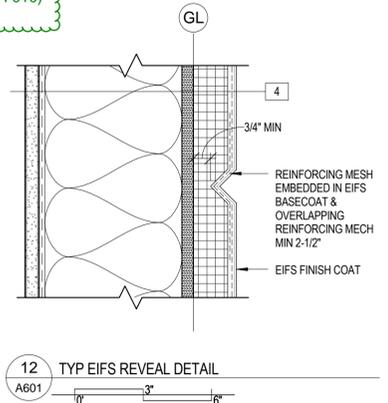


12 TYP EIFS REVEAL DETAIL
A601

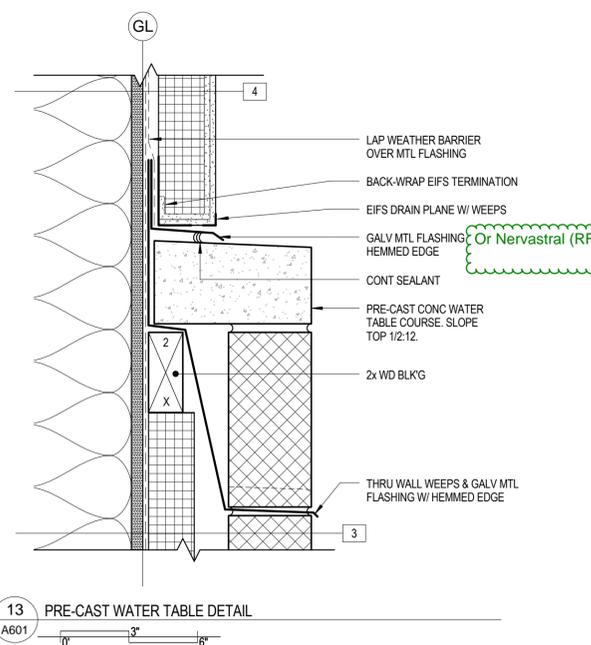


13 PRE-CAST WATER TABLE DETAIL
A601

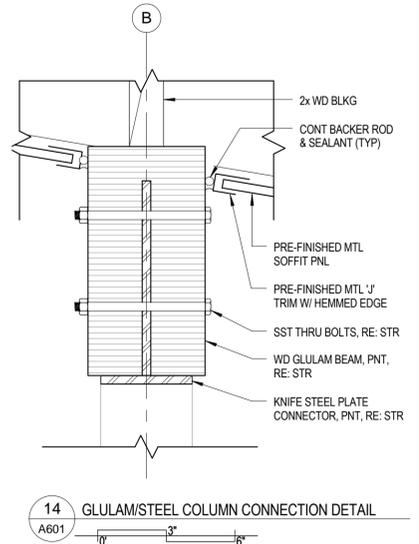

14 GLULAM/STEEL COLUMN CONNECTION DETAIL
A601

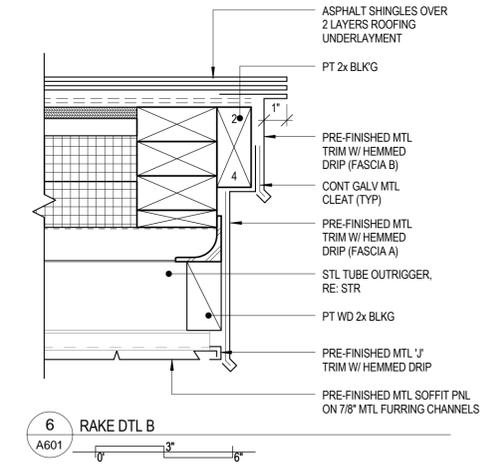


6 RAKE DTL B
A601

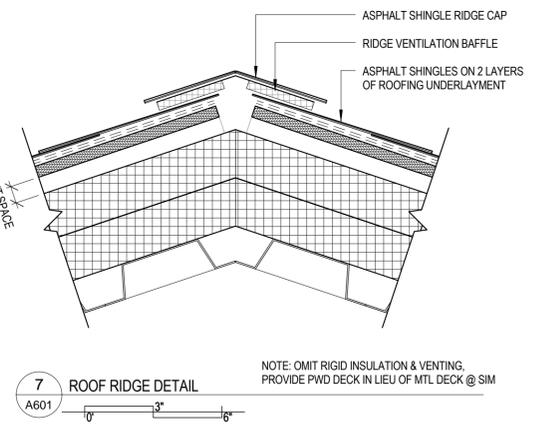


7 ROOF RIDGE DETAIL
A601


NOTE: OMIT RIGID INSULATION & VENTING, PROVIDE PWD DECK IN LIEU OF MTL DECK @ SIM

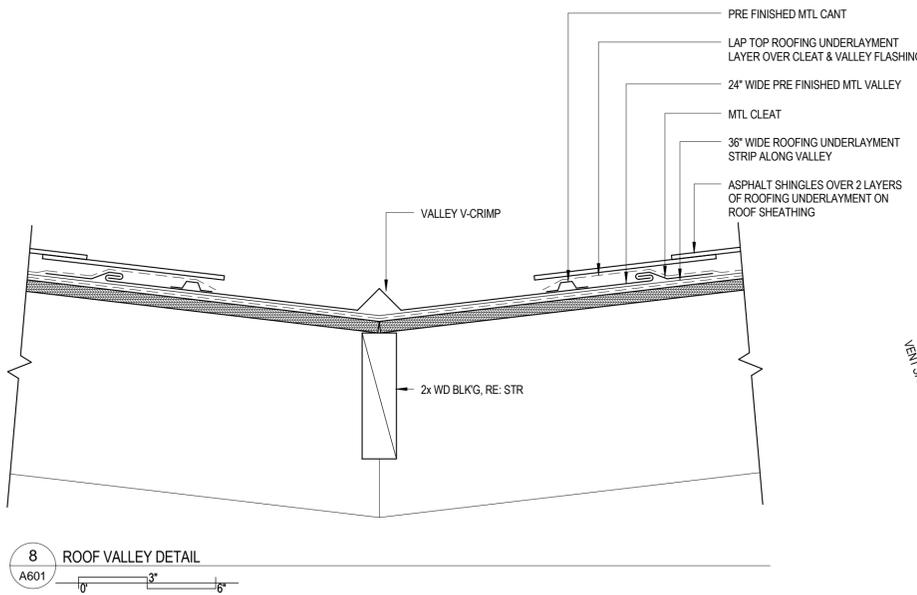


8 ROOF VALLEY DETAIL
A601

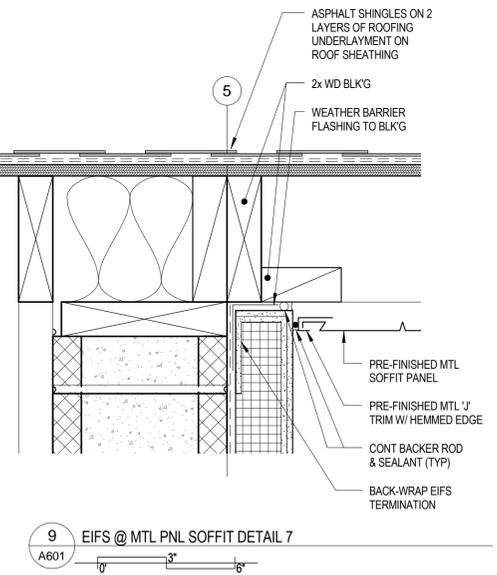


9 EIFS @ MTL PNL SOFFIT DETAIL 7
A601

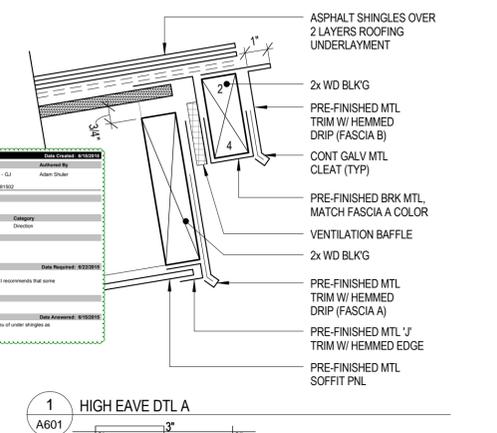


1 HIGH EAVE DTL A
A601

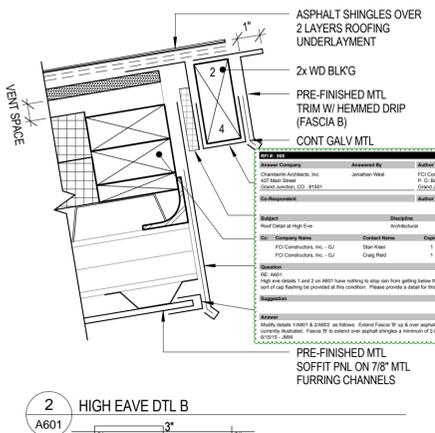


2 HIGH EAVE DTL B
A601

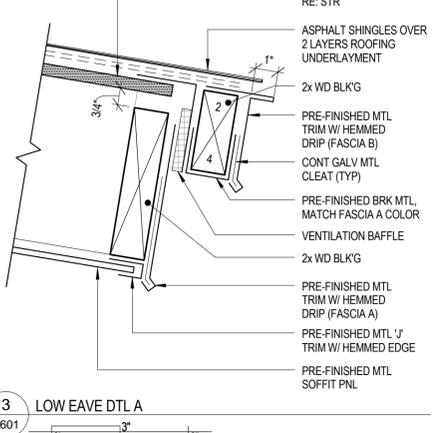

3 LOW EAVE DTL A
A601

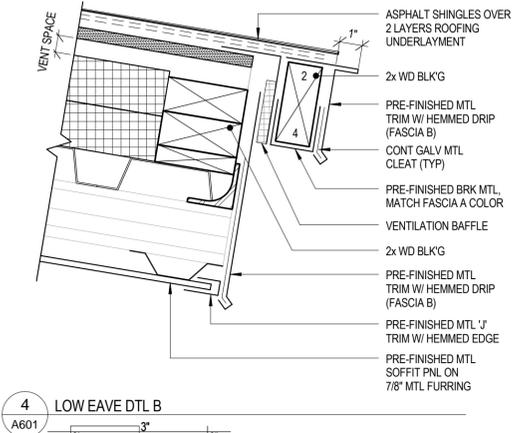


4 LOW EAVE DTL B
A601

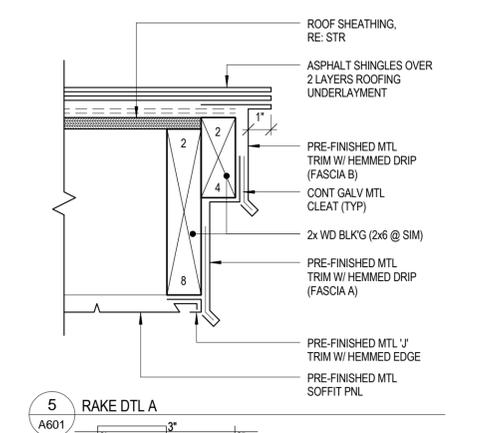

5 RAKE DTL A
A601


CURRENT PROJECTS 1443-CENTRAL-Panel.rvt 4/10/2015 12:00:28 PM ©2015 CHAMBERLIN ARCHITECTS

4/10/2015 12:00:48 PM
CURRENT PROJECTS\1443-CENTRAL-Parade.rvt

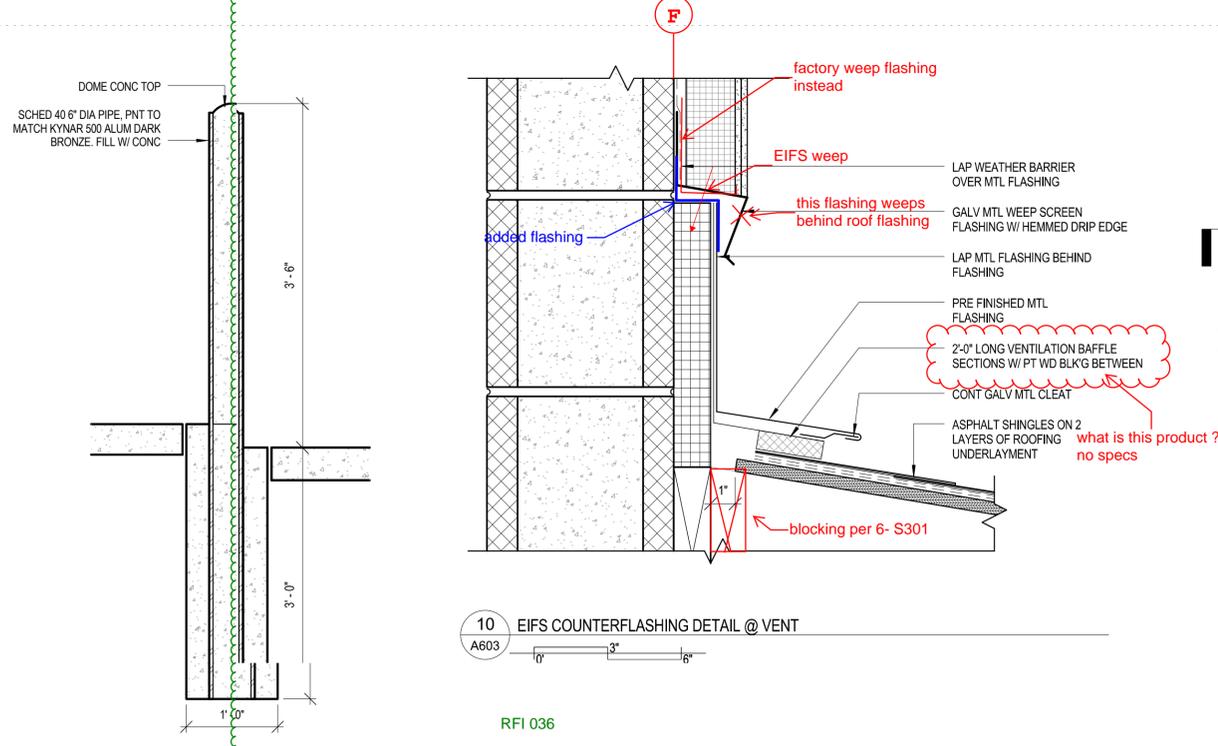


10 EIFS COUNTERFLASHING DETAIL @ VENT
A603

RFI 036

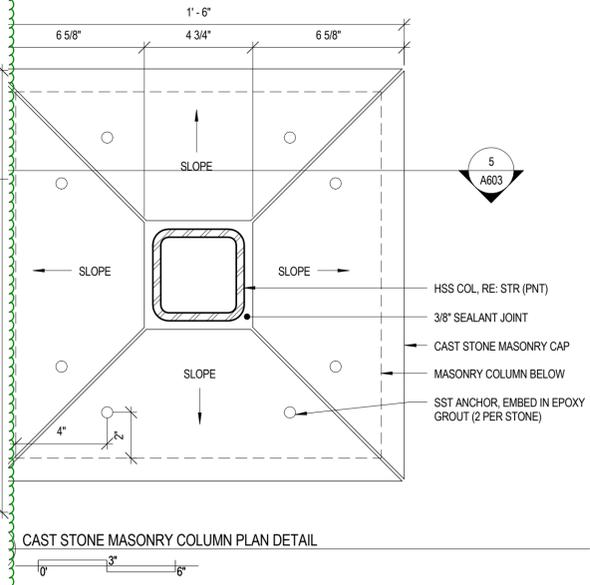


CAST STONE MASONRY COLUMN PLAN DETAIL
A603

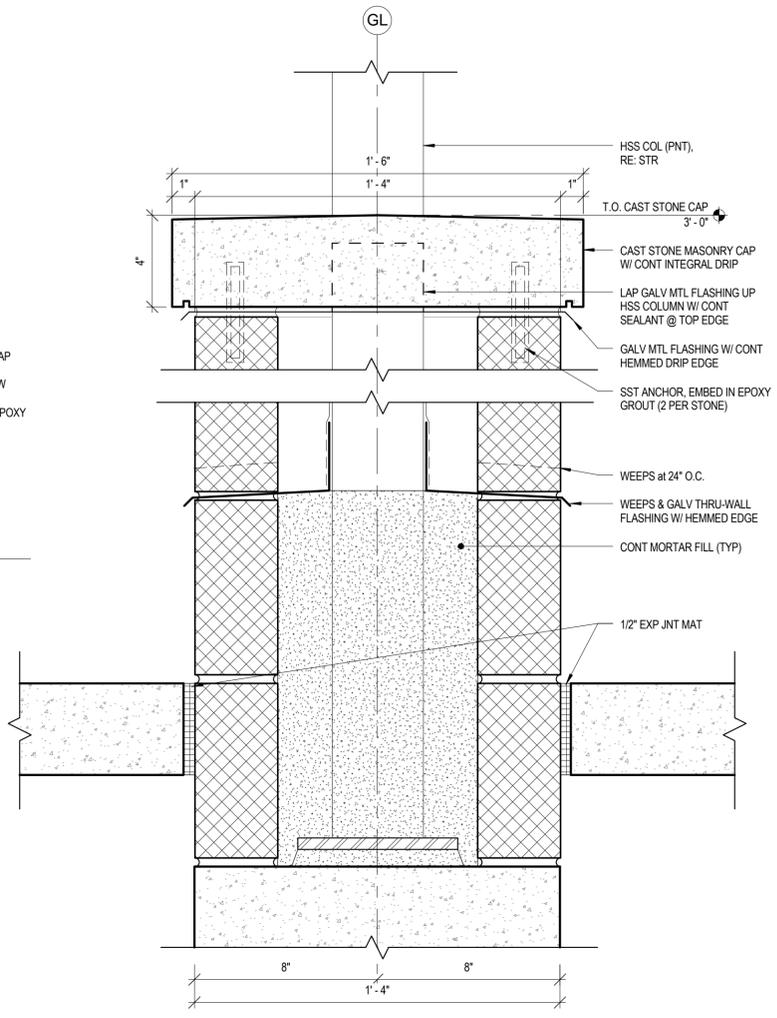

5 CAST STONE MASONRY COLUMN DETAIL
A603


11 STEEL BOLLARD DETAIL
A603

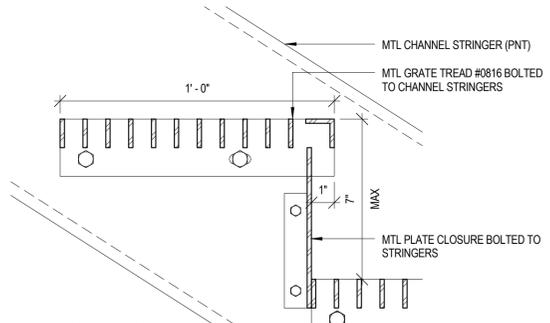


8 STAIR TREAD DETAIL
A603

ADD 2.08 Sheet A603, Detail 8: Change text "MTL GRATE TREAD #0816 BOLTED TO CHANNEL STRINGERS" to "GALV STL STAIR TREAD, MCNICHOLS RECTANGULAR BAR OR EQUIVALENT, BOLT TO STRINGER".


ADD 2.09 Sheet A603, Detail 8: Delete metal plate closure bolted to stringers.

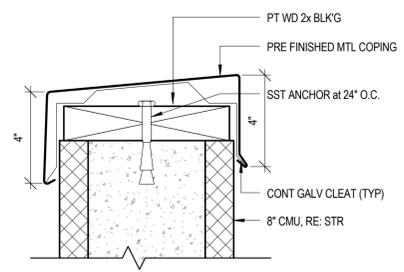

7 COPING DETAIL
A603

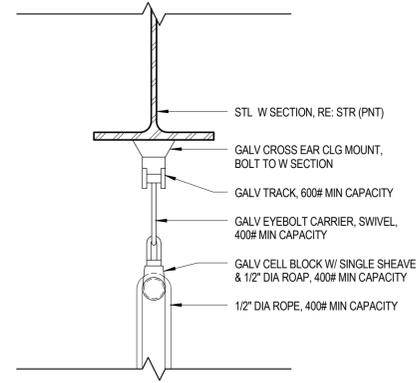

6 HOIST DETAIL
A603

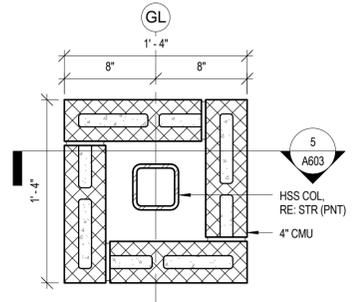


4 MASONRY COLUMN PLAN DETAIL
A603




FIRE STATION #4

3 GJFD LOGO
A603

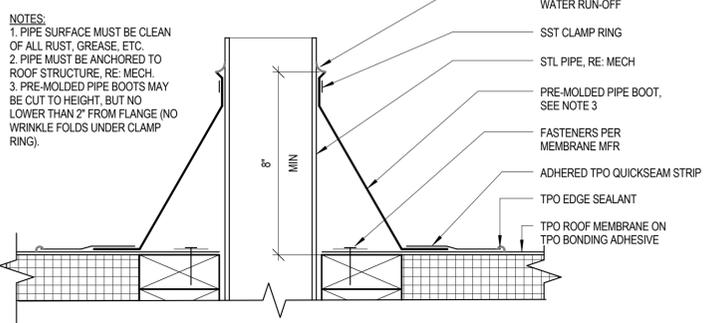

2 TYP ROOF PENETRATION DETAIL
A603

NOTES:
1. PIPE SURFACE MUST BE CLEAN OF ALL RUST, GREASE, ETC.
2. PIPE MUST BE ANCHORED TO ROOF STRUCTURE, RE: MECH.
3. PRE-MOLDED PIPE BOOTS MAY BE CUT TO HEIGHT, BUT NO LOWER THAN 2\"/>

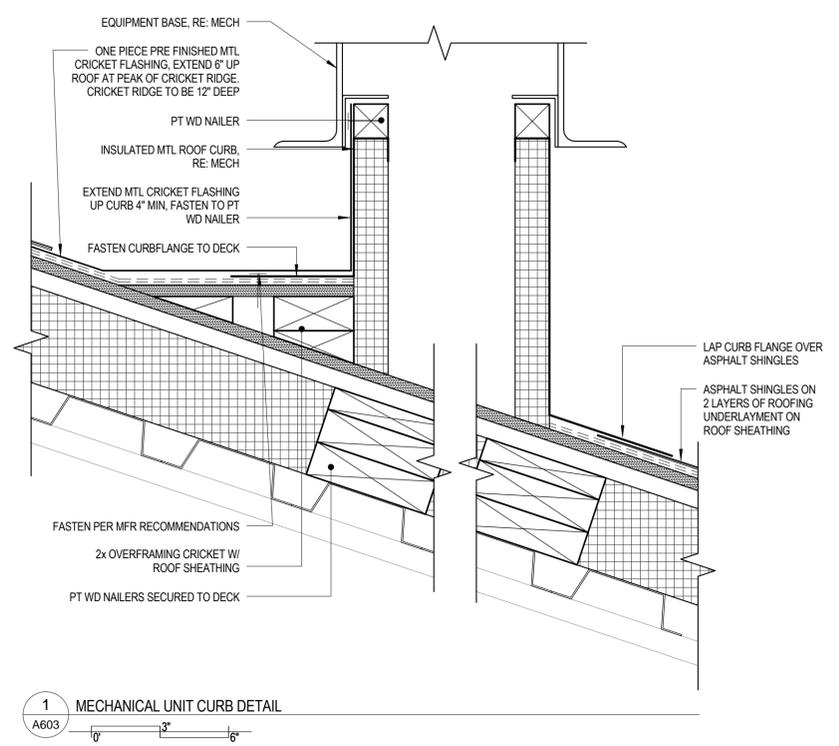

1 MECHANICAL UNIT CURB DETAIL
A603

ORCHARD MESA FIRE STATION #4

GRAND JUNCTION, COLORADO

ARCHITECTURAL DETAILS

NO: ISSUED FOR: DATE:



PROJECT STATUS: 100% CDs




DRAWN BY: PH CHECKED BY: JW

DATE: 04/10/2015 SHEET NO:


PROJECT NO: 1443 A603

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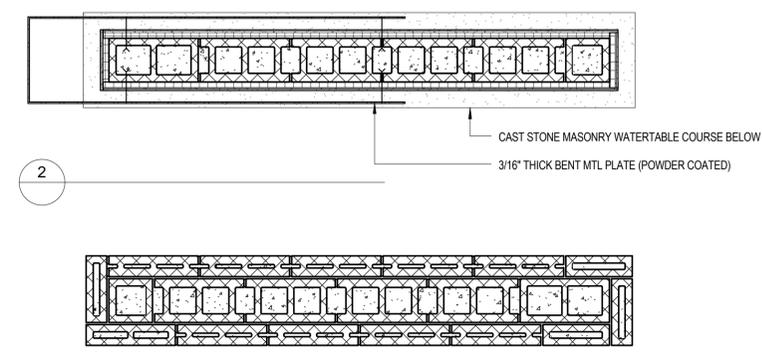
DELETED

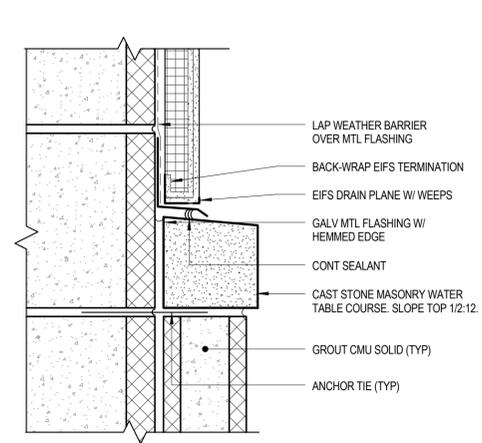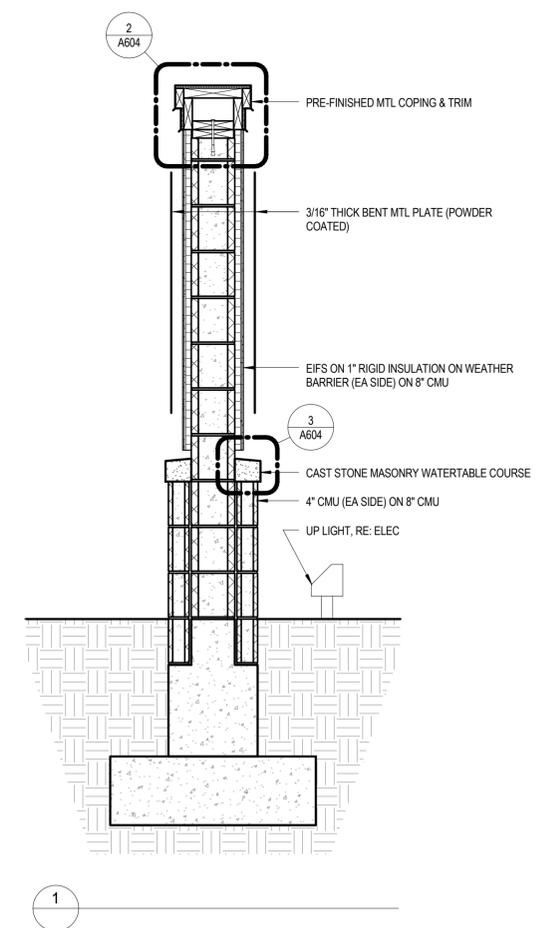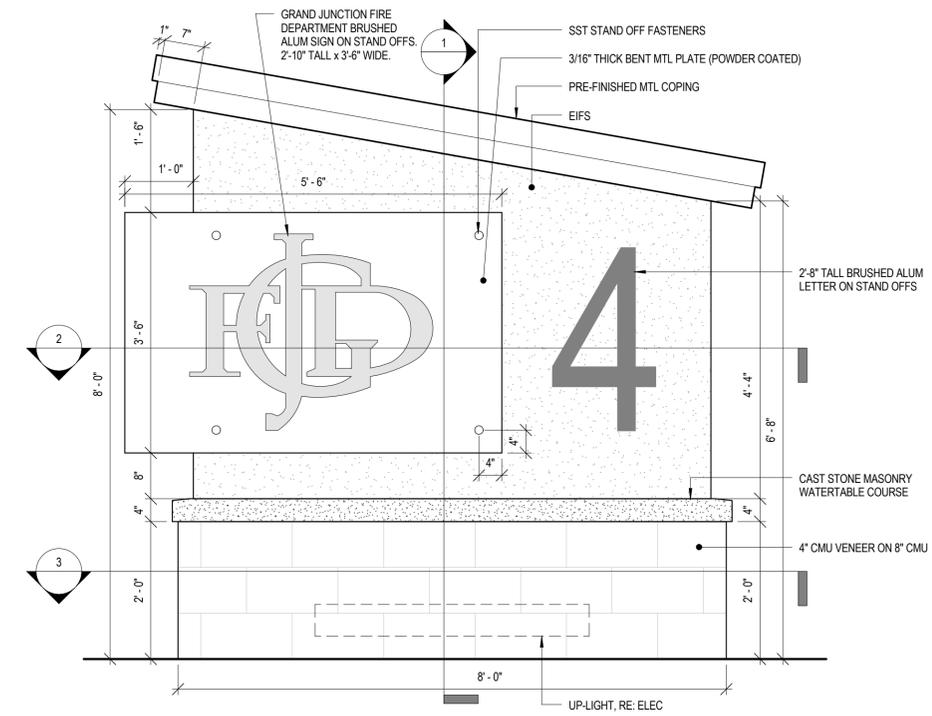

3 MONUMENT SIGN WATER TABLE DETAIL
A604

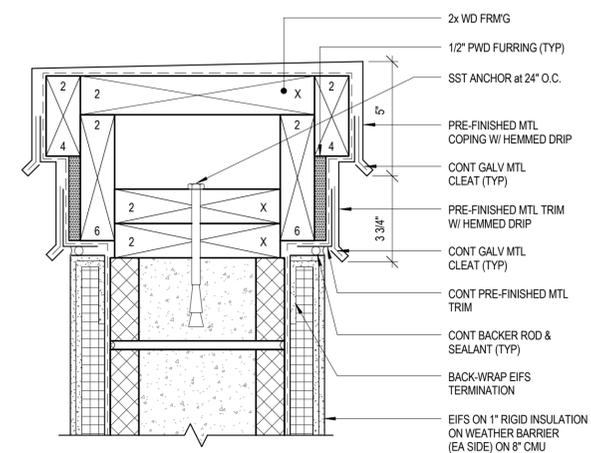

2 MONUMENT SIGN COPING DETAIL
A604



1 MONUMENT SIGN
A604

ORCHARD MESA FIRE STATION #4

GRAND JUNCTION, COLORADO

MONUMENT SIGN DETAILS


NO: ISSUED FOR: DATE:

PROJECT STATUS: 100% CDs

DRAWN BY: Author CHECKED BY: Checker

DATE: 04/10/2015 SHEET NO:

PROJECT NO: 1443 A604

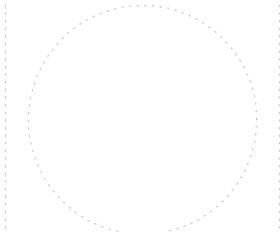

ORCHARD MESA FIRE STATION #4

GRAND JUNCTION, COLORADO

CASEWORK DETAILS

NO: ISSUED FOR: DATE:









PROJECT STATUS: 100% CDs

DRAWN BY: Author CHECKED BY: Checker

DATE: 04/10/2015 SHEET NO:

PROJECT NO: 1443 **A621**

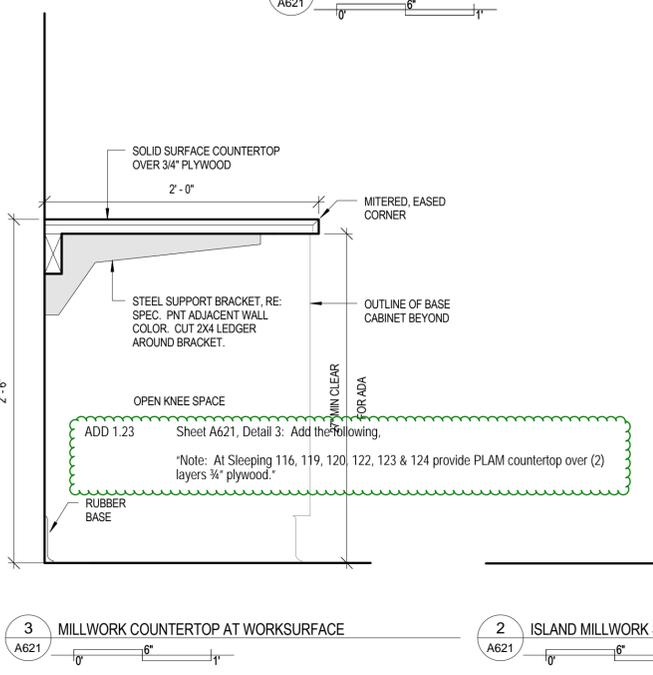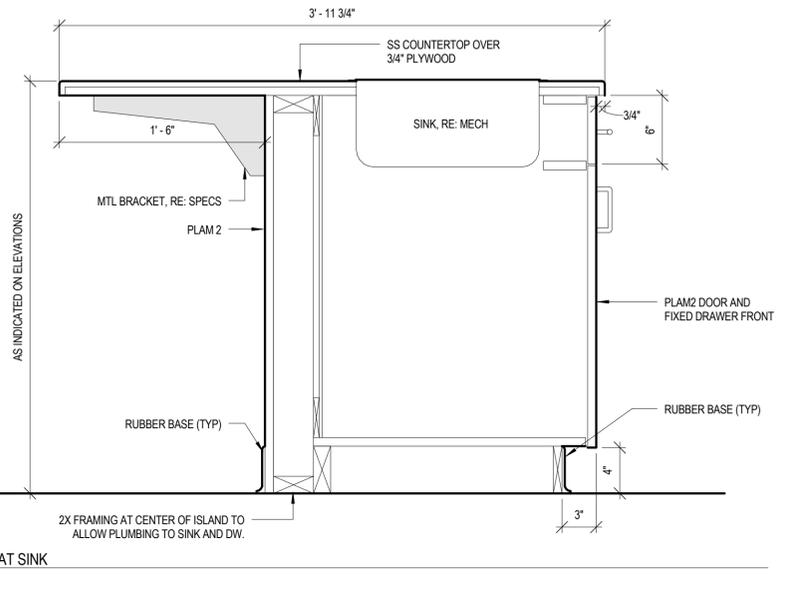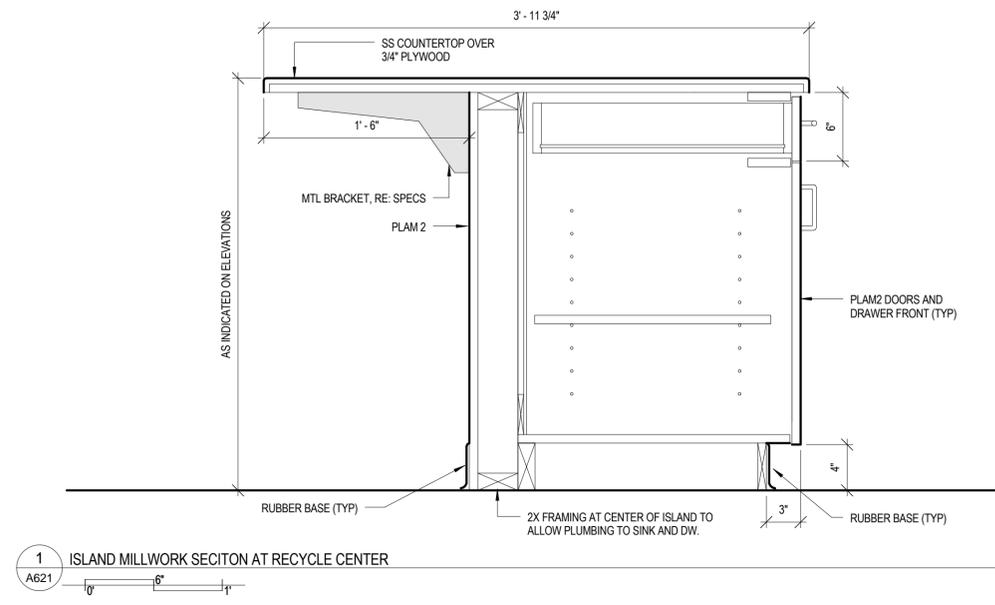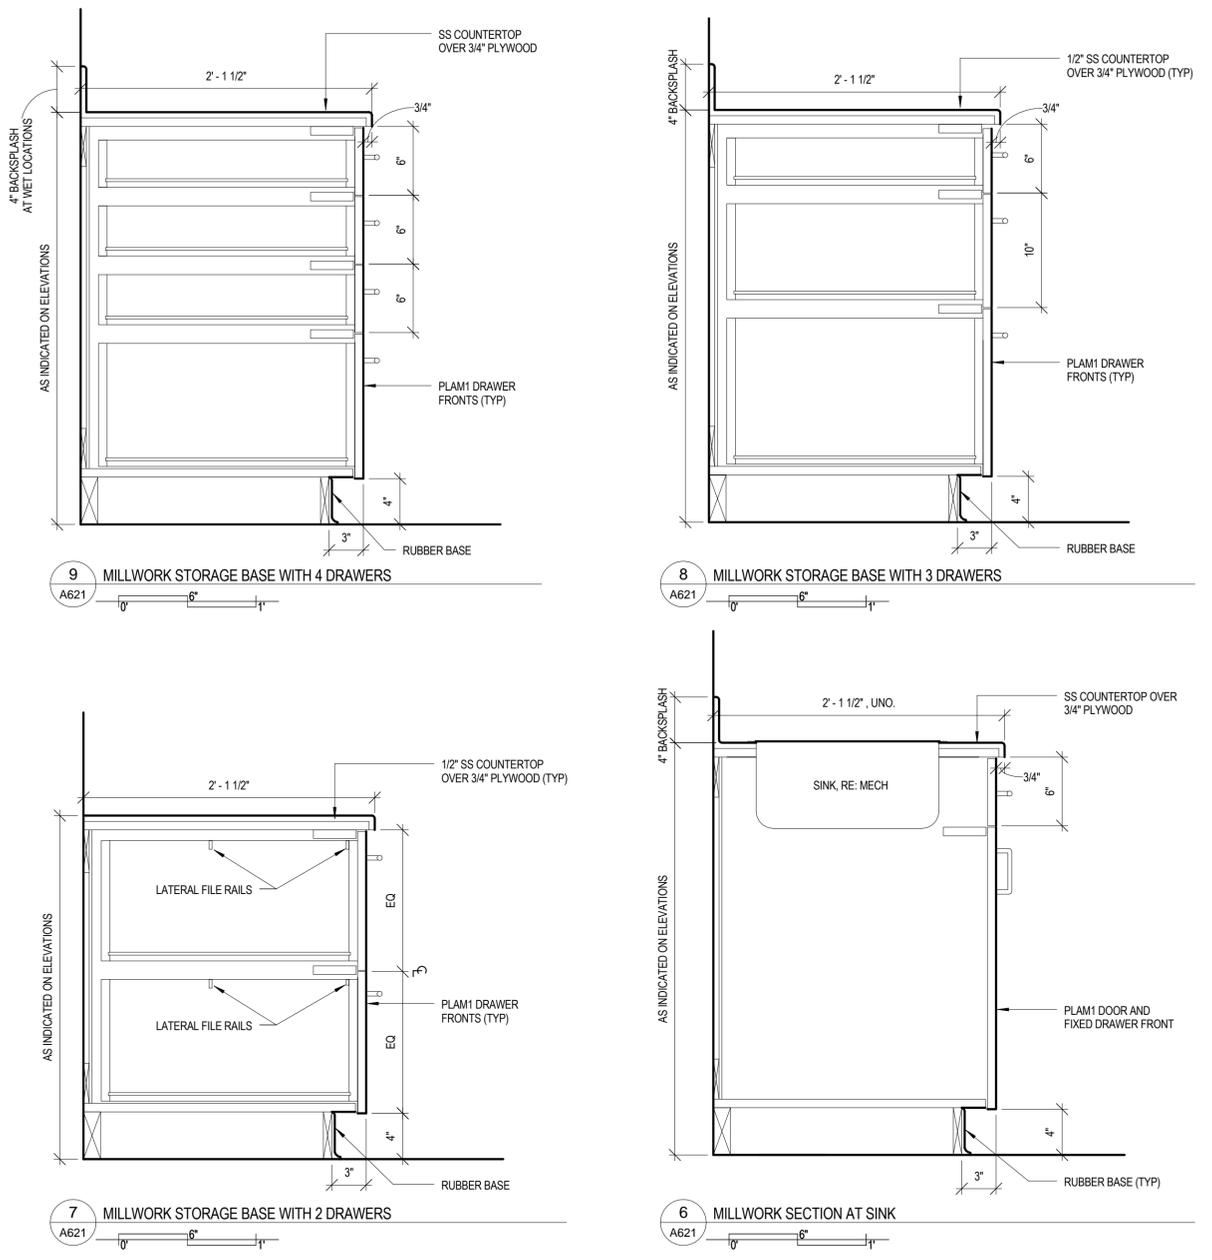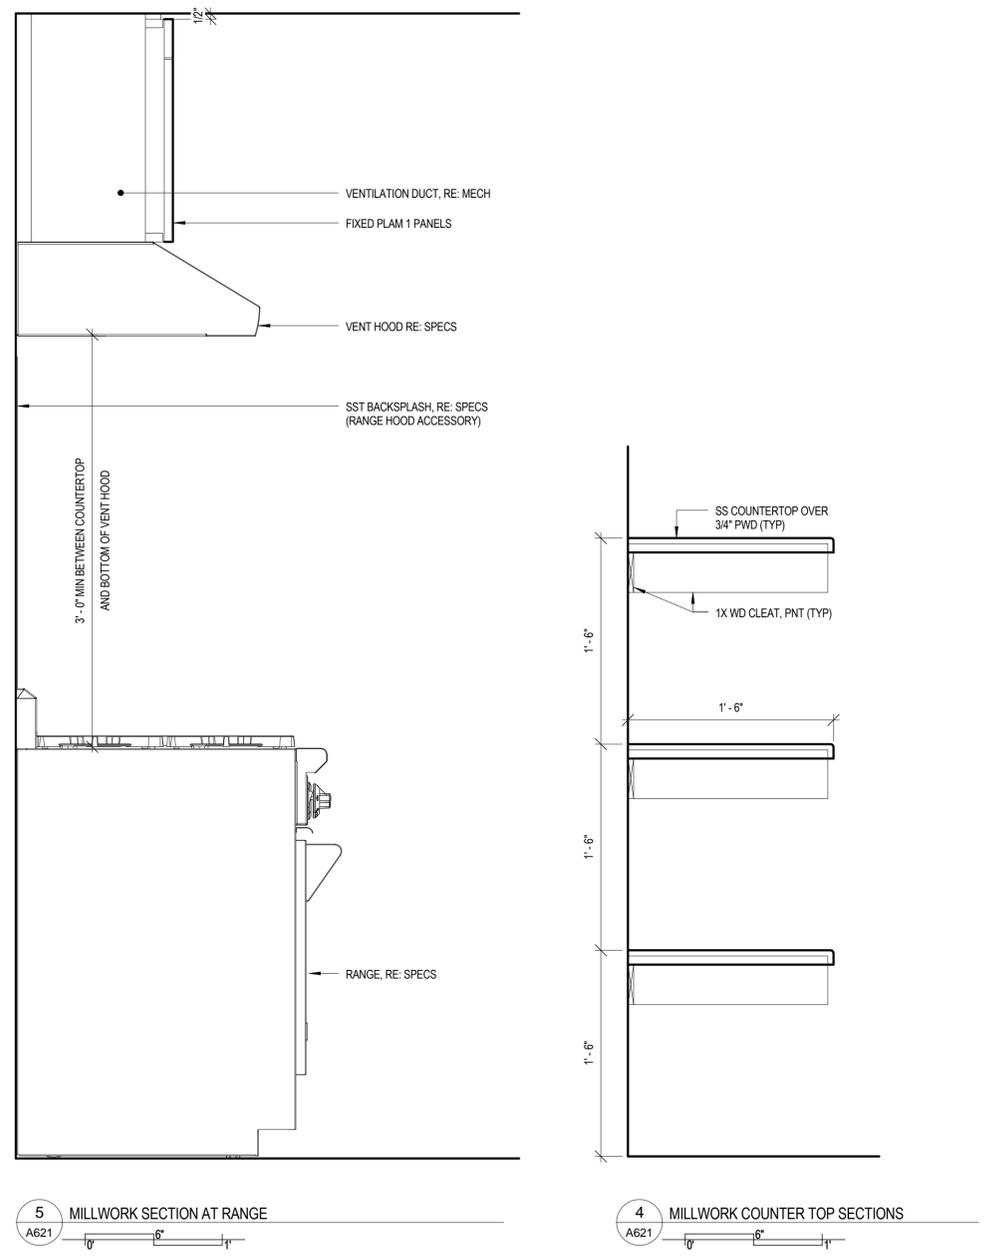

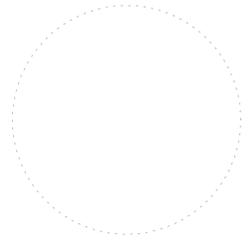

ORCHARD MESA
FIRE STATION #4

GRAND JUNCTION, COLORADO

CASEWORK
SECTIONS

NO: ISSUED FOR: DATE:








PROJECT STATUS: 100% CDs

DRAWN BY: Author CHECKED BY: Checker

DATE:
04/10/2015 SHEET NO:

PROJECT NO:
1443 **A622**

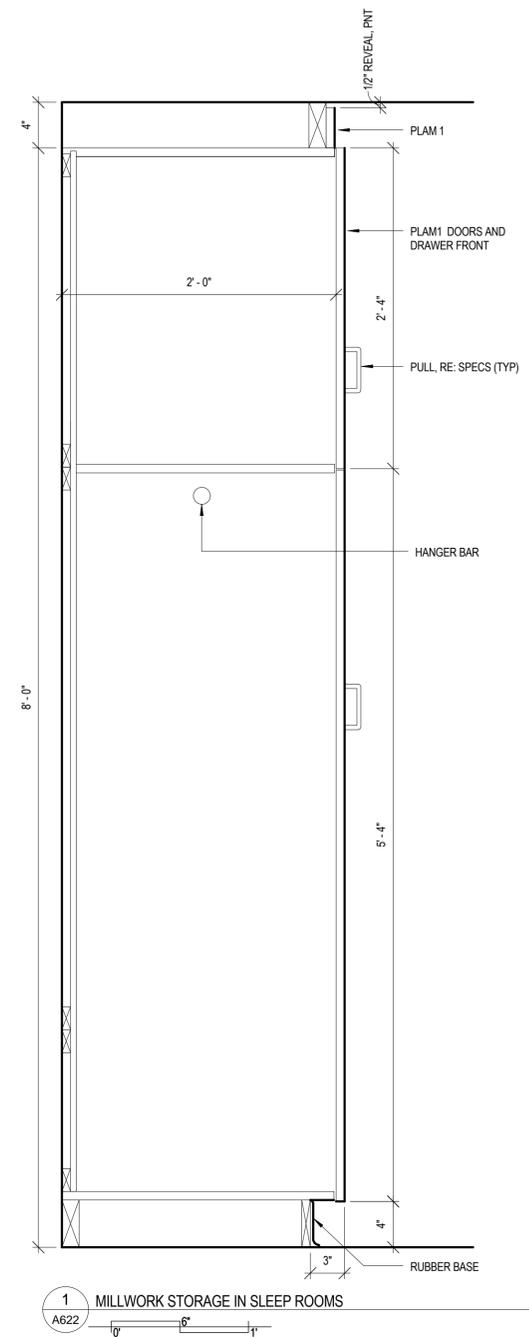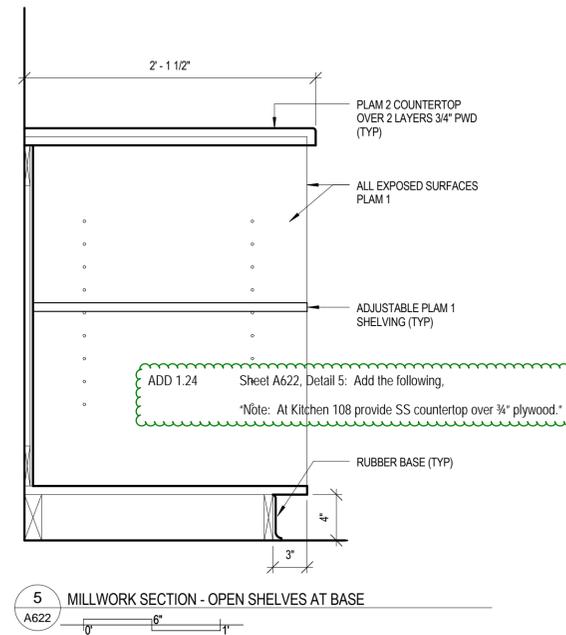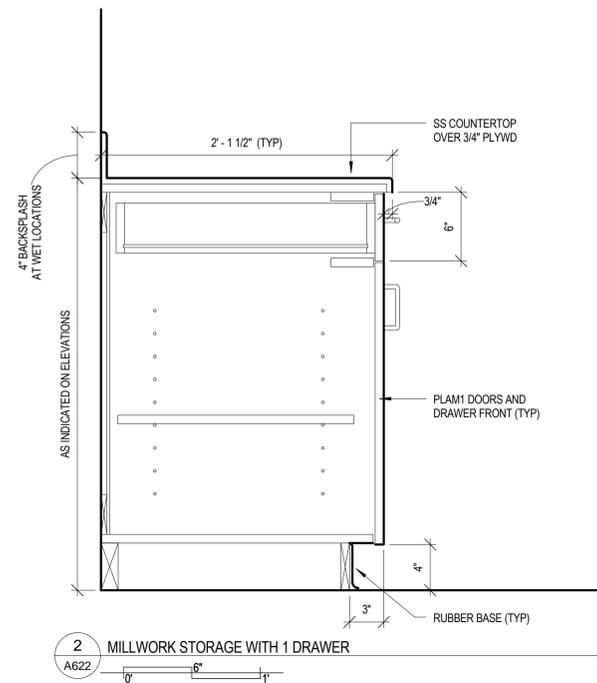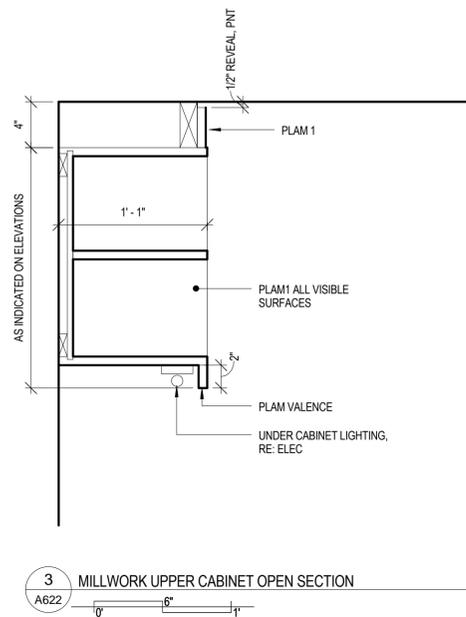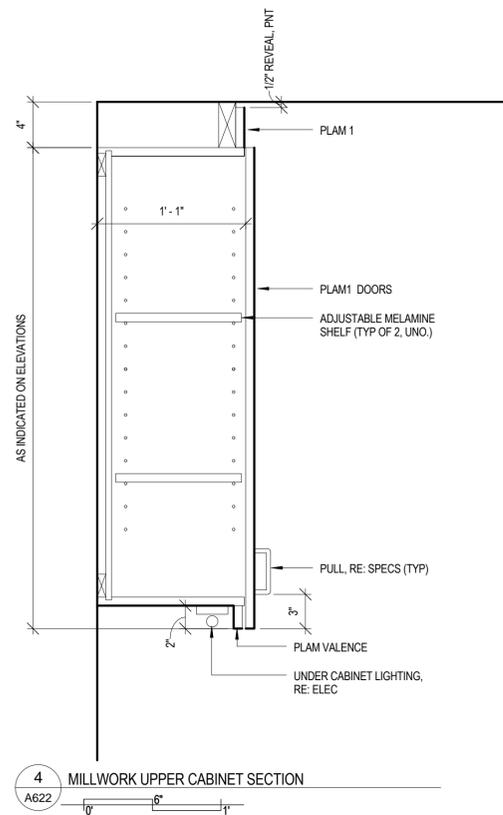

PROPOSAL REQUEST

FIELD OWNER ARCHITECT CONTRACTOR

PROJECT: Orchard Mesa Fire Station #4
 OWNER: City of Grand Junction
 TO: FCI Constructors, Inc.

PROPOSAL REQUEST NO: Two (2)
 DATE: June 5, 2015
 ARCHITECTS PROJECT NO: 1443
 CONTRACT DATED:

Please submit an itemized quotation for changes in the Contract Sum and/or Time incident to proposed modifications to the Contract Documents described herein.


THIS IS NOT A CHANGE ORDER NOR A DIRECTION TO PROCEED WITH THE WORK DESCRIBED HEREIN.

- Description:
- Specification Section 087100, Door Hardware, Hardware Group No. 01 (Door 101A), delete the following hardware:
 - 1 EA Surface Auto Operator 4642 WIMS
 - 1 EA Weather Ring 8310-800
 - 2 EA Actuator, Wall Mount 8310-856T
 - 2 EA Flush Mount Box 8310-860F
 - 1 EA Escutcheon 8310-874
 - Specification Section 087100, Door Hardware, Hardware Group No. 01, add the following hardware:
 - 1 EA OH Stop 100S ADJ US28 IV
 - 1 EA Surface Closure 4040XP EDA 689 LCN
 - 1 EA PA Mounting Plate 4040XP-16PA AS REOD 689 LCN
 - Specification Section 087100, Door Hardware: Add the following: Hardware Group No. 19
 For use on mark-door #(s): 135
 EACH TO HAVE:

QTY	Description	Catalog Number	FIN	Mfr
6 EA	Hinges	3CB1 4.5 X 4.5 NRP	630	IV
2 EA	Manual Flush BoltFB458	626	IV	
1 EA	Dust Proof Strike	DP2	626	IV
1 EA	Deadbolt	827-7-STK	626	BE
1 EA	Construction Core	GREEN CONSTRUCTION CORE		BE
1 EA	Astragal	178SA	AL	NGP
1 SET	Smoke Seal	S89 D 19'		PE
1 EA	Door Bottom Sweep	315 CN 60'		PE
1 EA	Threshold	270 A 60'		PE
 - Sheet A701, Door Schedule, Door No. 135: Add "18" in the HW SET column.

Attachments: none

ARCHITECT: Chamberlin Architects, P.C.
 BY: Jonathan West
 S:\1443 - Orchard Mesa Fire Station #4.c CONSTRUCTION\PROPOSAL REQUESTS\PR#02.1443.doc

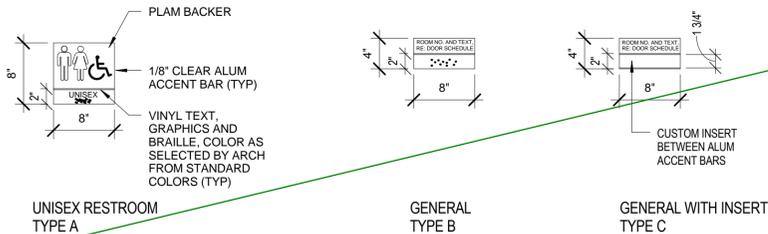

4 SIGN TYPES
A701

ADD 1.25 Sheet A701, Door Types: Add the following.
 General Note: Exterior door types C & F to receive 1-inch insulated glazing.

DOOR NO.	DOOR										FRAME			HDWR SET	NOTES	SIGNAGE	
	W	H	T	MATERIAL	TYPE	FIRE RATING	MATERIAL	TYPE	DETAIL			SIGN TYPE	TEXT				
									JAMB	HEAD	SILL						
101A	3'-0"	7'-0"	1'3/4"	AL	C		AL	AL3	RE: 3/A701	RE: 3/A701	18/A702	01					
102	3'-0"	7'-0"	1'3/4"	WD	C		HM	1	6/A702	5/A702	16/A702	08		C	CAPTAINS OFFICE 102		
103A	3'-0"	7'-0"	1'3/4"	WD	A		HM	1	6/A702	5/A702	-	08		C	OFFICE 103		
103B	3'-0"	7'-0"	1'3/4"	HM	A		HM	2	10/A702	9/A702	-	09		C	OFFICE 103		
104	3'-0"	7'-0"	1'3/4"	WD	A		HM	1	6/A702	5/A702	-	16		B	PANTRY 104		
105	3'-0"	7'-0"	1'3/4"	WD	A		HM	1	6/A702	5/A702	17/A702	13		A			
107	3'-0"	7'-0"	1'3/4"	AL	C		AL	AL4	RE: 3/A701	RE: 3/A701	19/A702	01.01					
109	3'-0"	7'-0"	1'3/4"	WD	A		HM	1	6/A702	5/A702	-	03					
110	3'-0"	7'-0"	1'3/4"	HM	A		HM	1	6/A702	5/A702	-	04					
111	3'-0"	7'-0"	1'3/4"	HM	A		HM	1	6/A702	5/A702	-	10					
112A	3'-0"	7'-0"	1'3/4"	WD	A		HM	1	6/A702	5/A702	16/A702	05					
112B	3'-0"	7'-0"	1'3/4"	HM	F		HM	1	2/A702	1/A702	15/A702	02					
112C	3'-0"	7'-0"	1'3/4"	HM	F		HM	1	2/A702	1/A702	15/A702	02					
113	3'-0"	7'-0"	1'3/4"	WD	A		HM	1	6/A702	5/A702	14/A702	14		B	SHOWER & TOILET 113		
114	3'-0"	7'-0"	1'3/4"	WD	A		HM	1	6/A702	5/A702	14/A702	14		B	SHOWER & TOILET 114		
115	3'-0"	7'-0"	1'3/4"	WD	A		HM	1	6/A702	5/A702	14/A702	14		B	SHOWER & TOILET 115		
116	3'-0"	7'-0"	1'3/4"	WD	A	20-MIN	HM	1	6/A702	5/A702	-	15					
119	3'-0"	7'-0"	1'3/4"	WD	A	20-MIN	HM	1	6/A702	5/A702	-	15					
120	3'-0"	7'-0"	1'3/4"	WD	A	20-MIN	HM	1	6/A702	5/A702	-	15					
121	3'-0"	7'-0"	1'3/4"	WD	A		HM	1	6/A702	5/A702	16/A702	16		B	LAUNDRY 121		
122	3'-0"	7'-0"	1'3/4"	WD	A	20-MIN	HM	1	6/A702	5/A702	-	15					
123	3'-0"	7'-0"	1'3/4"	WD	A	20-MIN	HM	1	6/A702	5/A702	-	15					
124	3'-0"	7'-0"	1'3/4"	WD	A	20-MIN	HM	1	6/A702	5/A702	-	15					
125A	3'-0"	7'-0"	1'3/4"	WD	A		HM	2	10/A702	9/A702	16/A702	03					
125B	3'-0"	7'-0"	1'3/4"	HM	F		HM	2	12/A702	11/A702	15/A702	02					
126	3'-0"	7'-0"	1'3/4"	HM	A		HM	2	8/A702	7/A702	-	12		B	MECHANICAL ROOM 126		
127A	14'-0"	14'-0"	2"	STL	D		STL	-	4/A702	3/A702	-	17					
127B	14'-0"	14'-0"	2"	STL	D		STL	-	4/A702	3/A702	-	17					
128A	14'-0"	14'-0"	2"	STL	D		STL	-	4/A702	3/A702	-	17					
128B	14'-0"	14'-0"	2"	STL	D		STL	-	4/A702	3/A702	-	17					
129A	14'-0"	14'-0"	2"	STL	D		STL	-	4/A702	3/A702	-	17					
129B	14'-0"	14'-0"	2"	STL	D		STL	-	4/A702	3/A702	-	17					
130	3'-0"	7'-0"	1'3/4"	HM	A		HM	2	8/A702	7/A702	-	03		B	SCBA REPAIR 130		
131	3'-0"	7'-0"	1'3/4"	HM	A		HM	2	8/A702	7/A702	-	11		B	ELECTRICAL ROOM		
132A	3'-0"	7'-0"	1'3/4"	HM	A		HM	2	8/A702	7/A702	13/A702	06		B	FITNESS 132		
132B	12'-0"	8'-0"	2"	STL	E		STL	-	4/A702 SIM	3/A702 SIM	-	17					
135	5'-0"	7'-0"	1'3/4"	HM	B		HM	2	12/A702	11/A702	20/A702	02.01					
136A	3'-0"	7'-0"	1'3/4"	HM	A		HM	2	12/A702	11/A702	15/A702	02.01					
136B	8'-0"	8'-0"	2"	STL	E		STL	-	4/A702	3/A702	-	17					
137	6'-0"	7'-0"	1'3/4"	HM	A		HM	2	8/A702	7/A702	-	07		B	STORAGE 137		

PROPOSAL REQUEST

FIELD OWNER ARCHITECT CONTRACTOR

PROJECT: Orchard Mesa Fire Station #4
 OWNER: City of Grand Junction
 TO: FCI Constructors, Inc.

PROPOSAL REQUEST NO: Six (6)
 DATE: July 16, 2015
 ARCHITECTS PROJECT NO: 1443
 CONTRACT DATED: December 18, 2014


Please submit an itemized quotation for changes in the Contract Sum and/or Time incident to proposed modifications to the Contract Documents described herein.

THIS IS NOT A CHANGE ORDER NOR A DIRECTION TO PROCEED WITH THE WORK DESCRIBED HEREIN.

- Description:
- Change Door 132B from "Electric Door Operator" to "Manual Chain Operation".
 - Change Door 136B from "Electric Door Operator" to "Manual Chain Operation".
 - Provide shop-applied (factory) urethane finish at doors 127A, 127B, 128A, 128B, 129A and 129B (exterior face only). Color to match Sherwin Williams SW 7563, Regis Ecol. Contractor's option to provide either single stage (color & clearcoat mixed together) or 2-stage (color & clearcoat separate) finish.
- Manufacturer's Tan


Attachments: none

ARCHITECT: Chamberlin Architects, P.C.
 BY: Jonathan West
 S:\1443 - Orchard Mesa Fire Station #4.c CONSTRUCTION\PROPOSAL REQUESTS\PR#06.1443.doc

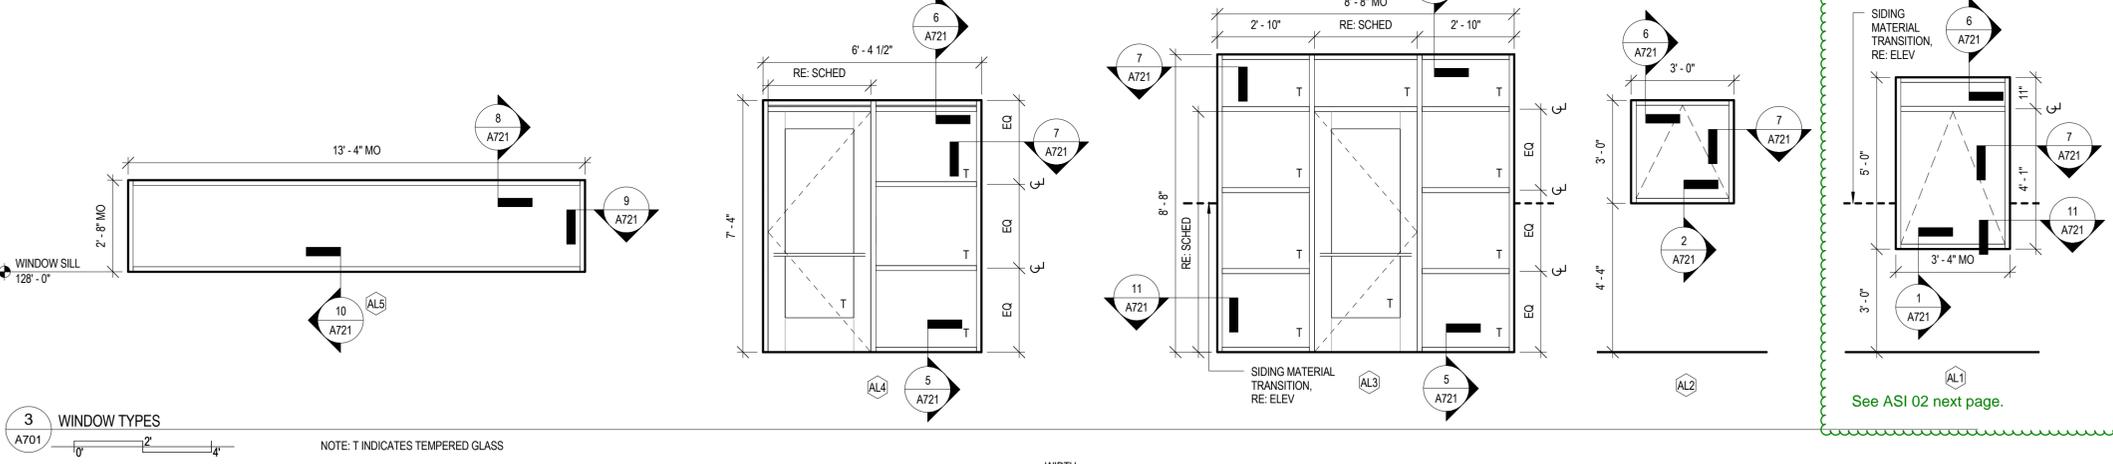


3 WINDOW TYPES
A701



NOTE: T INDICATES TEMPERED GLASS

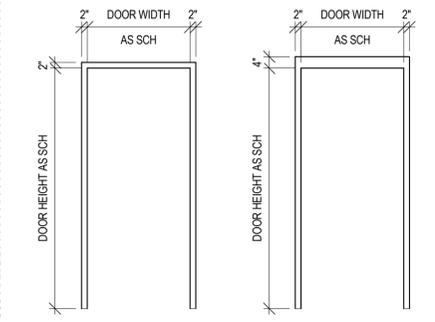

1 FRAME TYPES
A701

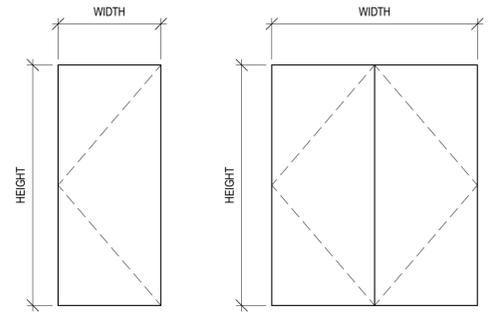

2 DOOR TYPES
A701

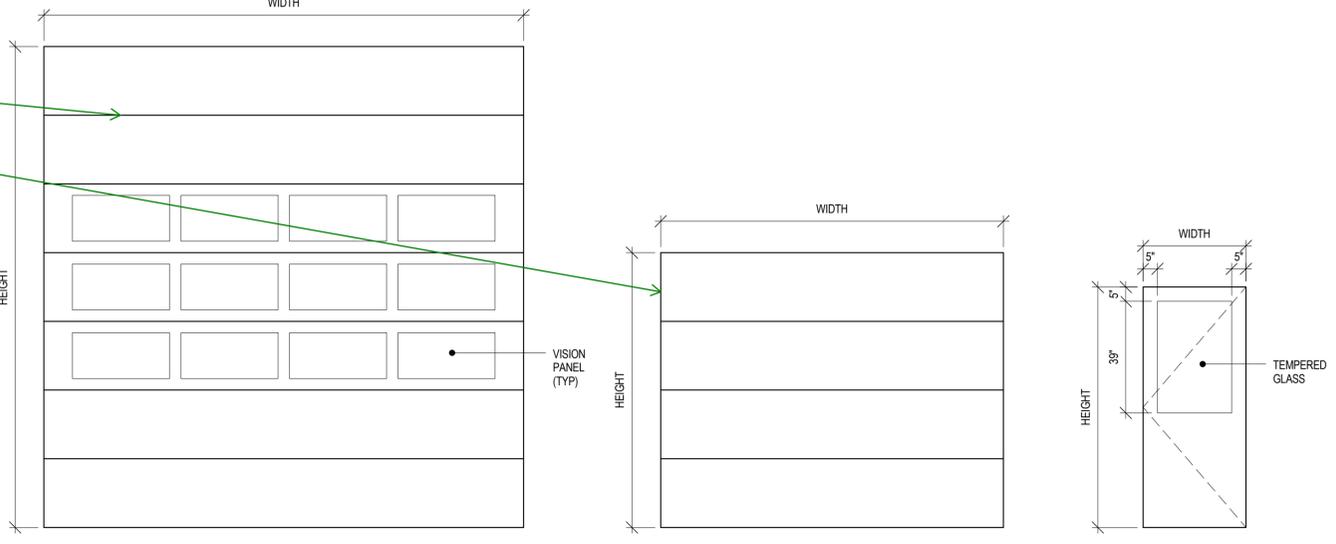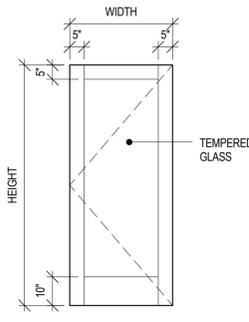

CHAMBERLIN ARCHITECTS
 437 Main St.
 Grand Junction, Colorado 81501
 T 970.242.6804
 725 Saint Joseph St., Suite B1
 Rapid City, South Dakota 57701
 T 605.355.6804
 www.chamberlinarchitects.com

ORCHARD MESA FIRE STATION #4

GRAND JUNCTION, COLORADO

DOOR SCHEDULE, FRAME, DOOR, WINDOW & SIGN TYPES

NO: ISSUED FOR: DATE:

PROJECT STATUS: 100% CDs

DRAWN BY: Author CHECKED BY: Checker

DATE: 04/10/2015 SHEET NO:

PROJECT NO: 1443 **A701**

ARCHITECT'S SUPPLEMENTAL INSTRUCTIONS

OWNER
ARCHITECT
CONTRACTOR
FIELD
OTHER

PROJECT: Orchard Mesa Fire Station #4
OWNER: City of Grand Junction
TO: FCI Constructors, Inc.
3070 I-70 B, Bldg A
Grand Junction, CO 81504

ARCHITECT'S SUPPLEMENTAL INSTRUCTION NO: Two (2)
ARCHITECT: Chamberlin Architects
437 Main Street
Grand Junction, CO 81501
ARCHITECT'S PROJECT NO: 1443
DATE OF ISSUANCE: July 13, 2015


The Work shall be carried out in accordance with the following supplemental instructions issued in accordance with the Contract Documents without change in Contract Sum or Contract Time. Proceeding in accordance with these instructions indicates your acknowledgment that there will be no change in the Contract Sum or Contract Time.

Add FLOOR PLAN – CASEMENT SWING as illustrated in the attached Sketch ASK-5 dated 7/13/15. This sketch is issued as a supplement to our response to RFI#011.

Add "limiting block" to keep window at Sleeping 124 from interfering with adjacent door swing and egress route.

Attachments: ASK-5

ARCHITECT: Chamberlin Architects, P.C.
BY: Jonathan West
S:\1443 - Orchard Mesa Fire Station #4\6. CONSTRUCTION\AS\AS1#002.1443.doc

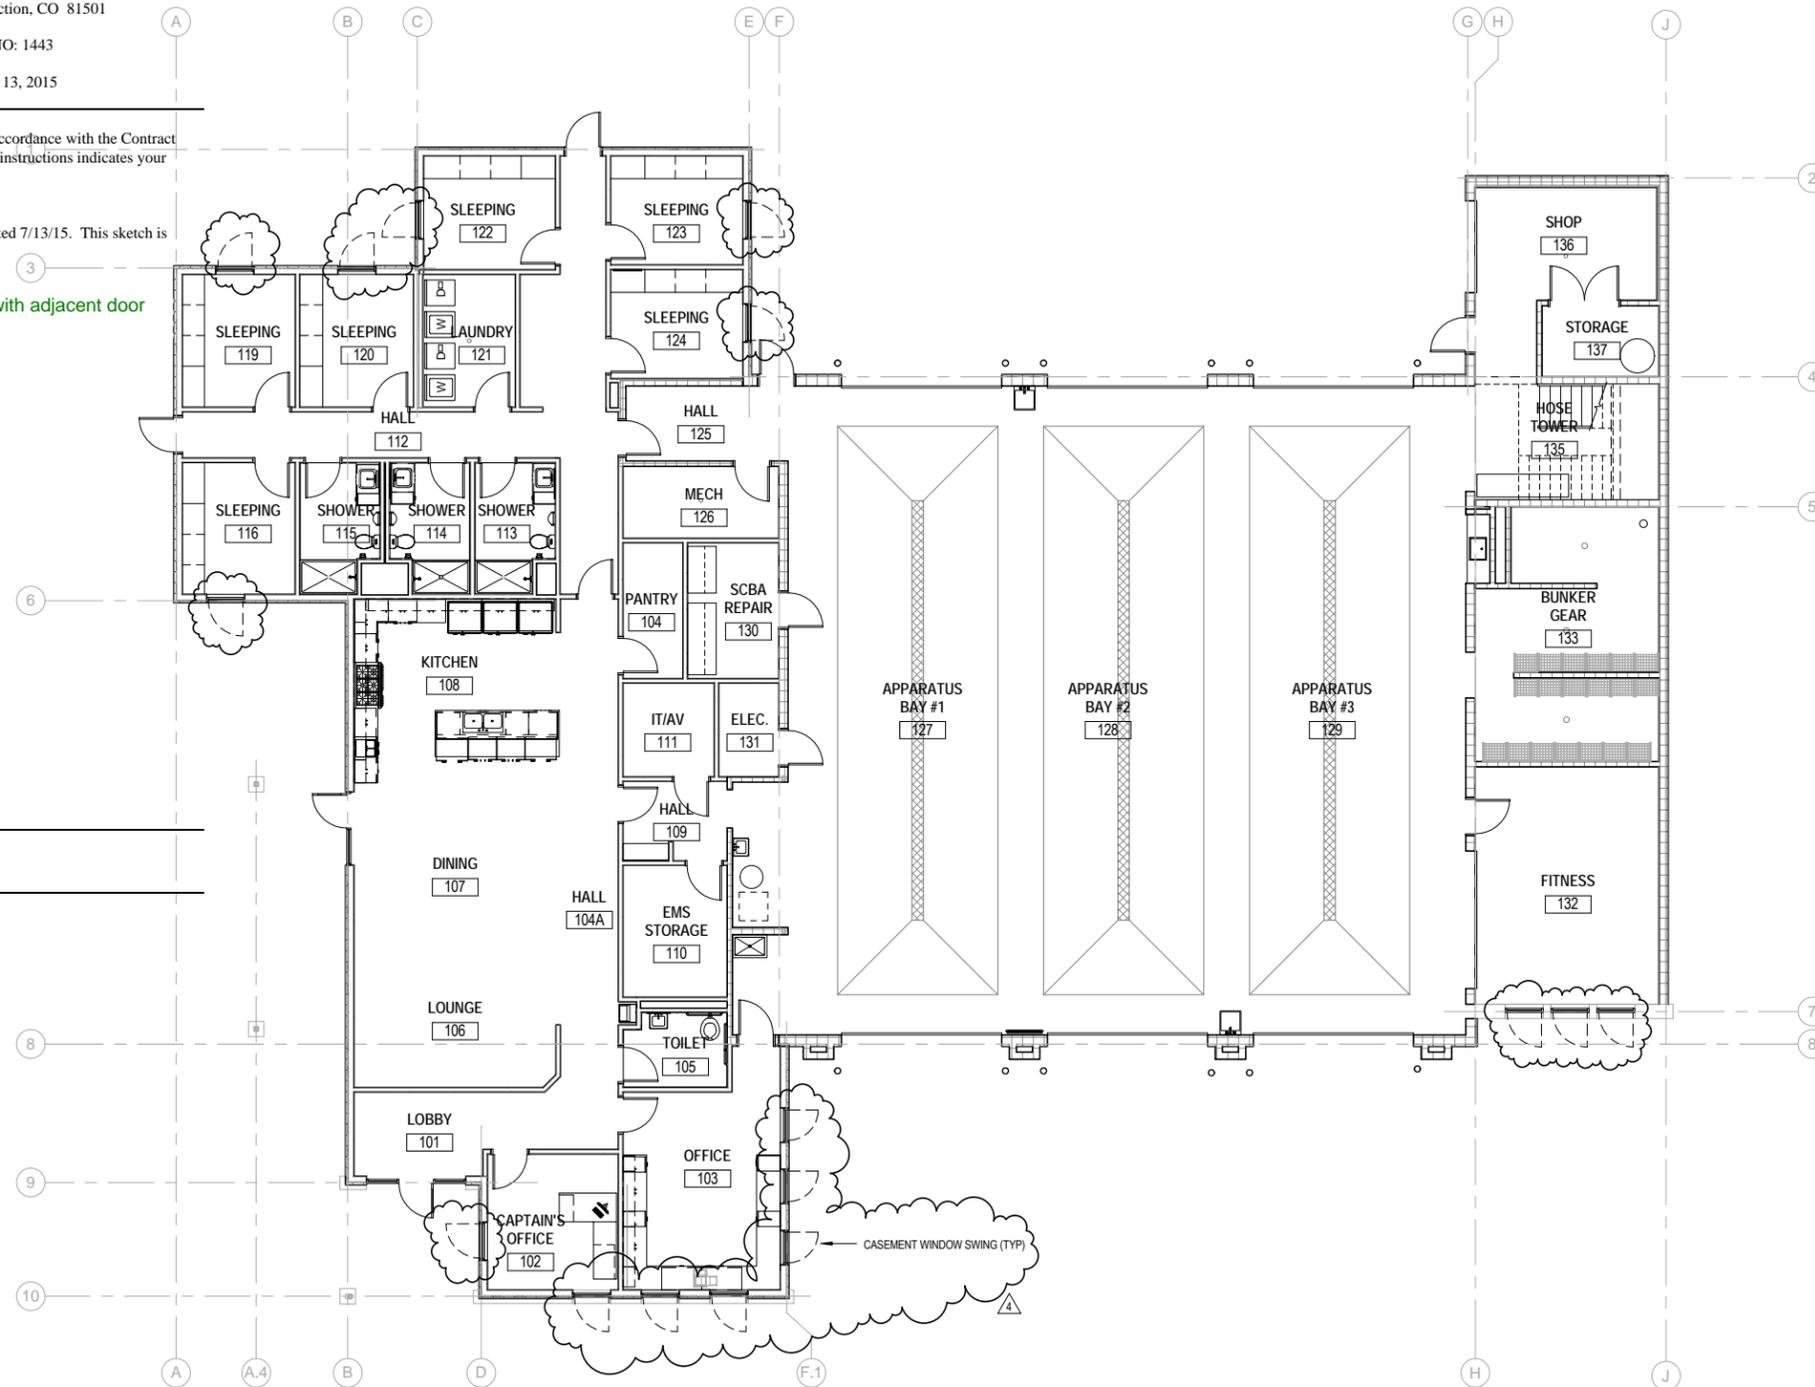

1 FLOOR PLAN - CASEMENT SWING
ASK-5

CHAMBERLIN ARCHITECTS
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725 Saint Joseph St., Suite B1
Rapid City, South Dakota 57701
T 605.355.6804
www.chamberlinarchitects.com

ORCHARD MESA FIRE STATION #4

GRAND JUNCTION, COLORADO

FLOOR PLAN - CASEMENT SWING

NO: ASI#002
ISSUED FOR:
DATE: 7/13/15

PROJECT STATUS: 100% CDs

DRAWN BY: JW CHECKED BY: Checker

DATE: 05/27/2015 SHEET NO:

PROJECT NO: 1443 **ASK-5**

ORCHARD MESA FIRE STATION #4

GRAND JUNCTION, COLORADO

DOOR DETAILS


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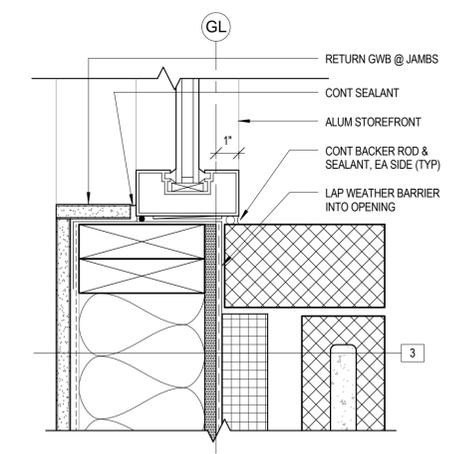
PROJECT STATUS: 100% CDs

DRAWN BY: Author CHECKED BY: Checker


DATE: 04/10/2015 SHEET NO:

PROJECT NO: 1443 **A702**




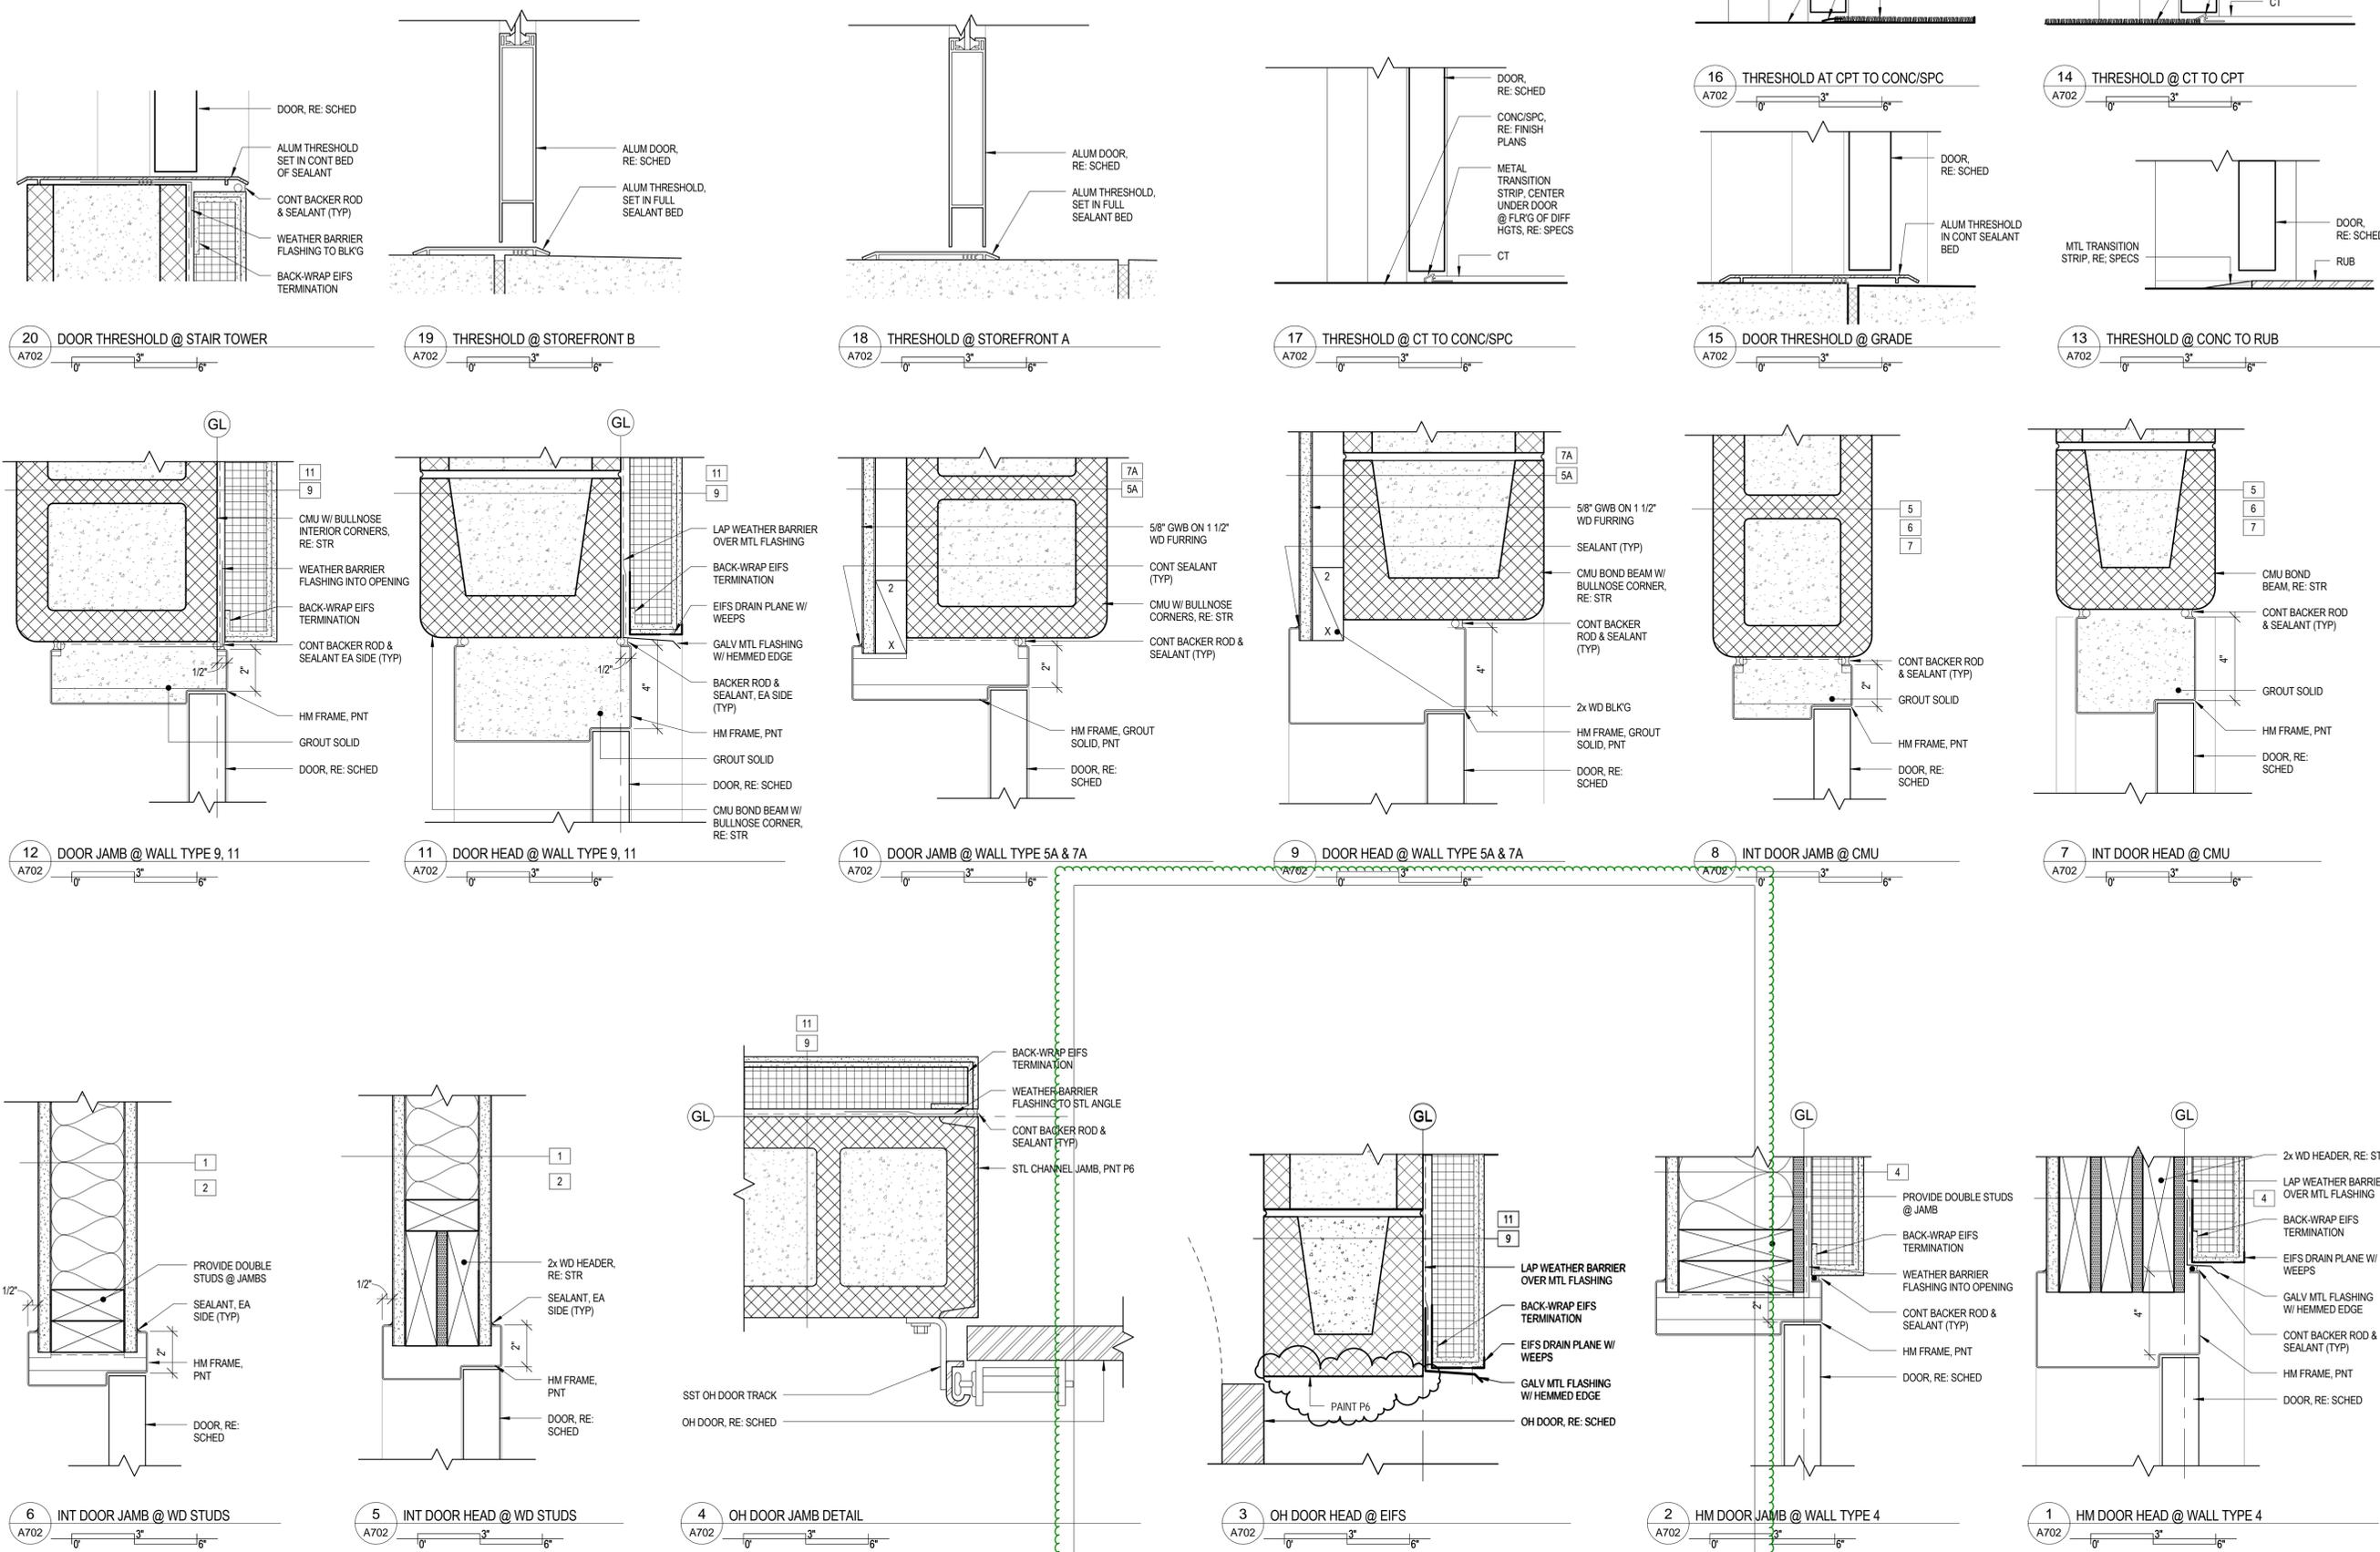


11 WINDOW JAMB DETAIL @ WALL TYPE 3
A721 0' 3' 6'

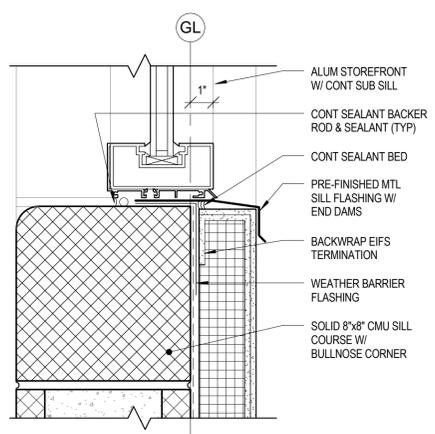


10 WINDOW SILL DTL @ WALL TYPE 9
A721 0' 3' 6'

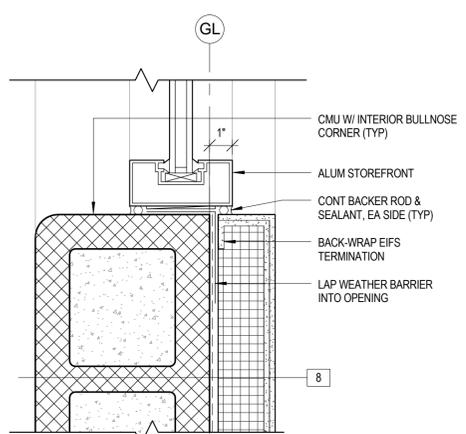


9 WINDOW JAMB DTL @ WALL TYPE 9
A721 0' 3' 6'

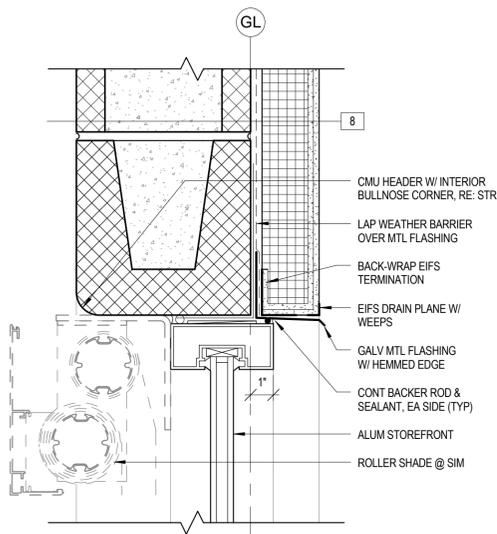


8 WINDOW HEAD DTL @ WALL TYPE 9
A721 0' 3' 6'

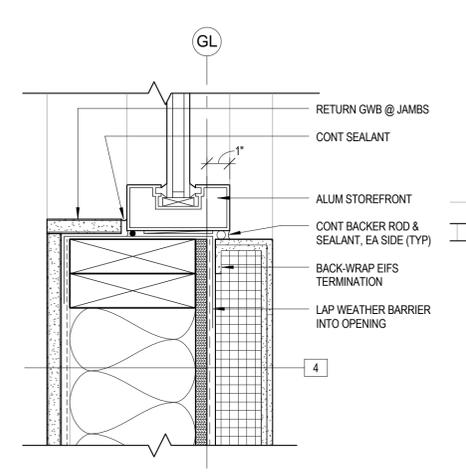


7 WINDOW JAMB DTL @ WALL TYPE 4
A721 0' 3' 6'

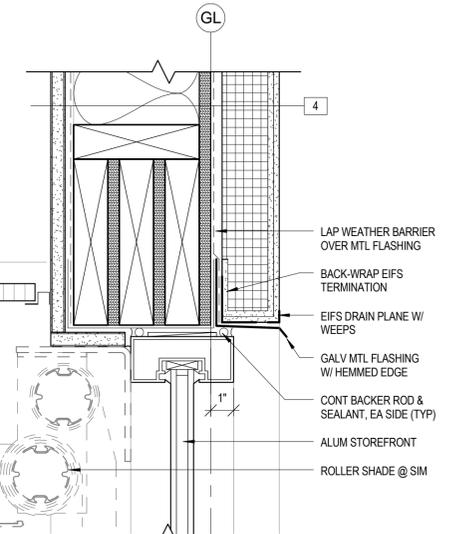


6 WINDOW HEAD DTL @ WALL TYPE 4
A721 0' 3' 6'

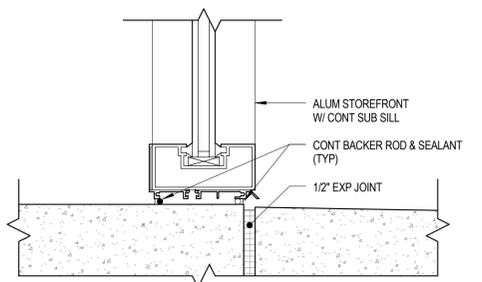


5 STOREFRONT SILL DETAIL @ GRADE
A721 0' 3' 6'

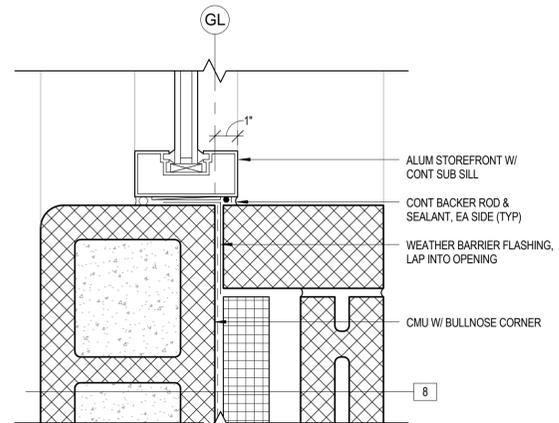


4 WINDOW JAMB DTL @ WALL TYPE 10
A721 0' 3' 6'

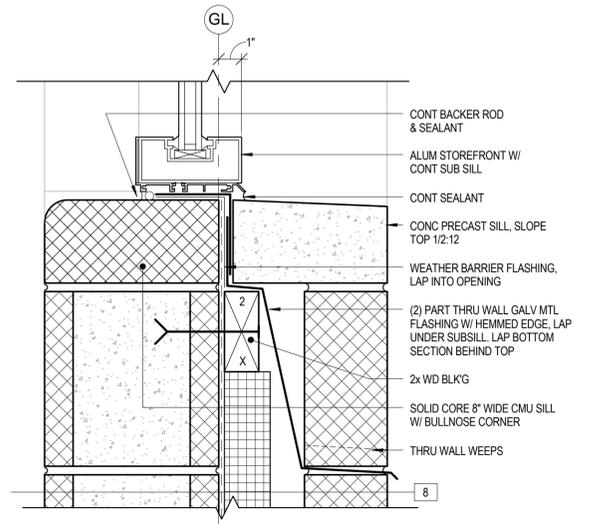


3 WINDOW SILL DTL @ WALL TYPE 8
A721 0' 3' 6'

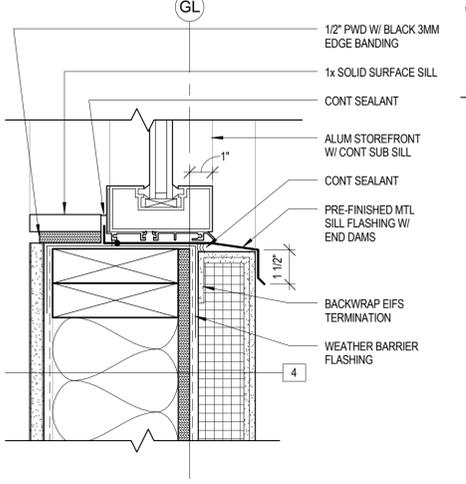

2 WINDOW SILL DTL @ WALL TYPE 4
A721 0' 3' 6'

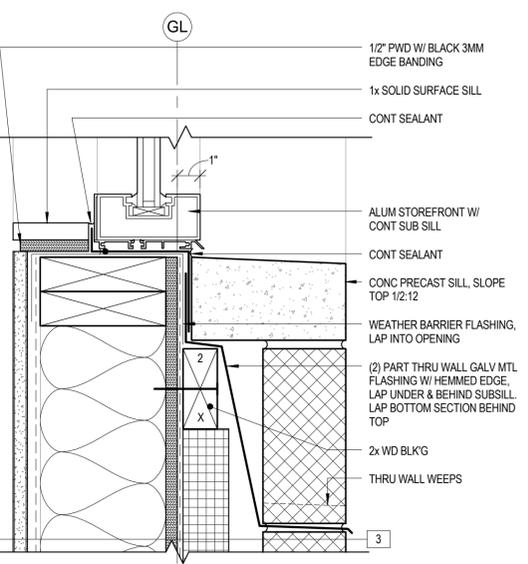

1 WINDOW SILL DTL @ WALL TYPE 3
A721 0' 3' 6'

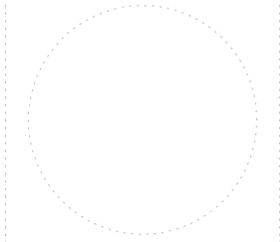

ORCHARD MESA FIRE STATION #4

GRAND JUNCTION, COLORADO

WINDOW DETAILS

NO: ISSUED FOR: DATE:



PROJECT STATUS: 100% CDs

DRAWN BY: JW CHECKED BY: Checker

DATE: 04/10/2015 SHEET NO:

PROJECT NO: 1443 A721

COLOR REVIEW AND APPROVAL: THE COLOR SCHEDULES IN THE DRAWINGS INDICATE THE INITIAL COLOR SELECTIONS FOR THE PROJECT. BECAUSE OF THE POTENTIAL FOR PRODUCT SUBSTITUTIONS AND DISCONTINUATION OF COLORS, FINAL COLOR SELECTIONS WILL BE MADE BY THE ARCHITECT ONLY AFTER ALL COLOR SUBMITTALS HAVE BEEN RECEIVED FROM THE CONTRACTOR. SEE DIVISION 01 SPECIFICATIONS SECTION "SUBMITTAL PROCEDURES".


CHAMBERLIN ARCHITECTS
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Grand Junction, Colorado 81501
T 970.242.6804
725 Saint Joseph St., Suite B1
Rapid City, South Dakota 57701
T 605.355.6804
www.chamberlinarchitects.com

Table with 4 columns: SPECIFICATION SECTION, NUMBER, TITLE, ITEM, COLOR. Rows include items like POLISHED CONCRETE FINISHING, INTERIOR ARCHITECTURAL MILLOWRK, HOLLOW METAL DOORS AND FRAMES, etc.

Table with 4 columns: SPECIFICATION SECTION, NUMBER, TITLE, ITEM, COLOR. Rows include items like CAST IN PLACE CONCRETE, CONCRETE UNIT MASONRY, CAST STONE MASONRY, etc.

ARCHITECT'S SUPPLEMENTAL INSTRUCTIONS. PROJECT: Orchard Mesa Fire Station #4. OWNER: City of Grand Junction. TO: FCI Constructors, Inc. Includes project details and a note about interior finish plan.

ARCHITECT'S SUPPLEMENTAL INSTRUCTIONS. PROJECT: Orchard Mesa Fire Station #4. OWNER: City of Grand Junction. TO: FCI Constructors, Inc. Includes project details and a list of changes to the color schedule.

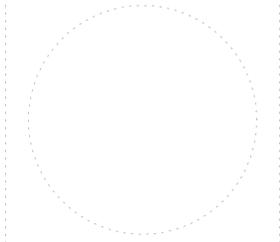

ORCHARD MESA FIRE STATION #4

GRAND JUNCTION, COLORADO
COLOR SCHEDULE

NO: ISSUED FOR: DATE:
A series of empty boxes for tracking.

PROJECT STATUS: 100% CDs
DRAWN BY: JW CHECKED BY: Checker


DATE: 04/10/2015 SHEET NO:
PROJECT NO: 1443 A741

SPECIAL INSPECTIONS:
A. SPECIAL INSPECTIONS SHALL COMPLY WITH CHAPTER 17 OF THE 2012 I.B.C.
B. STATEMENT OF REQUIRED SPECIAL INSPECTIONS:

SYSTEM OF COMPONENT	VERIFICATION OF INSPECTION TASK	FREQUENCY (DURING TASK LISTED)		APPLICABLE CODE & SECTION FOR INSPECTION CRITERIA
		CONTINUOUS	PERIODIC	
1) SOILS	a) VERIFY SOILS BELOW SHALLOW FOUNDATIONS ARE ADEQUATE TO ACHIEVE THE DESIGN BEARING CAPACITY.	--	X	--
	b) VERIFY EXCAVATIONS ARE EXTENDED TO PROPER DEPTH & HAVE REACHED PROPER MATERIAL	--	X	--
	c) PERFORM CLASSIFICATION & TESTING OF CONTROLLED FILL MATERIALS	--	X	--
	d) VERIFY USE OF PROPER MATERIALS, DENSITIES AND LIFT THICKNESS DURING PLACEMENT & COMPLETION OF CONTROLLED FILL	X	--	--
	e) OBSERVE SUBGRADE FOR PROPER PREPARATION BEFORE PLACEMENT OF CONTROLLED FILL	--	X	--
	2) CONCRETE	a) INSPECT REINFORCING STEEL	--	X
	b) VERIFY USE OF REQUIRED DESIGN MIX	--	X	ACI 318: CH. 4, 5.2-5.4 IBC 1904.2
	c) INSPECT REINFORCING STEEL WELDING	--	X	AWS D1.4 ACI 318: 3.5.2
	d) FABRICATE TEST SPECIMENS FROM FRESH CONCRETE FOR STRENGTH TESTS, SLUMP & AIR CONTENT TESTS AND TO DETERMINE CONCRETE TEMPERATURE	X	--	ASTM C172 ASTM C31 ACI 318: 5.6, 5.8
	e) INSPECT CONCRETE PLACEMENT FOR PROPER APPLICATION TECHNIQUES	X	--	ACI 318: 5.9, 5.10
	f) INSPECT FOR MAINTENANCE OF SPECIFIED CURING TEMPERATURE & TECHNIQUES	--	X	ACI 318: 5.11-5.13
	g) INSPECT FORMWORK FOR SHAPE, LOCATION & DIMENSIONS OF CONCRETE MEMBERS BEING FORMED	--	X	ACI 318: 6.1.1
	h) INSPECT ANCHORS CAST INTO CONCRETE.	--	X	ACI 318: 8.1.3, 21.2.8 IBC 1908.5, 1909.1
	i) INSPECT ANCHORS POST-INSTALLED INTO HARDENED CONCRETE MEMBERS.	--	X	ACI 318: 3.8.6, 8.1.3, 21.2.8 IBC 1909.1
3) WOOD	a) INSPECT FABRICATED WOOD STRUCTURAL MEMBERS ASSEMBLED AT FABRICATOR'S SHOP OR PLANT.	--	X	--
	b) VERIFY MATERIAL SPECIES AND GRADES OF DIMENSIONAL LUMBER AND PLYWOOD OR O.S.B.	--	X	--
	c) VERIFY BOTTOM CHORD AND OTHER BRACING OF STRUCTURAL MEMBERS.	--	X	--
	d) INSPECT FOR PROPER FASTENING OF WOOD COMPONENTS.	--	X	IBC TABLE 2304.9.1
4) LATERAL BRACING SYSTEM	a) PERIODICALLY INSPECT NAILING, BOLTING, ANCHORING, AND OTHER FASTENING OF COMPONENTS WITHIN WOOD SHEAR WALLS, WOOD DIAPHRAGMS, DRAG STRUTS, AND HOLDDOWNS.	--	X	--

5) MASONRY	a) VERIFY 1m OF CONCRETE MASONRY UNITS PRIOR TO CONSTRUCTION.	--	X	ACI 530: Art 2.6A
	b) AS MASONRY CONSTRUCTION BEGINS VERIFY THE FOLLOWING TO ENSURE COMPLIANCE: - PROPORTIONS OF SITE -- PREPARED MORTAR	--	X	ACI 530: Art 1.4B
	- CONSTRUCTION OF MORTAR JOINTS	--	X	ACI 530: Art 3.3B
	- LOCATION OF REINFORCEMENT CONNECTORS & ANCHORAGES	--	X	ACI 530: Art 3.4, 3.6A
	c) THE INSPECTION PROGRAM SHALL VERIFY: - SIZE & LOCATION OF STRUCTURAL ELEMENTS	--	X	ACI 530: Art 3.36
	- TYPE, SIZE & LOCATION OF ANCHORS, INCLUDING OTHER DETAILS OF ANCHORAGE OF MASONRY TO STRUCTURAL MEMBERS	--	X	ACI 530: SECTION 1.22(e), 7.1.4, 3.1.6
	- SPECIFIED SIZE, GRADE, AND TYPE OF REINFORCEMENT	--	X	ACI 530: SECTION 1.13, Art 2.4, 3.4
	- WELDING OF REINFORCING BARS	X	--	ACI 530: SECTION 2.1.10.7.2, 3.3.34(B)
	- PROTECTION OF MASONRY DURING COLD WEATHER (TEMP. BELOW 40°F) OR HOT WEATHER (TEMP ABOVE 90°F)	--	X	IBC 2104.3, 2104.4 ACI 530 Art 1.8C, 1.8D
	d) PRIOR TO GROUTING, VERIFY THE FOLLOWING TO ENSURE COMPLIANCE: - GROUT SPACE IS CLEAR	--	X	ACI 530: Art 3.2D
	- PLACEMENT OF REINFORCEMENT, CONNECTORS & ANCHORAGES	--	X	ACI 530: SECTION 1.13, Art 3.4
	- PROPORTIONS OF SITE PREPARED GROUT	--	X	ACI 530: Art 2.6B
	- CONSTRUCTION OF MORTAR JOINTS	--	X	ACI 530: Art 3.3B
	e) VERIFY GROUT PLACEMENT TO ENSURE COMPLIANCE WITH CODE & CONSTRUCTION DOCUMENT PROVISIONS	X	--	ACI 530: Art 3.5
	f) OBSERVE PREPARATION OF GROUT SPECIMENS, MORTAR SPECIMENS AND/OR PRISMS	X	--	IBC 2105.2.2, 2105.3 ACI 530: Art 1.4
g) VERIFY COMPLIANCE WITH INSPECTION PROVISIONS OF THE CONSTRUCTION DOCUMENTS AND COMPLIANCE WITH THE APPROVED SUBMITTALS	--	X	ACI 530: Art 1.5	
6) STEEL	a) MATERIAL VERIFICATION OF HIGH STRENGTH BOLTS, NUTS & WASHERS	--	X	APPLICABLE ASTM MATERIAL SPEC. AISC 360, SECTION A3.3
	- IDENTIFICATION MARKINGS TO CONFORM TO ASTM STANDARDS SPECIFIED IN THE APPROVED CONSTRUCTION DOCUMENTS	--	X	--
	- MANUFACTURER'S CERTIFICATE OF COMPLIANCE REQUIRED	--	X	--
	b) INSPECTION OF HIGH-STRENGTH BOLTING OF BEARING TYPE CONNECTIONS	--	X	AISC 360, SECTION M2.5 IBC SECTION 1704.3.3
	c) MATERIAL VERIFICATION OF STRUCTURAL STEEL: - IDENTIFICATION MARKINGS TO CONFORM TO ASTM STANDARDS SPECIFIED IN THE APPROVED CONSTRUCTION DOCUMENTS	--	X	ASTM A6 OR A568 IBC SECTION 1708.4
	- MANUFACTURER'S CERTIFIED MILL TEST REPORTS	--	X	ASTM A6 OR A568 IBC SECTION 1708.4
	d) MATERIAL VERIFICATION OF WELD FILLER MATERIALS: - IDENTIFICATION MARKINGS TO CONFORM TO AWS SPECIFICATION IN THE APPROVED CONSTRUCTION DOCUMENTS	--	X	AISC 360, SECTION A3.5
	- MANUFACTURER'S CERTIFICATE OF COMPLIANCE REQUIRED	--	X	--
	e) INSPECTION OF WELDING 1) COMPLETE & PARTIAL PENETRATION GROOVE WELDS	X	--	AWS D1.1 AISC 360 NS.4-N5.5
	2) MULTI-PASS FILLET WELDS	X	--	AWS D1.1 AISC 360 NS.4-N5.5
	3) SINGLE PASS FILLET WELDS > 5/16"	X	--	AWS D1.1 AISC 360 NS.4-N5.5
	4) SINGLE PASS FILLET WELDS < 5/16"	--	X	AWS D1.1 AISC 360 NS.4-N5.5
	5) FLOOR & ROOF DECK WELDS	--	X	AWS D1.3
	f) STUD SHEAR CONNECTOR SIZES, SPACING, MATERIALS & QUANTITY	X	--	AISC 360, SECTION N6
	g) WELDING OF STUD SHEAR CONNECTORS	--	X	AWS D1.1
h) INSPECT STEEL FRAME JOINT DETAILS FOR COMPLIANCE WITH APPROVED CONSTRUCTION DOCUMENTS	--	X	AISC 360 N5.7	

7) COLD-FORMED STEEL FRAMING	a) MATERIAL CERTIFICATION OF COLD FORMED STEEL: - IDENTIFICATION MARKINGS TO CONFORM TO ASTM SPECIFICATION IN THE APPROVED CONSTRUCTION DOCUMENTS	--	X	A.1.5.1 NAS-01	
	- MANUFACTURER'S CERTIFICATE OF COMPLIANCE REQUIRED	--	X	--	
	b) VERIFY SIZES AND SPACING OF MEMBERS FOR COMPLIANCE WITH THE APPROVED CONSTRUCTION DOCUMENTS	--	X	--	
	c) VERIFY WELDS AND CONNECTORS FOR COMPLIANCE WITH THE APPROVED CONSTRUCTION DOCUMENTS	--	X	--	
	d) VERIFY POWDER DRIVEN FASTENER SPACING, SIZES AND INSTALLATION FOR COMPLIANCE WITH THE APPROVED CONSTRUCTION DOCUMENTS	--	X	--	
	8) STEEL CONSTRUCTION OTHER THAN STRUCTURAL STEEL	a) MATERIAL VERIFICATION OF COLD-FORMED STEEL DECK: 1) IDENTIFICATION MARKINGS TO CONFORM TO ASTM STANDARDS SPECIFIED IN THE APPROVED CONSTRUCTION DOCUMENTS	--	X	APPLICABLE ASTM MATERIAL SPEC.
		2) MANUFACTURER'S CERTIFIED TEST REPORTS	--	X	--
		b) INSPECTION OF WELDING: 1) COLD-FORMED STEEL DECK: a) FLOOR AND ROOF DECK WELDS	--	X	AWS D1.3
		2) REINFORCING STEEL a) VERIFICATION OF WELDABILITY OF REINFORCING STEEL OTHER THAN ASTM A706	--	X	AWS D1.4 ACI 318: SECTION 3.5.2
		b) SHEAR REINFORCEMENT	X	--	AWS D1.4 ACI 318: SECTION 3.5.2
c) OTHER REINFORCING STEEL		--	X	AWS D1.4 ACI 318: SECTION 3.5.2	
9) SPECIAL INSPECTIONS FOR SEISMIC RESISTANCE		a) STRUCTURAL STEEL - INSPECTION OF STRUCTURAL STEEL ELEMENTS OF THE SEISMIC FORCE RESISTING SYSTEM	--	X	AISC 341
		b) TESTING AND QUALIFICATION FOR SEISMIC RESISTANCE - TEST STRUCTURAL STEEL ELEMENTS OF THE SEISMIC FORCE RESISTING SYSTEM IN ACCORDANCE WITH AISC QUALITY ASSURANCE REQUIREMENTS	--	X	AISC 341
		- VERIFY STEEL REINFORCEMENT USED IN CONCRETE ELEMENTS OF THE SEISMIC FORCE RESISTING SYSTEM BY CERTIFIED MILL TEST REPORTS FOR EACH SHIPMENT OF REINFORCEMENT	--	X	ACI 318, SECTION 21.1.5.2
		- FOR WELDED REINFORCING STEEL OTHER THAN ASTM A706 IN CONCRETE ELEMENTS OF THE SEISMIC FORCE RESISTING SYSTEM, PERFORM CHEMICAL TESTS TO VERIFY WELDABILITY	--	X	ACI 318, SECTION 3.5.2
	c) INSPECTION AND SEISMIC CERTIFICATION OF NON-STRUCTURAL COMPONENTS 1) INSPECT INSTALLATION AND ANCHORAGE OF MECHANICAL AND ELECTRICAL COMPONENTS REQUIRING ANCHORAGE AGAINST SEISMIC FORCES	--	X	IBC SECTION 1705.11.6, ASCE 7, SECTION 13.6	
	2) CERTIFY BY TESTING OR EXPERIENCE DATA THAT MECHANICAL AND ELECTRICAL EQUIPMENT WILL REMAIN OPERABLE FOLLOWING THE DESIGN SEISMIC GROUND MOTION	--	X	IBC SECTION 1705.11.4, IBC SECTION 1705.12.3	
	a) FOR SYSTEMS REQUIRING SEISMIC CERTIFICATION, VERIFY THAT LABELS, ANCHORAGE, OR MOUNTING CONFORM TO THE CERTIFICATE OF COMPLIANCE	--	X	IBC SECTION 1705.12.3, ASCE 7, SECTION 13.2	
	3) INSPECT FABRICATION AND INSTALLATION OF ISOLATOR UNITS AND ENERGY DISSIPATION DEVICES IN SEISMIC ISOLATION SYSTEMS	--	X	IBC SECTION 1705.11.8	
	4) TEST SEISMIC ISOLATION SYSTEMS	--	X	ASCE 7, SECTION 17.8	

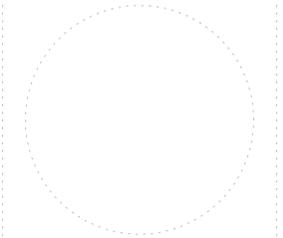

ORCHARD MESA FIRE STATION #4

GRAND JUNCTION, COLORADO

SCHEDULE OF SPECIAL INSPECTIONS

NO: ISSUED FOR: DATE:




PROJECT STATUS: 100% CD

DRAWN BY: JDG CHECKED BY: JAD

DATE: 04/10/15 SHEET NO:

PROJECT NO: 14.108 **S101**

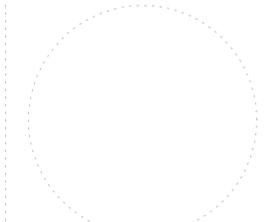

**ORCHARD MESA
FIRE STATION #4**

GRAND JUNCTION, COLORADO

FOUNDATION PLAN

NO: ISSUED FOR: DATE:




PROJECT STATUS: 100% CD

DRAWN BY: JDG, KDN CHECKED BY: JAD

DATE: 04/10/15 SHEET NO.:

PROJECT NO: **S102**
14.108

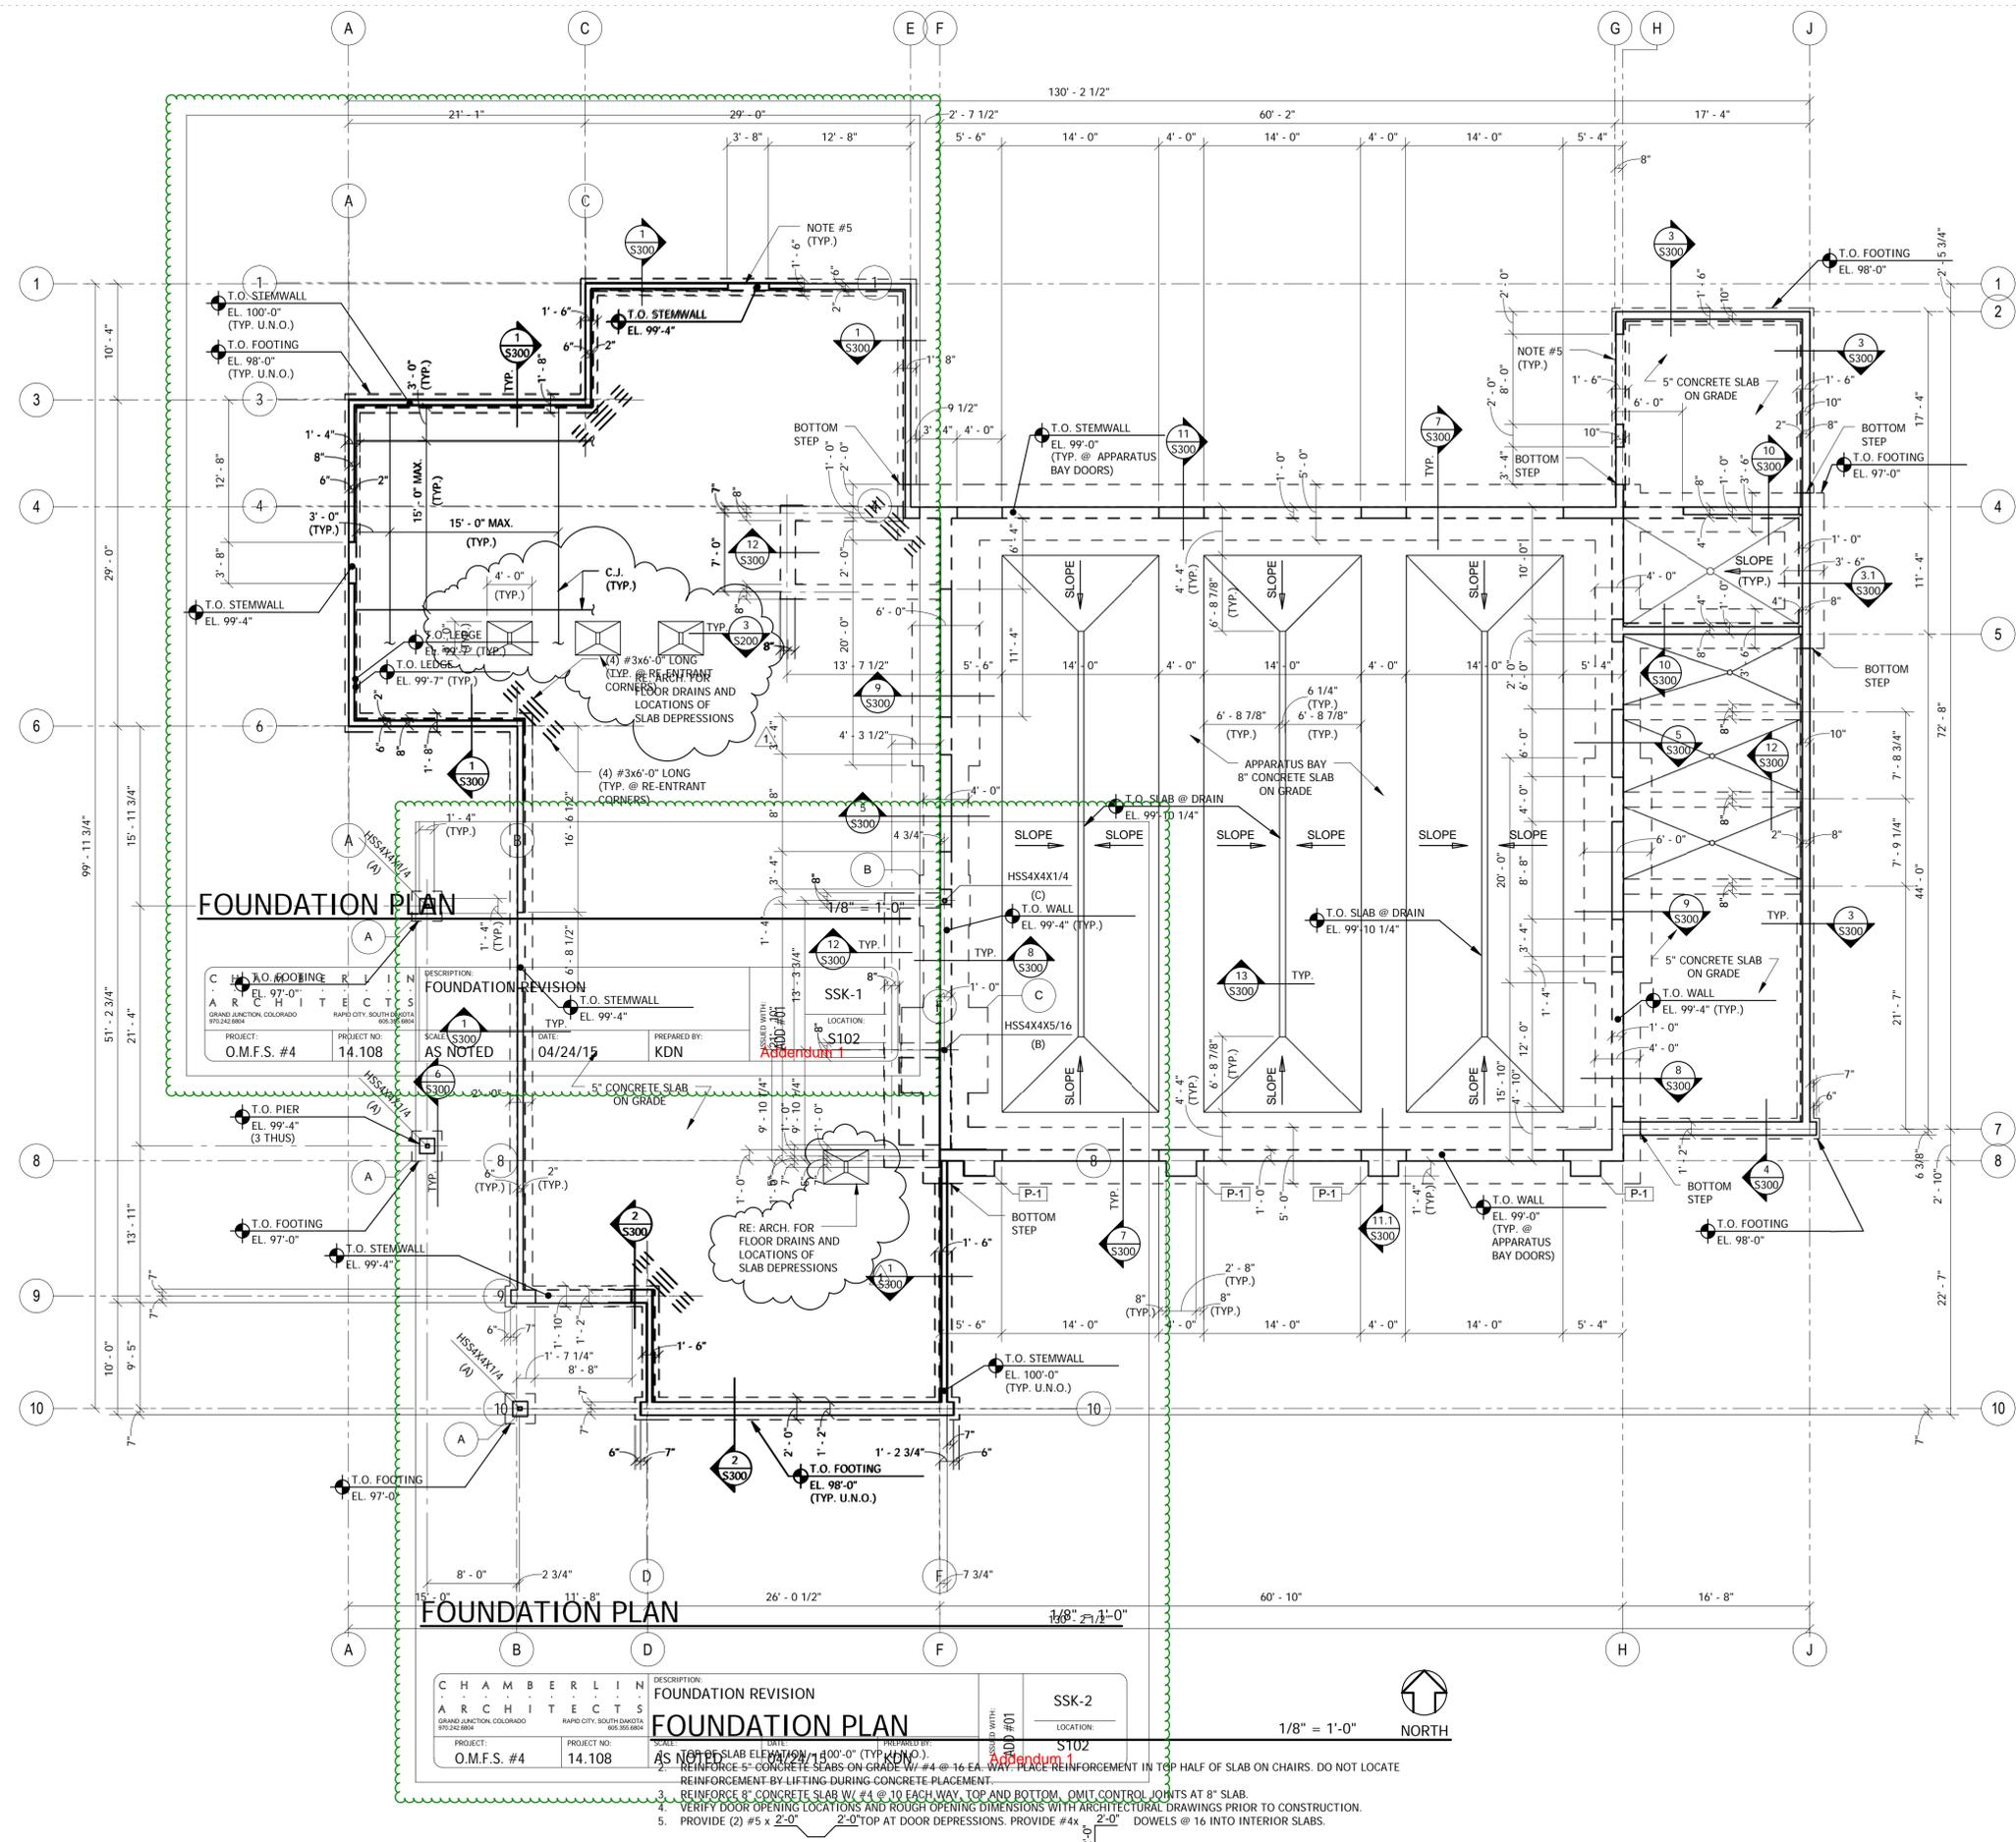

**ARCHITECT'S
SUPPLEMENTAL INSTRUCTIONS**

OWNER
ARCHITECT
CONTRACTOR
FIELD
OTHER

PROJECT: Orchard Mesa Fire Station #4
OWNER: City of Grand Junction
TO: FCI Constructors, Inc.
3070 I-70 B, Bldg A
Grand Junction, CO 81504

ARCHITECT'S SUPPLEMENTAL
INSTRUCTION NO: Three (3)

ARCHITECT: Chamberlin Architects
437 Main Street
Grand Junction, CO 81501

ARCHITECT'S PROJECT NO: 1443

DATE OF ISSUANCE: July 21, 2015


The Work shall be carried out in accordance with the following supplemental instructions issued in accordance with the Contract Documents without change in Contract Sum or Contract Time. Proceeding in accordance with these instructions indicates your acknowledgment that there will be no change in the Contract Sum or Contract Time.

Add FLOOR PLAN – CONTROL JOINT LAYOUT as illustrated in the attached Sketch ASK-7 dated 7/21/15.

Attachments: ASK-7

ARCHITECT: Chamberlin Architects, P.C.

BY: Jonathan West
S:\1443 - Orchard Mesa Fire Station #4\6. CONSTRUCTION\ASK\ASK#003.1443.doc

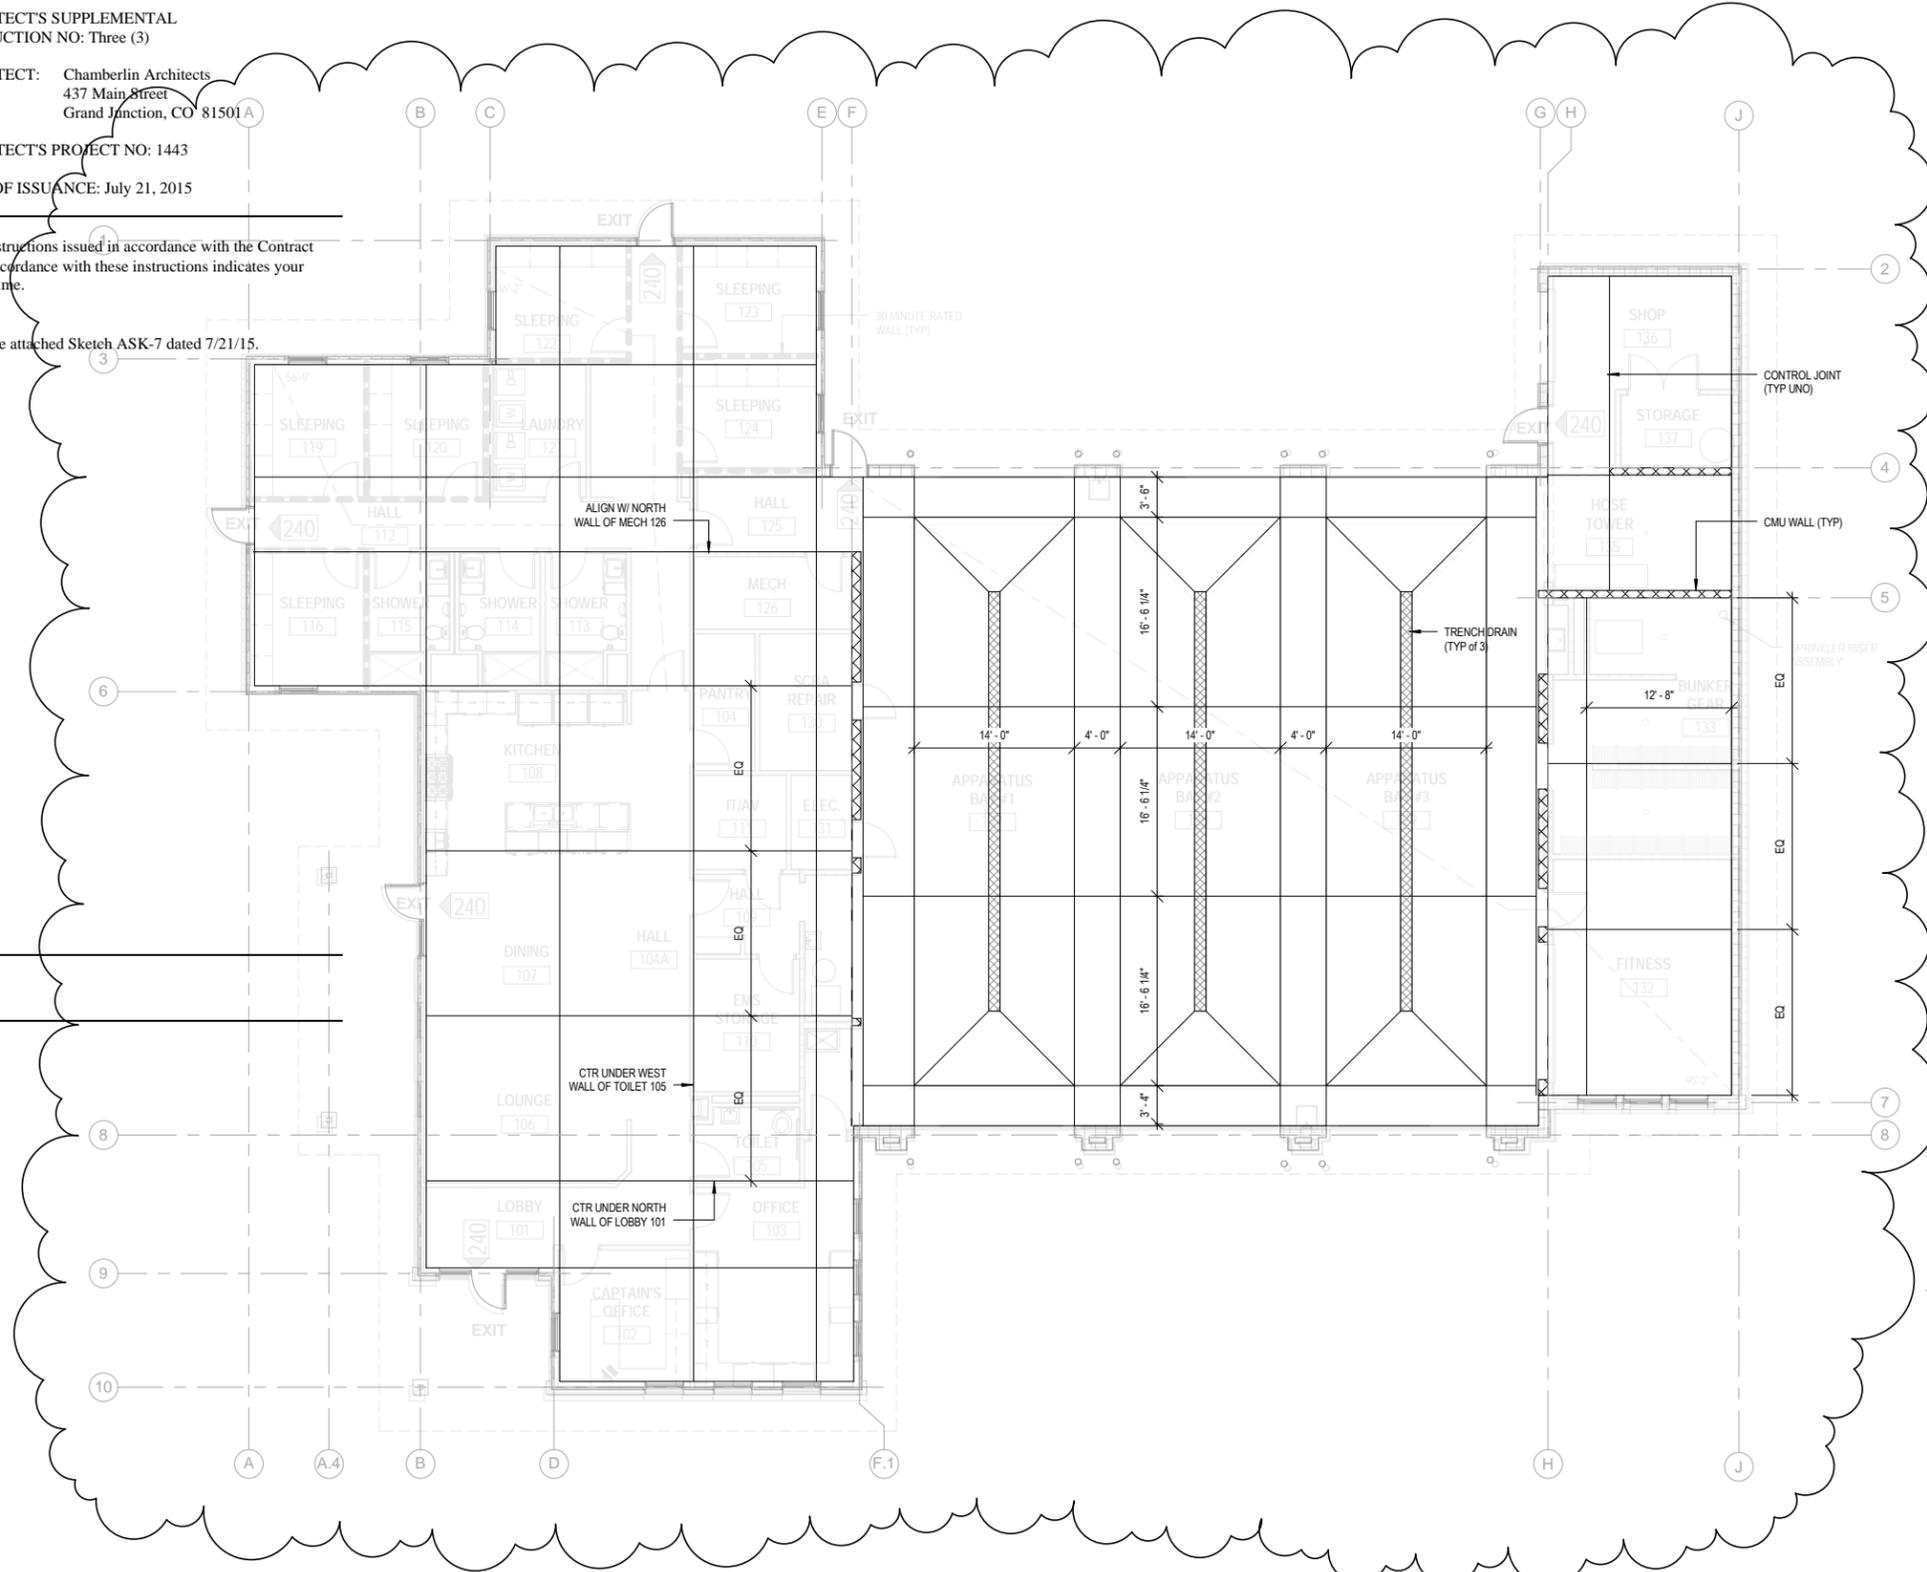

1 FLOOR PLAN - CONTROL JOINT LAYOUT
ASK-7

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**ORCHARD MESA
FIRE STATION #4**

GRAND JUNCTION, COLORADO

**FLOOR PLAN -
CONTROL JOINT
LAYOUT**


NO: ASH#003
ISSUED FOR: ASH#003
DATE: 7/21/15

PROJECT STATUS: 100% CDs

DRAWN BY: JW CHECKED BY: Checker

DATE: 05/27/2015 SHEET NO:

PROJECT NO: 1443 **ASK-7**

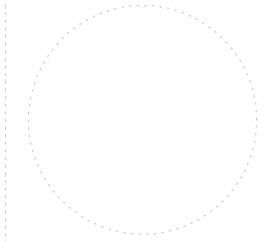

**ORCHARD MESA
FIRE STATION #4**

GRAND JUNCTION, COLORADO

**LOW ROOF
FRAMING PLAN**

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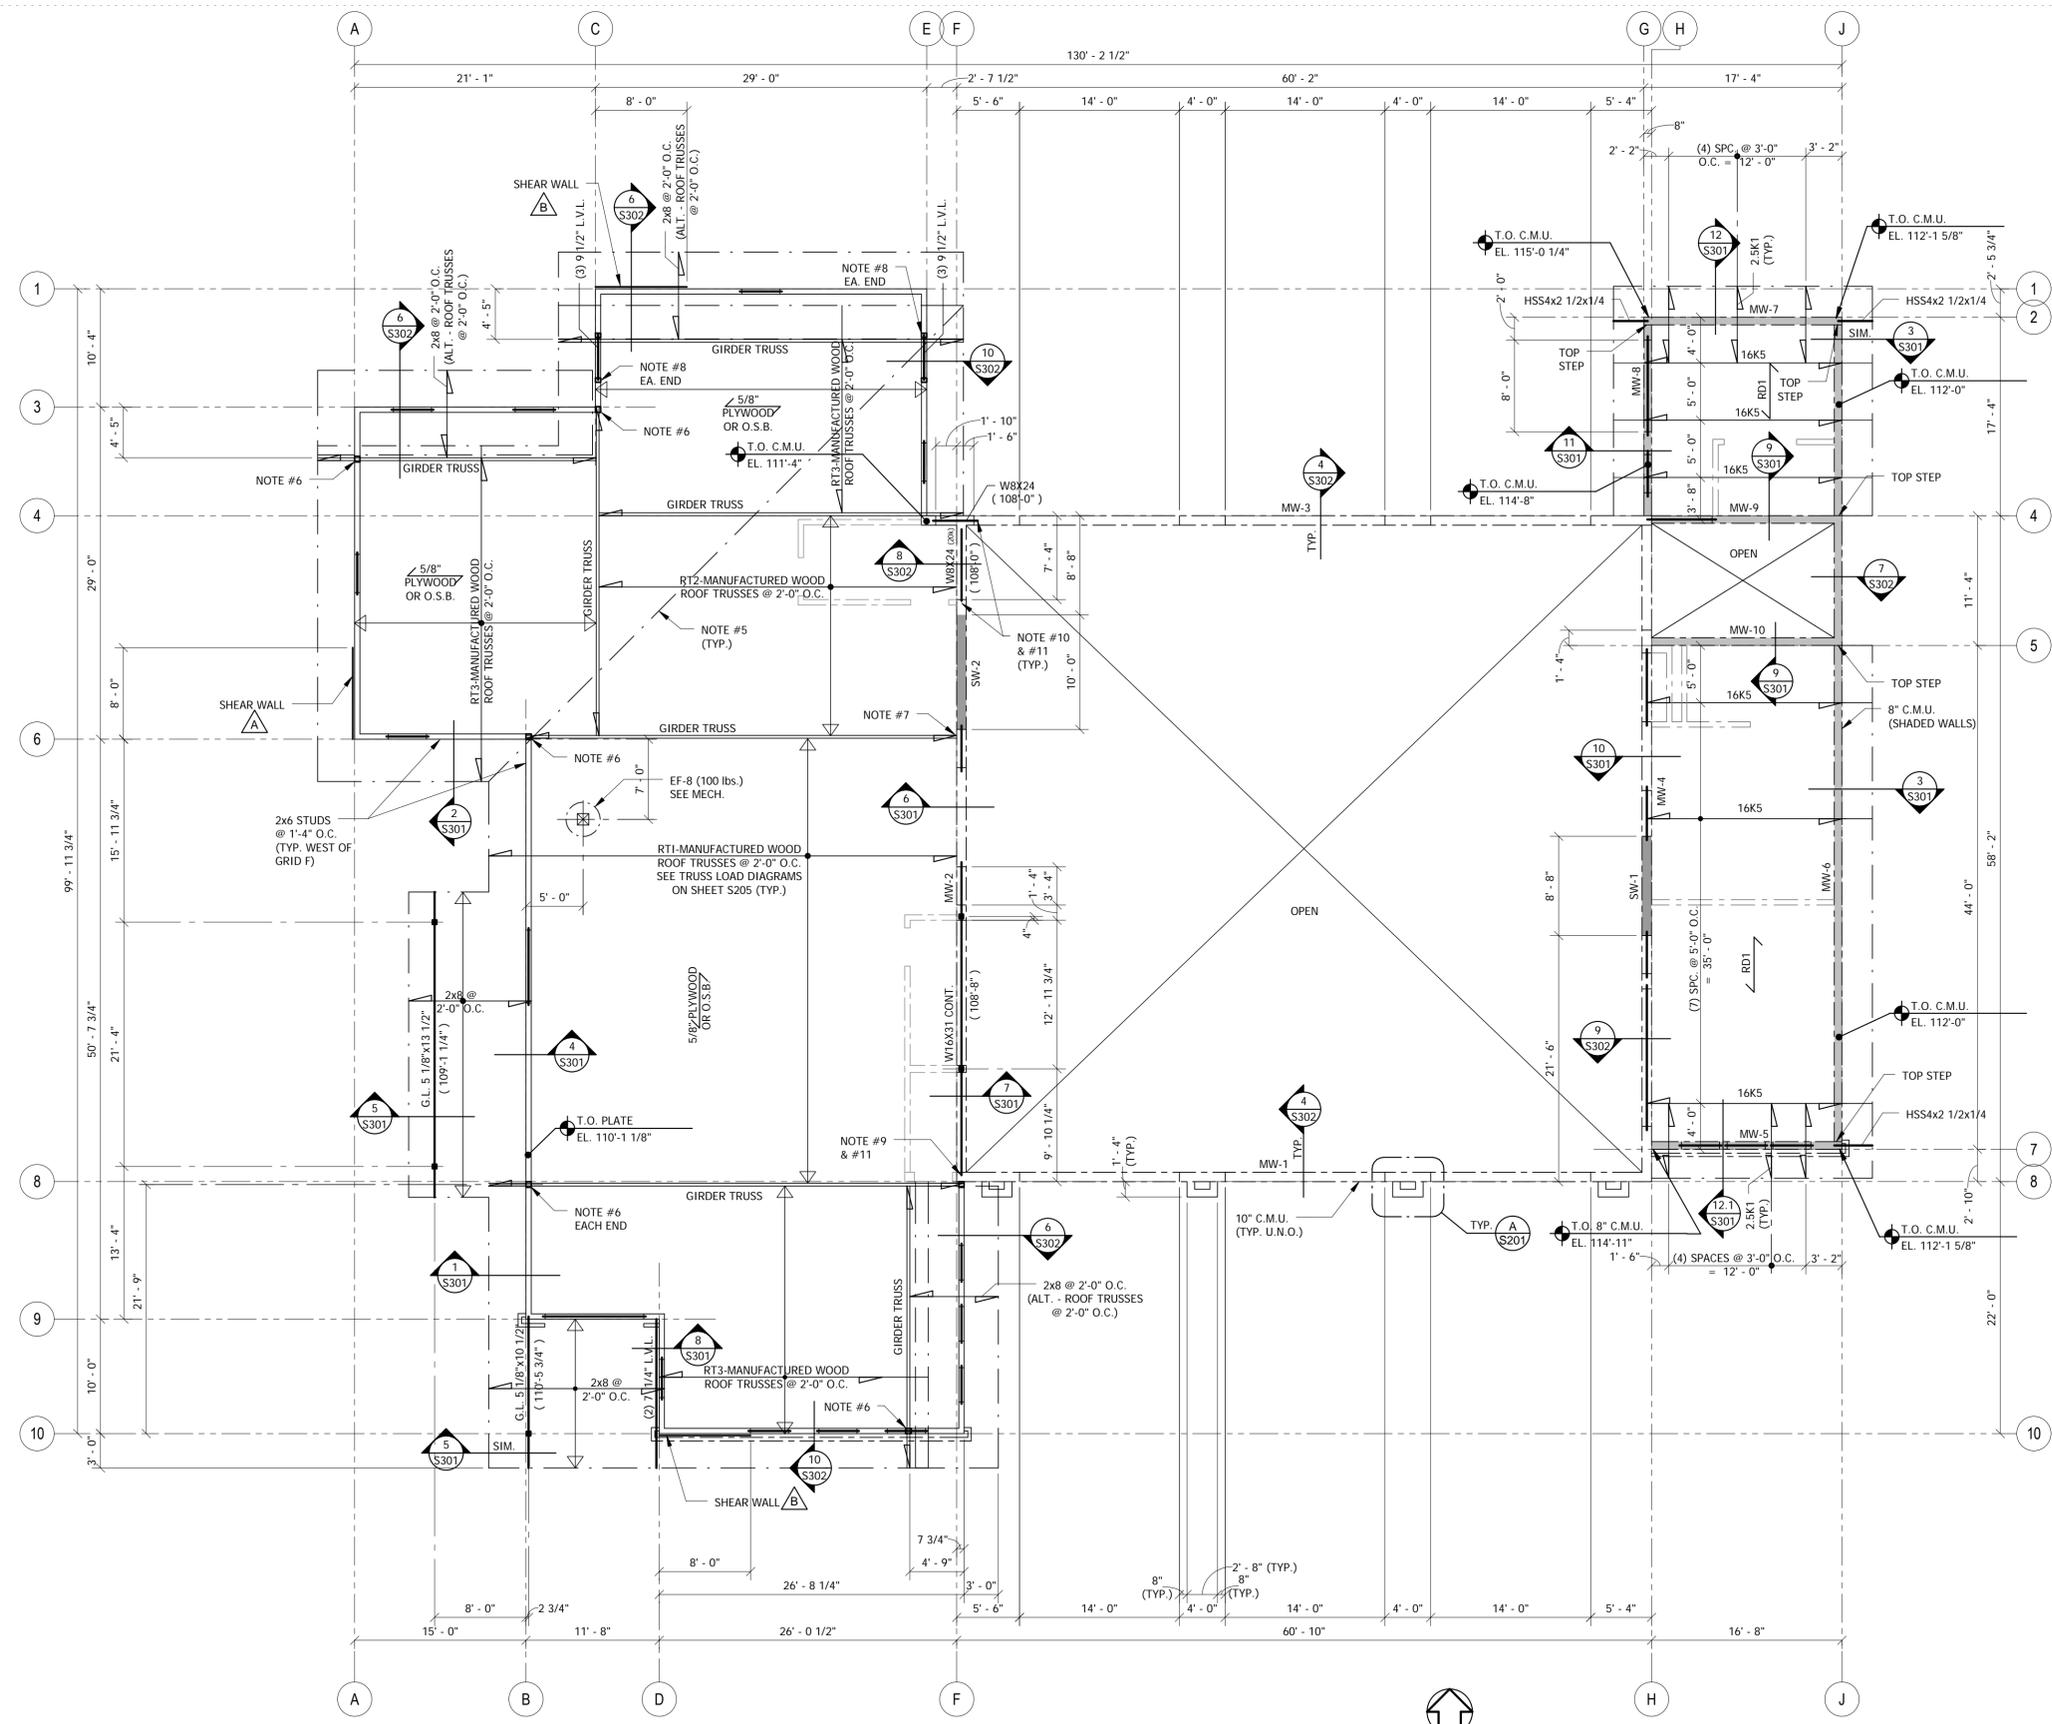


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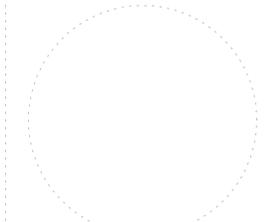
DATE: 04/10/15 SHEET NO:

PROJECT NO: **S103**



LOW ROOF FRAMING PLAN 1/8" = 1'-0" NORTH

1. TOP OF BEAM ELEVATION NOTED THUS: (XXX-XX").
2. PROVIDE JOIST BRIDGING IN ACCORDANCE WITH S.J.I. SPECIFICATIONS.
3. UNLESS NOTED OTHERWISE, ALL EXTERIOR HEADERS IN WOOD FRAMED WALLS SHALL BE 9 1/4" TJ-INSULATED* HEADERS BY WEYERHAEUSER, OR AN ENGINEER APPROVED EQUIVALENT. BEAR ON (2) 2x6 STUDS EACH END, U.N.O.
4. ALL HANGERS REQUIRED AT CONNECTIONS BETWEEN ROOF TRUSSES ARE TO BE SPECIFIED BY THE TRUSS MANUFACTURER, UNLESS OTHERWISE NOTED IN THE STRUCTURAL DETAILS.
5. PROVIDE (2) 2x6 BLOCKING BETWEEN TRUSSES ALONG VALLEY LINE FOR PLYWOOD ATTACHMENT. CONNECT TO TRUSSES WITH SIMPSON TYPE "SUL26-2" HANGER EACH END.
6. BEAR ON (4) 2x6 STUDS.
7. PROVIDE SIMPSON TYPE "LGM210-3-SDS" HANGER WITH (8) 3/8"x0-4" TITEN HD ANCHORS TO GROUTED CELLS OF C.M.U. HANGER SIZE IS BASED UPON AN ASSUMPTION OF A (3) PLY GIRDER TRUSS. USE "LGM210-2" FOR A (2) PLY TRUSS OR "LGM210-4" FOR A (4) PLY TRUSS.
8. BEAR ON (3) 2x6 STUDS.
9. PROVIDE BEARING PLATE 1/2"x6 1/2"x0-6 1/2". PLACE ON 3/8" MIN. NON-SHRINK GROUT.
10. PROVIDE BEARING PLATE 1/2"x7 1/2"x0-8 1/2". W/ 8" LENGTH PARALLEL TO BEAM SPAN. PLACE ON 3/8" MIN. NON-SHRINK GROUT.
11. PROVIDE (2) 5/8"x1-0" LONG HEADED ANCHOR BOLTS WITH MINIMUM 8" EMBEDMENT.



**ORCHARD MESA
FIRE STATION #4**

GRAND JUNCTION, COLORADO

**UPPER ROOF
FRAMING PLAN**

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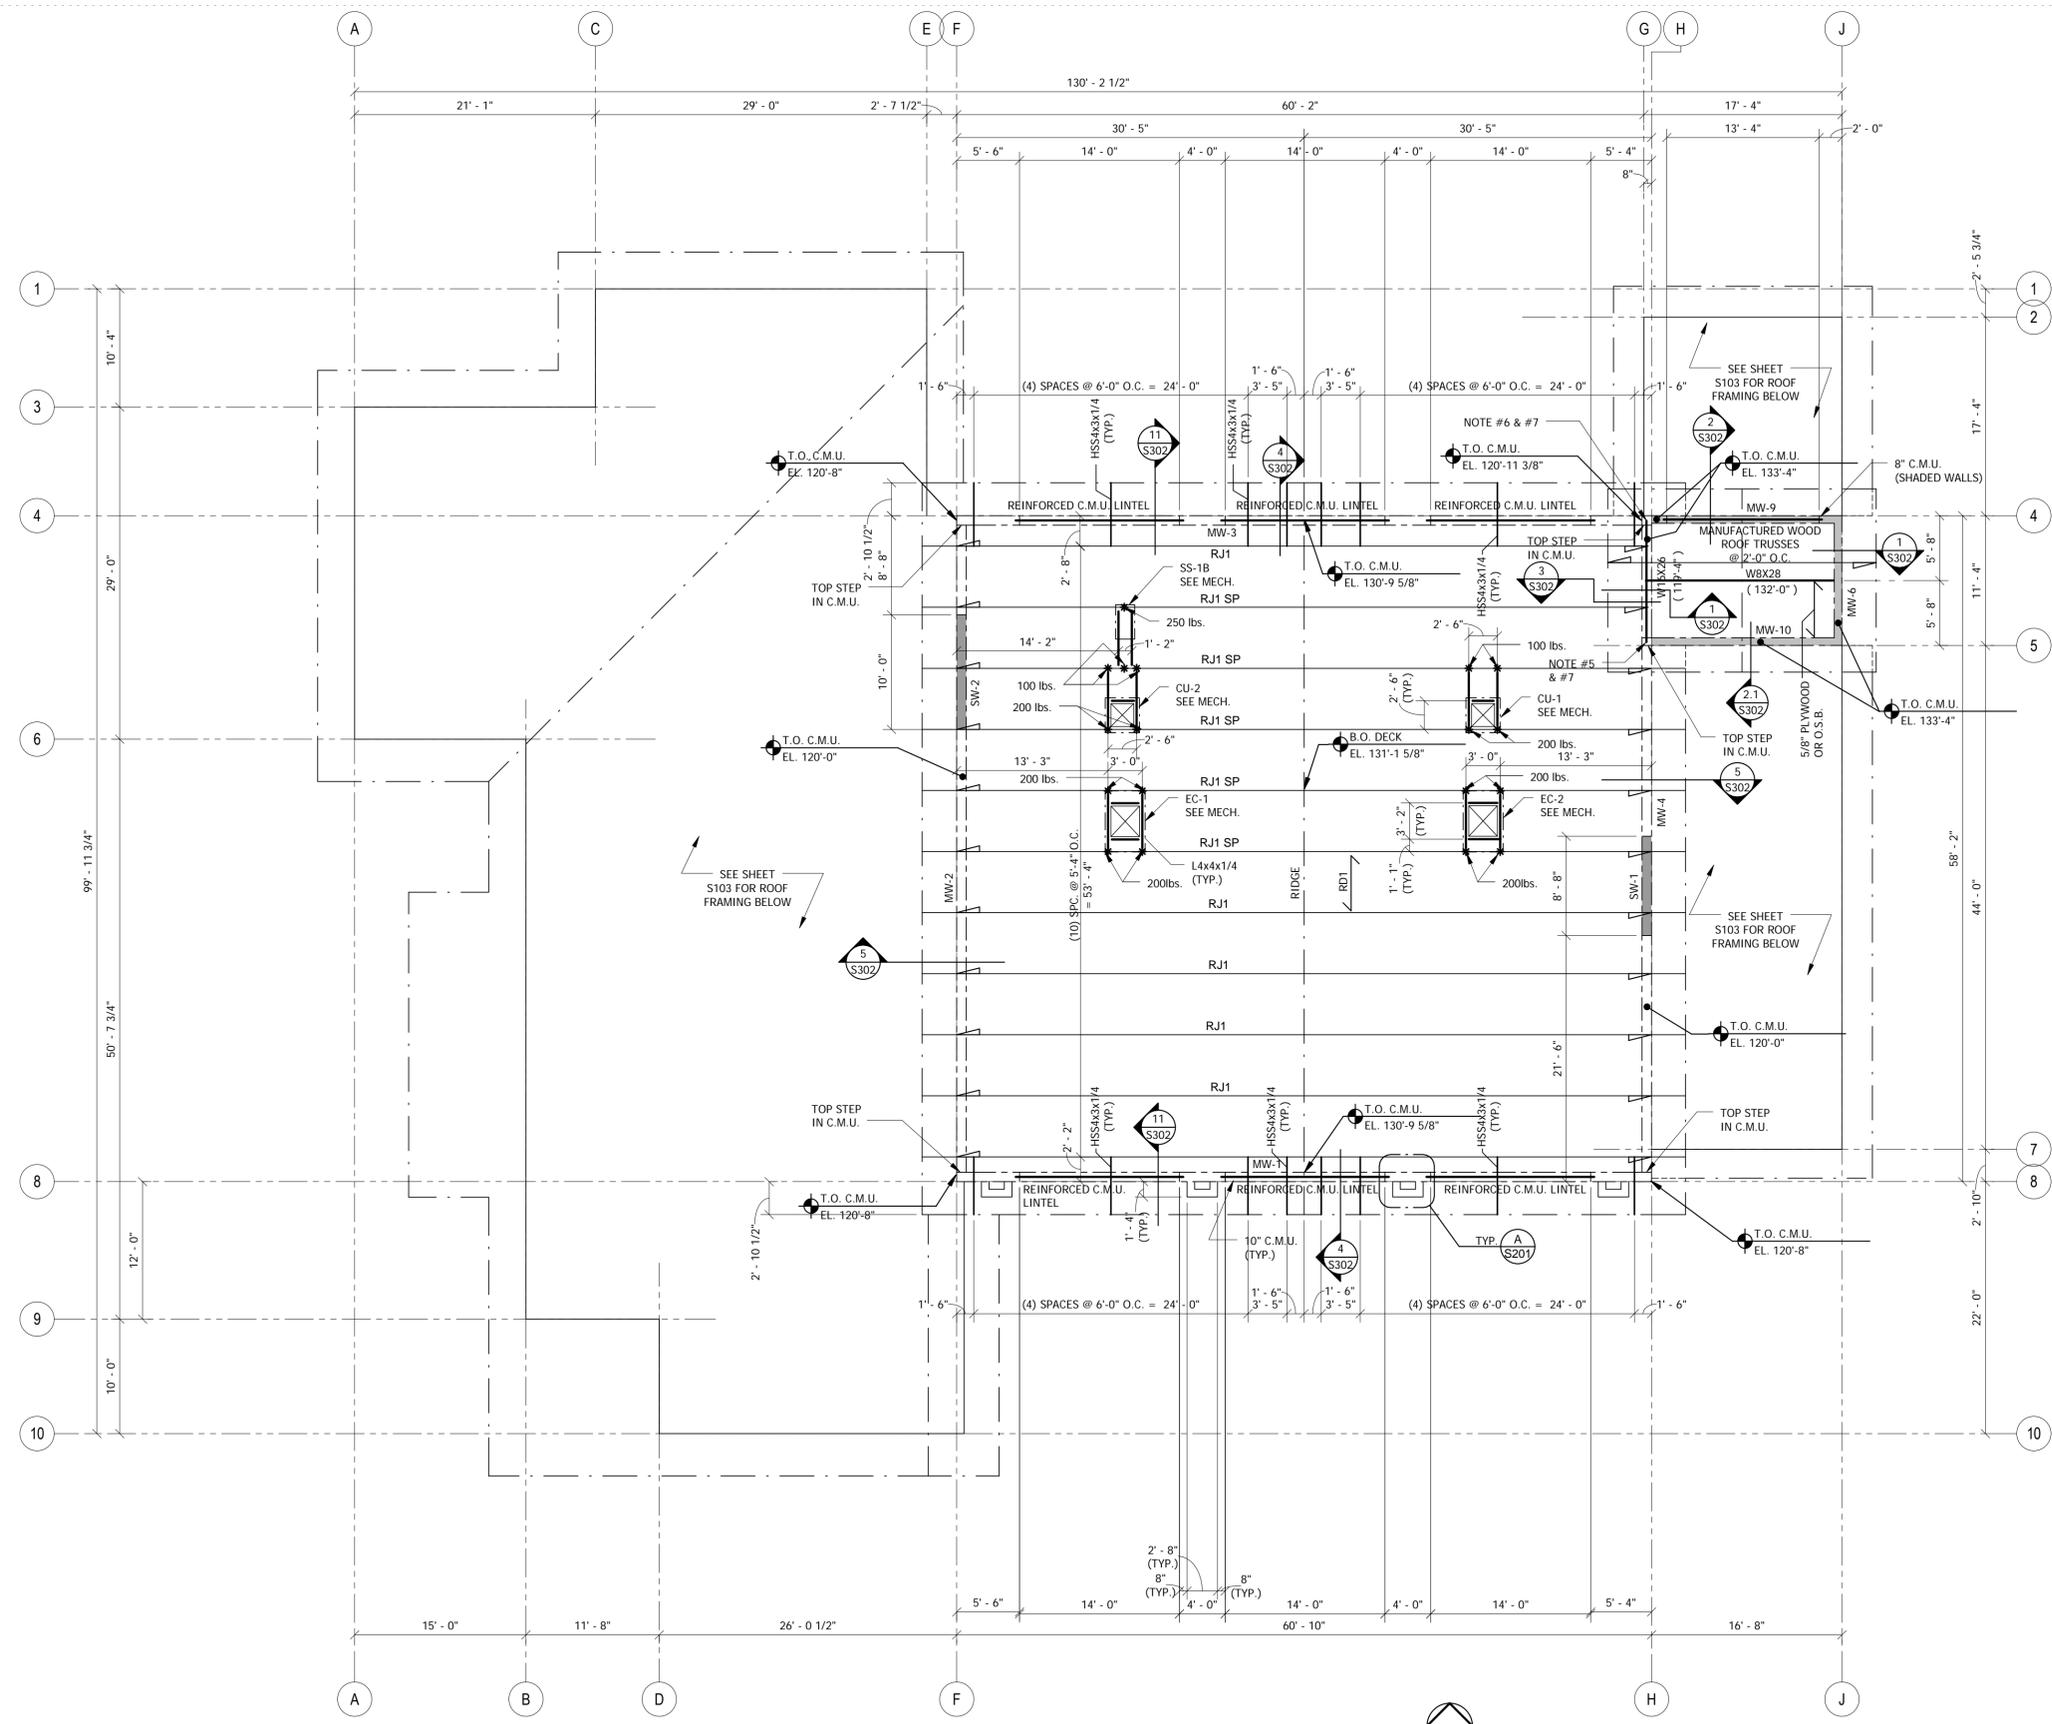


PROJECT STATUS: 100% CD

DRAWN BY: JDG, KDN CHECKED BY: JAD

DATE: 04/10/15 SHEET NO:

PROJECT NO: **S104**




UPPER ROOF FRAMING PLAN

1/8" = 1'-0" NORTH

1. TOP OF STEEL ELEVATION NOTED THUS: (XXX'-XX").
2. STEEL ROOF JOISTS SHALL BE LH TYPE IN A GABLE CONFIGURATION WITH A TOP CHORD PITCH OF 4:12. SEE LOAD DIAGRAMS ON SHEET S203.
3. PROVIDE JOIST BRIDGING IN ACCORDANCE WITH S.J.I. SPECIFICATIONS. PROVIDE BOLTED DIAGONAL BRIDGING AS REQUIRED AT LH JOISTS.
4. VERIFY LOCATIONS, DIMENSIONS, AND WEIGHTS OF MECHANICAL UNITS AND VERIFY DIMENSIONS OF DUCT OPENINGS PRIOR TO FABRICATION AND CONSTRUCTION.
5. PROVIDE BEARING PLATE 5/8"x6 1/2"x8 1/2" WITH LONG DIMENSION PARALLEL TO BEAM SPAN. PLACE ON 1/2" MIN. NON-SHRINK GROUT.
6. PROVIDE BEARING PLATE 5/8"x7"x8 1/2" WITH LONG DIMENSION PERPENDICULAR TO BEAM. PLACE ON 1/2" MIN. NON-SHRINK GROUT.
7. PROVIDE (2) 5/8"x1'-0" LONG HEADED ANCHOR BOLTS W/ MIN. 8" EMBEDMENT.

BEAM BEARING PLATES ON C.M.U.

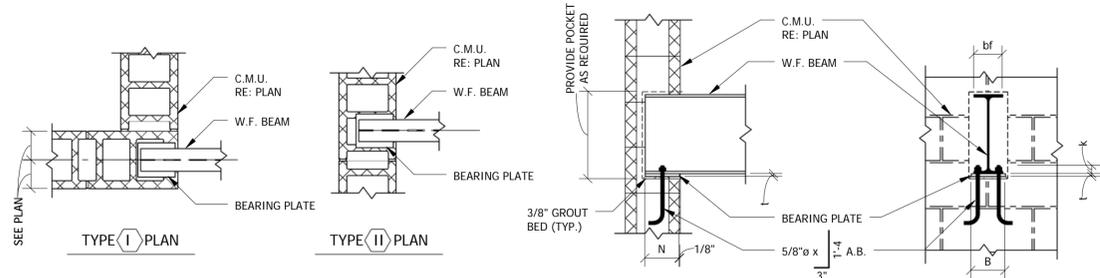

3/4" = 1'-0"

BEAM DEPTH	CAPACITY (SERVICE) KIPS	MIN. k	MIN. bf	N		B	t	# BOLTS
				8"	12"			
W8, W10	10	5/8"	4"	4"	8"	6"	1/2"	(1)
W10, W12	15	11/16"	4"	6"	8"	7"	1/2"	(2)
W12, W14	19	7/8"	5"	6"	8"	7"	1/2"	(2)

NOTES:

- CAPACITIES ARE BASED UPON $f_m' = 1,500$ psi. AND MINIMUM MASONRY BEARING (F_p) = .26 f_m' (SPECIAL INSPECTION REQUIRED).
- F_y OF BEARING PLATES = 36 ksi.
- SEE TYPICAL CORNER WITH BEAM BEARING FOR C.M.U. CORNER REINFORCING.

3/4" = 1'-0"

BEAM DEPTH	CAPACITY (SERVICE) KIPS	MIN. k	MIN. bf	N		B	t	# BOLTS
				8"	12"			
W8, W10	10	5/8"	4"	4"	6"	6"	1/2"	(1)
W10, W12	15	11/16"	4"	6"	8"	7"	1/2"	(2)
W12, W14	24	7/8"	5"	6"	8"	9"	3/4"	(2)
W16, W18	30	1 1/16"	6"	6"	8"	11"	7/8"	(2)
W18, W21	34	15/16"	6"	6"	8"	12 1/2"	1"	(2)
W21, W24	38	1 3/8"	7"	6"	8"	14"	1 1/4"	(2)

NOTES:

- CAPACITIES ARE BASED UPON $f_m' = 1,500$ psi. AND MINIMUM MASONRY BEARING (F_p) = .26 f_m' (SPECIAL INSPECTION REQUIRED).
- F_y OF BEARING PLATES = 36 ksi.

OPENING	LINTEL		BEARING EA. END	REMARKS
	4" VENEER	8" C.M.U.		
3'-6" OR LESS	L 3 1/2x3x1/4	(2) L 3 1/2x3x1/4	4"	S.L.V.
OVER 3'-6" THRU 5'-6"	L 4x3 1/2x1/4	(2) L 4x3 1/2x1/4	6"	L.L.V.
OVER 5'-6" THRU 7'-6"	L 6x3 1/2x5/16	(2) L 6x3 1/2x5/16	6"	L.L.V.
OVER 7'-6"	SEE PLAN			

- FOR OPENINGS OVER 6'-0", PROVIDE SOLID MASONRY JAMB UNDER LINTEL EACH SIDE OF OPENING.


C.M.U. REINFORCING SCHEDULE	
1.	PROVIDE #5 @ 32 VERTICAL REINFORCING AT 8" C.M.U. AND #6 @ 24 VERTICAL REINFORCING AT 10" C.M.U. GROUT ALL VERTICAL REINFORCING SOLID. VERTICAL REINFORCEMENT SHALL EXTEND THROUGH BOND BEAMS TO 2" CLR. BELOW TOP OF C.M.U. USE STANDARD LADDER TYPE HORIZONTAL JOINT REINFORCEMENT AT 16" O.C. WITH MINIMUM (2) #9 SIDE RODS AT EACH LADDER.
2.	PROVIDE #4 @ 24 VERTICAL REINFORCEMENT AT 6" C.M.U. WALLS. GROUT ALL REINFORCEMENT SOLID. PROVIDE BOND BEAM WITH (1) #6 CONT. AT TOP OF 6" C.M.U. WALLS, AND REINFORCE HORIZONTAL JOINTS WITH STANDARD LADDER TYPE REINFORCEMENT.
3.	PROVIDE (2) #5 CONT. VERTICAL EACH SIDE OF ALL OPENINGS AND CONTROL JOINTS. EXTEND 2'-0" MINIMUM EACH SIDE OF OPENING. GROUT SOLID.
4.	LAP ALL VERTICAL REINFORCING AS FOLLOWS: #4 - MINIMUM OF 2'-0" #5 - MINIMUM OF 2'-4" #6 - MINIMUM OF 3'-4"
5.	PROVIDE #5 x 4'-0" DOWELS @ 24 FROM STEMWALLS TO 8" C.M.U. LAP 2'-4" WITH WALL VERTICAL REINFORCEMENT AND GROUT SOLID. PROVIDE #6 x 5'-2" DOWELS @ 24 FROM STEMWALLS TO 10" C.M.U. LAP 3'-6" WITH WALL VERTICAL REINFORCEMENT AND GROUT SOLID.

ALTERNATE REINFORCED MASONRY LINTEL SCHEDULE

TYPE	CLEAR SPAN	NOMINAL DEPTH	REINF.	TYPICAL DETAIL
A	2'-0" TO 4'-0"	16"	(2) #4 BOT.	
B	4'-4" TO 8'-0"	32"	(2) #5 T.&B.	


NOTES:

- CLEAR SPAN INDICATES THE ROUGH MASONRY OPENING WIDTH.
- PROVIDE 8" MIN. BEARING FOR CLEAR SPAN 8'-0" OR LESS AND 16" MIN. BEARING FOR CLEAR SPAN GREATER THAN 8'-0".
- EXTEND TOP & BOTTOM REINFORCEMENT 2'-0 BEYOND EDGE OF OPENING EACH SIDE. TERMINATE TOP REINFORCEMENT W/ STD. HOOK AT CONTROL JOINTS OR FREE EDGES.
- PROVIDE SOLID GROUTED OR SOLID MASONRY JAMB UNDER LINTEL EACH SIDE OF OPENING.

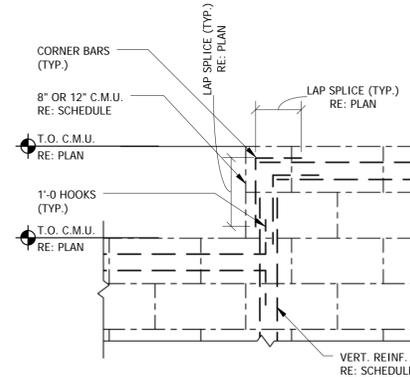

TYP. C.M.U. TOP STEP DETAIL

3/4" = 1'-0"

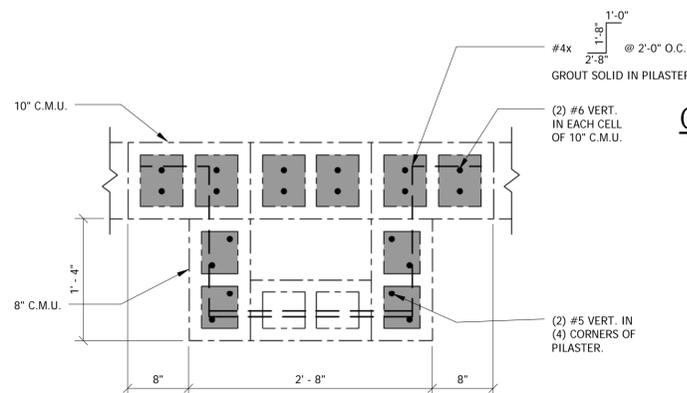


DETAIL

1" = 1'-0"


C.M.U. EDGE OPENING

3/4" = 1'-0"

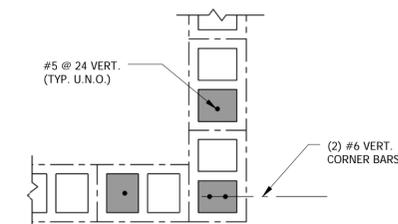

C.M.U. CORNER REINF.

3/4" = 1'-0"

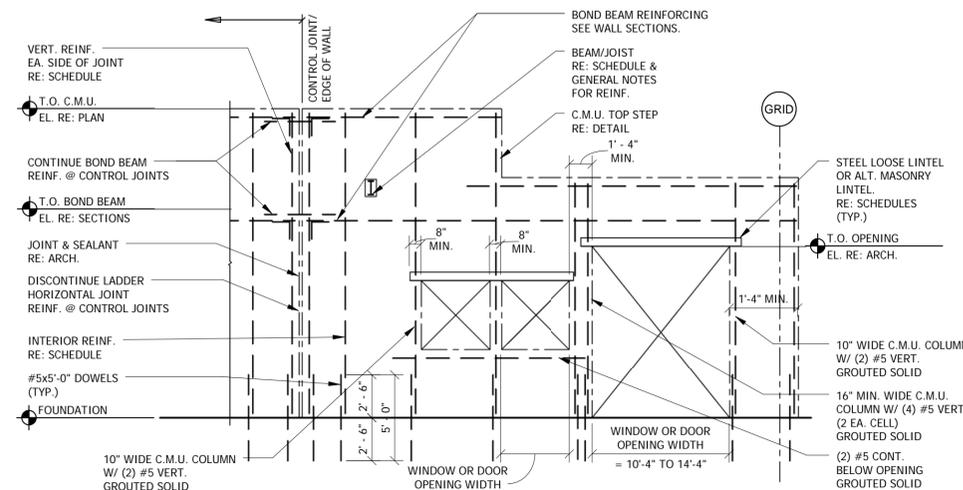

TYPICAL C.M.U. WALL ELEVATION

N.T.S.

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ORCHARD MESA FIRE STATION #4

GRAND JUNCTION, COLORADO

MASONRY DETAILS

NO. ISSUED FOR: DATE:

PROJECT STATUS: 100% CD

DRAWN BY: JDG CHECKED BY: JAD

DATE:


04/10/15

SHEET NO.


PROJECT NO:

14.108


S201

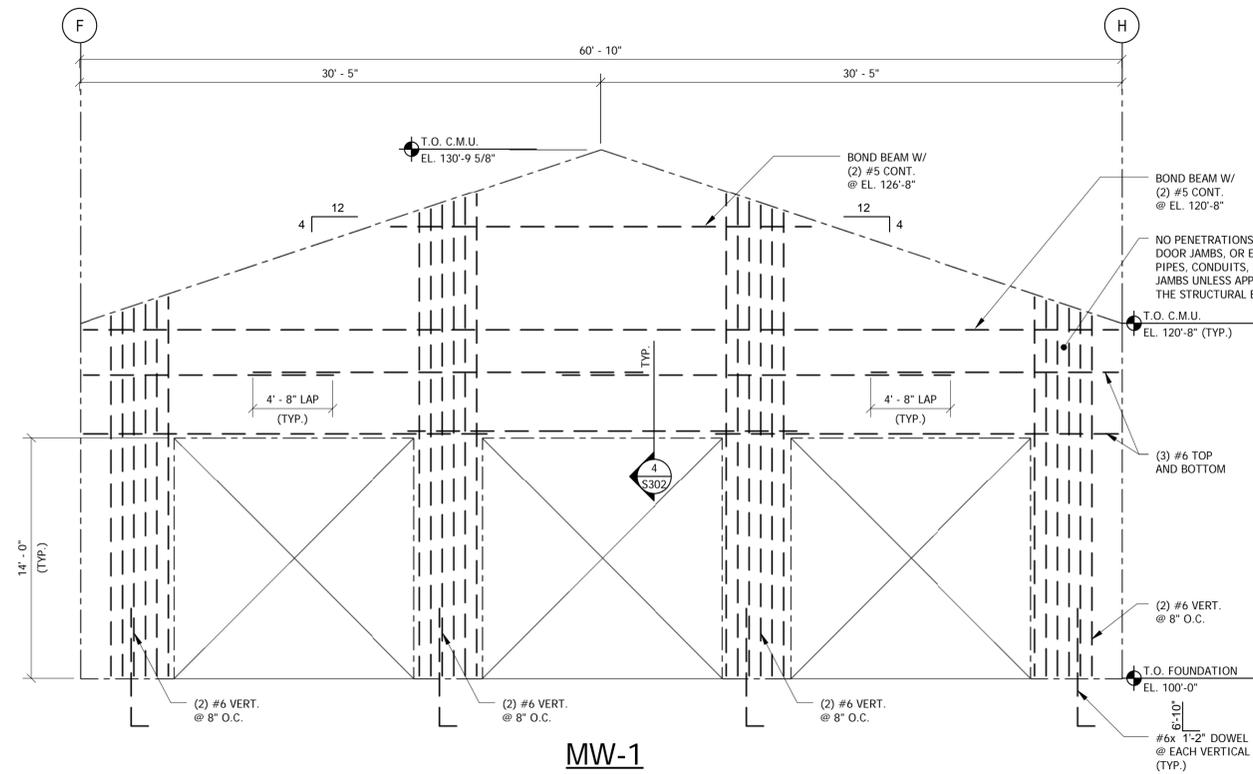


MW-1

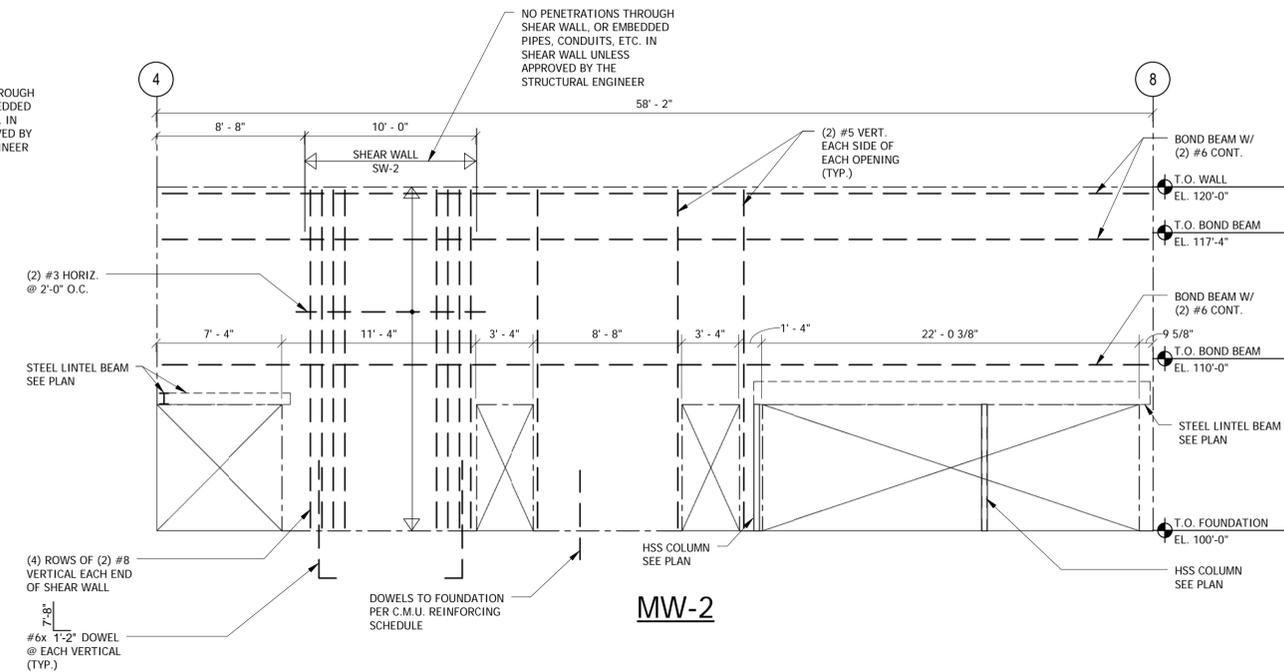

MW-2

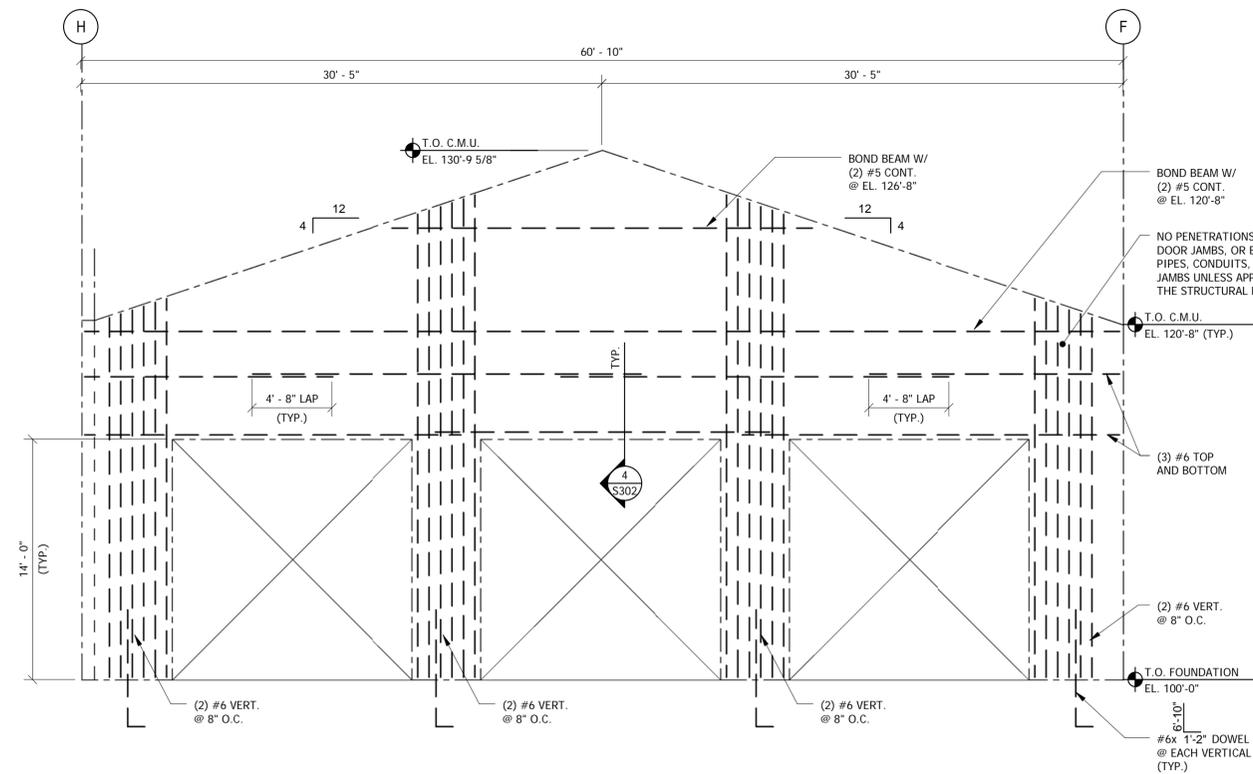

MW-3

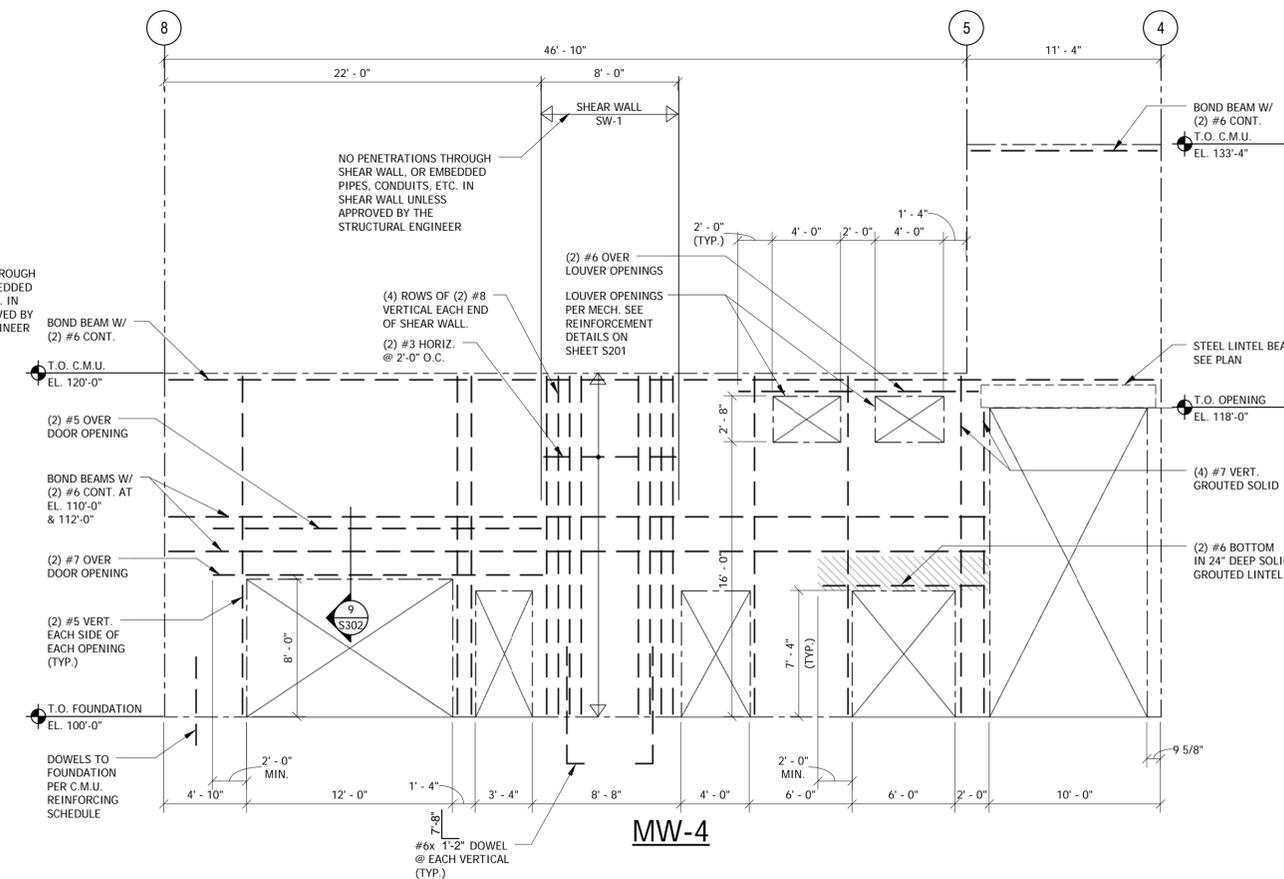

MW-4

MASONRY WALL ELEVATIONS

3/16" = 1'-0"

ORCHARD MESA
FIRE STATION #4

GRAND JUNCTION, COLORADO

C.M.U. WALL
ELEVATIONS

NO: ISSUED FOR: DATE:



PROJECT STATUS: 100% CD

DRAWN BY: JDG CHECKED BY: JAD

DATE:


04/10/15

SHEET NO:

PROJECT NO:

14.108

S202

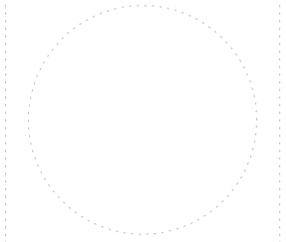

**ORCHARD MESA
FIRE STATION #4**

GRAND JUNCTION, COLORADO

**C.M.U. WALL
ELEVATIONS**

NO: ISSUED FOR: DATE:





PROJECT STATUS: 100% CD

DRAWN BY: JDG CHECKED BY: JAD

DATE:
04/10/15 SHEET NO:

PROJECT NO:
14.108 S203

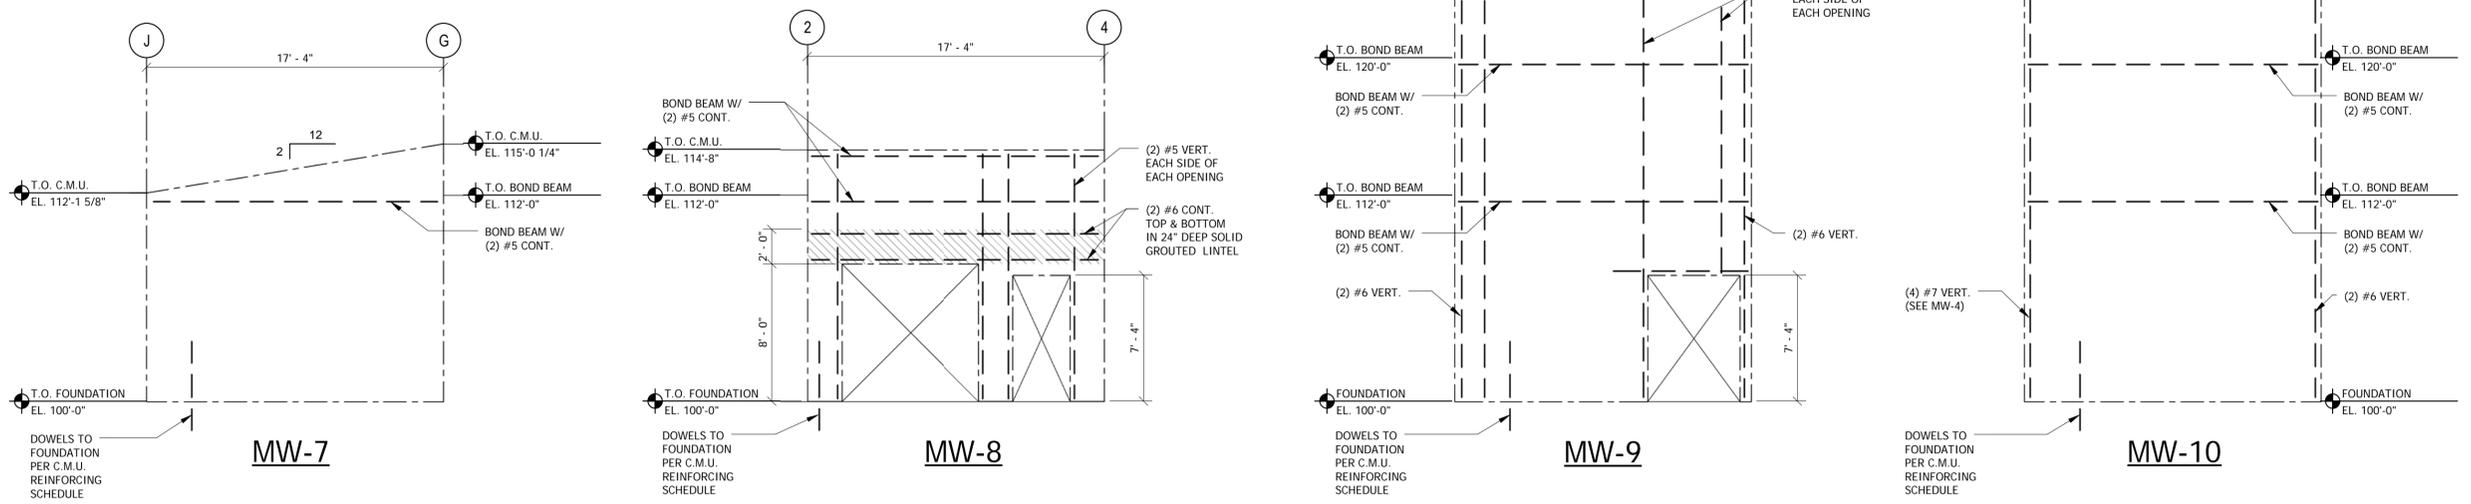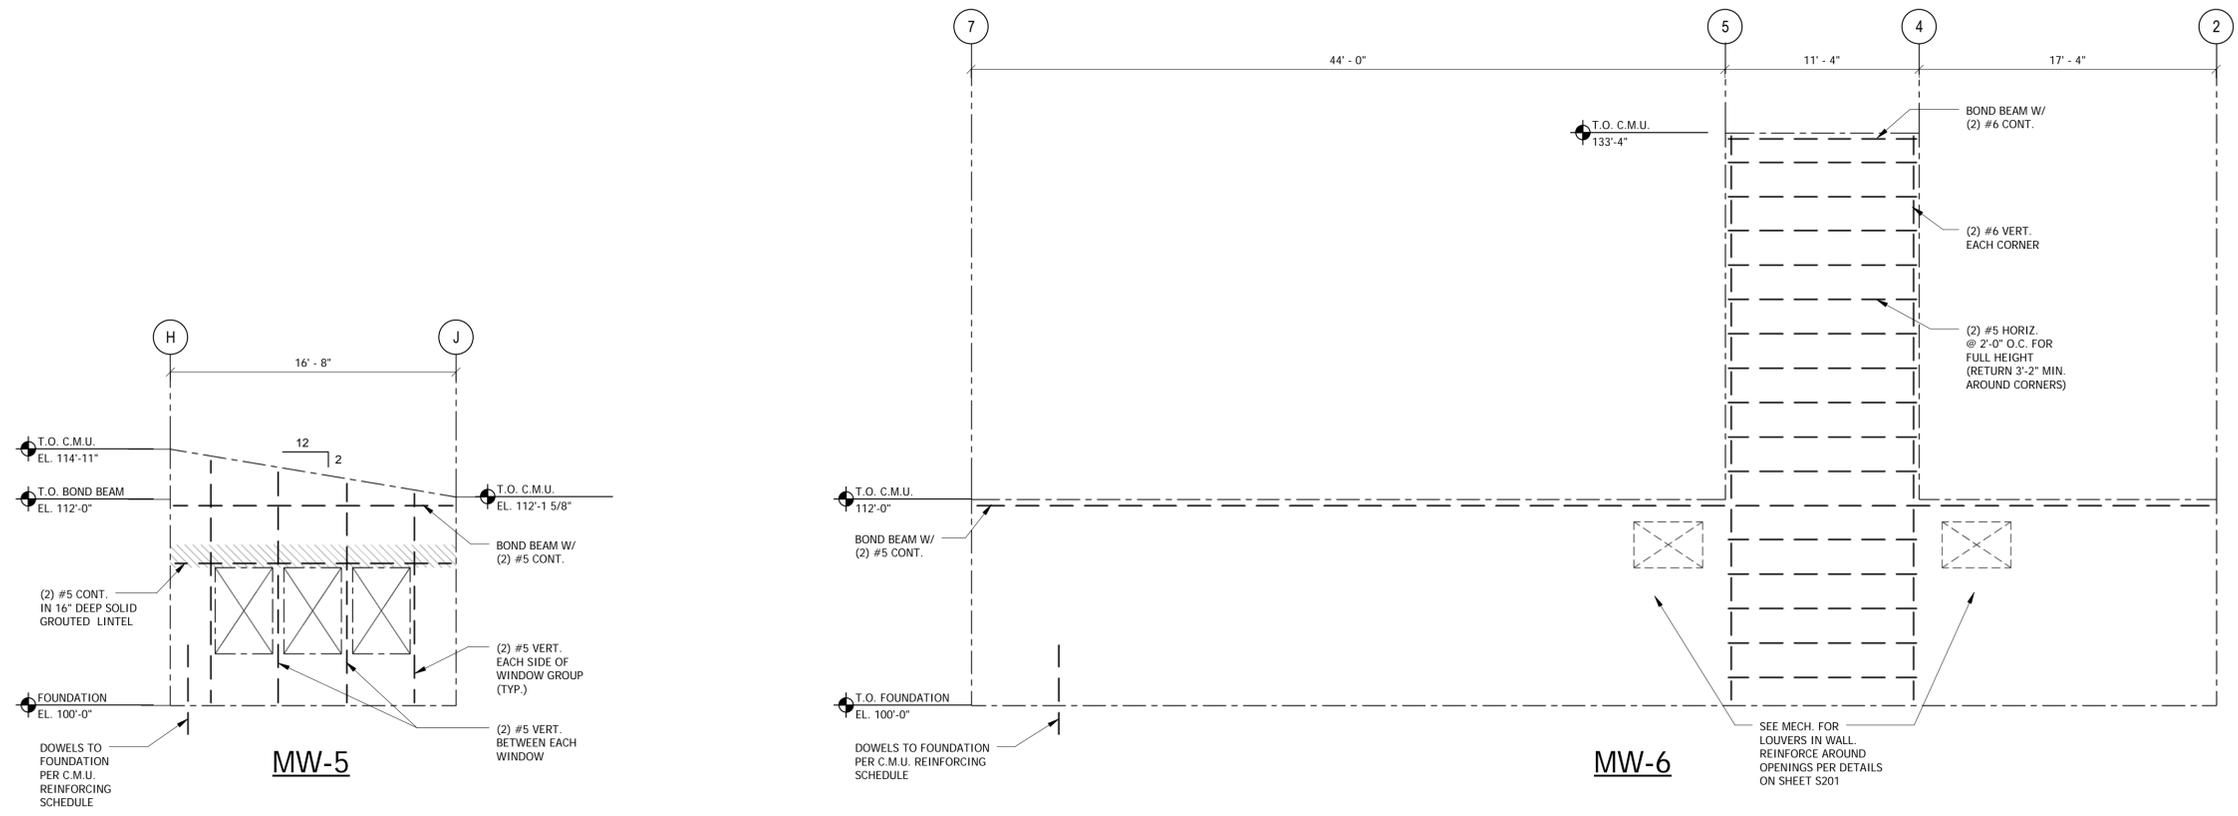


MASONRY WALL ELEVATIONS

3/16" = 1'-0"

STEEL DECK SCHEDULE


DECK				CONCRETE SLAB				DECK PROPERTIES (MINIMUMS)						FASTENERS		COMMENTS	
DECK MARK	DECK TYPE	DECK DEPTH (in.)	DECK FINISH	CONC. ABOVE DECK (in.)	TOTAL THICKNESS (in.)	CONC. TYPE	SLAB REINF.	SPAN CONDITION	DECK GAUGE	MAX. CLEAR CONST. SPAN	INT. DECK BRG. (in.)	EXT. DECK BRG. (in.)	DECK DIAPHRAGM SHEAR (PLF)	SUPERIMPOSED LOAD CAPACITY (UNIFORM OR CONCENTRATED)	SUPPORTS		SIDE LAPS
RD1	1.5B	1 1/2	SHOP PAINTED	--	--	--	--	1-2 SPAN	18	7'-8"	3	1 1/2	364	120 PSF	5/8" PUDDLE WELDS 36/4 PATTERN	(4) #10 TEK SCREWS EA. SPAN	ROOF DECK
								3 SPAN	18	8'-6"	3	1 1/2	364	120 PSF			
FD1	2C	2	GALVANIZED	4	6	NW	6x6-W2.9xW2.9	1-2 SPAN	18	10'-11"	3	1 1/2	--	300 PSF	5/8" PUDDLE WELDS EACH RIB	(4) #10 TEK SCREWS EA. SPAN	NON-COMPOSITE FORM DECK

- NOTES:**
- SEE GENERAL NOTES FOR REQUIRED DECK MATERIALS.
 - DECK WITH HIGHER YIELD STRESS MAY BE USED WITH SP & SN REQUIRED VALUES ADJUSTED BY THE RATIO OF Fy(40)/Fy(PROVIDED).
 - ROOF DECK CAPACITIES ARE TOTAL LOADS AND ARE BASED UPON SUPPORT CENTER TO CENTER DIMENSION.
 - LAP EDGES AND ENDS OF ADJOINING W.W.F. SHEETS AT LEAST TWO MESH SPACINGS.
 - NO PERMANENT SUSPENDED LOADS ARE TO BE SUPPORTED BY THE STEEL DECK.

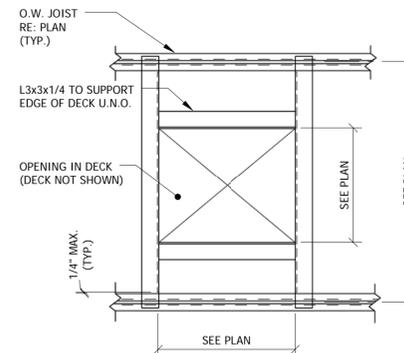

TYP. EDGE SUPPORT @ METAL ROOF DECK PEN.

N.T.S.

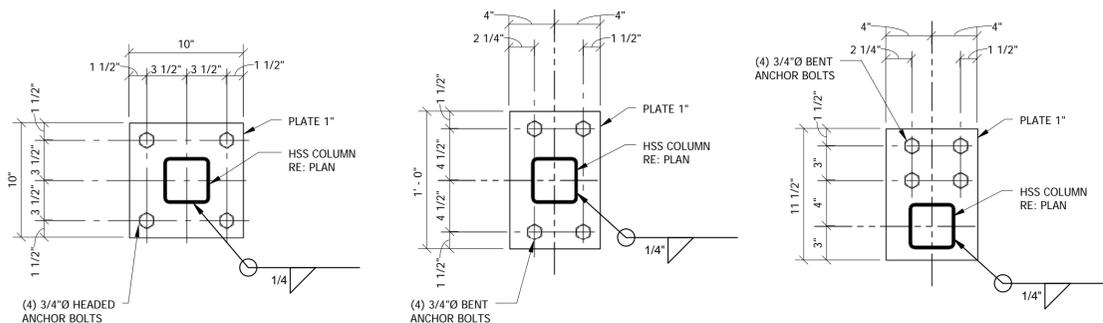


TYPE A

TYPE B

TYPE C

TYPICAL BASE PLATE DETAILS

1 1/2" = 1'-0"

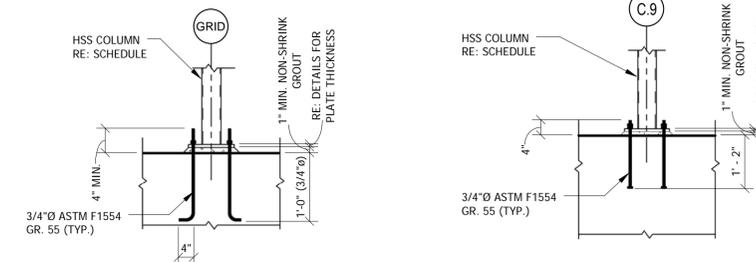


TYPICAL COLUMN ANCHOR BOLTS

EXTERIOR COLUMN ANCHOR BOLTS

TYPICAL ANCHOR BOLT DETAILS

1/2" = 1'-0"

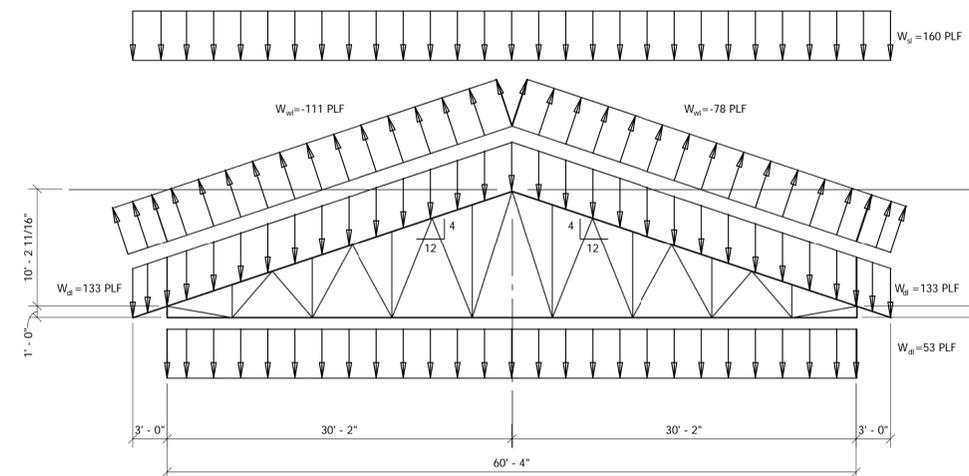

RJ1

LH GABLE ROOF JOISTS

1/8" = 1'-0"

- LOADS SHOWN ARE UNFACTORED LOADS.
- LOAD DESIGNATIONS ARE THUS: W_s = SNOW LOAD
 W_d = DEAD LOAD
 W_w = WIND LOAD (POSITIVE OR NEGATIVE INDICATES LOAD ACTING TOWARDS OR AWAY FROM THE ROOF, RESPECTIVELY)
- WHERE WIND LOAD PRESSURE AWAY FROM THE ROOF EXCEEDS THE TOTAL DEAD LOAD, DESIGN JOISTS FOR NET UPLIFT.
- DESIGN FOR WIND LOAD AS SHOWN AND WITH WIND LOADS REVERSED.
- WEB CONFIGURATION IS APPROXIMATE. DESIGN AND LAYOUT OF WEB MEMBERS SHALL BE BY JOIST MANUFACTURER.

ORCHARD MESA FIRE STATION #4

GRAND JUNCTION, COLORADO

TYPICAL STEEL FRAMING DETAILS

NO: ISSUED FOR: DATE:



PROJECT STATUS: 100% CD

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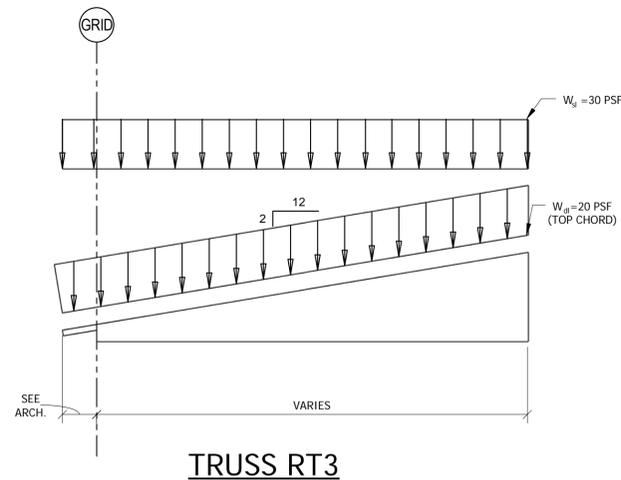
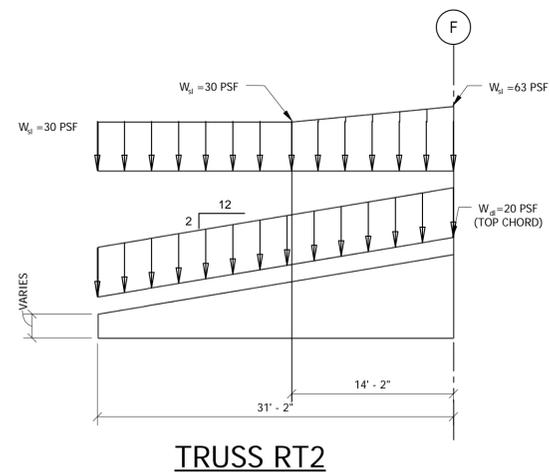
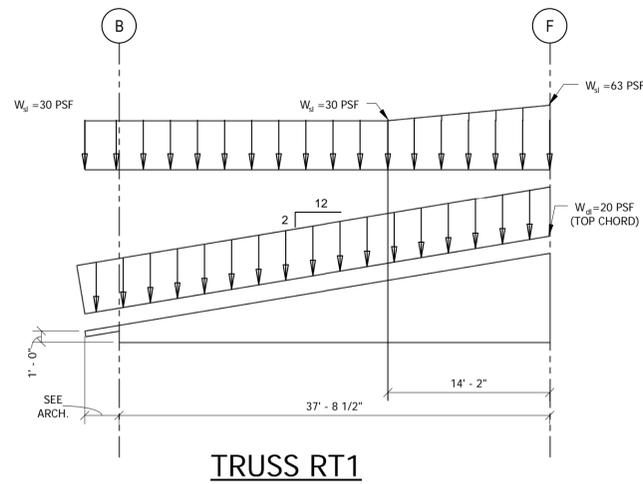
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04/10/15


SHEET NO:

PROJECT NO:
14.108


S204



WOOD ROOF TRUSS PROFILES & LOAD DIAGRAMS

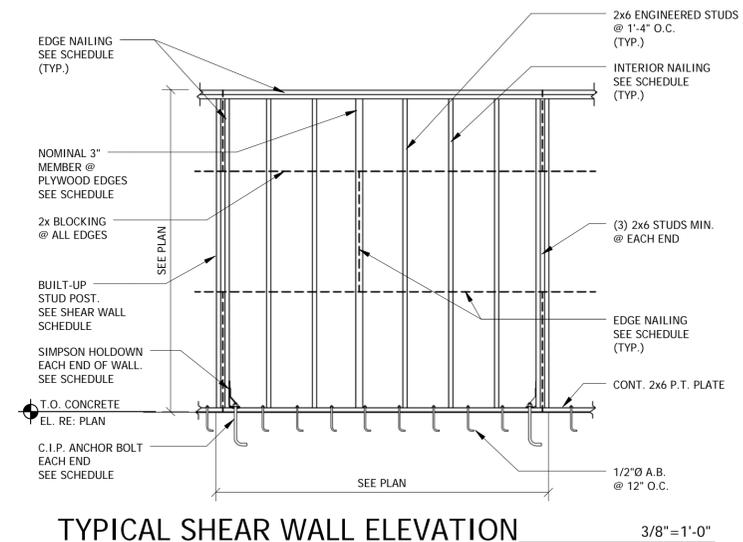

1. NO OPENINGS ALLOWED IN SHEAR PANELS UNLESS APPROVED BY THE STRUCTURAL ENGINEER.
2. ANCHOR BOLTS AT HOLDOWNS SHALL CONFORM TO ASTM F1554 GRADE 55.

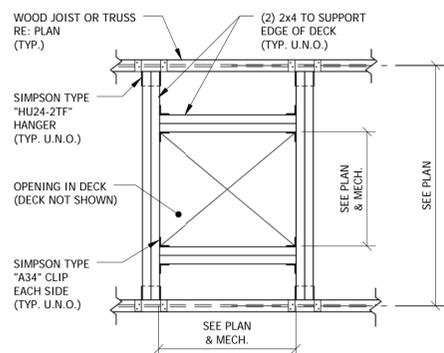

TYP. EDGE SUPPORT @ PLYWOOD ROOF DECK PEN.

PROVIDE OPENING SUPPORTS FOR ALL ROOF PENETRATIONS 6"Ø AND LARGER.

N.T.S.

PLYWOOD/SHEAR WALL NAILING SCHEDULE						
USE	PLYWOOD THICKNESS	SPAN/INDEX RATIO	EDGE NAILING	INTERIOR NAILING	HOLD DOWN	HEADED ANCHOR BOLT
ROOF	19/32"	32/16	10d @ 4" O.C. (BOUNDARIES) 10d @ 6" O.C. (ALL OTHER EDGES)	10d @ 12" O.C.	--	--
WALL	15/32"	24/0	8d @ 6" O.C.	8d @ 12" O.C.	--	--
SHEAR WALL:		15/32"	10d @ 2" O.C.	10d @ 12" O.C.	"HD12"	1"Ø
		15/32"	10d @ 4" O.C.	10d @ 12" O.C.	"HD9B"	7/8"Ø

1. PLYWOOD FOR ROOFS, FLOORS, AND SHEAR WALL SHEATHING SHALL BE APA GRADE TRADEMARKED CDX W/ EXTERIOR GLUE. LAY UP PLYWOOD W/ FACE GRAIN PERPENDICULAR TO SUPPORTS AND STAGGER JOINTS. ALL NAILS SHALL BE COMMON NAILS; RING SHANKED FOR ROOF AND FLOOR SHEATHING. REFER TO TABLE ABOVE FOR USE REQUIREMENTS.
2. OSB SHEATHING MAY BE USED AS AN ALTERNATE TO PLYWOOD W/ PRIOR APPROVAL OF OWNER AND CONTRACTOR. OSB SHEATHING SHALL COMPLY WITH THE APA PLYWOOD DESIGN SPECIFICATION AND SHALL HAVE A SPAN RATING EQUIVALENT TO, OR BETTER, THAN THE PLYWOOD IT REPLACES. ATTACHMENT AND THICKNESS (WITHIN 1/32") SHALL BE THE SAME AS THE PLYWOOD IT REPLACES.
3. ALL EDGES OF ROOF SHEATHING SHALL BE BLOCKED WITH A 2" NOMINAL WOOD FRAMING MEMBER.
4. AT ABUTTING SHEAR WALL PANEL EDGES, STUDS SHALL BE NO LESS THAN A SINGLE 3" NOMINAL MEMBER AND NAILS SHALL BE STAGGERED.
5. PROVIDE (3) 2" NOMINAL STUDS AND HOLDOWNS AT EACH END OF SHEAR WALL.
6. HOLDOWNS LISTED ARE BY SIMPSON STRONG-TIE. ALTERNATES MUST BE EQUIVALENT AND MUST BE APPROVED BY THE STRUCTURAL ENGINEER.
7. HEADED ANCHOR BOLTS AT HOLDOWNS SHALL CONFORM TO ASTM F1554 GRADE 55. ANCHORS SHALL HAVE A MINIMUM EMBEDMENT OF 2'-0" AND SHALL HAVE A MINIMUM PROJECTION OF 6".

**ORCHARD MESA
FIRE STATION #4**

GRAND JUNCTION, COLORADO

**TYPICAL WOOD
FRAMING DETAILS**

NO: ISSUED FOR: DATE:



PROJECT STATUS: 100% CD

DRAWN BY: KDN CHECKED BY: JAD

DATE:

04/10/15

SHEET NO:

PROJECT NO:

14.108

S205

ORCHARD MESA
FIRE STATION #4

GRAND JUNCTION, COLORADO

FOUNDATION
SECTIONS














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DATE: 04/10/15 SHEET NO:

PROJECT NO: 14.108 **S300**



ORCHARD MESA
FIRE STATION #4

GRAND JUNCTION, COLORADO

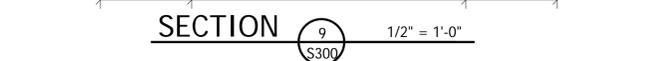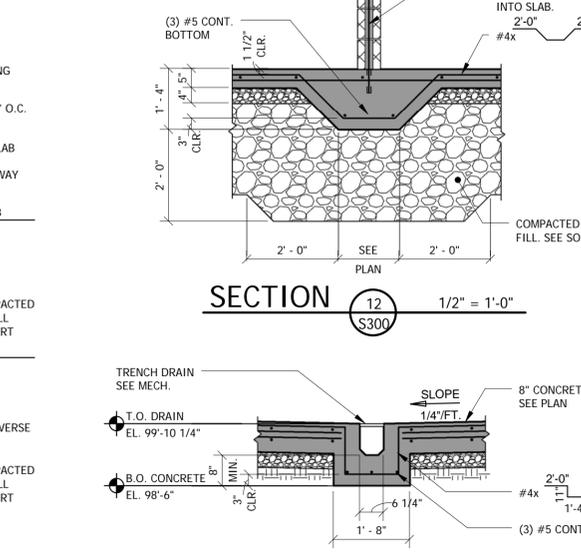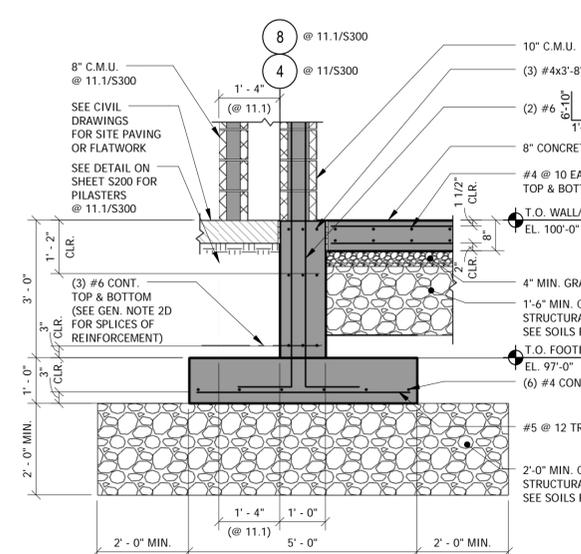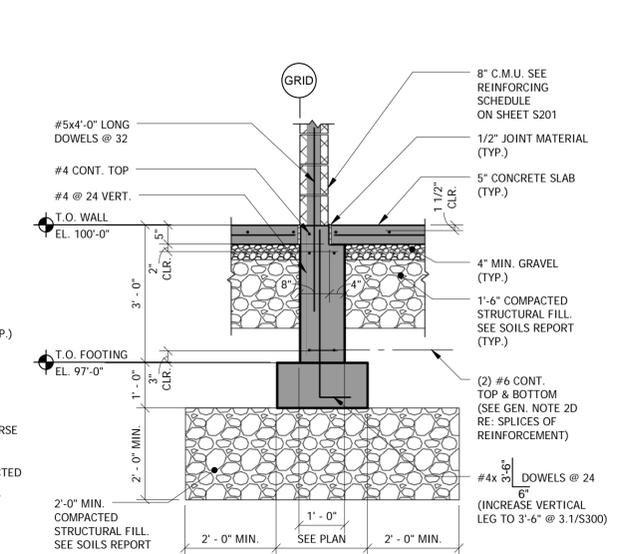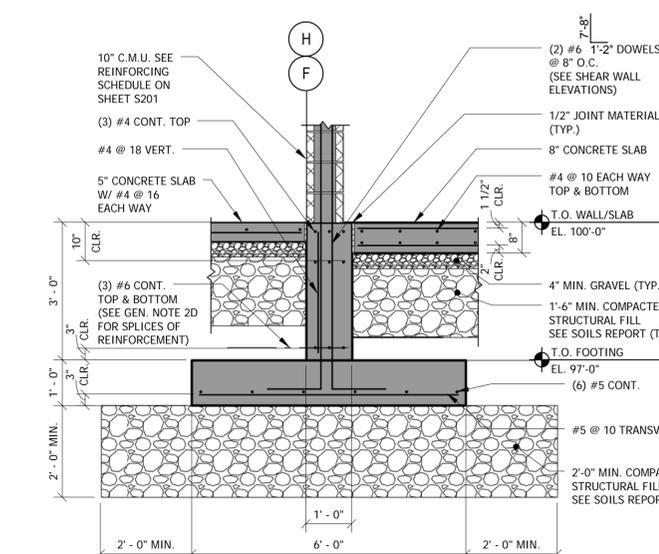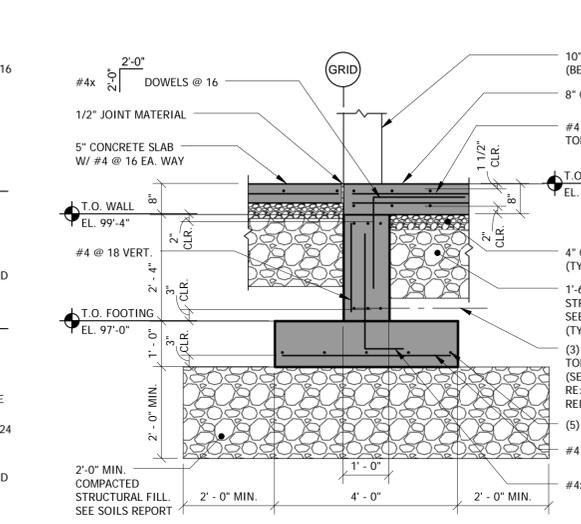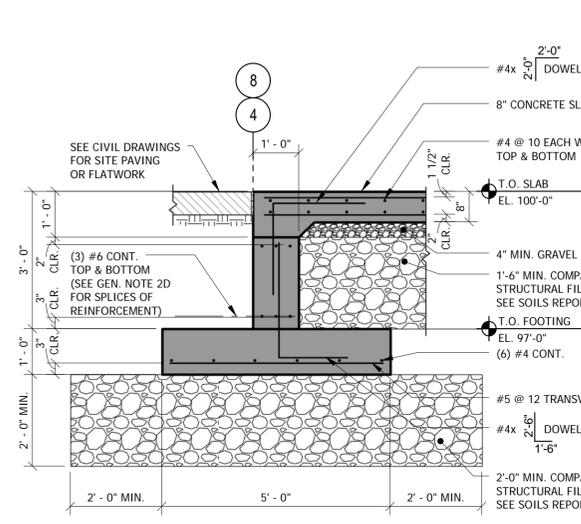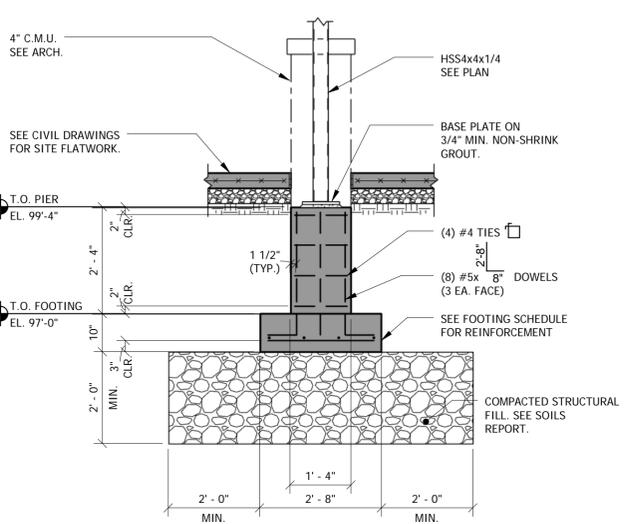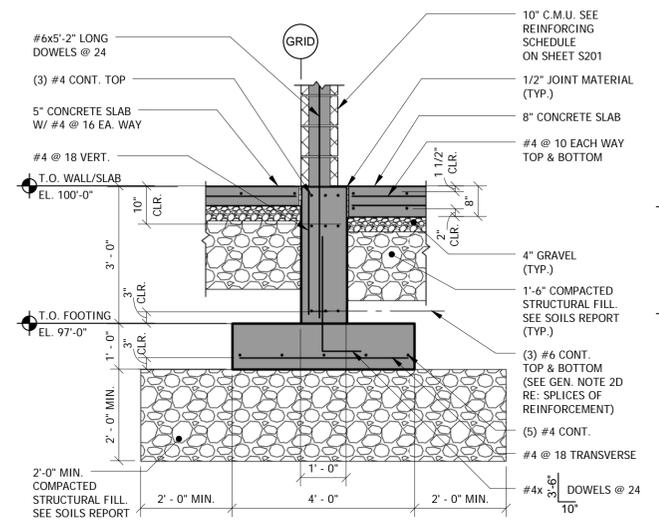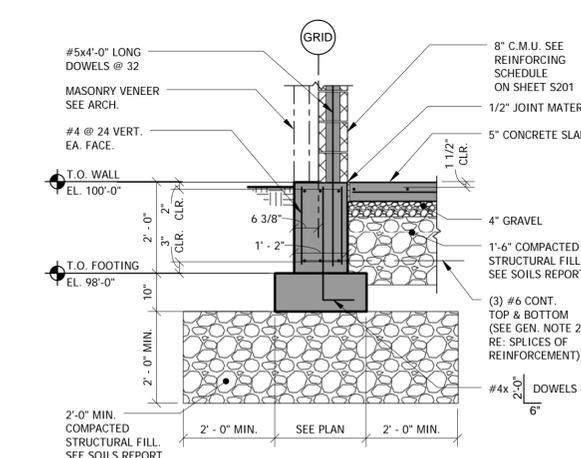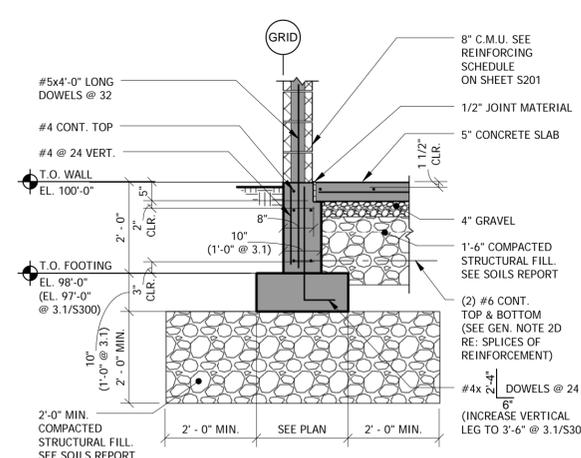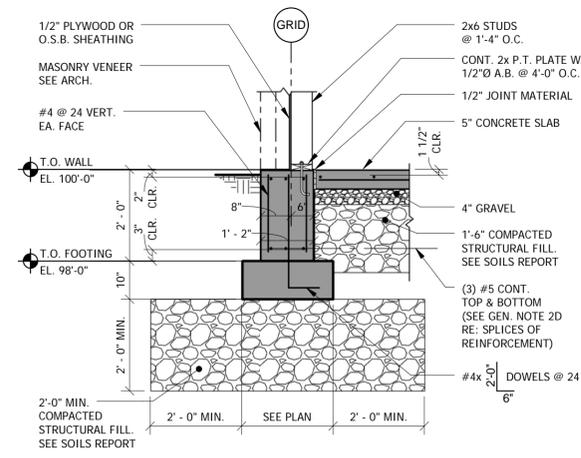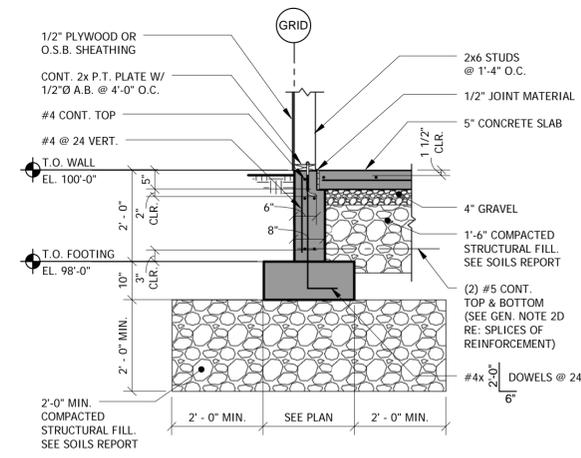FRAMING
SECTIONS

NO: ISSUED FOR: DATE:




PROJECT STATUS: 100% CD


DRAWN BY: KDN CHECKED BY: JAD

DATE: 04/10/15 SHEET NO:


PROJECT NO: 14.108 **S301**

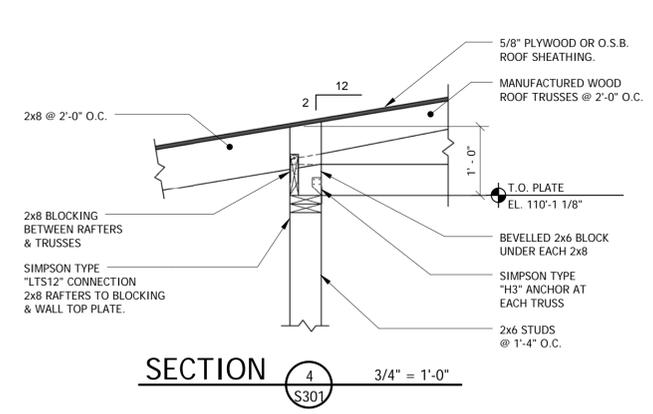


SECTION 4 3/4" = 1'-0"
S301

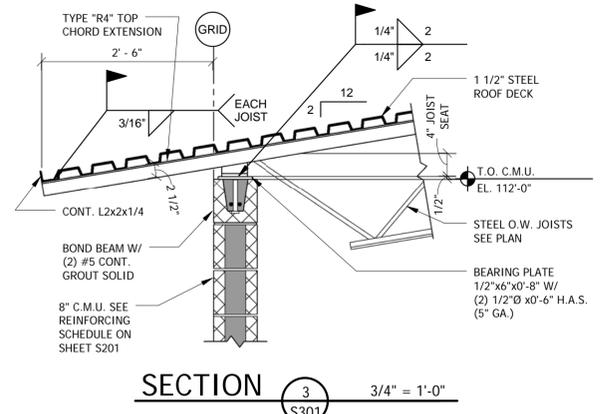


SECTION 3 3/4" = 1'-0"
S301

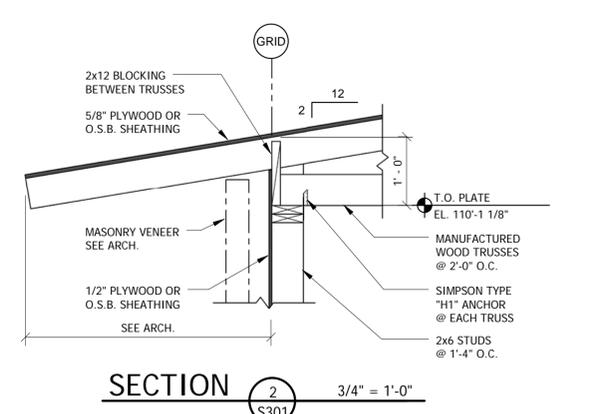


SECTION 2 3/4" = 1'-0"
S301

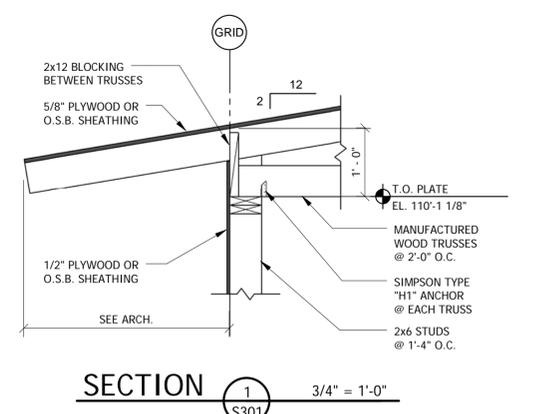


SECTION 1 3/4" = 1'-0"
S301

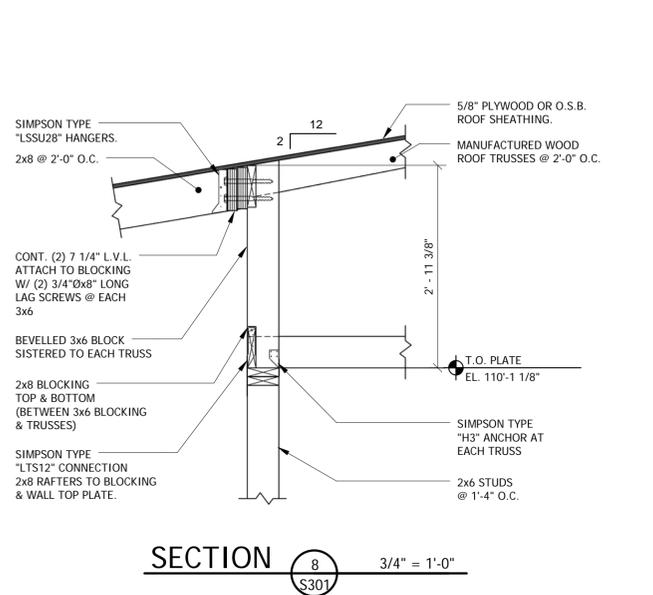


SECTION 8 3/4" = 1'-0"
S301

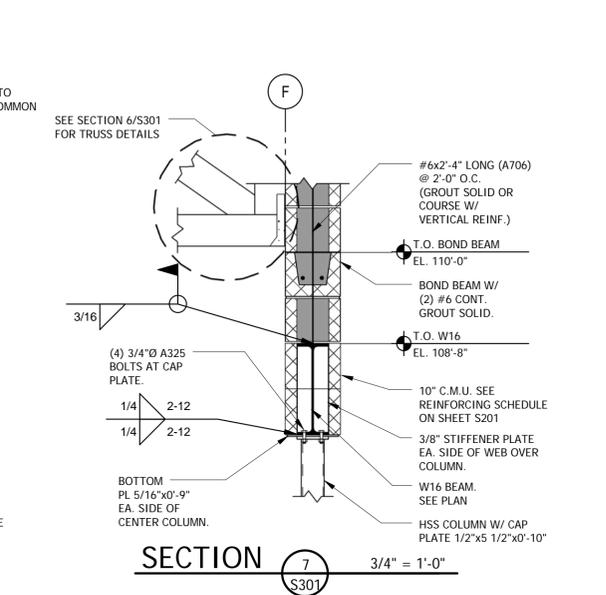


SECTION 7 3/4" = 1'-0"
S301

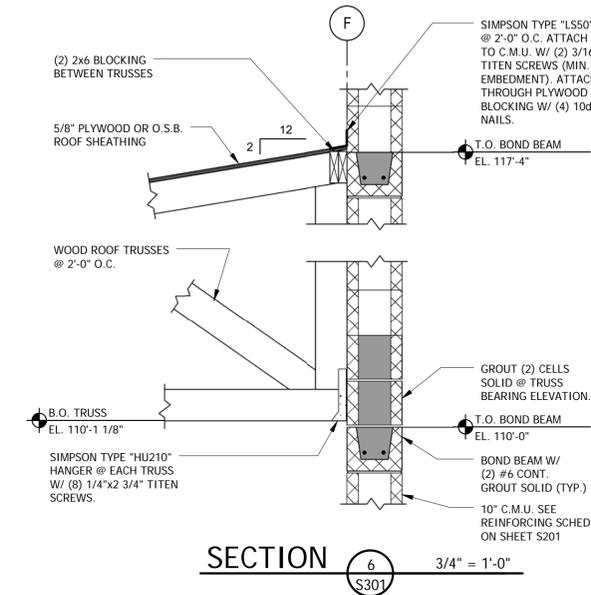


SECTION 6 3/4" = 1'-0"
S301

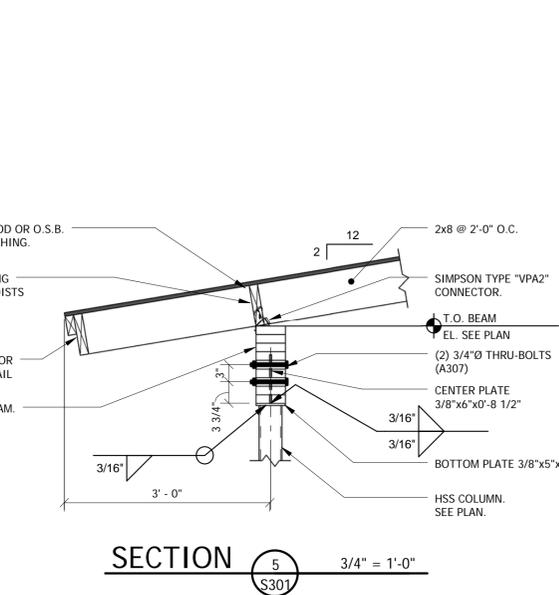


SECTION 5 3/4" = 1'-0"
S301

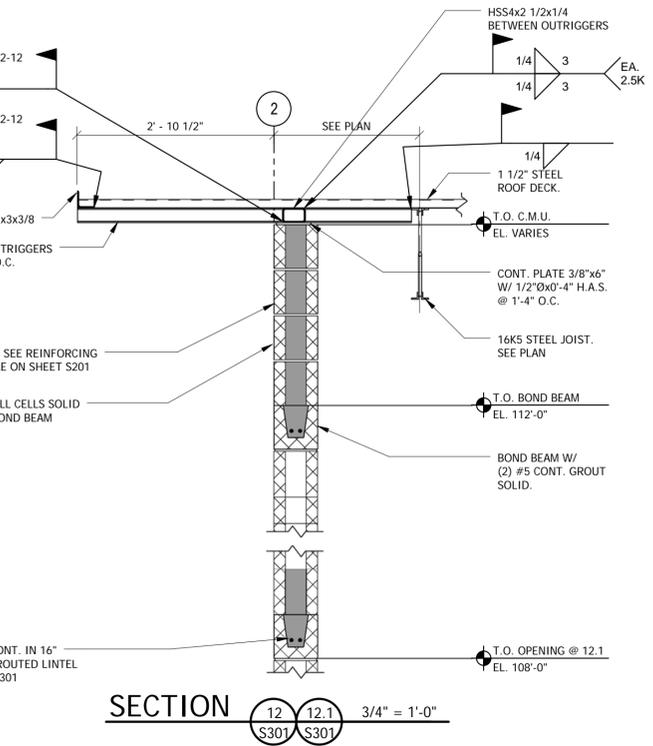


SECTION 12 3/4" = 1'-0"
S301

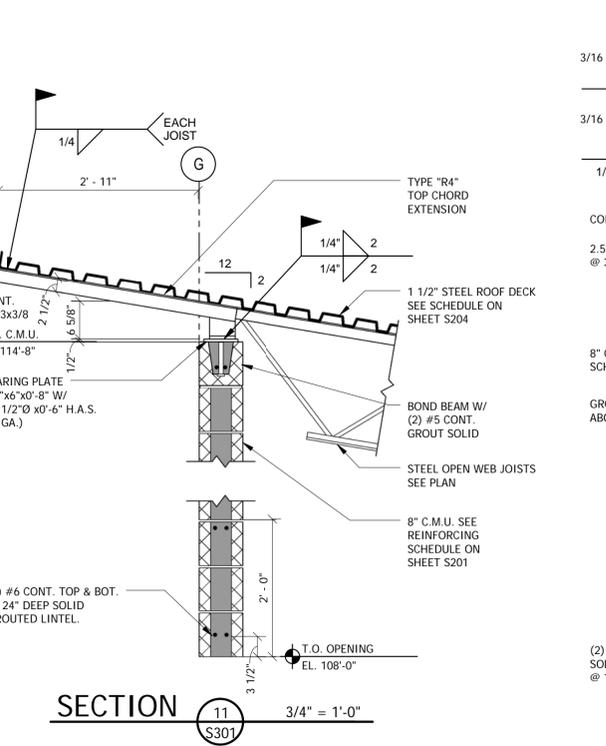

SECTION 11 3/4" = 1'-0"
S301












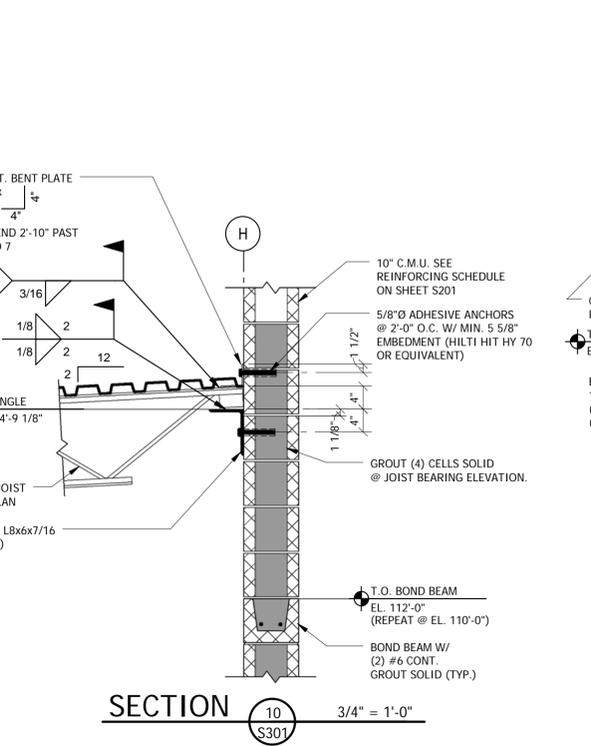


SECTION 10 3/4" = 1'-0"
S301

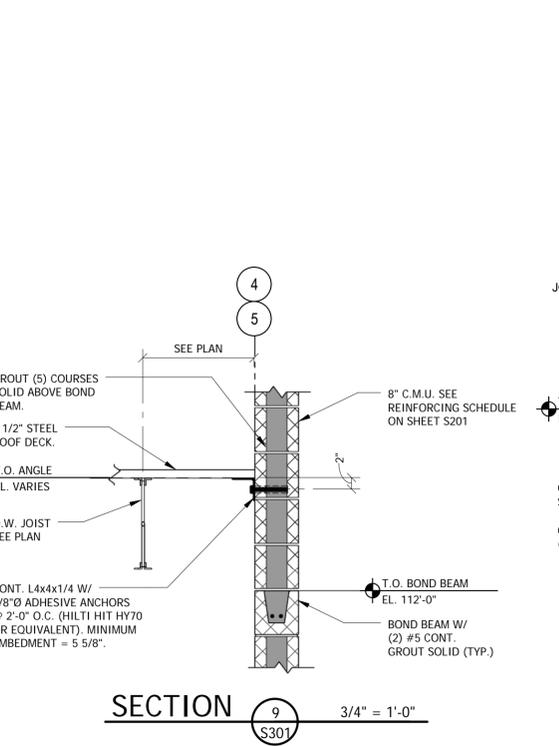

SECTION 9 3/4" = 1'-0"
S301

TS3 1/2"x2 1/2"x 1/4" ok RFI 017

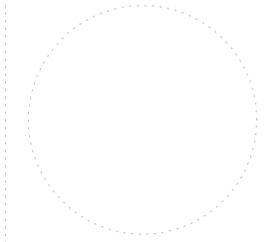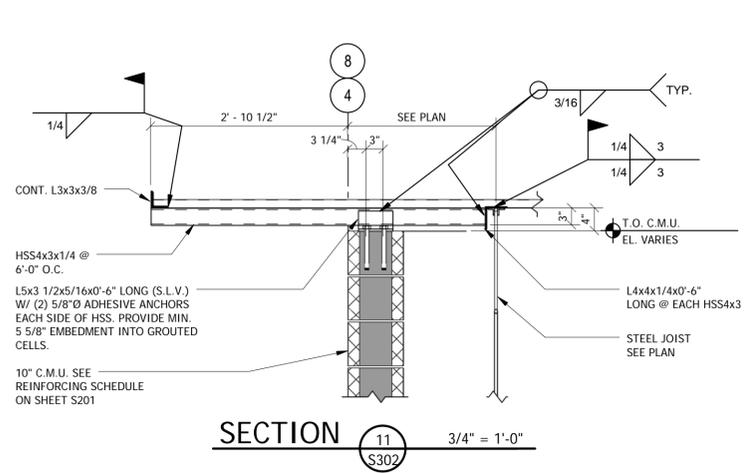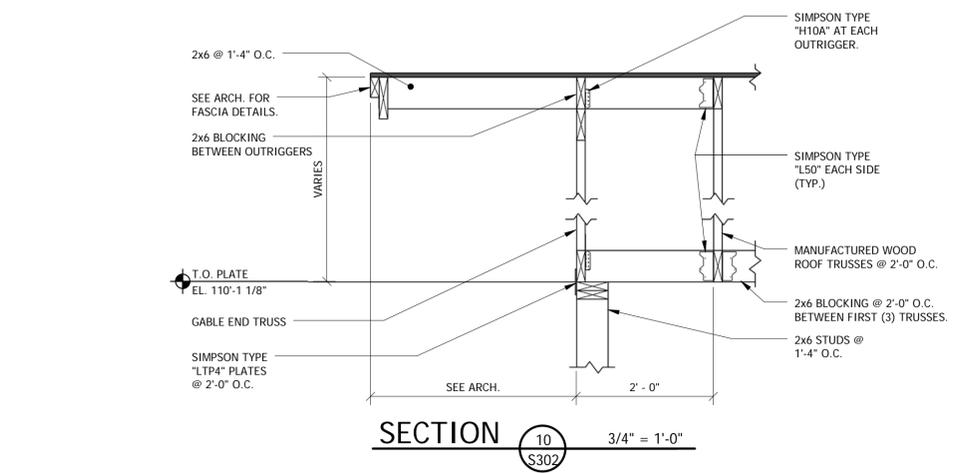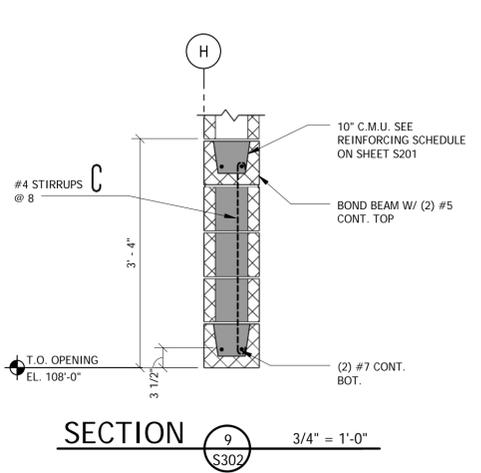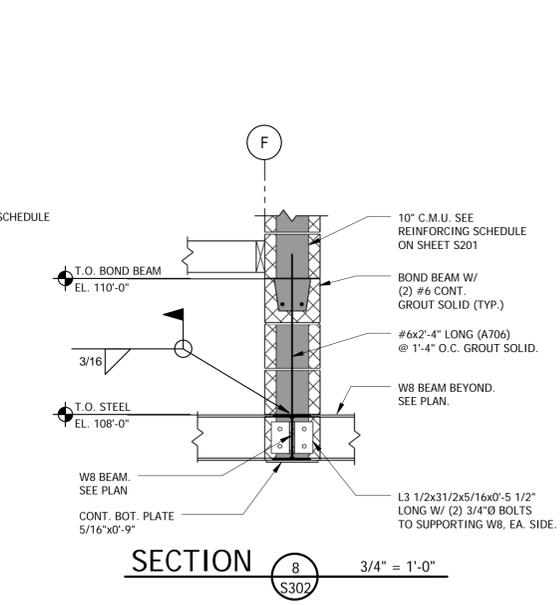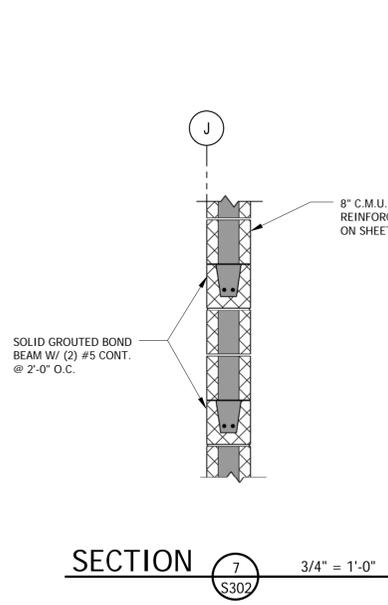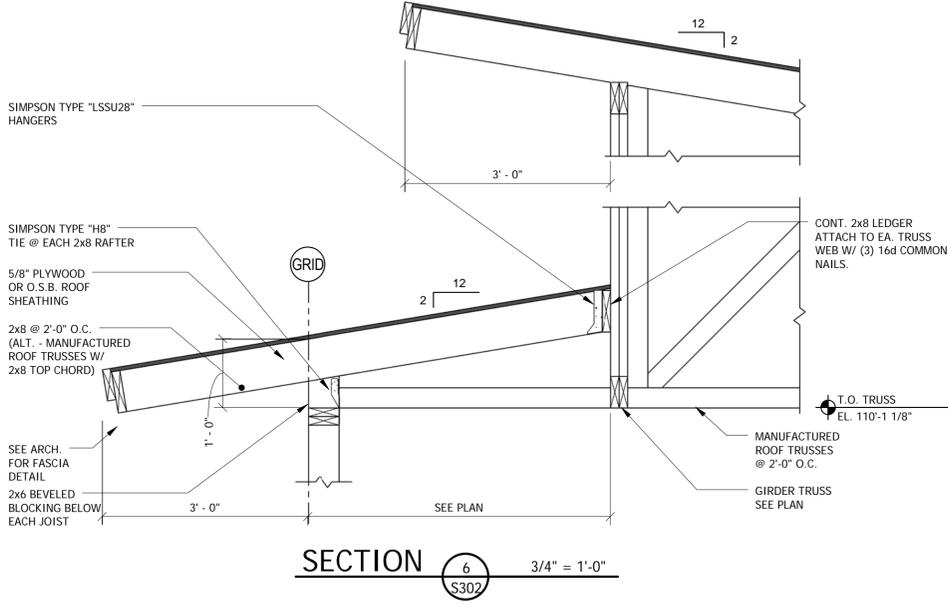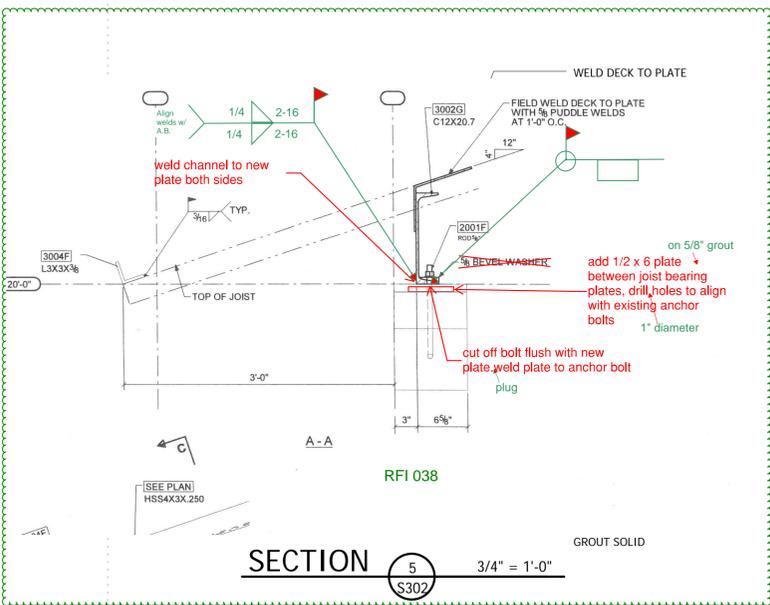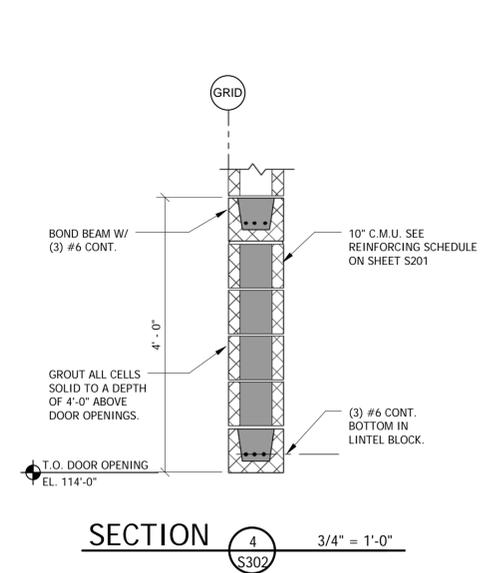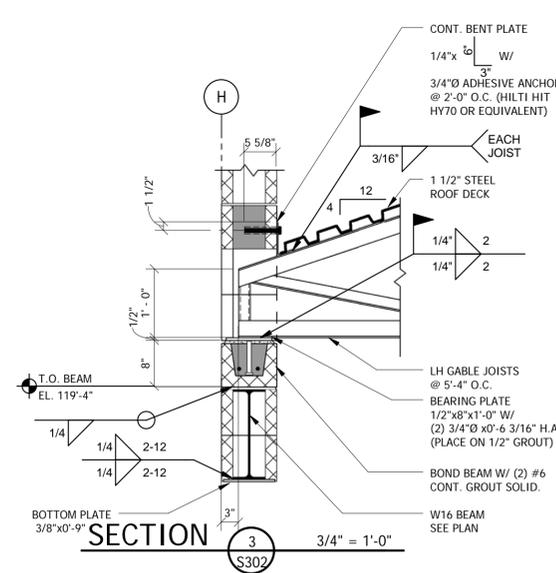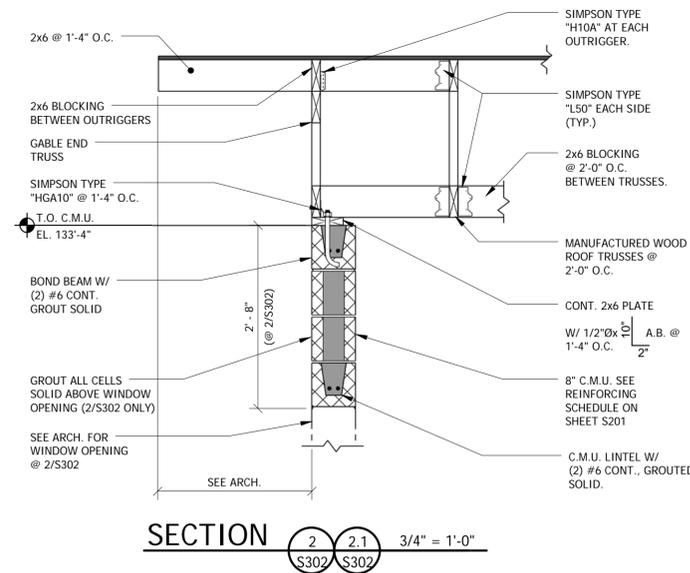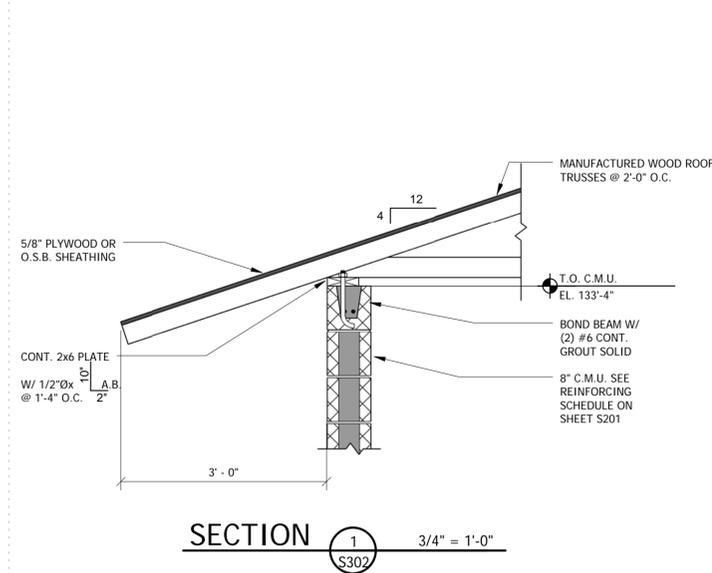


ORCHARD MESA
FIRE STATION #4

GRAND JUNCTION, COLORADO

FRAMING
SECTIONS


NO: ISSUED FOR: DATE:

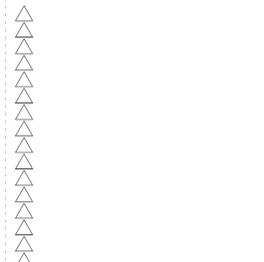

PROJECT STATUS: 100% CD
DRAWN BY: JDG, KDN CHECKED BY: JAD


DATE: 04/10/15 SHEET NO:

PROJECT NO: 14.108 **S302**

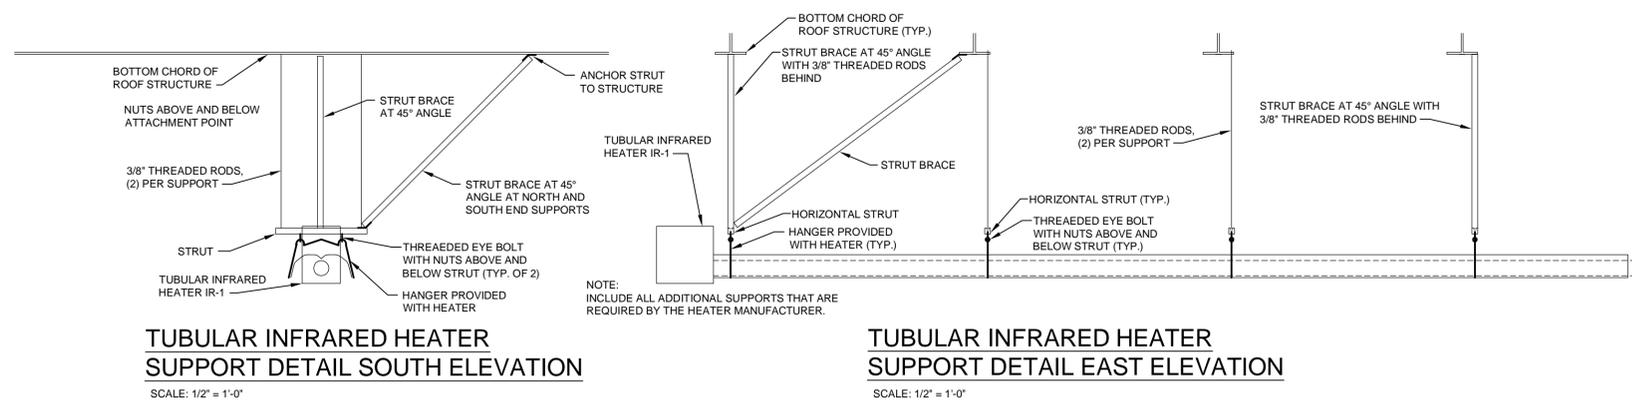


**TUBULAR INFRARED HEATER
SUPPORT DETAIL SOUTH ELEVATION**
SCALE: 1/2" = 1'-0"


**TUBULAR INFRARED HEATER
SUPPORT DETAIL EAST ELEVATION**
SCALE: 1/2" = 1'-0"

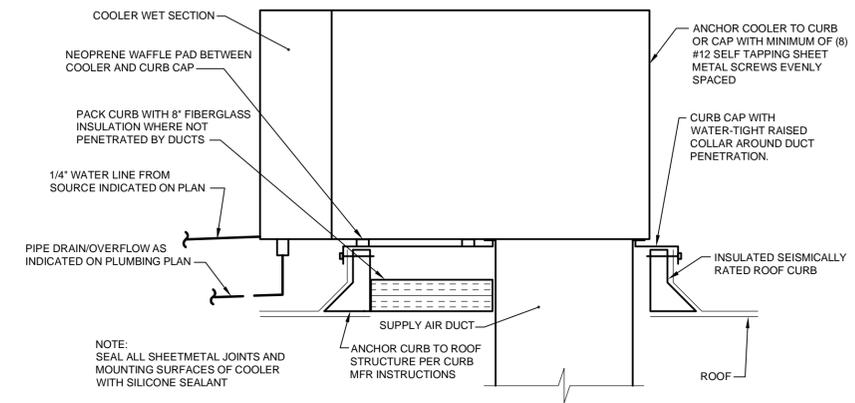


EVAPORATIVE COOLER MOUNTING DETAIL (BASE BID)
NO SCALE

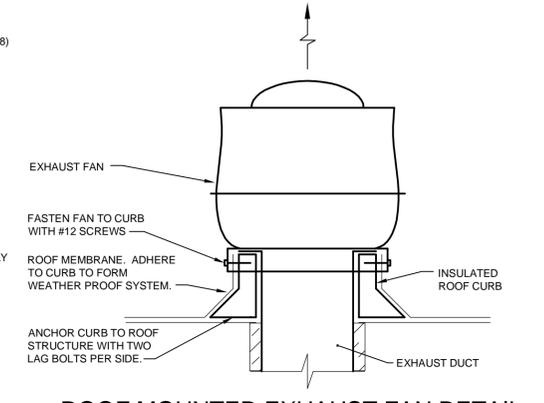


ROOF MOUNTED EXHAUST FAN DETAIL
NO SCALE

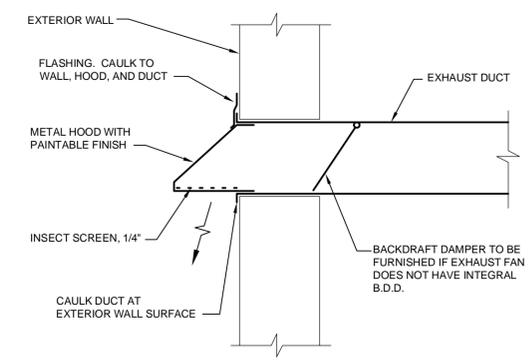


EXHAUST WALL JACK DETAIL
NO SCALE

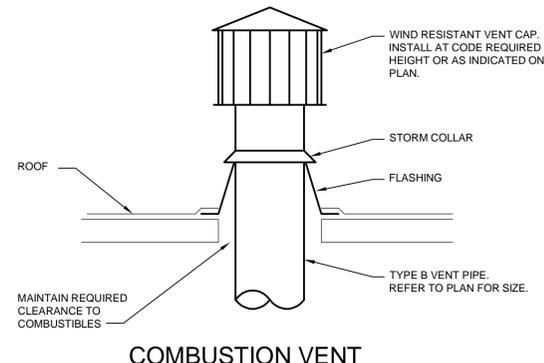


**COMBUSTION VENT
THROUGH ROOF DETAIL**
NO SCALE

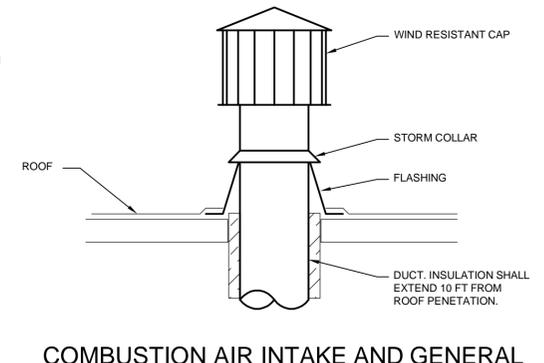


**COMBUSTION AIR INTAKE AND GENERAL
EXHAUST THROUGH ROOF DETAIL**
NO SCALE

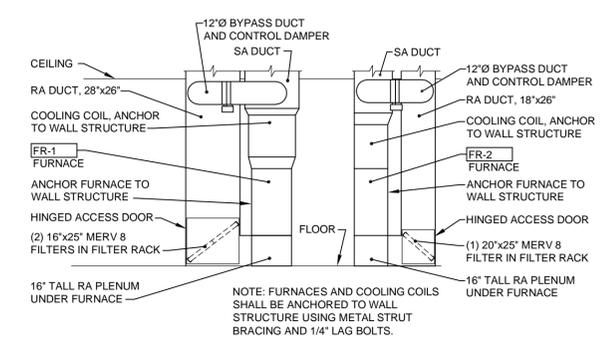

**FURNACE DUCT AND FILTER
INSTALLATION DETAIL**
SCALE: 1/4" = 1'-0"

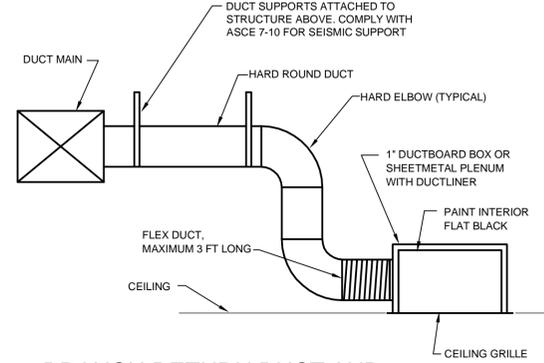

**BRANCH RETURN DUCT AND
CEILING GRILLE INSTALLATION DETAIL**
NO SCALE

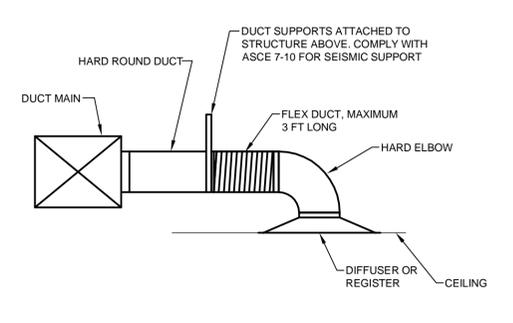

**BRANCH SUPPLY DUCT
INSTALLATION DETAIL**
NO SCALE

**ORCHARD MESA
FIRE STATION #4**

GRAND JUNCTION, COLORADO

MECHNICAL DETAILS

NO: ISSUED FOR: DATE:



PROJECT STATUS:
CONSTRUCTION DOCUMENTS

DRAWN BY: DCR CHECKED BY:

DATE:
04/10/2015

SHEET NO:

PROJECT NO:
1443 **M301**

4/10/2015 2:18:05 PM

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GENERAL NOTES

THE MECHANICAL CONTENT OF THIS DRAWING IS DIAGRAMMATIC AND NOT NECESSARILY TO SCALE.

THE CONTRACTOR SHALL MAKE MINOR ADJUSTMENTS TO LOCATIONS OF DUCTWORK, EQUIPMENT, PIPING, AND SUPPORTS IN ORDER TO COORDINATE WITH BUILDING CONSTRUCTION AND WORK OF OTHER TRADES.


REFER TO SCHEDULES AND SPECIFICATIONS FOR EQUIPMENT AND MATERIALS OF CONSTRUCTION.

INSTALL WASTE PIPING CLEANOUTS WHERE INDICATED AND AS REQUIRED BY 2012 INTERNATIONAL PLUMBING CODE.

WATER PIPING SHALL BE INSTALLED TIGHT TO BOTTOM CHORD OF ROOF TRUSSES AND MUST BE COORDINATED WITH DUCTWORK INSTALLATION DUE TO SEVERELY LIMITED SPACE ABOVE CEILINGS.

EQUIPMENT AND PIPING SHALL BE SUPPORTED AND BRACED IN COMPLIANCE WITH ASCE STANDARD 7, MINIMUM DESIGN LOADS FOR BUILDINGS AND OTHER STRUCTURES.

ALL HORIZONTAL PIPING IN APPARATUS BAYS SHALL BE SUPPORTED AT UNDERSIDE OF ROOF STRUCTURE USING METAL STRUT AND PIPING CLAMPS. PROVIDE SHIMS TO ACHIEVE PROPER SLOPE.

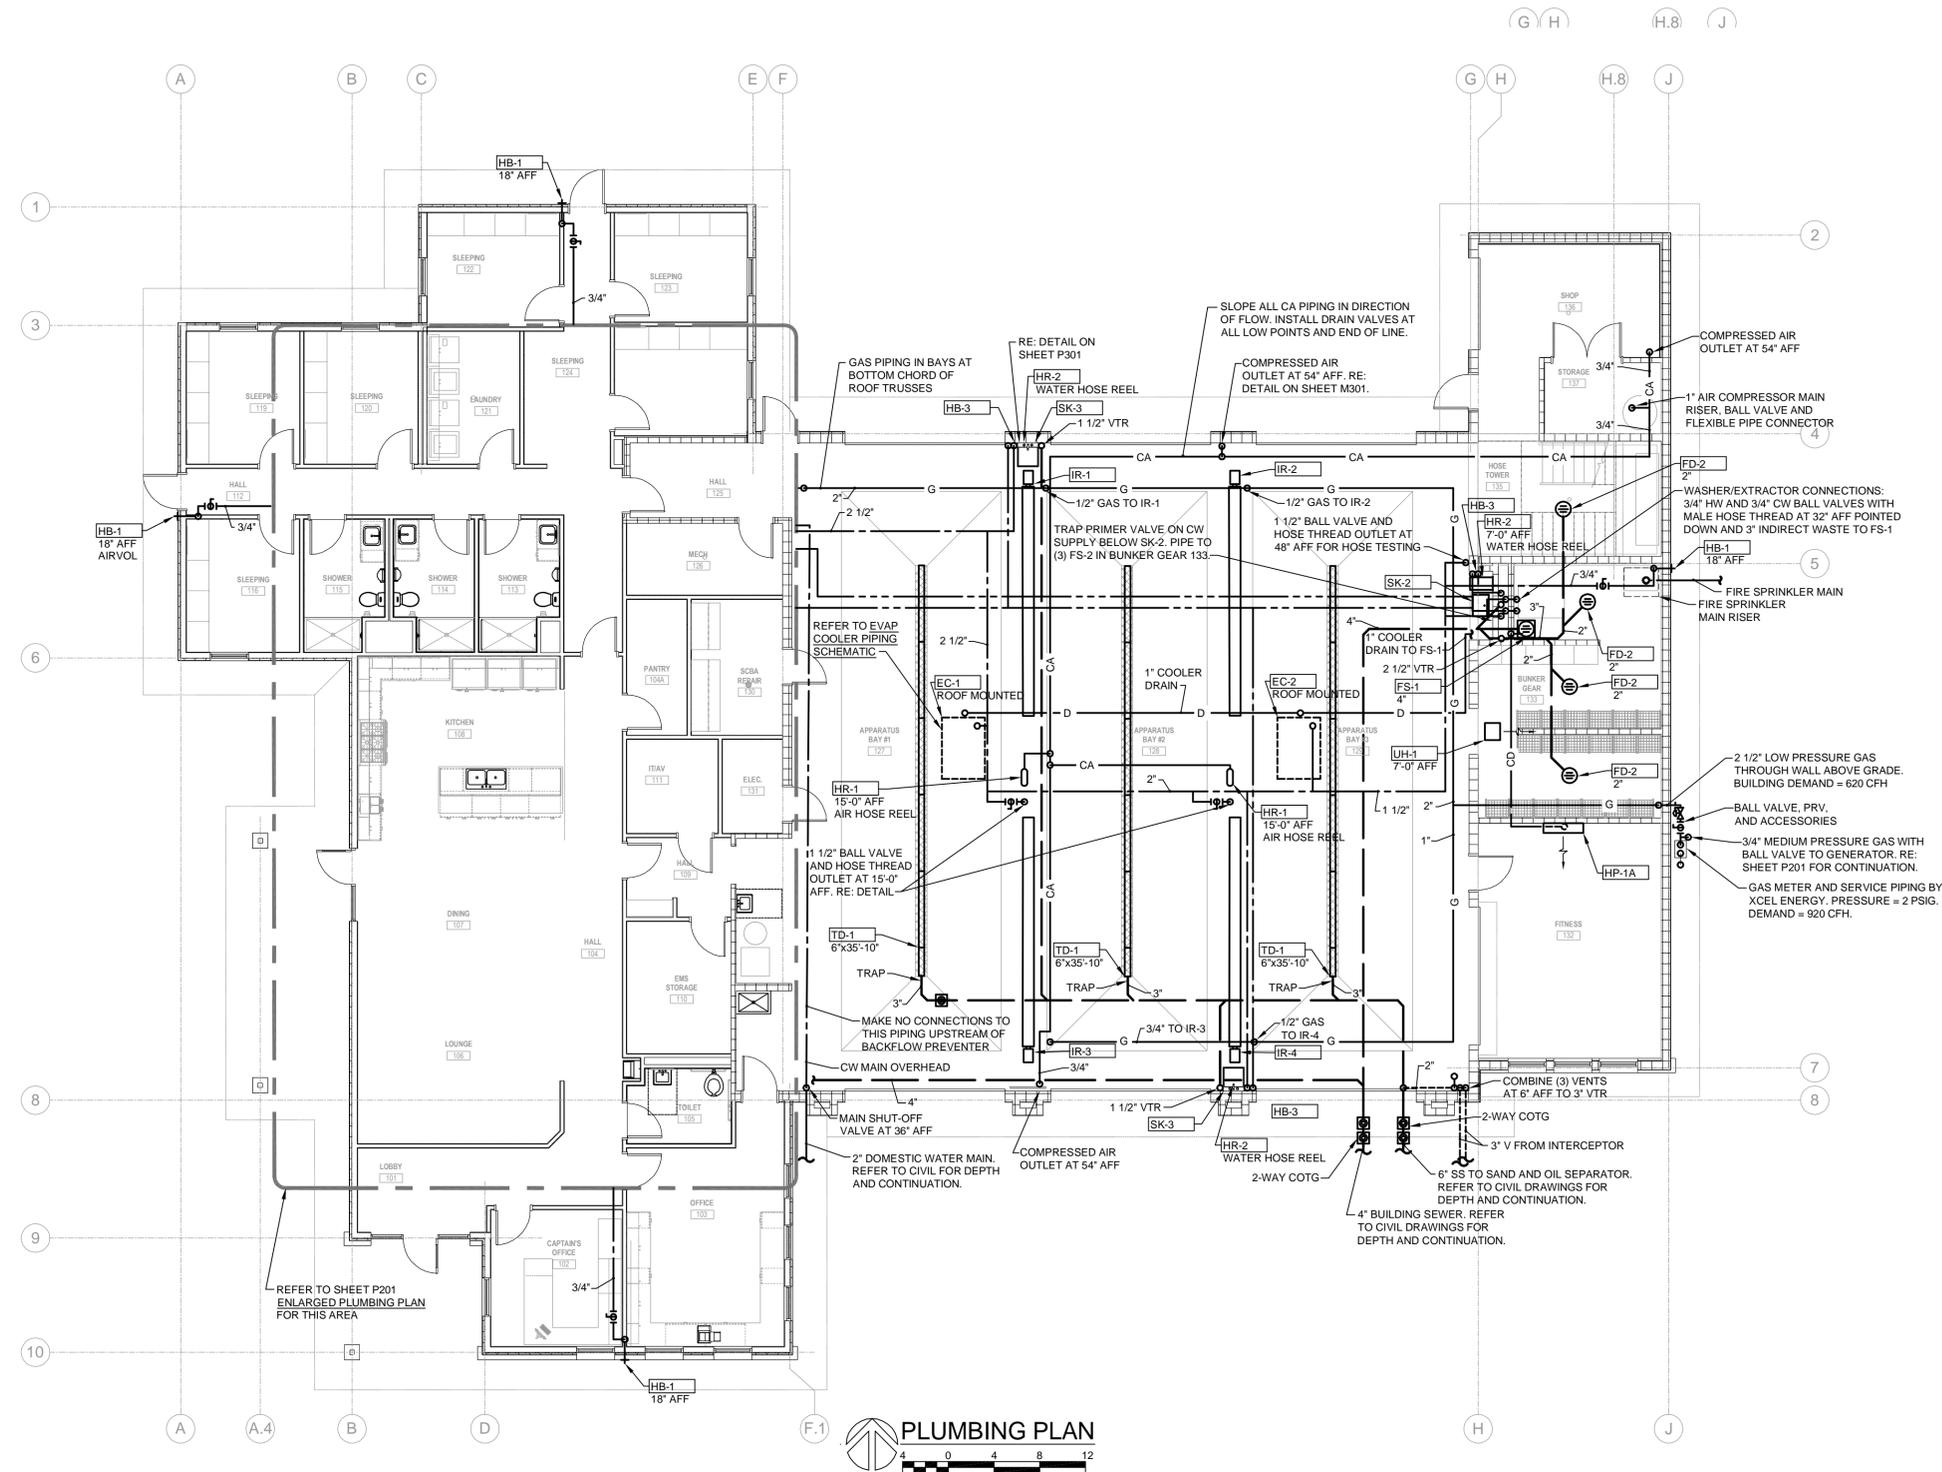

ORCHARD MESA
FIRE STATION #4

GRAND JUNCTION, COLORADO

PLUMBING PLAN

NO: ISSUED FOR: DATE:



PROJECT STATUS:
CONSTRUCTION DOCUMENTS

DRAWN BY: DCR CHECKED BY:


DATE:
04/10/2015 SHEET NO:

PROJECT NO:
1443 P101


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ENLARGED PLUMBING PLAN
 0 4 8 12
 OFFICE



GAS PIPING SITE PLAN
 0 4 8 12 16

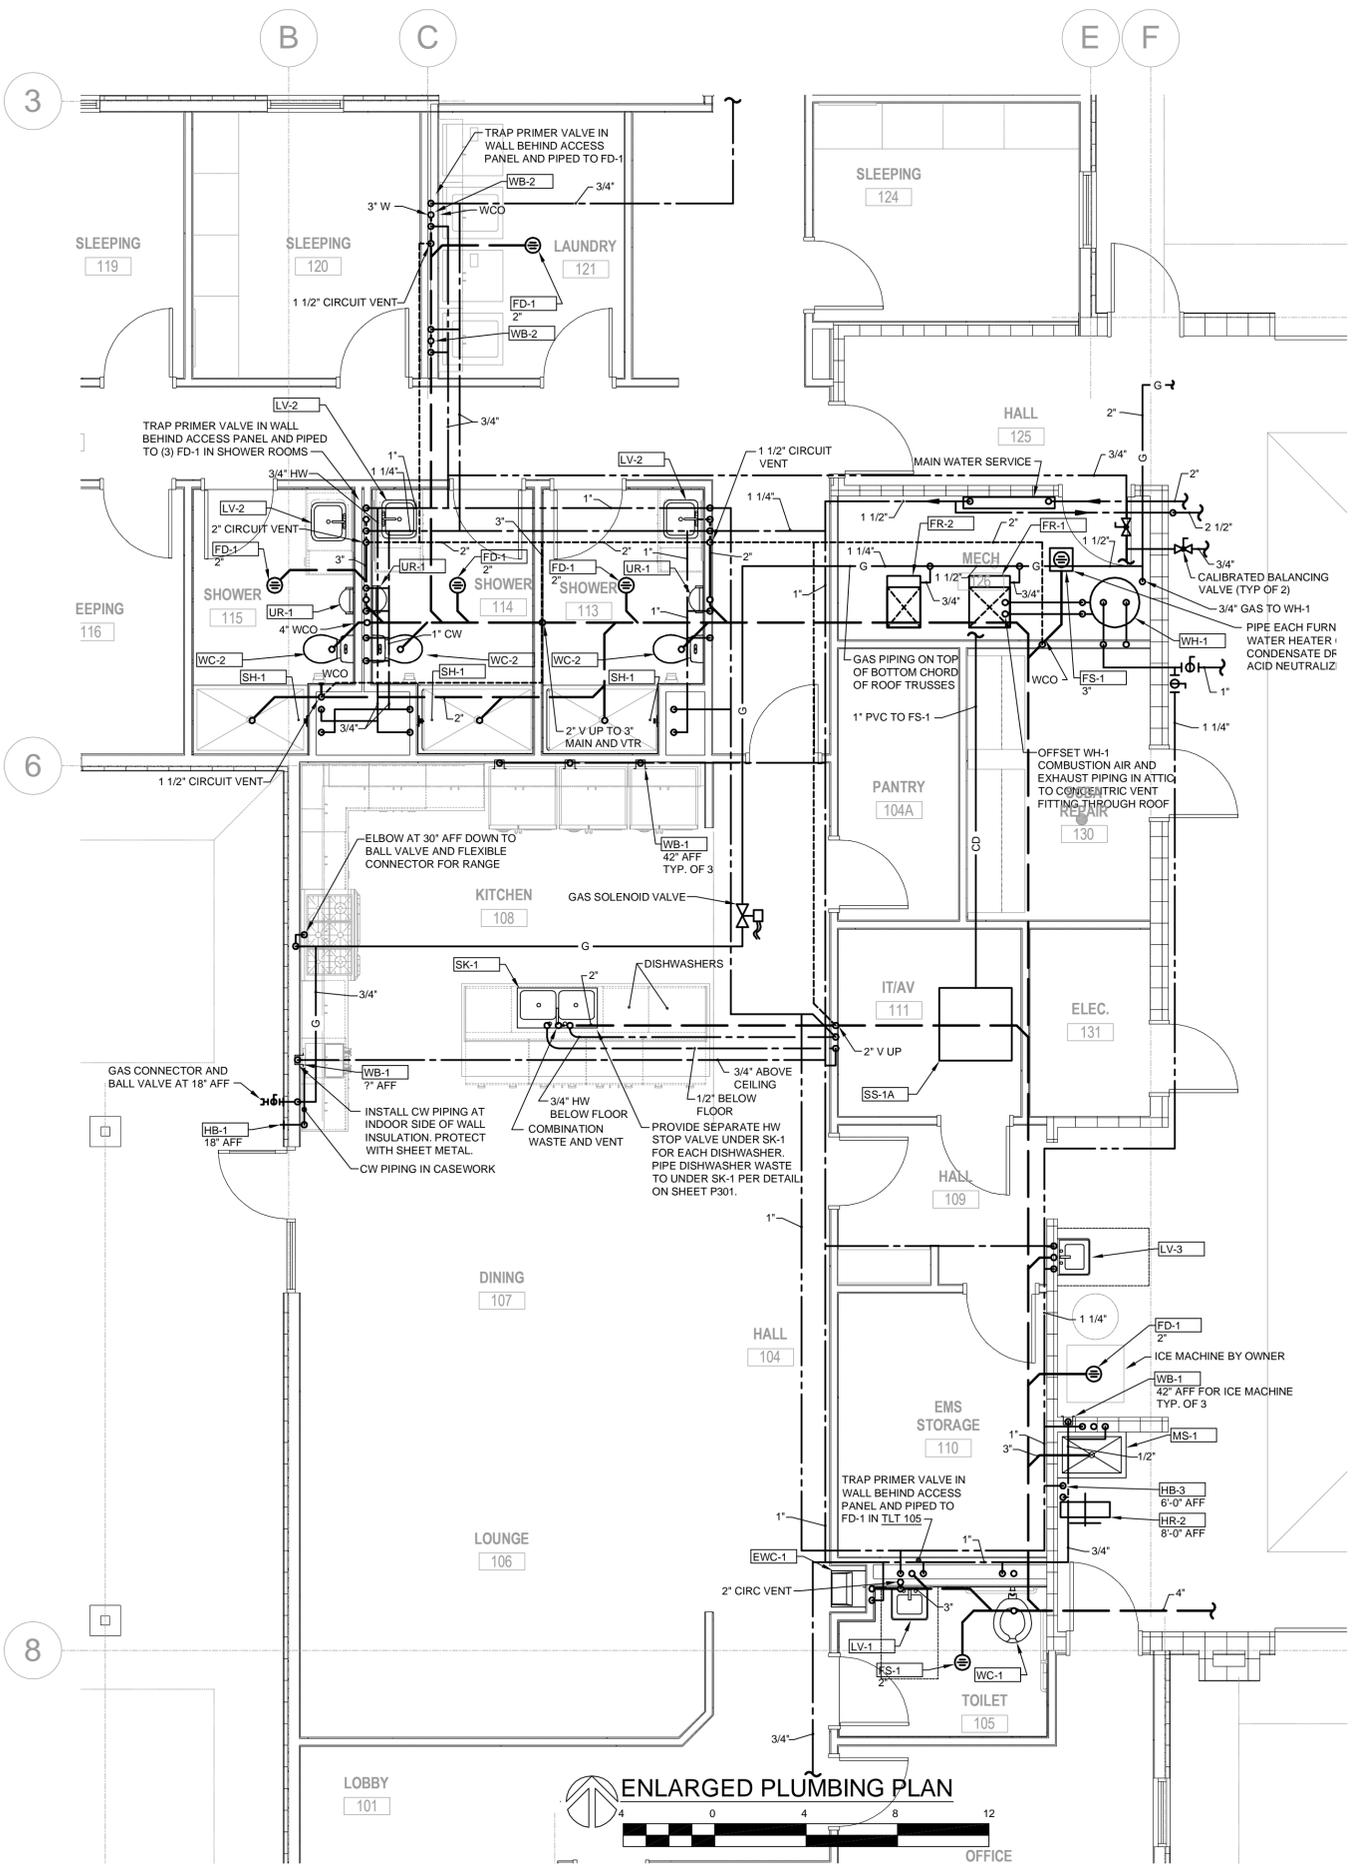GENERAL NOTES

THE MECHANICAL CONTENT OF THIS DRAWING IS DIAGRAMMATIC AND NOT NECESSARILY TO SCALE.

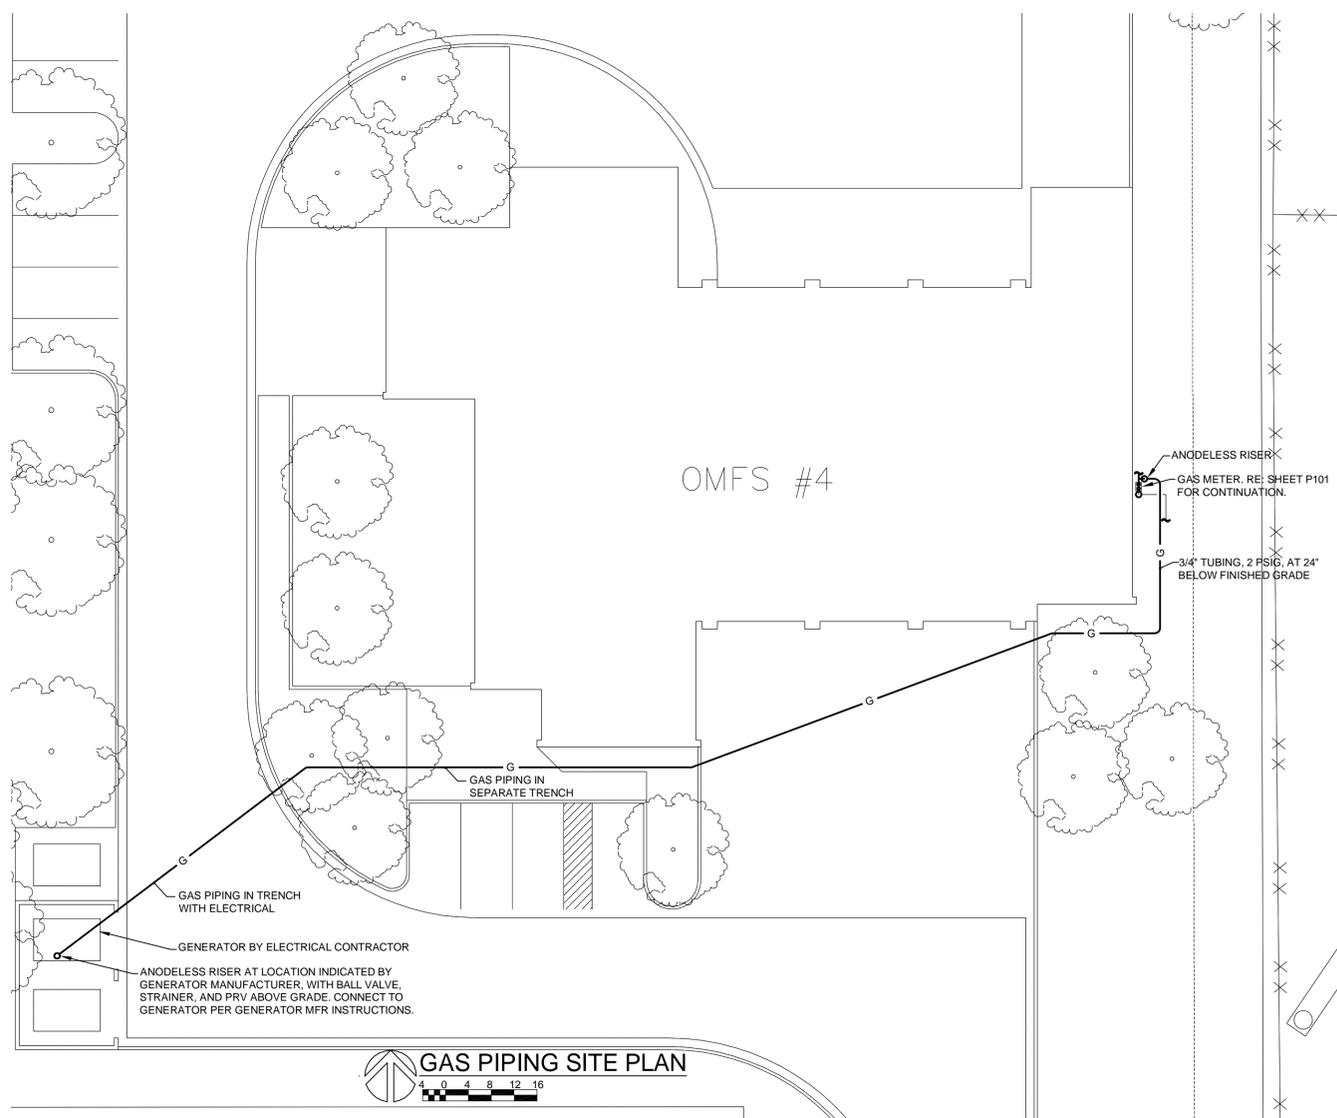THE CONTRACTOR SHALL MAKE MINOR ADJUSTMENTS TO LOCATIONS OF DUCTWORK, EQUIPMENT, PIPING, AND SUPPORTS IN ORDER TO COORDINATE WITH BUILDING CONSTRUCTION AND WORK OF OTHER TRADES.

REFER TO SCHEDULES AND SPECIFICATIONS FOR EQUIPMENT AND MATERIALS OF CONSTRUCTION.

INSTALL WASTE PIPING CLEANOUTS WHERE INDICATED AND AS REQUIRED BY 2012 INTERNATIONAL PLUMBING CODE.

WATER PIPING SHALL BE INSTALLED TIGHT TO BOTTOM CHORD OF ROOF TRUSSES AND MUST BE COORDINATED WITH DUCTWORK INSTALLATION DUE TO SEVERELY LIMITED SPACE ABOVE CEILINGS.

EQUIPMENT AND PIPING SHALL BE SUPPORTED AND BRACED IN COMPLIANCE WITH ASCE STANDARD 7, MINIMUM DESIGN LOADS FOR BUILDINGS AND OTHER STRUCTURES.

ALL OVERHEAD HORIZONTAL PIPING GAS PIPING SHALL BE IN ATTIC AND SHALL BE SUPPORTED FROM ROOF STRUCTURE USING METAL STRUT AND PIPING CLAMPS.

ALL OVERHEAD HORIZONTAL WATER PIPING SHALL BE SUPPORTED AT UNDERSIDE OF ROOF STRUCTURE USING METAL STRUT AND PIPING CLAMPS.

CHAMBERLIN ARCHITECTS
 ENHANCING EVERYDAY LIVING THROUGH DESIGN

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 Engineering for HVAC, Refrigeration, and Plumbing



358 ECHO CANYON COURT, GRAND JUNCTION, CO 81507-9594
 PHONE 970-434-9819 / FAX 970-434-9815 / CELL 970-280-1781 / cma@ralston.net

ORCHARD MESA FIRE STATION #4

GRAND JUNCTION, COLORADO

ENLARGED PLUMBING PLAN AND GAS PIPING SITE PLAN

NO: ISSUED FOR: DATE:




PROJECT STATUS:
 CONSTRUCTION DOCUMENTS

DRAWN BY: DCR CHECKED BY:


DATE:
04/10/2015 SHEET NO.:

PROJECT NO:
1443 P201


©2012 CHAMBERLIN ARCHITECTS

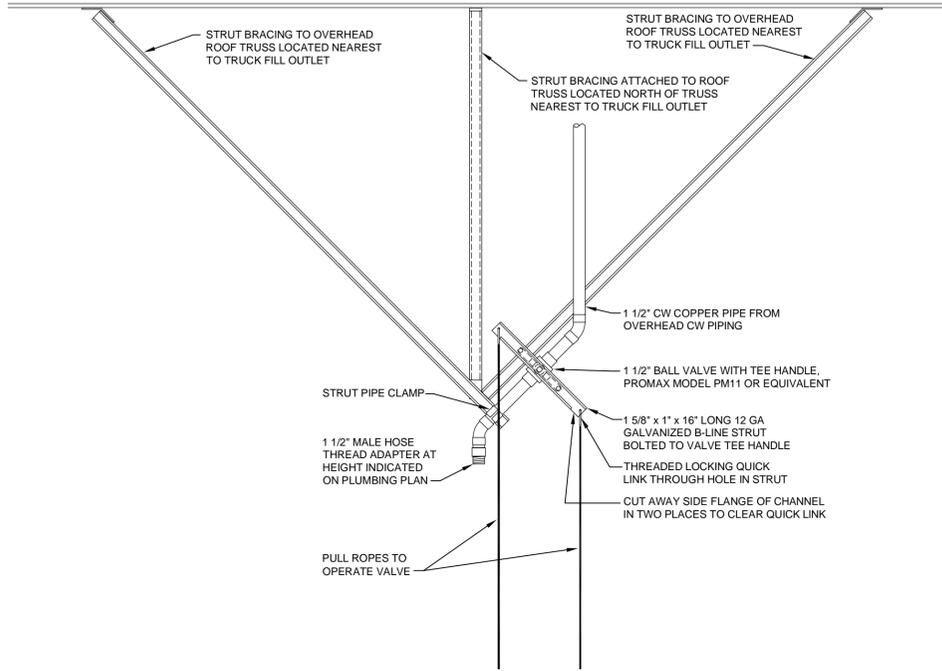


TRUCK FILL WATER VALVE DETAIL
SCALE: 1" = 1'-0"

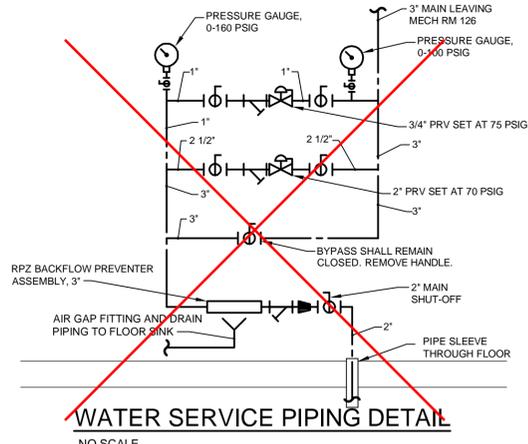


WATER SERVICE PIPING DETAIL
NO SCALE

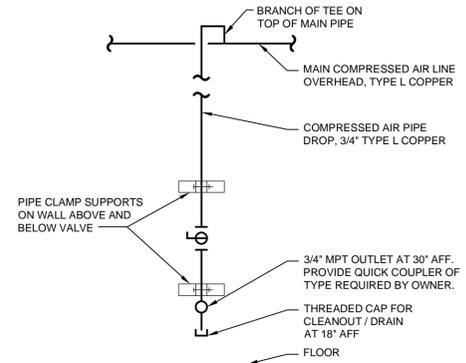


COMPRESSED AIR DROP DETAIL
NO SCALE

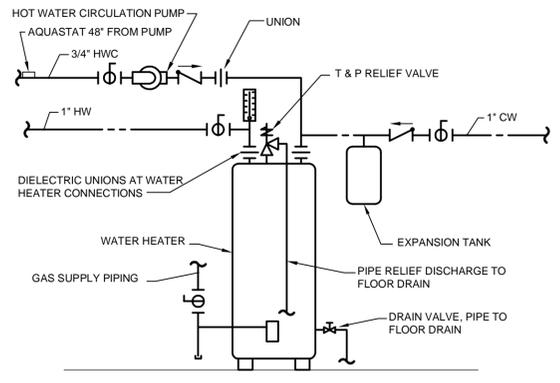


GAS WATER HEATER PIPING DETAIL
NO SCALE

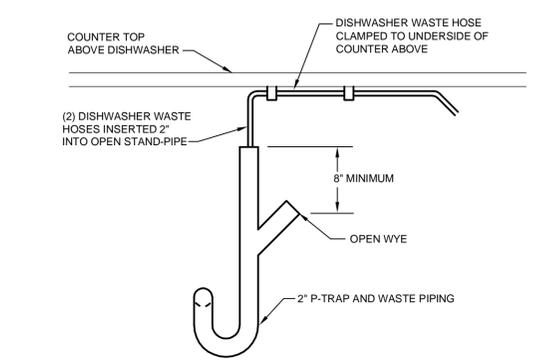


DISHWASHER WASTE CONNECTION DETAIL
NO SCALE

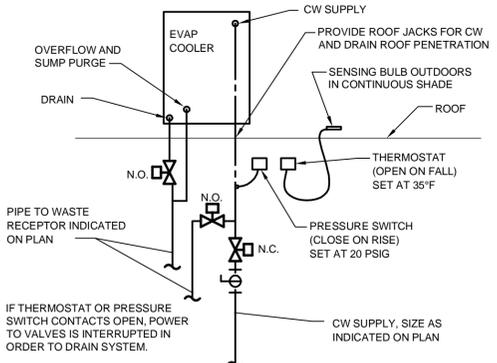


EVAPORATIVE COOLER PIPING SCHEMATIC
NO SCALE

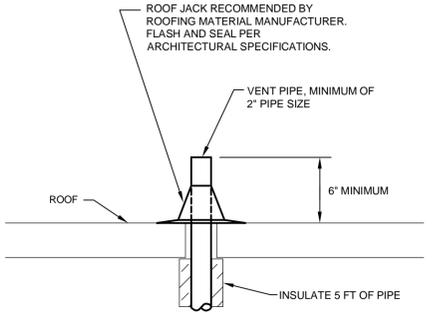


VENT THROUGH ROOF DETAIL
NO SCALE

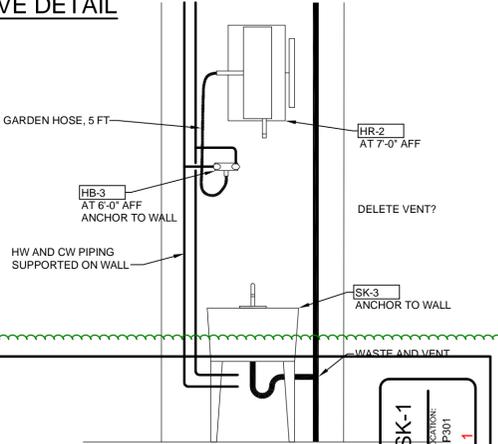


SK-3 AND HR-2 PIPING DETAIL
SCALE: 1/2" = 1'-0"

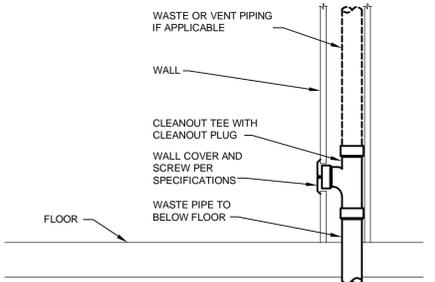


WALL CLEANOUT (W.C.O.) DETAIL

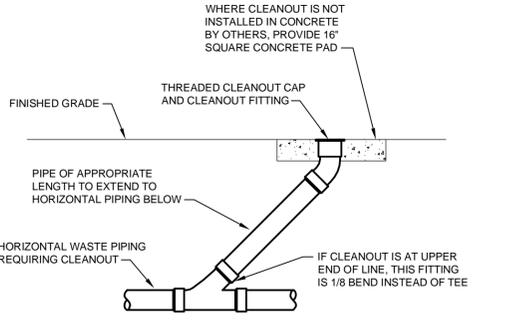


CLEANOUT TO GRADE (C.O.T.G.) DETAIL

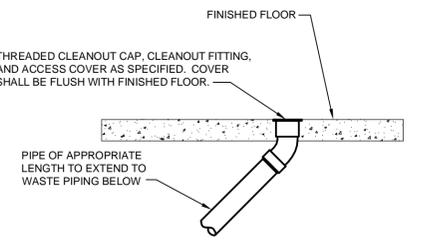

FLOOR CLEANOUT (F.C.O.) DETAIL
NO SCALE

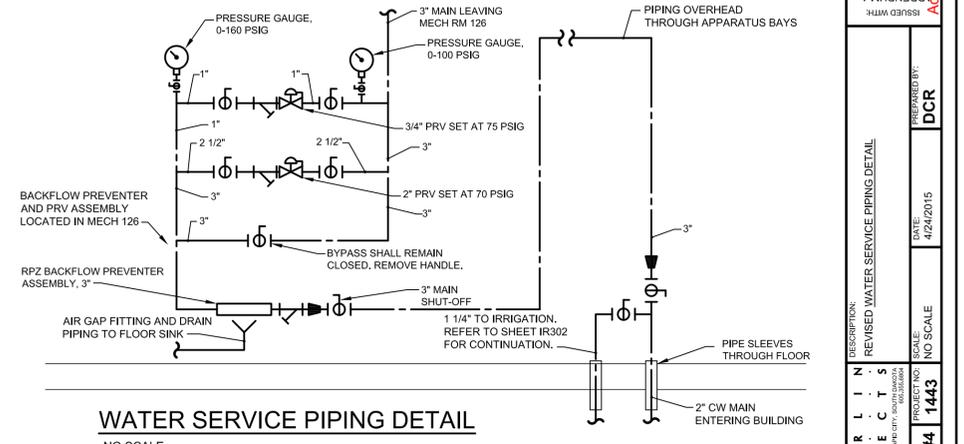

WATER SERVICE PIPING DETAIL
NO SCALE

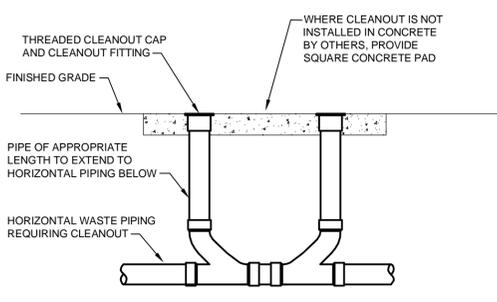

TWO-WAY CLEANOUT TO GRADE DETAIL
NO SCALE

PSK-1
 REVISION: P301
 ACTION: Addendum 1
 PREPARED BY: DCR
 DATE: 4/24/2015
 SCALE: NO SCALE
 PROJECT NO: 1443
STATION #4
 CHAMBERLIN ARCHITECTS
 356 ECHO CANYON COURT, GRAND JUNCTION, CO 81507-9594
 PHONE 970-434-9819 / FAX 970-434-9815 / CELL 970-280-1781 / cdra@chamberlin.net



ORCHARD MESA FIRE STATION #4

GRAND JUNCTION, COLORADO

PLUMBING DETAILS

NO: ISSUED FOR: DATE:



PROJECT STATUS:
CONSTRUCTION DOCUMENTS

DRAWN BY: DCR CHECKED BY:

DATE:
04/10/2015 SHEET NO:

PROJECT NO:
1443 **P301**