


# 2022 Sewer Line Replacement


## 27 Rd – Unaweep Ave to B 3/4 Rd

- 1 — Cover Sheet
- 2 — Standard Abbreviations, Legend and Symbols
- 3 — Project Control Map
- 4 — 27 ROAD P&P Sta 10 + 00 — 12+00
- 5 — 27 ROAD P&P Sta 12 + 00 — 14+00
- 6 — 27 ROAD P&P Sta 14 + 00 — 16+00
- 7 — 27 ROAD Sta 16 + 00 — 18+00
- 8 — 27 ROAD P&P Sta 18 + 00 — 20+20

VICINITY MAP

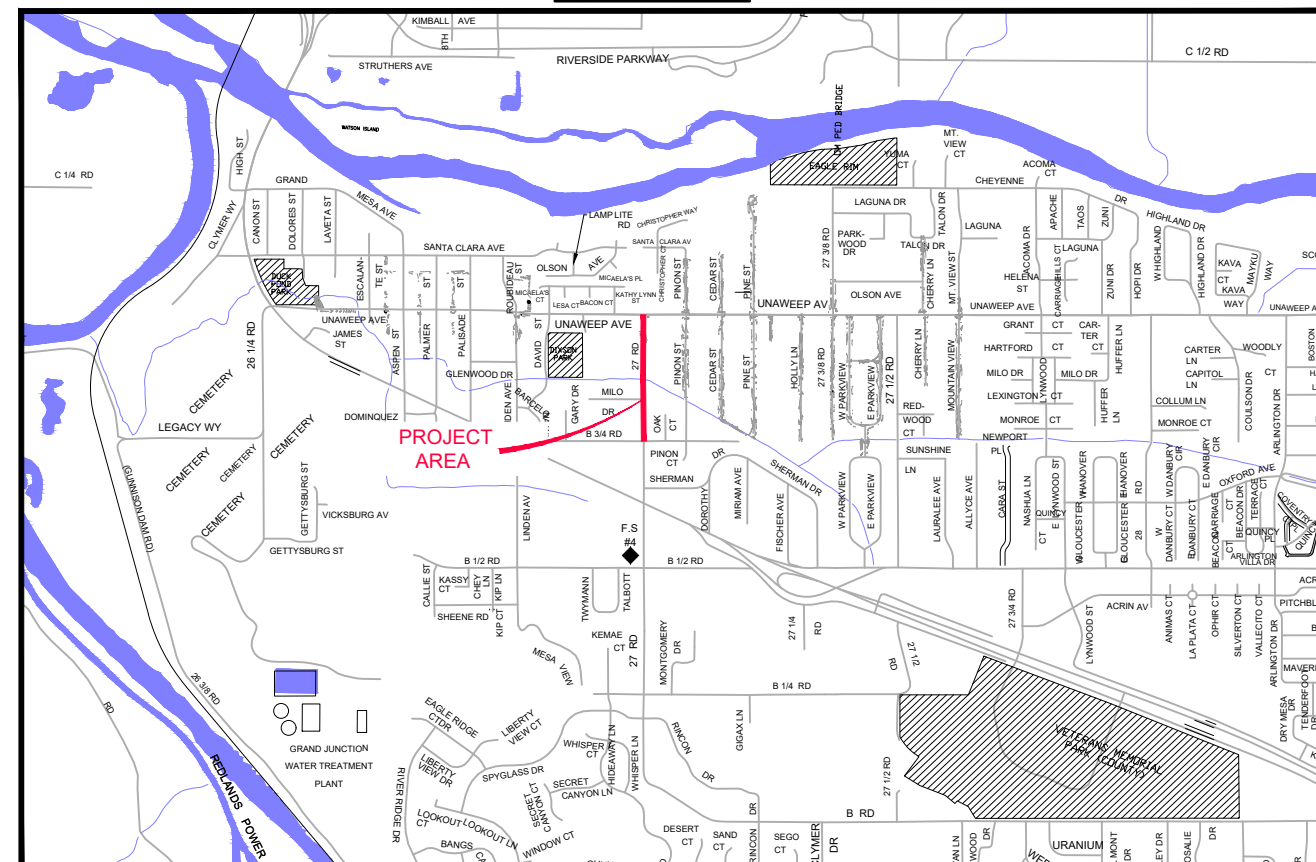

UTILITIES AND AGENCIES								
AGENCY	NAME	POSITION	ROLE	MAILING ADDRESS	STREET ADDRESS	CITY, STATE	VOICE-WK	FAX
CITY OF GRAND JUNCTION	Toby Thieman	PROJECT ENGINEER	PROJECT ENGINEER	333 WEST AVE BLDG C	333 WEST AVE BLDG C	GRAND JCT., CO 81501	(970) 244-1559	(970) 256-4022
CITY OF GRAND JUNCTION	Toby Thieman	PROJECT ENGINEER	SANITARY SEWER	333 WEST AVE BLDG C	333 WEST AVE BLDG C	GRAND JCT., CO 81501	(970) 244-1559	(970) 256-4022
ORCHARD MESA IRRIGATION	MAX SCHMIDT	MANAGER	IRRIGATION	668 38 RD	668 38 RD	PALISADE, CO 81526	(970) 464-7885	(970) 464-5928
SPECTRUM	JEFF VALDEZ	MANAGER	CABLE TV	2502 FORESIGHT CIRCLE	2502 FORESIGHT CIRCLE	GRAND JCT., CO 81504	(970) 245-8750	(970) 245-6803
CENTURYLINK	CHRIS JOHNSON	ENGINEER	TELEPHONE	2524 BLICHMANN AVE	2524 BLICHMANN AVE	GRAND JCT., CO 81504	(970) 244-4311	(970) 240-4349
UTE WATER	JUSTIN BATES	SUPERVISOR	WATER	PO BOX 460	2190 H 1/4 RD	GRAND JCT., CO 81502	(970) 242-7491	(970) 242-9189
XCEL	STEVE PIBURN	UNIT MANAGER	ELECTRIC	2538 BLICHMANN AVE	2538 BLICHMANN AVE	GRAND JCT., CO 81506	(970) 244-2664	(970) 244-2664
XCEL	SARAH DARRICAU	UNIT MANAGER	GAS	2538 BLICHMANN AVE	2538 BLICHMANN AVE	GRAND JCT., CO 81506	(970) 244-2656	(970) 244-2656

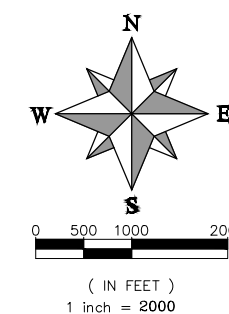

PROJECT NO. F0016-F001642

NOTE: NOTIFY AFFECTED UTILITY VENDOR 48 HOURS PRIOR TO EXCAVATIONS THAT WILL EXPOSE UTILITY LINES. THE COVER SHEET WILL HAVE A LISTING OF UTILITY VENDORS AND TELEPHONE NUMBERS.

REVISION	DESCRIPTION	DATE
REVISION Δ XXX		201X
REVISION Δ XXX		201X
REVISION Δ XXX		201X
REVISION Δ XXX		201X

  
**Public Works**  
**Engineering Division**



DRAWING STATUS:	
●	PROGRESS
○	FINAL CONSTRUCTION DRAWINGS
○	ASBUILT
DESIGNED BY:	
TOBY THIEMAN	09/2022
REVIEWED BY:	
KEN HALEY, ENGINEERING MANAGER	09/2022
AUTHORIZED FOR CONSTRUCTION	
KEN HALEY, ENGINEERING MANAGER	09/2022
ACCEPTED AS CONSTRUCTED	
XXX, PROJECT ENGINEER	201X

**ABBREVIATIONS**

AASHTO	AMERICAN ASSOCIATION OF STATE HIGHWAY & TRANSPORTATION OFFICIALS
ABC	AGGREGATE BASE COURSE
AC	ASBESTOS CEMENT
AP	ANGLE POINT
ASB	ANCHORED STRAW BALES
ASP	ALUMINIZED STEEL PIPE
ASTM	AMERICAN SOCIETY FOR TESTING MATERIALS
AWWA	AMERICAN WATER WORKS ASSOCIATION
BC	BACK OF CURB
BF	BUTTERFLY VALVE
BOW	BACK OF WALK
BCR	BEGIN CURB RETURN
BOT	BOTTOM
BSWMP	BETTER STORM WATER MANAGEMENT PRACTICES
CH	CHORD
CAP	CORRUGATED ALUMINUM PIPE
CDOT	COLORADO DEPARTMENT OF TRANSPORTATION
CI	CAST IRON
C,G,& SW	CURB, GUTTER & SIDEWALK
C	CENTER LINE
CL	CLEAR
CMP	CORRUGATED METAL PIPE
CO	CLEAN OUT
COMB	COMBINATION (AS IN STORM SEWER AND SANITARY SEWER)
CONC	CONCRETE
CSM	CITY SURVEY MONUMENT
CSP	CORRUGATED STEEL PIPE
CU	COPPER
DI	DUCTILE IRON
DWY	DRIVEWAY
E	ELECTRIC
ECR	END CURB RETURN
EG	EDGE OF GUTTER
EL	ELEVATION
EP	EDGE OF PAVEMENT
EX	EXISTING
FB	FULL BODY
FC	FACE OF CURB
FG	FINISHED GRADE
F	FLOW LINE
FL	FLANGE
FM	FORCE MAIN
FO	FIBER OPTICS
FS	FAR SIDE
FTG	FOOTING
G	GAS
GB	GRADE BREAK
GM	GAS METER
GV	GATE VALVE
HBP	HOT BITUMINOUS PAVEMENT
HDPE	HIGH DENSITY POLYETHYLENE
INV	INVERT
IRR	IRRIGATION
L	LENGTH OF ARC
LC	LONG CHORD
LF	LINEAR FEET
LL	LONG ARC
LS	SHORT ARC
LT	LEFT
MB	MAILBOX
MCSM	MESA COUNTY SURVEY MONUMENT
MH	MANHOLE
MJ	MECHANICAL JOINT
MW	MILL WRAP
N/A	NOT APPLICABLE
NIC	NOT IN CONTRACT
NOP	NO ONE PERSON
NRCP	NON-REINFORCED CONCRETE PIPE
NS	NEAR SIDE
NTS	NOT TO SCALE
OHP	OVERHEAD POWER
OHT	OVERHEAD TELEPHONE
PC	POINT OF CURVATURE
PCC	POINT OF COMPOUND CURVATURE
PE	POLYETHYLENE
PERF	PERFORATED
PI	POINT OF INTERSECTION
PIP	PLASTIC IRRIGATION PIPE
POC	POINT ON CURVE
POT	POINT ON TANGENT
PR	PROPOSED
PRC	POINT OF REVERSE CURVATURE
PT	POINT OF TANGENCY
PVC	POLYVINYL CHLORIDE
R	RADIUS
RCP	REINFORCED CONCRETE PIPE
REQ'D	REQUIRED
RG	RESTRAINED GLANDS
RL	LONG RADIUS
ROW	RIGHT OF WAY
RP	RADIUS POINT
RR	RAIL ROAD
RS	SHORT RADIUS
RT	RIGHT
S	SLOPE
SAN	SANITARY
SC	SHORT CHORD
SCD	STANDARD CONTRACT DOCUMENTS
SCH	SCHEDULE
SF	SILT FENCE
SL	SECTION LINE
SSRB	STANDARD SPECIFICATIONS FOR ROAD & BRIDGE CONSTRUCTION
SSUU	STANDARD SPECIFICATIONS FOR CONSTRUCTION OF UNDERGROUND UTILITIES
STA	STATION
STL	STEEL
STM	STORM
T	TELEPHONE
TAN	LENGTH OF TANGENT
TC	TOP OF CURB
TH	TEST HOLE
TV	TELEVISION
(TYP)	TYPICAL
UU	UNDERGROUND UTILITIES
VC	VERTICAL CURVE
VCP	VITRIFIED CLAY PIPE
VPC	VERTICAL POINT OF CURVATURE
VPCC	VERTICAL POINT OF COMPOUND CURVATURE
VPRC	VERTICAL POINT OF REVERSE CURVATURE
VPI	VERTICAL POINT OF INTERSECTION
VPT	VERTICAL POINT OF TANGENCY
W	WATER
Δ	DELTA ANGLE

**LEGEND**

BSWMP	BSWMP	PROPOSED CONCRETE CURB AND GUTTER	
DRAINAGE BASIN BOUNDARY		PROPOSED CONCRETE CURB, GUTTER, & SIDEWALK	
BSWMP ANCHORED STRAW BALES		PROPOSED CONCRETE SIDEWALK	
BSWMP SILT FENCE		PROPOSED "WET" UTILITIES (CONSTRUCTION NOTE WILL INDICATE TYPE, SIZE, AND MATERIAL OF NEW MAIN)	
BSWMP EROSION LOG		ALL PROPOSED FEATURES NOT SHOWN IN LEGEND WILL BE SHOWN THE SAME AS THEIR EXISTING COUNTERPART, BUT INDICATED BY BOLDER LINETYPE	
BUILDING		RAIL ROAD	
CONCRETE CURB AND GUTTER		RETAINING WALL	
CONCRETE CURB, GUTTER, & SIDEWALK		STRIPING (CONTINUOUS WHITE)	
CONCRETE DITCH		STRIPING (DASHED WHITE)	
CONCRETE SIDEWALK		STRIPING (CONTINUOUS YELLOW)	
CULVERT		STRIPING (DASHED YELLOW)	
EARTH DITCH		TOP OF SLOPE	
EDGE OF GRAVEL		CONTOUR LINES (SHOWN BETWEEN TOP & TOE)	
EDGE OF PAVEMENT		TOE OF SLOPE	
FENCE (BARBED WIRE)		TRAFFIC DETECTOR LOOP	
FENCE (CHAIN LINK)		UTILITY LINE (ABANDON) (THIS CASE A WATER LINE)	
FENCE (IRON)		UTILITY LINE (CABLE TV)	
FENCE (PLASTIC)		UTILITY LINE (ELECTRIC)	
FENCE (WOOD)		UTILITY LINE (FIBER OPTIC)	
FENCE (WOVEN WIRE)		UTILITY LINE (GAS)	
GUARD RAIL		UTILITY LINE (HIGH VOLTAGE OVERHEAD POWER)	
HATCHING: INDICATES ASPHALT REMOVAL		UTILITY LINE (OVERHEAD POWER)	
HATCHING: INDICATES CONCRETE REMOVAL		UTILITY LINE (OVERHEAD TELEPHONE)	
HATCHING: INDICATES STAGING AREA		UTILITY LINE (SANITARY SEWER)	
LINE (CENTER OF IMPROVEMENTS)		UTILITY LINE (SANITARY SEWER FORCE MAIN)	
LINE (CITY LIMITS)		UTILITY LINE (STORM SEWER)	
LINE (CONTROL)		UTILITY LINE (STORM SEWER, PERFORATED)	
LINE (EASEMENT)		UTILITY LINE (STORM/SANITARY SEWER SEWER COMBINATION)	
LINE (MONUMENT/SECTION)		UTILITY LINE (TELEPHONE)	
LINE (PROPERTY)		UTILITY LINE (WATER)	
LINE (RIGHT OF WAY)			
MATCH LINE			
PIPE (IRRIGATION)			
PIPE (SIPHON)			

**SYMBOLS**

BENCH MARK	
CATCH BASIN	
CLEAN OUT	
CURB STOP	
FIRE HYDRANT	
GUY WIRE ANCHOR	
HEADGATE	
IRRIGATION PUMP	
MAILBOX	
MANHOLE (ELECTRIC)	
MANHOLE (GAS)	
MANHOLE (SANITARY/STORM)	
MANHOLE (TELEPHONE)	
MANHOLE (TV)	
MANHOLE (WATER)	
METER (GAS)	
METER (WATER)	
PEDESTAL (TELEPHONE)	
PEDESTAL (TV)	
PROPERTY PIN	
PULL BOX	
REDUCER FITTING	
SIGN OR POST (SIGN TYPE NOTED)	
SPRINKLER HEAD	
STREET LIGHT	
SURVEY MONUMENT (CITY)	
SURVEY MONUMENT (TYPE NOTED)	
TEST HOLE	
TRAFFIC PAINT MARKING	
TRAFFIC SIGNAL POLE AND MAST ARM	
UTILITY POLE	
VALVE (GAS)	
VALVE (IRRIGATION)	
VALVE (WATER)	
VEGETATION (HEDGE OR BUSH)	
VEGETATION (TREE STUMP)	
VEGETATION (TREE) (CALIPER SIZE NOTED)	
WATER HYDRANT	
WEIR	
YARD LIGHT	

NORTH ARROW:

BAR SCALE:

( IN FEET )  
1 inch = 20 feet

REVISION Δ	DESCRIPTION	DATE	PROJECT NO.
REVISION Δ			DRAWN BY JCS DATE 4-02
REVISION Δ			DESIGNED BY DATE
REVISION Δ			CHECKED BY DATE
REVISION Δ			APPROVED BY DATE

SCALES: PLAN & PROFILE



PUBLIC WORKS  
ENGINEERING DIVISION

CITY OF GRAND JUNCTION  
STANDARD ABBREVIATIONS, LEGEND,  
AND SYMBOLS



REVISION	DESCRIPTION	DATE	PROJECT NO. F001642
REVISION Δ			DRAWN BY DJM DATE 09/2022
REVISION Δ			DESIGNED BY DJM DATE 09/2022
REVISION Δ			CHECKED BY TRT DATE 09/2022
REVISION Δ			APPROVED BY KH DATE 08/2022


SCALES: PLAN & PROFILE





PUBLIC WORKS  
ENGINEERING DIVISION

2022 SEWER LINE REPLACEMENT  
27 RD - UNAWEEP AVE TO B 3/4 RD  
PROJECT CONTROL MAP



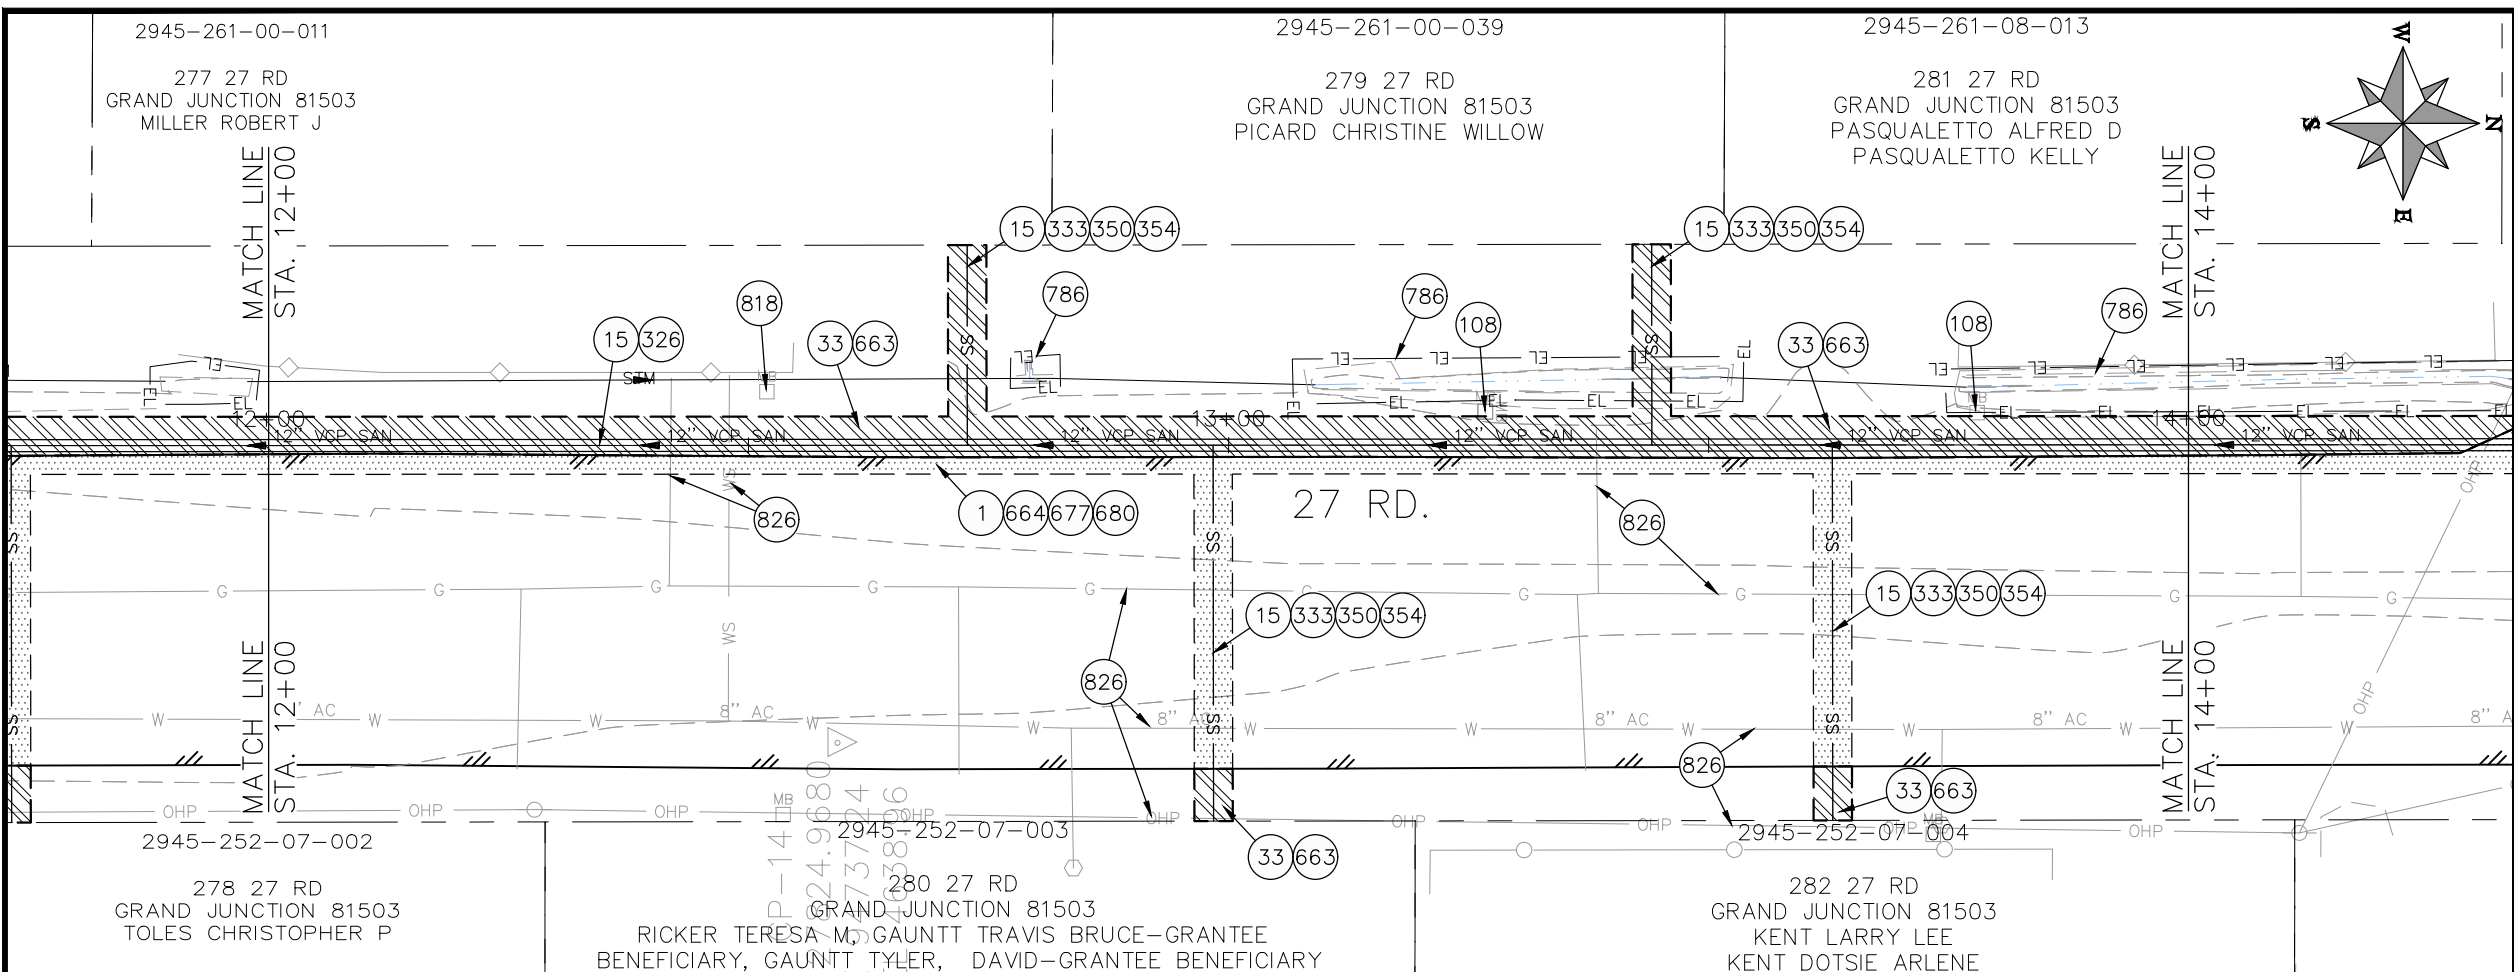

- CONSTRUCTION NOTES**
- 1 202 - REMOVAL OF ASPHALT MAT. CUT AND REMOVE ASPHALT AS SHOWN. (INDICATED BY DOT HATCH PATTERN)
  - 15 202 - REMOVAL OF PIPE AS SHOWN. (SIZE AND TYPE AS SHOWN ON PLAN)
  - 33 202 - REMOVE EXISTING SURFACE MATERIAL.
  - 108 210 - RESET MAILBOX TO NEW 4X4 POST.
  - 326 102.9/108.2 - 15" GRAVITY SEWER PIPE (SDR 35 PVC). INCLUDES TYPE A BEDDING AND HAUNCHING MATERIAL AND BACKFILL OF TRENCH WITH NATIVE MATERIALS MEETING 103.16 EARTH BACKFILL MATERIAL..
  - 333 102.9/108.2 - 4" SEWER SERVICE PIPE (SDR 35 PVC). INCLUDES TYPE A BEDDING AND HAUNCHING MATERIAL, BACKFILL OF TRENCH WITH NATIVE MATERIALS MEETING 103.16 EARTH BACKFILL MATERIAL, AND END-OF-SERVICE CAP
  - 663 304 - AGGREGATE BASE COURSE (CLASS 6) (6" THICK)
  - 350 102.9/108.3 - 15" x 4" SEWER SERVICE TAP. FULL BODY WYE (SEE STD. DETAIL SS-06).
  - 354 104.20 - INSTALL 2-WAY SANITARY SEWER SERVICE CLEANOUT (STD. DETAIL SS-07). INCLUDES CLEANOUT RING AND COVER AND CONCRETE COLLAR IN UNPAVED AREAS (SEE STD. DETAIL SS-07)
  - 664 304 - AGGREGATE BASE COURSE (CLASS 6) (12" THICK)
  - 677 401.08 - HOT BITUMINOUS PAVEMENT (4" THICK) (GRADING SX, BINDER GRADE PG 64-22) (TWO 2" LIFTS)
  - 680 401.08 - HOT BITUMINOUS PAVEMENT (PATCHING) (2" THICK) (GRADING SX, BINDER GRADE PG 64-22, GYR = 75) (ONE 2" LIFT TOP MAT) (T-TOP PATCH) (SEE CITY STD. DETAIL GU-03)
  - 786 EROSION CONTROL LOG
  - 818 PROTECT MAILBOX.
  - 826 PROTECT EXISTING UTILITY LINE IN PLACE.

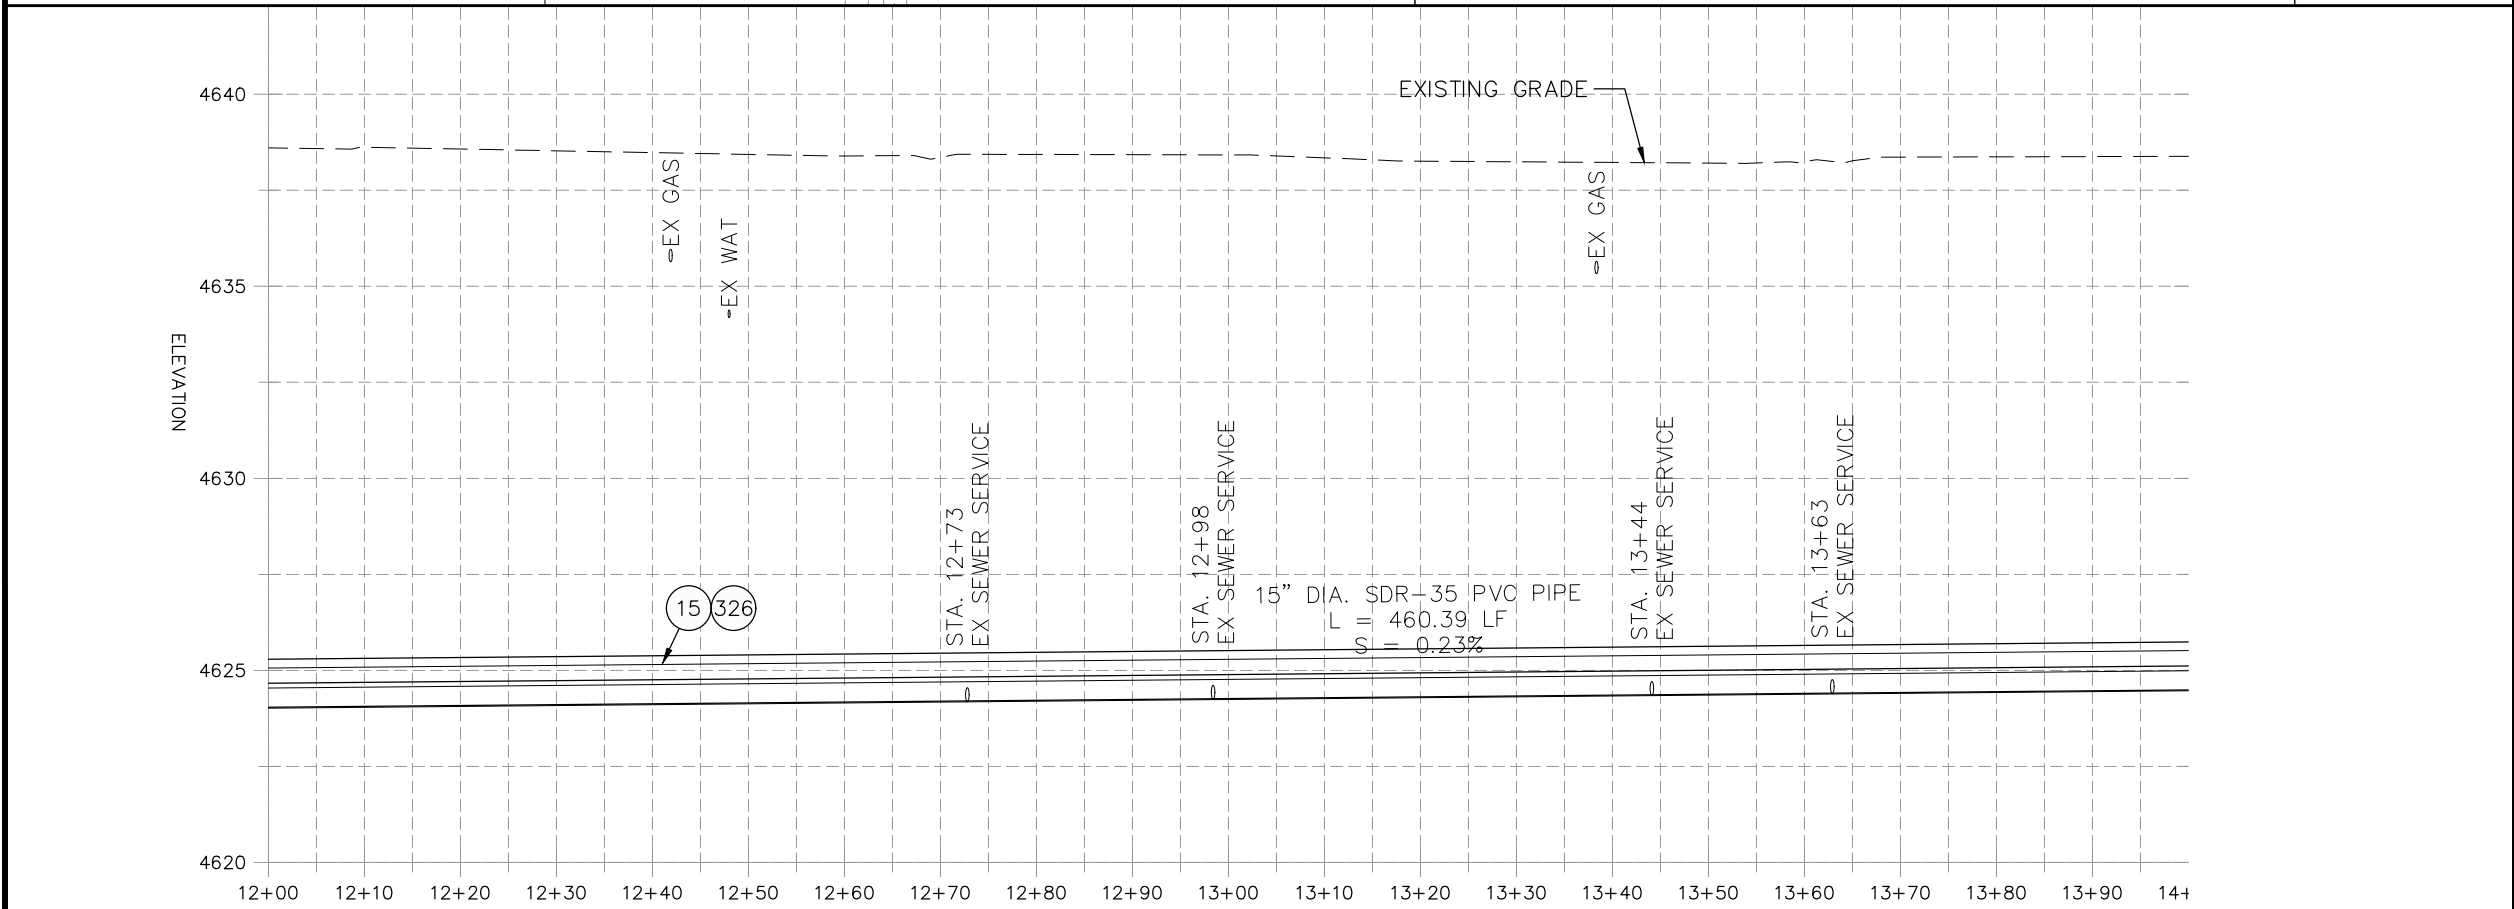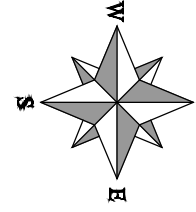

NOTE:  
CONTRACTOR SHALL VERIFY SEWER SERVICE LOCATIONS BEFORE REPLACING PIPE.

REVISION	DESCRIPTION	DATE
REVISION Δ XXX		
REVISION Δ XXX		
REVISION Δ XXX		
REVISION Δ XXX		

PROJECT NO. F001642	DATE 09/2022
DRAWN BY DJM	DATE 09/2022
DESIGNED BY DJM	DATE 09/2022
CHECKED BY IRT	DATE 09/2022
APPROVED BY KH	DATE 09/2022

SCALES: PLAN & PROFILE	
HORIZONTAL: 1" = 20'	0 5 10 20
VERTICAL: 1" = 5'	0 1.25 2.5 5



**PUBLIC WORKS  
ENGINEERING DIVISION**


**2022 SEWER LINE REPLACEMENT  
27 ROAD PLAN AND PROFILE  
STA 12+00 TO STA 14+00**

2945-261-08-013

281 27 RD  
GRAND JUNCTION 81503  
PASQUALETTO ALFRED D  
PASQUALETTO KELLYE



MILO DR.

363  
16 300 306 308  
STA 14+70.39  
OFFSET: 0.00  
B4-262-038  
N 28036.08  
E 94706.18

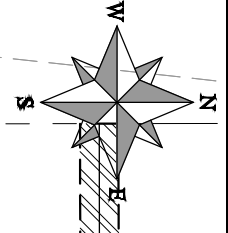

CONSTRUCTION NOTES

- 1 202 - REMOVAL OF ASPHALT MAT. CUT AND REMOVE ASPHALT AS SHOWN. (INDICATED BY DOT HATCH PATTERN)
- 15 202 - REMOVAL OF PIPE AS SHOWN. (SIZE AND TYPE AS SHOWN ON PLAN)
- 16 202 - REMOVAL OF MANHOLE. CONTRACTOR SHALL SALVAGE RING AND COVER AND DELIVER TO CITY SHOPS.
- 33 202 - REMOVE EXISTING SURFACE MATERIAL.
- 108 210 - RESET MAILBOX TO NEW 4X4 POST.
- 300 102.11/108.5 - SANITARY SEWER BASIC MANHOLE (48" I.D.). INCLUDES CONNECTION OF ADJACENT SEWER LINE, FORMING INVERTS AND ADJUSTING TO FINAL GRADE. (SEE CITY OF GRAND JUNCTION STANDARD DETAIL SS-02).
- 306 102.11/108.5 - MANHOLE BARREL SECTION (D>5") (48" I.D.).
- 308 102.11/108.5 - MANHOLE INTERIOR CORROSION PROTECTION (CASTAGRA ECOLUR 201 PROTECTIVE COATING OR APPROVED EQUAL) (PROTECTIVE COATING SHALL BE APPLIED TO PREPARED MANHOLE INVERT, BENCH, BARRELS, AND CONE SECTIONS. MANHOLE INVERTS AND BENCHES SHALL BE COATED PRIOR TO WASTEWATER INTRODUCTION)
- 326 102.9/108.2 - 15" GRAVITY SEWER PIPE (SDR 35 PVC). INCLUDES TYPE A BEDDING AND HAUNCHING MATERIAL AND BACKFILL OF TRENCH WITH NATIVE MATERIALS MEETING 103.16 EARTH BACKFILL MATERIAL.
- 333 102.9/108.2 - 4" SEWER SERVICE PIPE (SDR 35 PVC). INCLUDES TYPE A BEDDING AND HAUNCHING MATERIAL, BACKFILL OF TRENCH WITH NATIVE MATERIALS MEETING 103.16 EARTH BACKFILL MATERIAL, AND END-OF-SERVICE CAP.
- 350 102.9/108.3 - 15" x 4" SEWER SERVICE TAP. FULL BODY WYE (SEE STD. DETAIL SS-06).
- 354 104.20 - INSTALL 2-WAY SANITARY SEWER SERVICE CLEANOUT (STD. DETAIL SS-07). INCLUDES CLEANOUT RING AND COVER AND CONCRETE COLLAR IN UNPAVED AREAS (SEE STD. DETAIL SS-07).
- 358 103 - CLAY CUT-OFF WALL (INCIDENTAL TO SEWER INSTALLATION PAY ITEM)
- 363 BYPASS PUMPING (AS DEEMED NECESSARY BY THE CITY OR CONTRACTOR)
- 364 CONNECT TO EXISTING SEWER PIPE. THE CONTRACT PRICE FOR SEWER PIPE SHALL INCLUDE THE COST OF CONNECTION TO EXISTING PIPELINE.
- 365 CONNECT TO EXISTING SEWER MANHOLE. THE CONTRACT PRICE FOR SEWER PIPE SHALL INCLUDE THE COST OF CONNECTION TO EXISTING MANHOLE.
- 663 304 - AGGREGATE BASE COURSE (CLASS 6) (6" THICK)
- 664 304 - AGGREGATE BASE COURSE (CLASS 6) (12" THICK)
- 677 401.08 - HOT BITUMINOUS PAVEMENT (4" THICK) (GRADING SX, BINDER GRADE PG 64-22) (TWO 2" LIFTS)
- 680 401.08 - HOT BITUMINOUS PAVEMENT (PATCHING) (2" THICK) (GRADING SX, BINDER GRADE PG 64-22, GYR = 75) (ONE 2" LIFT TOP MAT) (T-TOP PATCH) (SEE CITY STD. DETAIL GU-03)
- 786 EROSION CONTROL LOG
- 826 PROTECT EXISTING UTILITY LINE IN PLACE.

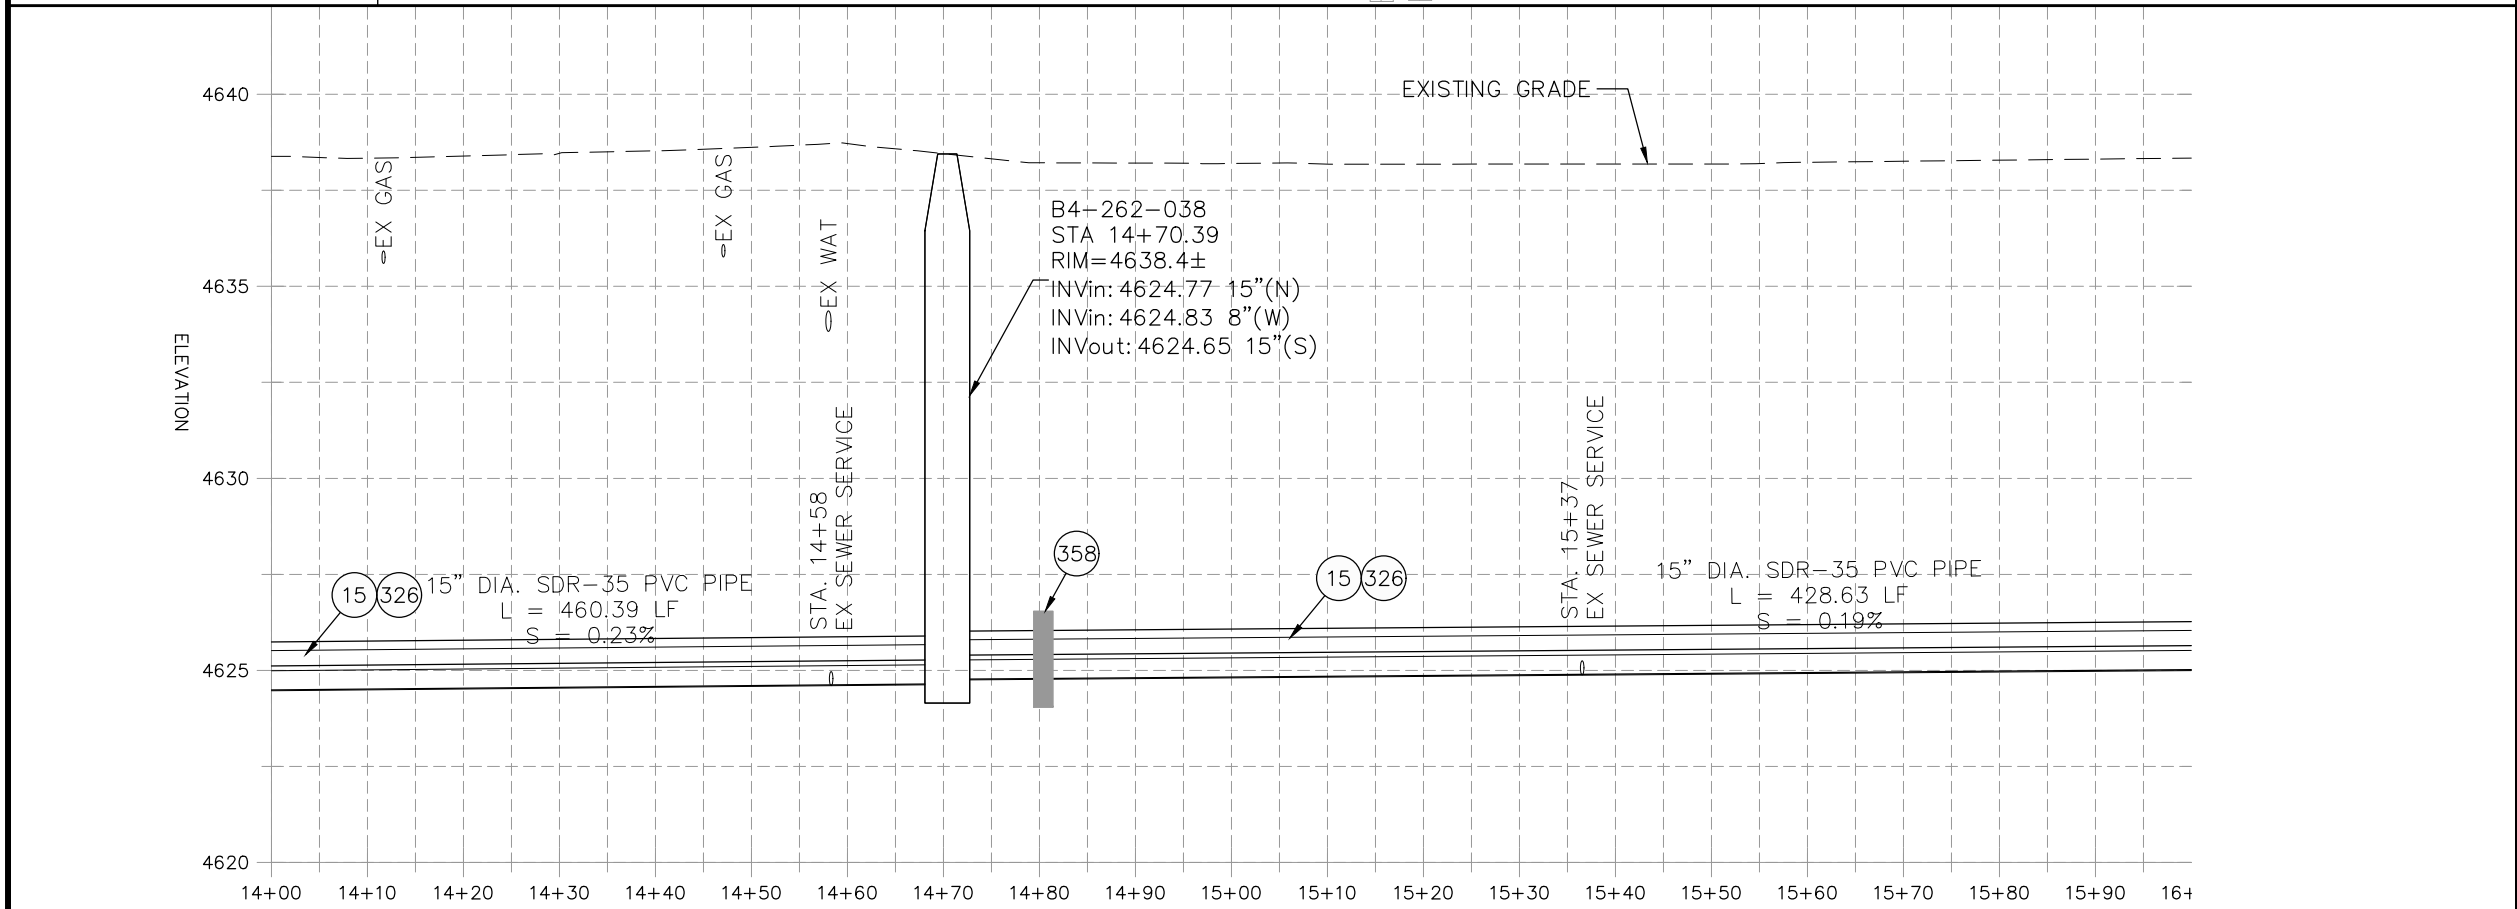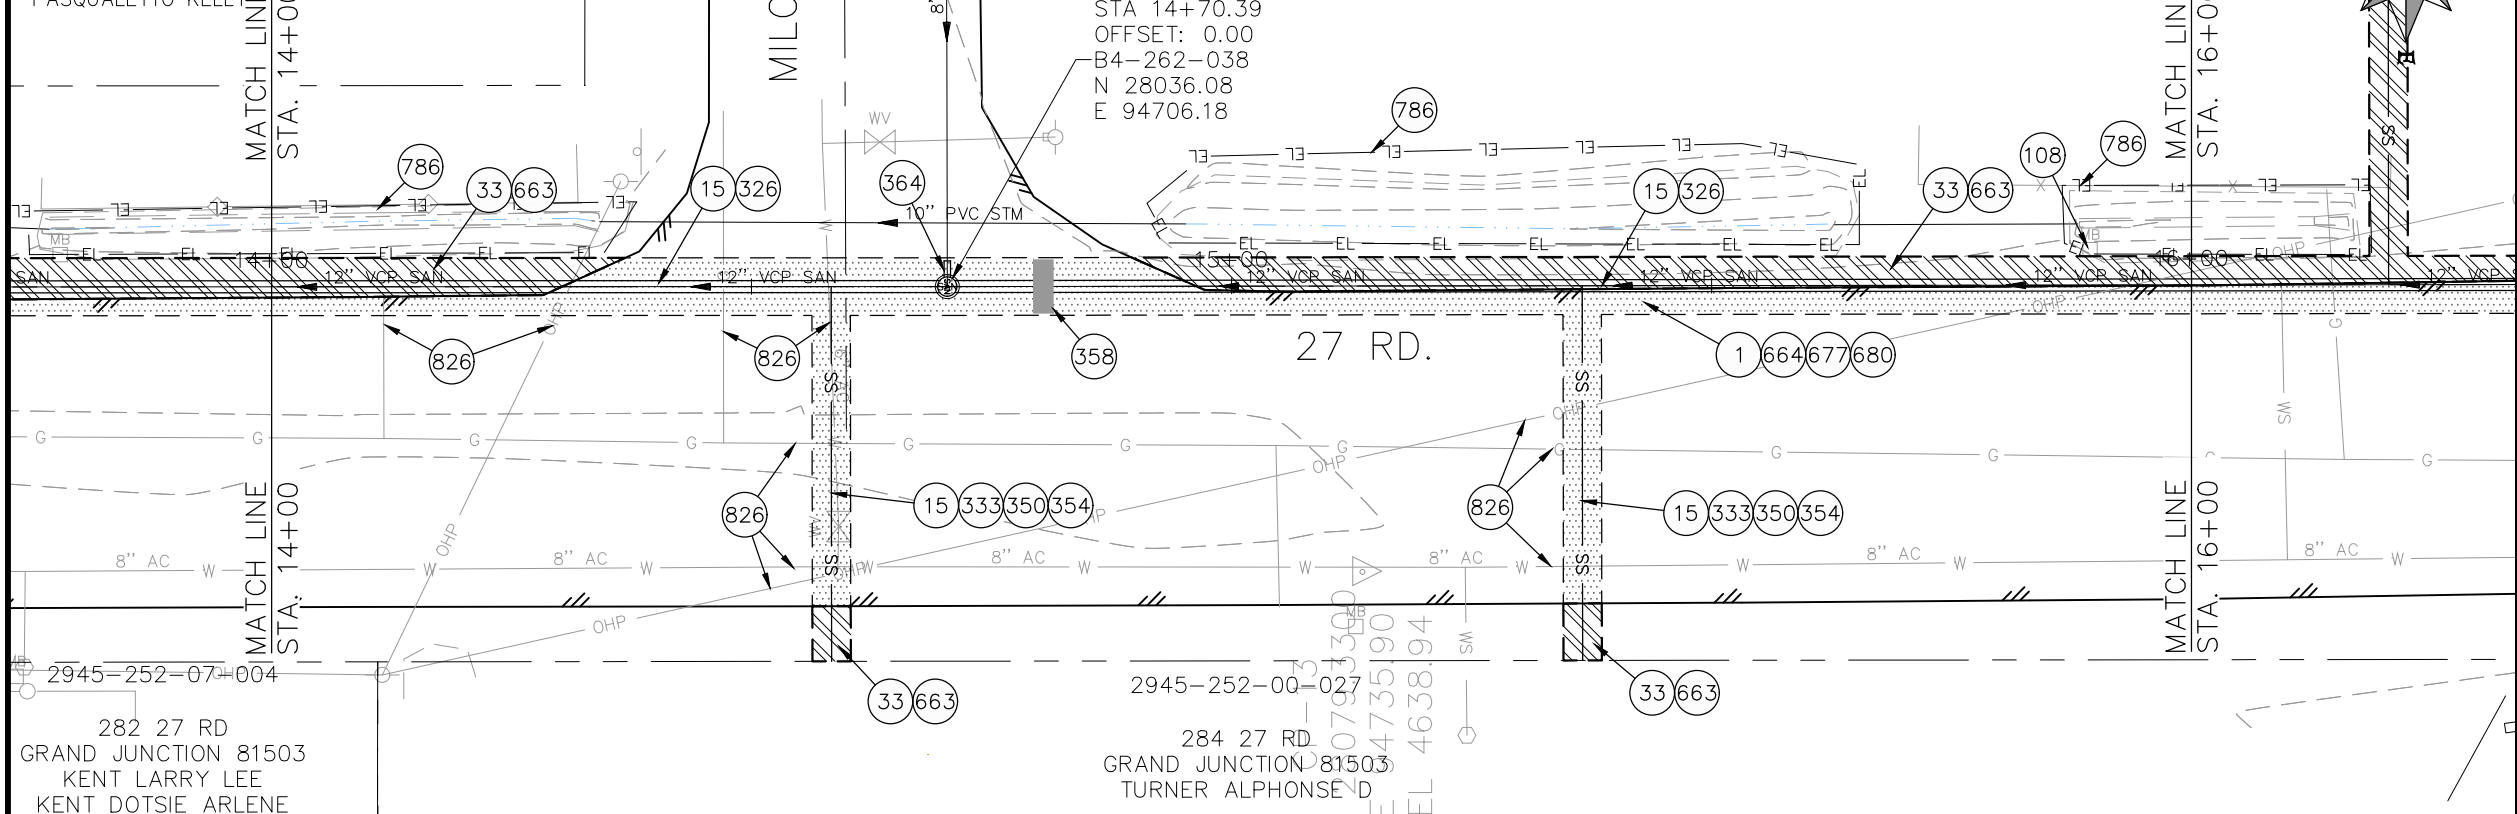

NOTE: CONTRACTOR SHALL VERIFY SEWER SERVICE LOCATIONS BEFORE REPLACING PIPE.

REVISION	DATE	DESCRIPTION
REVISION Δ XXX	- 202X	
REVISION Δ XXX	- 202X	
REVISION Δ XXX	- 202X	
REVISION Δ XXX	- 202X	


PROJECT NO. F001642	DRAWN BY DJM	DATE 09/2022
DESIGNED BY DJM	CHECKED BY IRT	DATE 09/2022
APPROVED BY KH		DATE 09/2022

SCALES: PLAN & PROFILE
HORIZONTAL: 1" = 20'
VERTICAL: 1" = 5'





PUBLIC WORKS  
ENGINEERING DIVISION

2022 SEWER LINE REPLACEMENT  
27 ROAD PLAN AND PROFILE  
STA 14+00 TO STA 16+00

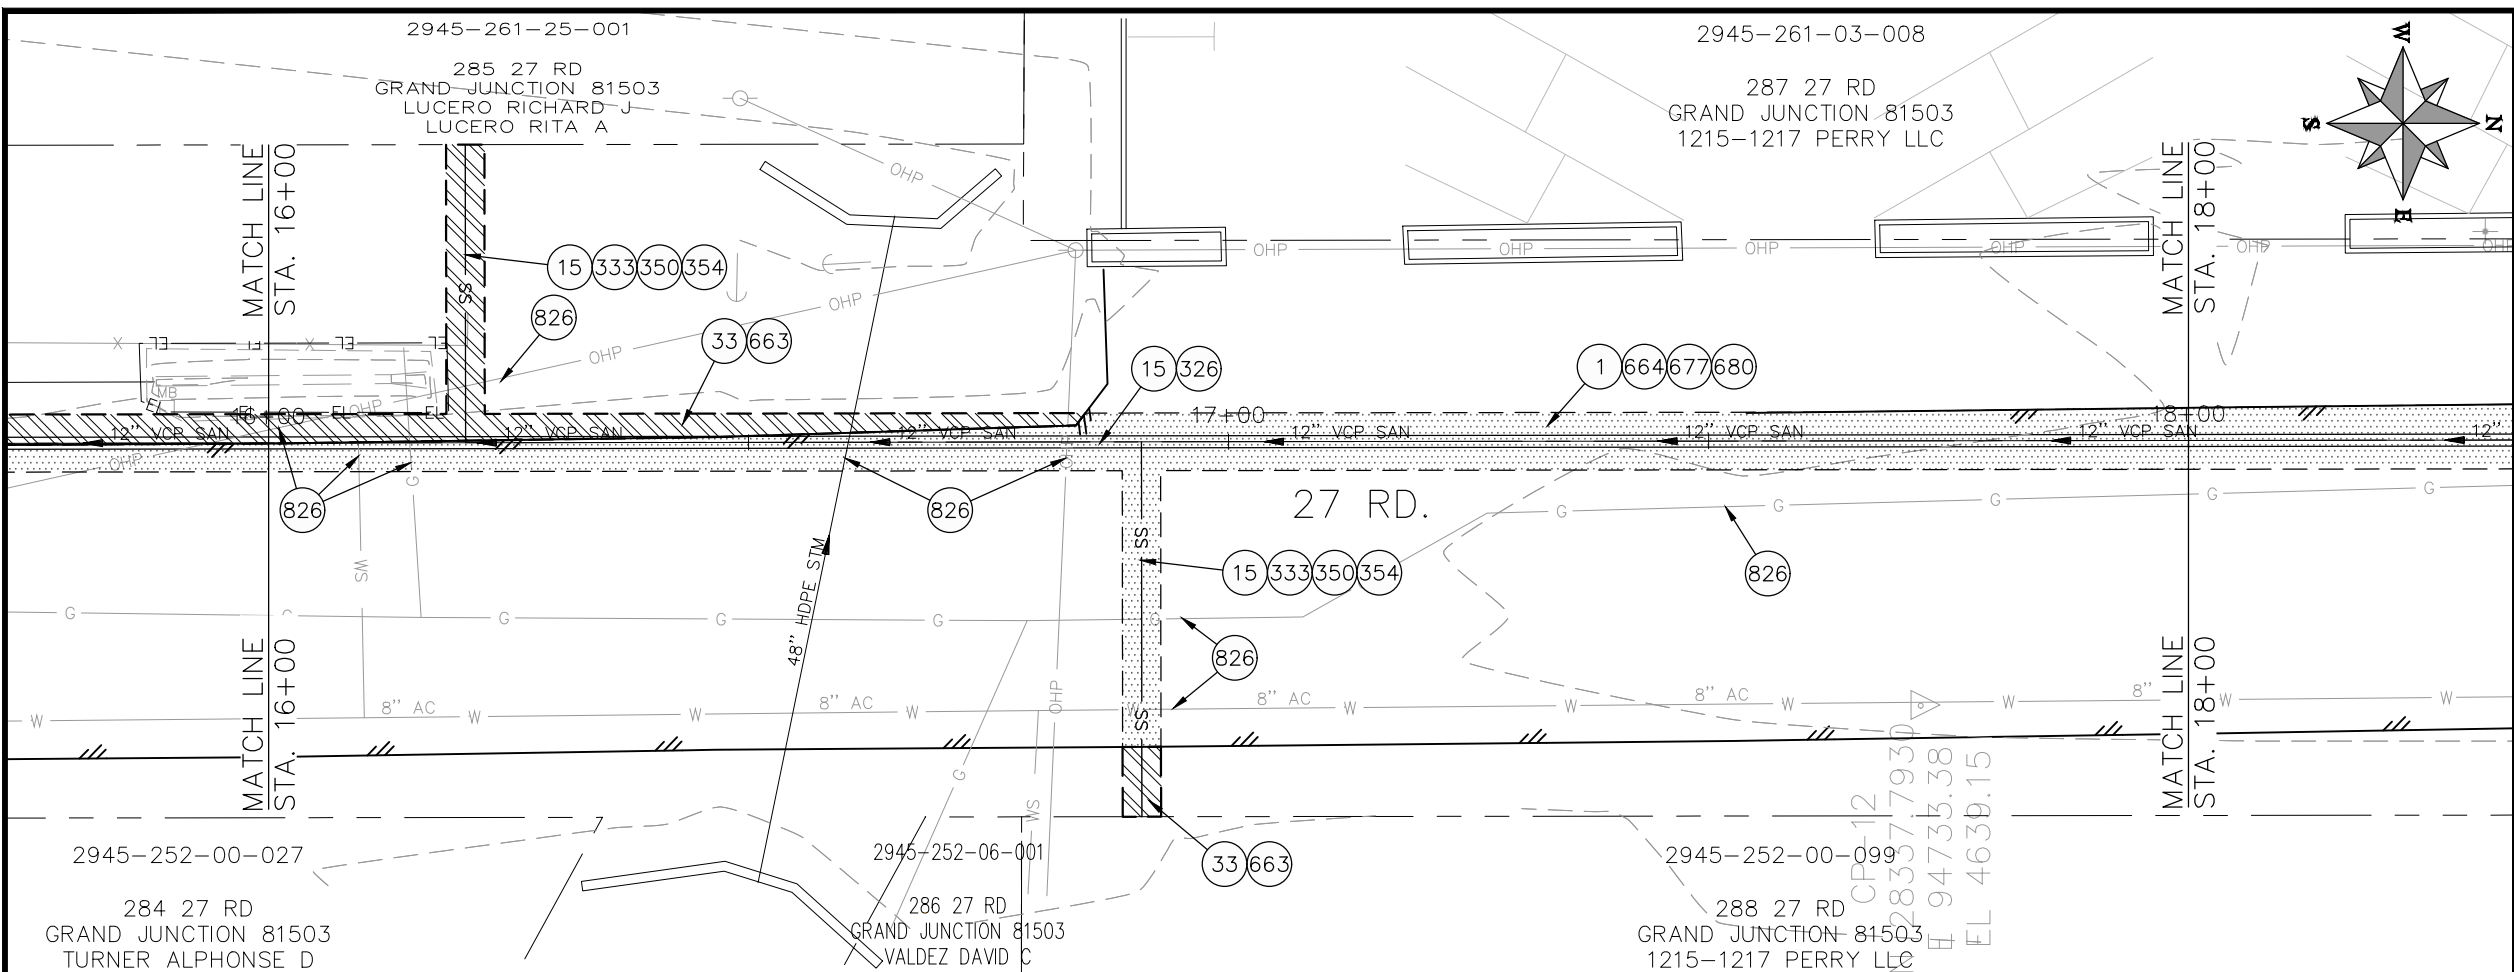

- CONSTRUCTION NOTES**
- 1 202 - REMOVAL OF ASPHALT MAT. CUT AND REMOVE ASPHALT AS SHOWN. (INDICATED BY DOT HATCH PATTERN)
  - 15 202 - REMOVAL OF PIPE AS SHOWN. (SIZE AND TYPE AS SHOWN ON PLAN)
  - 33 202 - REMOVE EXISTING SURFACE MATERIAL.
  - 326 102.9/108.2 - 15" GRAVITY SEWER PIPE (SDR 35 PVC). INCLUDES TYPE A BEDDING AND HAUNCHING MATERIAL AND BACKFILL OF TRENCH WITH NATIVE MATERIALS MEETING 103.16 EARTH BACKFILL MATERIAL.
  - 333 102.9/108.2 - 4" SEWER SERVICE PIPE (SDR 35 PVC). INCLUDES TYPE A BEDDING AND HAUNCHING MATERIAL, BACKFILL OF TRENCH WITH NATIVE MATERIALS MEETING 103.16 EARTH BACKFILL MATERIAL, AND END-OF-SERVICE CAP.
  - 350 102.9/108.3 - 15" x 4" SEWER SERVICE TAP. FULL BODY WYE (SEE STD. DETAIL SS-06).
  - 354 104.20 - INSTALL 2-WAY SANITARY SEWER SERVICE CLEANOUT (STD. DETAIL SS-07). INCLUDES CLEANOUT RING AND COVER AND CONCRETE COLLAR IN UNPAVED AREAS (SEE STD. DETAIL SS-07).
  - 663 304 - AGGREGATE BASE COURSE (CLASS 6) (6" THICK)
  - 664 304 - AGGREGATE BASE COURSE (CLASS 6) (12" THICK)
  - 677 401.08 - HOT BITUMINOUS PAVEMENT (4" THICK) (GRADING SX, BINDER GRADE PG 64-22) (TWO 2" LIFTS)
  - 680 401.08 - HOT BITUMINOUS PAVEMENT (PATCHING) (2" THICK) (GRADING SX, BINDER GRADE PG 64-22, GYR = 75) (ONE 2" LIFT TOP MAT) (T-TOP PATCH) (SEE CITY STD. DETAIL GU-03)
  - 826 PROTECT EXISTING UTILITY LINE IN PLACE.

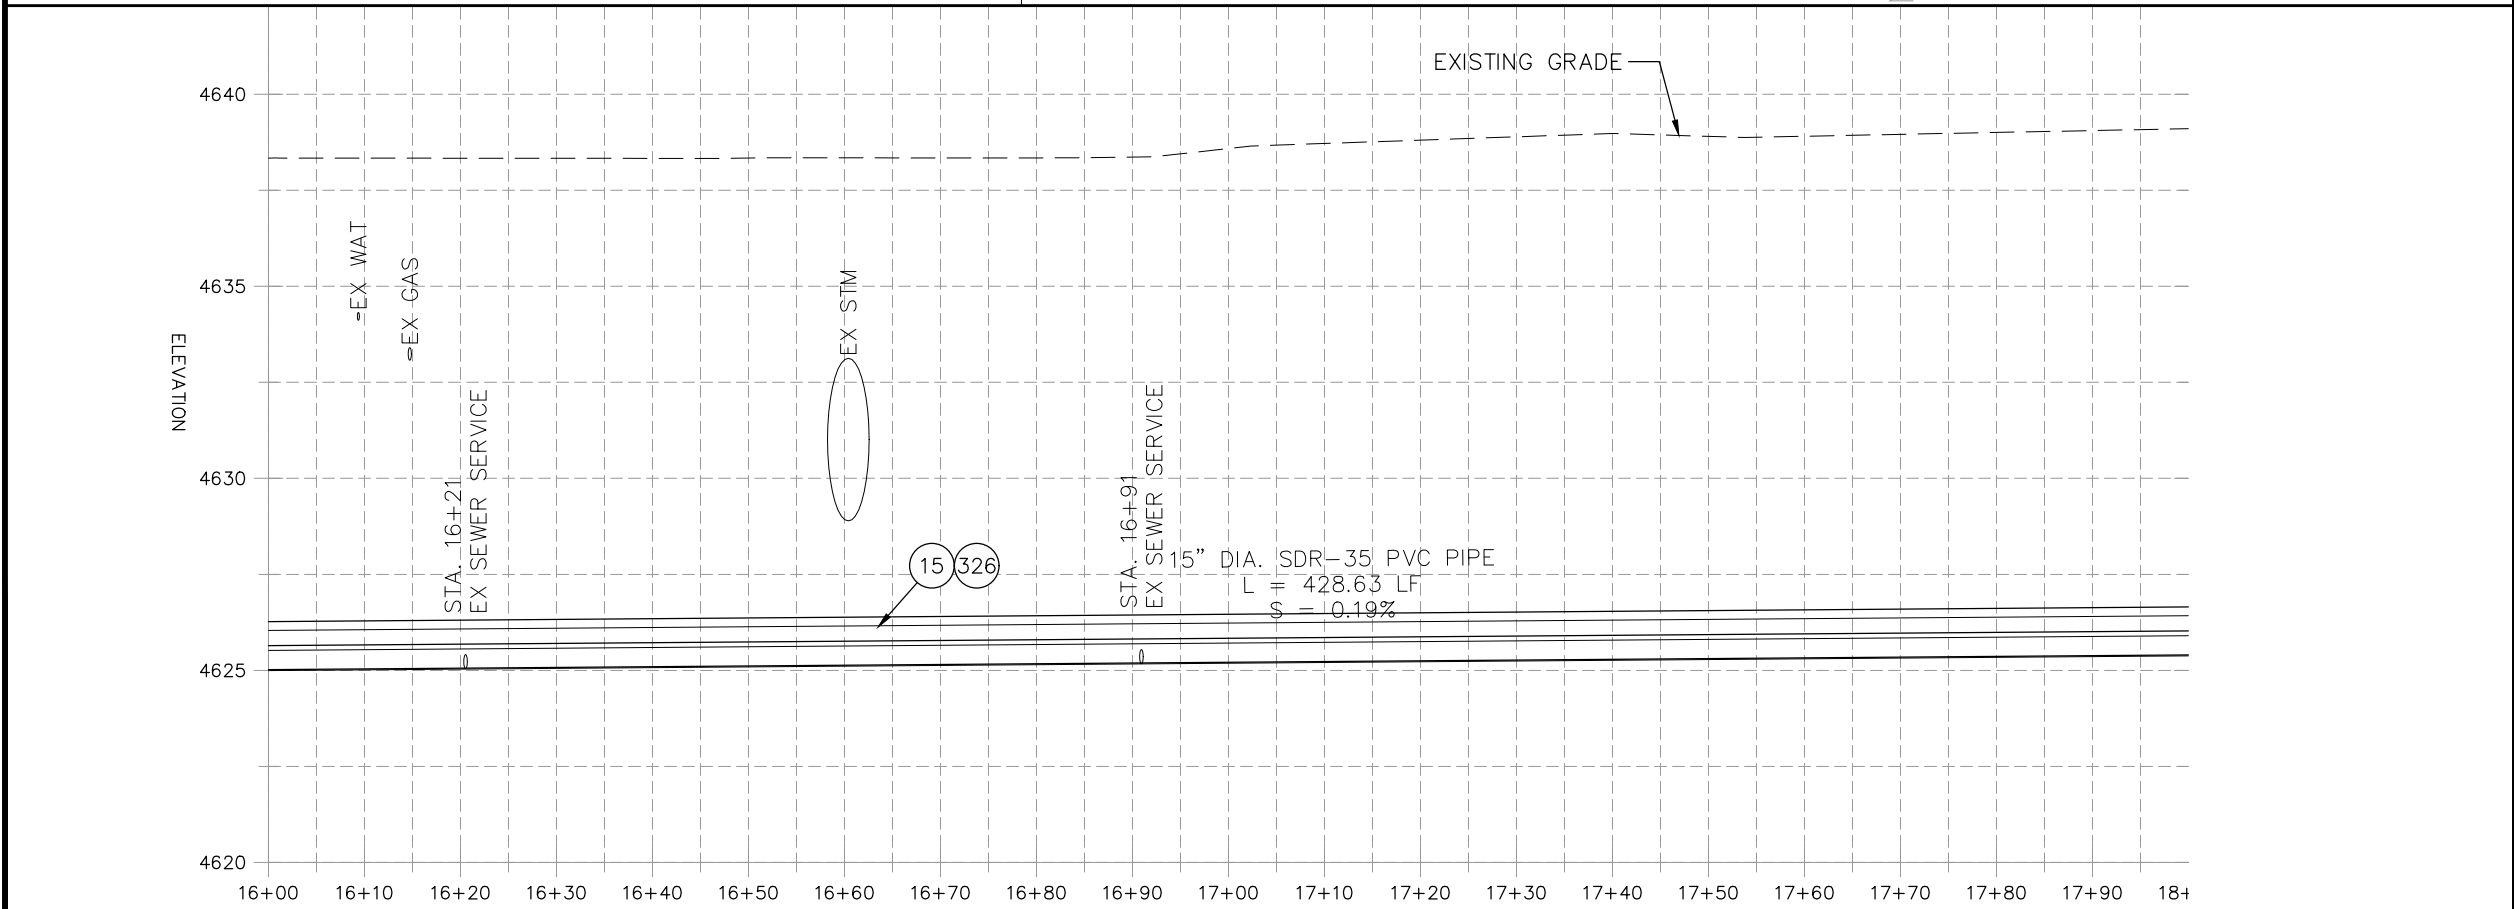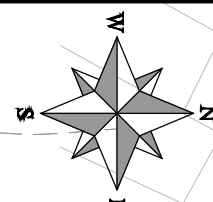


REVISION	DESCRIPTION	DATE	PROJECT NO. F001642
REVISION Δ XXX		202X	
REVISION Δ XXX		202X	
REVISION Δ XXX		202X	
REVISION Δ XXX		202X	

DATE	PROJECT NO. F001642
09/2022	
09/2022	
09/2022	
09/2022	


**CITY OF Grand Junction COLORADO**

**PUBLIC WORKS  
ENGINEERING DIVISION**

**2022 SEWER LINE REPLACEMENT  
27 ROAD PLAN AND PROFILE  
STA 16+00 TO STA 18+00**

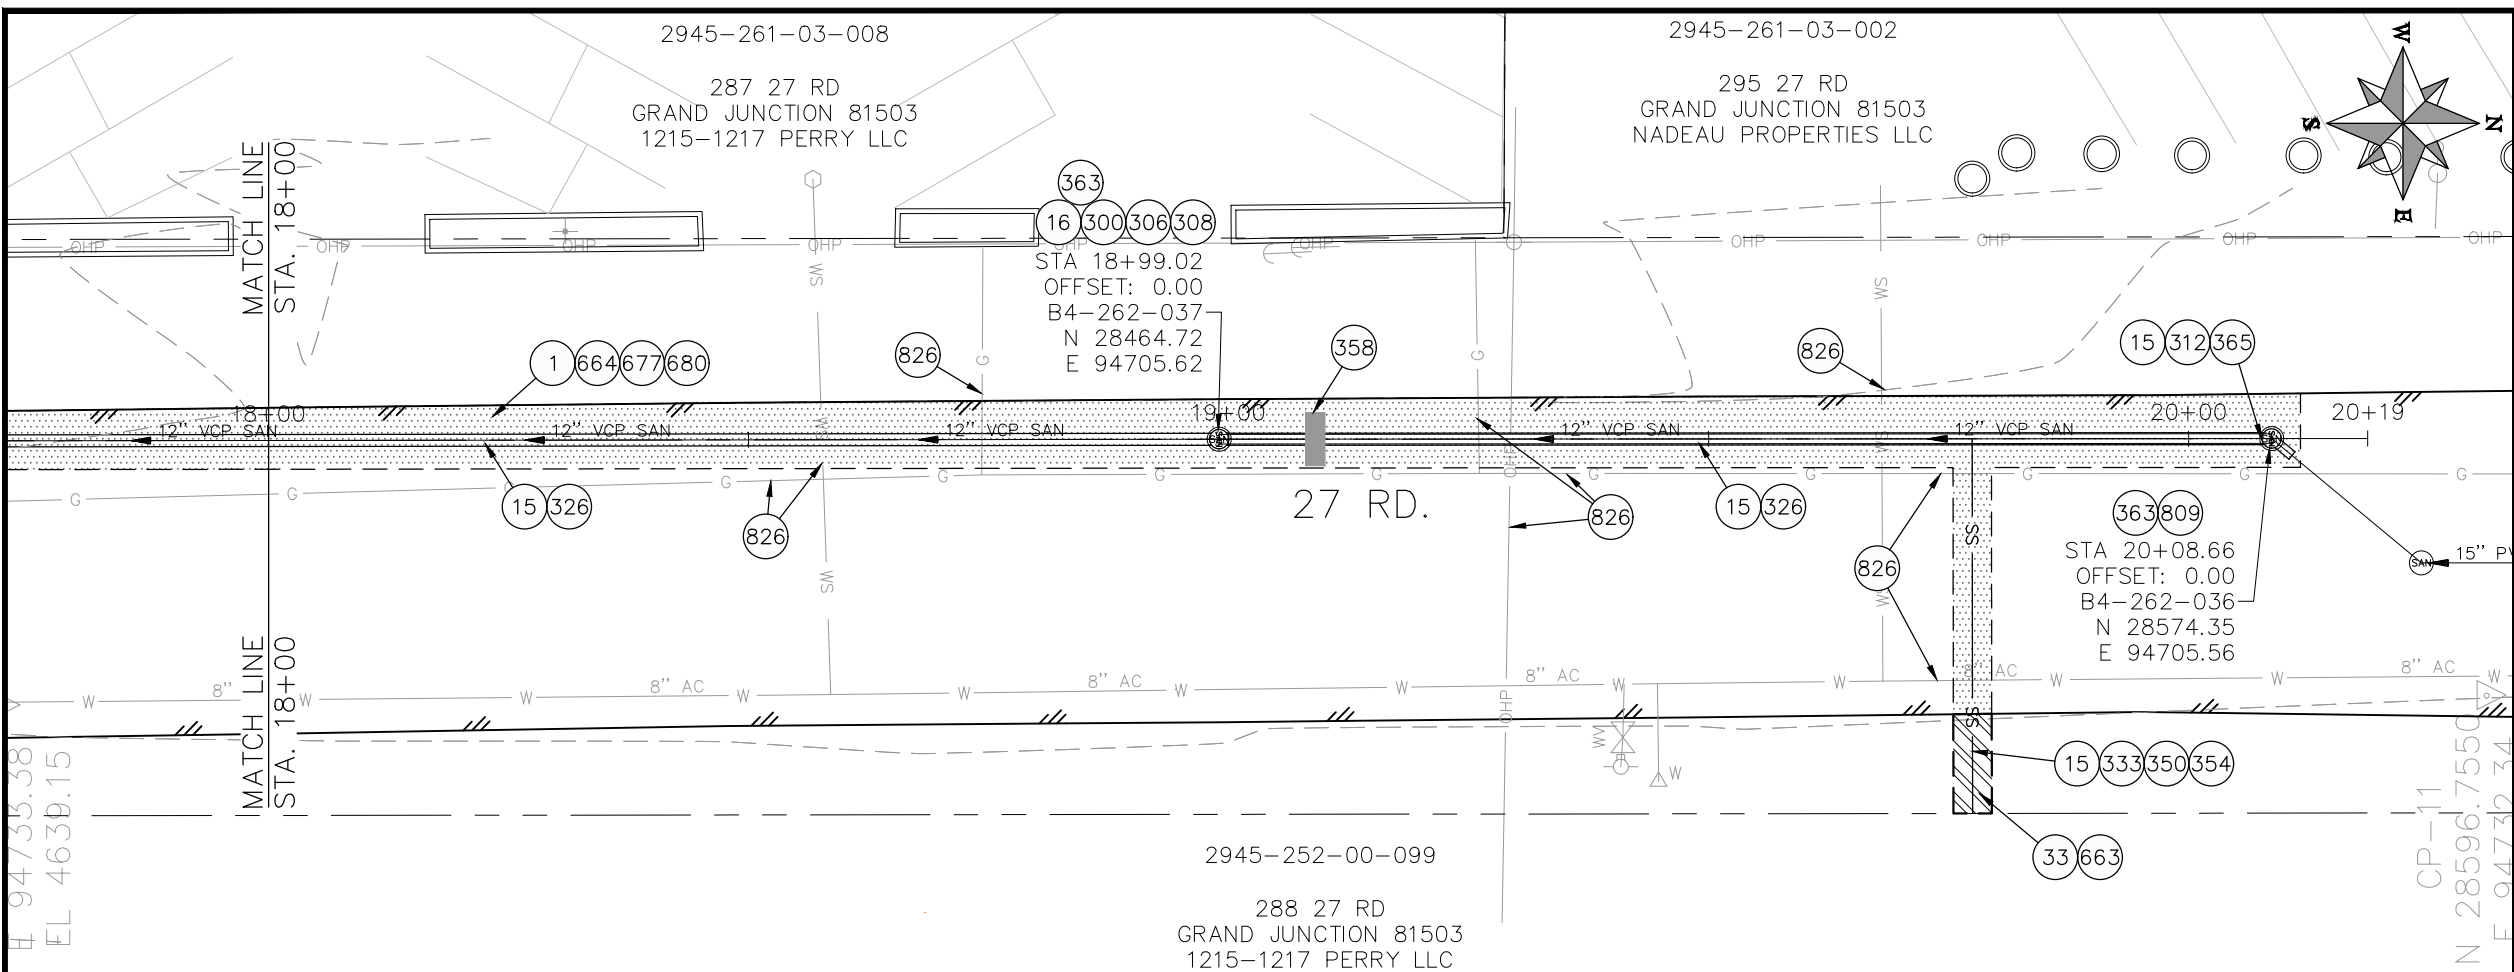

- CONSTRUCTION NOTES**
- ① 202 - REMOVAL OF ASPHALT MAT. CUT AND REMOVE ASPHALT AS SHOWN. (INDICATED BY DOT HATCH PATTERN)
  - 15 202 - REMOVAL OF PIPE AS SHOWN. (SIZE AND TYPE AS SHOWN ON PLAN)
  - 312 102.11/108.5 - CONNECT TO EXISTING MANHOLE (12" PIPE). (SEE CITY OF GRAND JUNCTION STANDARD DETAIL SS-08).
  - 326 102.9/108.2 - 15" GRAVITY SEWER PIPE (SDR 35 PVC). INCLUDES TYPE A BEDDING AND HAUNCHING MATERIAL AND BACKFILL OF TRENCH WITH NATIVE MATERIALS MEETING 103.16 EARTH BACKFILL MATERIAL.
  - 358 103 - CLAY CUT-OFF WALL (INCIDENTAL TO SEWER INSTALLATION PAY ITEM)
  - 363 BYPASS PUMPING (AS DEEMED NECESSARY BY THE CITY OR CONTRACTOR)
  - 365 CONNECT TO EXISTING SEWER MANHOLE. THE CONTRACT PRICE FOR SEWER PIPE SHALL INCLUDE THE COST OF CONNECTION TO EXISTING MANHOLE.
  - 664 304 - AGGREGATE BASE COURSE (CLASS 6) (12" THICK)
  - 677 401.08 - HOT BITUMINOUS PAVEMENT (4" THICK) (GRADING SX, BINDER GRADE PG 64-22) (TWO 2" LIFTS)
  - 680 401.08 - HOT BITUMINOUS PAVEMENT (PATCHING) (2" THICK) (GRADING SX, BINDER GRADE PG 64-22, GYR = 75) (ONE 2" LIFT TOP MAT) (T-TOP PATCH) (SEE CITY STD. DETAIL GU-03)
  - 809 PROTECT MANHOLE
  - 826 PROTECT EXISTING UTILITY LINE IN PLACE.

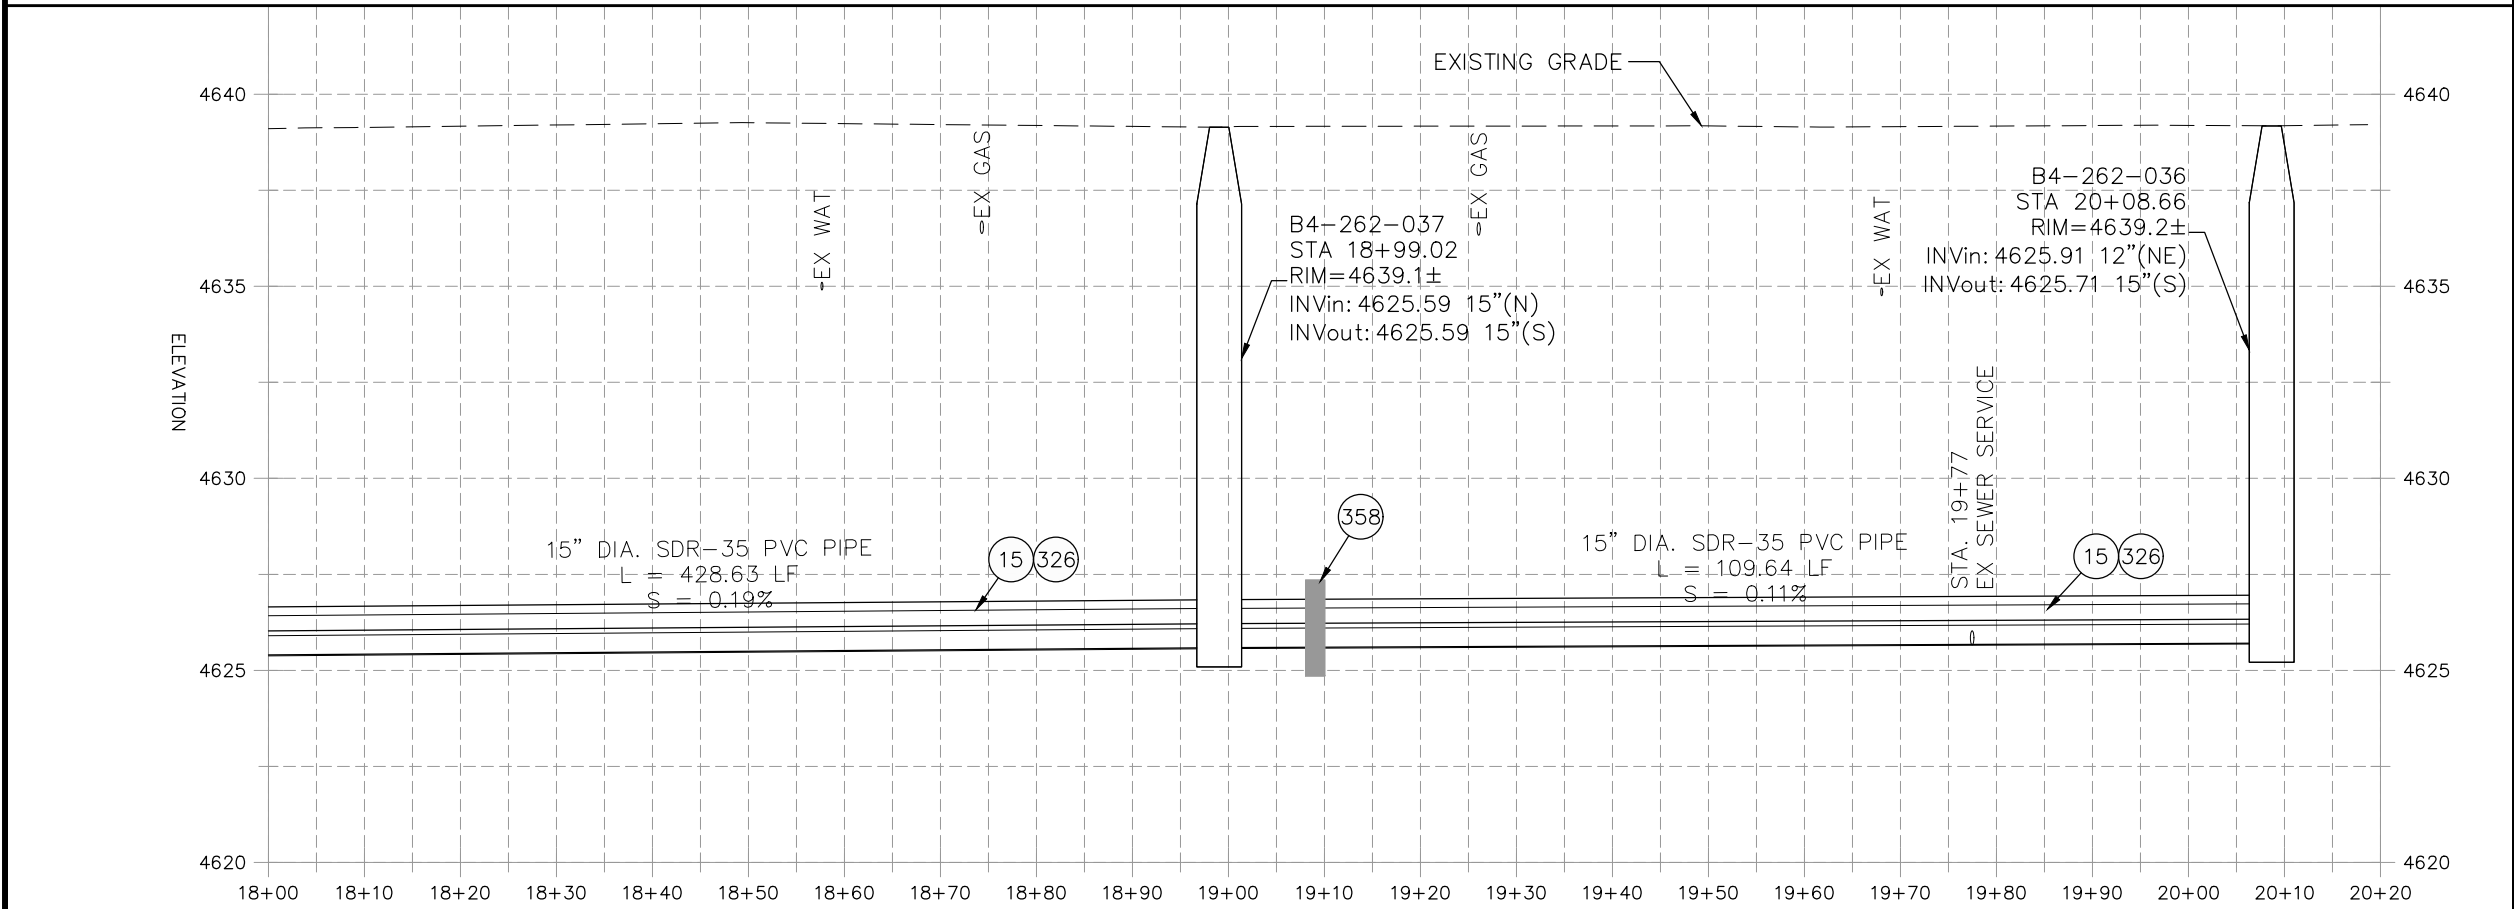

REVISION	DESCRIPTION	DATE
REVISION Δ XXX		202X
REVISION Δ XXX		202X
REVISION Δ XXX		202X
REVISION Δ XXX		202X

PROJECT NO. F001642
DRAWN BY DJM DATE 09/2022
DESIGNED BY DJM DATE 09/2022
CHECKED BY IRT DATE 09/2022
APPROVED BY KH DATE 09/2022

SCALES: PLAN & PROFILE	
HORIZONTAL: 1" = 20'	0 5 10 20
VERTICAL: 1" = 5'	0 1.25 2.5 5



**PUBLIC WORKS  
ENGINEERING DIVISION**

**2022 SEWER LINE REPLACEMENT  
27 ROAD PLAN AND PROFILE  
STA 18+00 TO STA 20+20**