			CITY	OF GRA	AND JUNCTI	JN		INDEX OF SHEETS	
			ST/		COLORADO		SHEET NO.	DESCRIPTION	Call before you d
			SIF	ALC OF	COLOKADO		1	COVER	_
			WATE	DI INE CON	STRUCTION BID PLAN	2	2	GENERAL NOTES	-
			WAIL	KLINE CON	STRUCTION BID FLAN	3	3	TABULATION OF CITY WATERLINE	-
				MESA	A COUNTY		4	WATERLINE PLAN AND PROFILE	-
							5	WATERLINE PLAN AND PROFILE	-
							6	WATERLINE PLAN AND PROFILE	-
							7	WATERLINE PLAN AND PROFILE	
							8	WATERLINE PLAN AND PROFILE	
							9	WATERLINE PLAN AND PROFILE	
							10	WATERLINE PLAN AND PROFILE	
					CITY OF GRAND JUNCTIC	N	11	WATERLINE NOTES/DETAIL	
				MAIN ST			12	WATERLINE CIVIL DETAILS	1
				3			13	WATERLINE CIVIL DETAILS	1
							14	WATERLINE CIVIL DETAILS	1
				**			15	WATERLINE CIVIL DETAILS	-
			↓	-			16	WATERLINE CIVIL DETAILS	
				a			17	EXISTING UTILITY CONFLICT PLAN	
				3			18	EXISTING UTILITY CONFLICT PLAN	
			۲. I				19	EXISTING UTILITY CONFLICT PLAN	
							20	EXISTING UTILITY CONFLICT PLAN	
				1			21	EXISTING UTILITY CONFLICT PLAN	
					(70)		22	EXISTING UTILITY CONFLICT PLAN	
			1 N W				23	EXISTING UTILITY CONFLICT PLAN	
							24	EXISTING UTILITY CONFLICT MATRIX	
					т т		25	EXISTING UTILITY CONFLICT MATRIX	
					ST ST		26	EXISTING UTILITY CONFLICT MATRIX	
			\land		R R		27	EXISTING UTILITY CONFLICT MATRIX	
							28	EXISTING UTILITY CONFLICT MATRIX	
							29	EXISTING UTILITY CONFLICT MATRIX	
							30	EXISTING UTILITY CONFLICT MATRIX	
				\setminus \backslash	<		31	EXISTING UTILITY CONFLICT MATRIX	
				/ / %			32	EXISTING UTILITY CONFLICT MATRIX	
							33	EXISTING UTILITY CONFLICT MATRIX	
				PROJEC ⁻	T LOCATION MAP		34	EXISTING UTILITY CONFLICT MATRIX	
							35	CDOT PROJECT CONTROL	_
CRIPTION OF PR	ROJECT						36	CDOT PROJECT CONTROL	_
ROJECT IS LOCATED I	N THE CITY OF GRAND JUNCTION ON I-70B	(PITKIN AVE) AND					37	CDOT PROJECT CONTROL	_
(UTE AVE).							38	CDOT PROJECT CONTROL	
OJECT INCLUDES REA DRANTS ALONG I-70	MOVAL AND REPLACEMENT OF WATERLINE MA DB (PITKIN AVE), I-70Z (UTE AVE), MAIN ST,	IN, SERVICE LINES COLORADO AVE,							
, AND 3RD ST.	Print Date: 11/2/23		Revisions	Colorado D	epartment of Transportatior	ISSUED FOR BI	I-70B	SOUTH OF ROOD	Project No./Code
	File Name: 1.DWG		ments Init.		oparament of fransportation		4	COVER	, ,
eals for this set of ings are applied to	Horiz. Scale: Vert. Scale: As Noted			Grand hunst	Grand Junction City Hall	No Revisions:			NHPP 070A-037
ne cover page(s)	Unit Information	2			250 North 5th Street Grand Junction, CO 81501	Revised:	Designer: B. LUSTER		23583
		ו וכ			970-244-1501		Detailer: C. WITTEN	MEIER Numbers	

GENERAL

- G1. THIS PROJECT IS DESIGNATED AS A NON-SIGNIFICANT FOR TRAFFIC CONTROL PURPOSES.
- G2. THE CONTRACTOR SHALL FIELD VERIFY LENGTHS, DIAMETERS, ELEVATIONS, LOCATIONS AND THICKNESS BEFORE ORDERING MATERIALS.
- G3. NO EXCESS MATERIAL SHALL BE DSPOSED OF WITHIN THE PROJECT LIMITS BUT SHALL BE HAULED OFF SITE FOR DISPOSAL. WHICH SHALL BE INCLUDED IN THE COST OF THE WORK.
- G4. A CLEAR ZONE CRITERIA OF 14-18 FEET SHALL BE USED FOR I-70B AND I-70Z, AND A CLEAR ZONE OF 7-16 FEET SHALL BE USED FOR LOCAL ROADS DURING THIS PROJECT. NO PARKING OR EQUIPMENT STORAGE SHALL BE ALLOWED WITHIN THE CLEAR ZONE OR WITHIN THE MEDIAN. THE CONTRACTOR SHALL NOT STOCKPILE MATERIAL WITHIN THE CLEAR ZONE. THE CONTRACTOR MAY USE BARRIER WITH BUFFER AREA WITHIN THE CLEAR ZONE AS APPROVED BY THE ENGINEER.
- G5. EXISTING CURB AND GUTTER, CROSS PANS, SIDEWALKS, DRIVEWAYS, SIGNS, AND/OR ANY OTHER STRUCTURE OR MARKER NOT IDENTIFIED IN THE CONTRACT TO BE REMOVED OR MODIFIED, WHICH ARE DAMAGED BY THE WORK, SHALL BE REPLACED AT THE CONTRACTOR'S EXPENSE. ANY DAMAGE TO ITEMS DESIGNATED TO BE PROTECTED IN PLACE SHALL BE REPARED OR REPLACED TO PRECONSTRUCTION CONDITIONS OR BETTER AT NO ADDITIONAL COST TO THE PROJECT.
- G8. UNLESS OTHERWISE NOTED, MATERIALS SHALL BE CONTRACTOR'S SOURCE.
- G9. ALL POTHOLING METHODS AND LOCATIONS SHALL BE PREAPPROVED BY THE ENGINEER. ANY POTHOLING THAT HAS NOT BEEN PREAPPROVED BY THE ENGINEER SHALL BE AT THE CONTRACTORS EXPENSE.
- G10. FIELD OFFICE (CLASS 2), FIELD LABORATORY (CLASS 2) AND SANITARY FACILITY SHALL BE LOCATED AS APPROVED BY ENGINEER.
- G15. A PRE-CONSTRUCTION MEETING WILL BE HELD TO DISCUSS CONSTRUCTION PHASING AND SEQUENCING, CONSTRUCTION SCHEDULE, AND NECESSARY COORDINATION AND EXPECTATIONS PRIOR TO THE START OF CONSTRUCTION.

EARTHWORK

- E1. EXCAVATION REQUIRED FOR COMPACTION OF BASES OF CUTS AND FILLS WILL BE CONSIDERED AS SUBSIDIARY TO THAT OPERATION AND WILL NOT BE PAID FOR SEPARATELY.
- E2. WATER SOURCE REQUIRED FOR MOISTURE/DENSITY CONTROL SHALL BE THE CONTRACTOR'S RESPONSIBILITY AND SHALL BE FREE OF EXCESSIVE SEDIMENTS AND OTHER CONTAMINANTS THAT MAY BE DETRIMENTAL TO EMBANKMENTS, SUB-BASES, AND BASE COURSE MATERIAL.
- E6. ALL TRENCHES SHALL BE BACKFILLED BEFORE THE WORK SHIFT ENDS. ANY TRENCHES THAT CANNOT BE BACKFILLED BEFORE THE WORK SHIFT ENDS MUST BE COVERED WITH A STEEL PLATE. THIS SHALL NOT BE PAID FOR SEPARATELY, BUT SHALL BE INCLUDED IN THE COST OF THE WORK.
- E7. WATER SHALL BE USED AS A DUST PALLIATIVE WHERE REQUIRED. APPLICATION SHALL BE AS DIRECTED BY THE ENGINEER. WATER AS A DUST PALLIATIVE AND ANY OTHER WETTING SHALL BE INCLUDED IN THE WORK AND WILL NOT BE PAID SEPARATELY.
- E8. THE CONTRACTOR SHALL BE RESPONSIBLE TO OBTAIN ANY ADDITIONAL BORING LOGS AND/OR SOIL INFORMATION.
- E10. THE CONTRACTOR SHALL EXPECT BOULDERS AND COBBLES IN EXCAVATIONS AND DEEP FOUNDATIONS.

DRAINAGE

D3. THE CONTRACTOR SHALL PROVIDE TEMPORARY LOCAL DRAINAGE DURING EACH PHASE OF CONSTRUCTION INCLUDING BUT NOT LIMITED TO DRAINAGE STRUCTURES. THIS WORK WILL NOT BE PAID FOR SEPARATELY, BUT SHALL BE CONSIDERED INCIDENTAL TO THE WORK. THE CONTRACTOR SHALL COORDINATE WITH THE ENGINEER ON DRAINAGE FLOWS AND DIRECTIONS.

ENVIRONMENTAL

- ENI. THE CONTRACTOR SHALL LIMIT CONSTRUCTION ACTIVITIES TO THOSE AREAS WITHIN THE LIMITS OF DISTURBANCE AND/OR THE TOES OF SLOPE AS SHOWN ON THE PLANS AND CROSS SECTIONS. ANY DISTURBANCE BEYOND THESE LIMITS SHALL BE RESTORED TO ORIGINAL CONDITIONS AT THE CONTRACTOR'S EXPENSE. CONSTRUCTION ACTIVITIES IN ADDITION TO NORMAL CONSTRUCTION PROCEDURES SHALL INCLUED PARKING OF VEHICLES AND EQUIPMENT, DISPOSAL OF LITTER, AND ANY OTHER ACTION WHICH WOULD ALTER EXISTING CONDITIONS.
- EN2. THE STORMWATER MANAGEMENT FLAN IDENTIFIES EXISTING TREES TO BE PROTECTED. TREES CONSIDERED FOR REMOVAL SHALL BE COODINATED WITH THE ENGINEER IN THE EVENT THE EXISTING TREES MAY BE SAVED. EXISTING UTILITIES SHALL BE EVALUATED BEFORE ANY TREE REMOVAL. TREE PROTECTION SHALL BE INCLUDED IN THE WORK AND NOT BE PAID FOR SEPARATELY.
- EN3. DURING ALL SUBSURFACE ACTIVITIES, WORKERS SHALL BE ALERT FOR VISUAL AND OLFACTORY SIGNS OF CONTAMINATION. IF CONTAMINATION IS ENCOUNTERED, WORK SHALL STOP AND PROCEDURES ESTABLISHED IN THE CDOT 250 SPEC SHALL BE FOLLOWED. ANY CONTAMINATED SOILS OR LANDFILL MATERIAL SHALL BE PROPERLY HANDLED AND SAMPLED PRIOR TO DISPOSAL.
- EN4. THE CONTRACTOR SHALL BE RESPONSIBLE FOR ANY DEWATERING, IF NEEDED, AND OBTAINING THE APPLICABLE DEWATERING PERMIT FOR CONSTRUCTION AT THE SITE PER SPECIFICATIONS. THE PERMIT IS OBTAINED FROM THE COLORADO DEPARTMENT OF PUBLIC HEALTH AND ENVIORNMENT. THE PERMIT AND ANY DEWATERING WILL NOT BE PAID FOR SEPARATELY BUT SHALL BE INCLUDED IN THE WORK.

RIGHT OF WAY

R2. THE CONTRACTOR SHALL PROTECT ALL EXISTING SURVEY MONUMENTATION DESIGNATED TO REMAIN FROM DAMAGE DURING CONSTRUCTION OPERATIONS. ANY MONUMENTS DISTURBED BY THE CONTRACTOR THAT ARE NOT DESIGNATED FOR RELOCATION, SHALL BE RESET AT THE CONTRACTOR'S EXPENSE IN ACCORDANCE WITH SECTION 629, SURVEY MONUMENTATION. THE CONTRACTOR AND ENGINEER SHALL NOTE THOSE MONUMENTS IN THE FIELD PRIOR TO CONSTRUCTION. SEE TABULATION OF SURVEY.

UTILITIES

- U1. SEE PROJECT SPECIAL SPECIFICATIONS FOR UTILITY CONTACT INFORMATION.
- U2. EXISTING UTILITY LINES AS SHOWN ON THE PLAN SHEETS ARE PLOTTED FROM THE BEST AVAILABLE INFORMATION AND ARE BASED ON A SUBSURFACE UTILITY ENGINEERING INVESTIGATION (SUE). THE SUE PLANS WILL BE A SUPPLEMENTAL DOCUMENT AVAILABLE WITH THE CONSTRUCTION DOCUMENTS. ALL UTILITY LINES ARE ASCE 38 STANDARD QUALITY LEVEL B EXCEPT AS NOTED ON THE SUE PLANS.
- U3. THE CONTRACTOR'S ATTENTION IS DIRECTED TO SUBSECTION 105.11 OF THE STANDARD SPECIFICATIONS AND THE UTILITY PROJECT SPECIAL PROVISIONS CONCERNING UTILITIES. THE CONTRACTOR SHALL COORDINATE AND COOPERATE WITH UTILITY OWNERS IN THEIR REMOVAL, ADJUSTMENT AND/OR RELOCATION OPERATIONS SO THAT THE UTILITY WORK CAN BE ACCOMPLISHED WITHOUT IMPACTING THE CONSTRUCTION SCHEDULE.
- U4. THE CONTRACTOR SHALL COMPLY WITH ARTICLE 1.5 OF TITLE 9, CRS ("EXCAVATION REQUIREMENTS") WHEN EXCAVATING OR GRADING IS PLANNED IN THE AREA OF UNDERGROUND UTLITY FACILITES. THE CONTRACTOR SHALL NOTIFY ALL AFFECTED UTILITIES AT LEAST TWO (2) BUSINESS DAYS, PLUS THE ACTUAL DAY OF NOTICE, PRIOR TO COMMENCING SUCH OPERATIONS. THE CONTRACTOR SHALL CONTACT THE UTILITY NOTIFICATION CENTER OF COLORADO (UNCC) APERATIONS. THE CONTRACTOR SHALL CONTACT THE UTILITY NOTIFICATION CENTER OF COLORADO (UNCC) APERATIONS. THE CONTRACTOR SHALL CONTACT THE UTILITY NOTIFICATION CENTER OF COLORADO (UNCC) APERATIONS. THE CONTRACTOR SHALL CONTACT THE UTILITY NOTIFICATION CENTER OF COLORADO (UNCC) APERATIONS. THE CONTRACTOR SHALL BE LOCATED BY CONTACTING THE RESPECTIVE OWNER. CDDT LOCATES ARE REQUESTED THROUGH THE UNCC. UTILITY SERVICE LATERALS SHALL ALSO BE LOCATED PRIOR TO BEGINNING EXCAVATION OR GRADING. CONTRACTOR TO REFERENCE POINTMAN FOR UNDERGROUND UTILITY DATA PRIOR TO EXCAVATION.
- U5. THE CONTRACTOR SHALL BE RESPONSIBLE FOR VERIFYING THE LOCATION AND DEPTH OF ALL EXISTING UTILITIES AT PIPES, CULVERTS, CONCRETE BOX CULVERTS, SIGNAL POLES, WALLS, AND OTHER AREAS OF EXCAVATION AS NECESSARY TO ENSURE THE UTILITIES WILL NOT BE IMPACTED.
- U6. LOCATION AND NOTIFICATION OF BOTH UNCC MEMBER AND NON-MEMBER UTILITIES IS THE CONTRACTOR'S RESPONSIBILITY.
- U7. THERE ARE UTILITY CONFLICTS WITHIN THE PROJECT LIMITS. THE CONTRACTOR SHALL REQUEST UTILITY LOCATES PRIOR TO COMMENCING ANY TYPE OF EXCAVATION, OR OTHER IMPROVEMENTS. BASED UPON IMPROVEMENTS ADJUSTMENTS MAY BE DIRECTED BY THE PROJECT ENGINEER TO AVOID UTILITY CONFLICTS. HAND DIGGING OR OTHER MEANS OF EXCAVATION MAYBE REQUIRED.
- U8. AS THE CONTRACTOR APPROACHESBURIED UTILITY FACILITIES, THE UTILITY FACILITIES SHALL BE EXPOSED THROUGH A NON-DESTRUCTIVE MEANS PRIOR TO MECHANICAL EXCAVATION. DAMAGES THAT ARE INCURRED ARE AT THE CONTRACTOR'S EXPENSE IF METHODS THAT DO NOT MEET THE APPROVED REQUIREMENTS ARE USED.


	Print Date: 11/2/23 File Name: 1.DWG	Date:	Sheet Revisions Comments	1	Colorado Department of Transportation	ı I	ISSUED FOR BID	I-70B SOUT	TH OF ROO L NOTES	D	Project No./Code
All seals for this set of		Dute.	Comments	Init.	Grand Junction City Hall		No Revisions:	GENERAL			NHPP 070A-037
drawings are applied to the cover page(s)	Unit Information				Grand Junction 250 North 5th Street Grand Junction, CO 81501	- [revised;	Designer: B. LUSTER Detailer: C. WITTENMEIER	Structure		23583
					970-244-1501 KCC	c [Sheet Subset: WATERLINE		2 of 38	Sheet Number








			202-0	0032	202-0	0035					210-00035	210	-00050	210-	-04060	250-0	0224	619	-00002	619	-00006	619	-00007
STAT	ΓΙΟΝ	ALIGNMENT	Removal	of Valve	Removal	of Pine	awing Asphalt laterial (6 Inch)	Structure Backf (Flow-Fill)		Material ass A)	Reset Water M	leter Reset Fi	re Hydrant	Adjust W	Vater Meter	Hazardous W (Radio		l Wate	r Service		ct to New terline		t To Existin Iterline
			EA	CH	L	-	LF	CY	0	CY	EACH	E	ACH	E	EACH	C	Y	E	ACH	E	ACH	F	EACH
FROM	TO	1	PLAN /	AS CONST.	PLAN /	S CONST.	PLAN	PLAN	PL	LAN	PLAN AS CO	NST. PLAN	AS CONST.	PLAN	AS CONST.	PLAN	AS CONS	T. PLAN	AS CONST	. PLAN	AS CONST	. PLAN	AS CONS
10+00	16+00	UTE AVE (SHT 6)	4		596		1256	174	1.	139	1	3		3		314		1					
16+00	22+95	UTE AVE (SHT 7)	4		692		1502	209	1	168		1		6		376						2	
10+00	14+00	PITKIN AVE (SHT 8)	5		392		822	114		92	2	1		9		206							
14+00	18+49	PITKIN AVE (SHT 9)	4		520		1138	158		27		2		11		285						2	
10+00	15+50	2ND ST (SHT 10)	1		450		1128	157		.24		1		6		280	_			2		1	
			18		2650		5846	812	6	549	3	0	1 1	35		1461		1		2		5	
		PROJECT TOTALS	10		2030		5010	UIL			3	0				1101							
		PROJECT TOTALS	10		2030		5010													2		3	
	_	PROJECT TOTALS		40060		-40120	619-4016		Т		N OF WATERLI	NE UTILITES 19-50480	619-50		619-75048	_	75064	619-7	7206	619-7	7208		77300
STAT	TION	ALIGNMENT	619- 3/4 Inc	40060 h Copper ipe	619 1.5 Inc	-40120 h Copper Pipe		0 619-50	7/ 240	ABULATION	N OF WATERLI		619-50 8 Inch Plas	640	619-75048 6 Inch Gate Val	619-		619-7 6-Inch Re Coupling	strained		estrained	619-7	77300 ation Stop
STAT	τιον		619- 3/4 Inc P	h Copper	619 1.5 Inc	h Copper	619-4016	0 619-50	7/ 240	ABULATION 619-50320	N OF WATERLI	19-50480		640 tic Pipe		619- ve 8 Inch G		6-Inch Re	strained Adapter	619-7 8-Inch Re Coupling	estrained	619-7 Corpora	
FROM	то	ALIGNMENT	619- 3/4 Inc P PLAN	h Copper ipe	619 1.5 Inc I	h Copper Pipe	619-4016 2 Inch Copper LF	D 619-50 Pipe 3 Inch Plas	T/ 240 tic Pipe 4	ABULATION 619-50320 Inch Plastic	I OF WATERLII	19-50480 n Plastic Pipe LF N AS CONST.	8 Inch Plas LF PLAN A	640 itic Pipe	6 Inch Gate Val EACH PLAN AS COI	619- ve 8 Inch G E. IST. PLAN	ate Valve	6-Inch Re Coupling EAC PLAN	strained Adapter	619-7 8-Inch Re Coupling EA PLAN	estrained Adapter	619-7 Corpora EA	ition Stop
FROM 10+00	TO 16+00	ALIGNMENT UTE AVE (SHT 6)	619- 3/4 Inc P PLAN 69	h Copper ipe LF	619 1.5 Inc PLAN 28	h Copper Pipe LF	619-4016 2 Inch Copper LF	D 619-50 Pipe 3 Inch Plas	T/ 240 tic Pipe 4	ABULATION 619-50320 Inch Plastic	NOF WATERLII	19-50480 n Plastic Pipe LF N AS CONST.	8 Inch Plas LF PLAN A 546	640 itic Pipe	6 Inch Gate Val	619- ve 8 Inch C E. IST. PLAN 2	ate Valve	6-Inch Re Coupling EAC PLAN 15	strained Adapter CH	619-7 8-Inch Re Coupling EA PLAN 38	estrained Adapter CH	619-7 Corpora EA PLAN 5	ation Stop
FROM 10+00 16+00	TO 16+00 22+95	ALIGNMENT UTE AVE (SHT 6) UTE AVE (SHT 7)	619- 3/4 Inc P PLAN 69 132	h Copper ipe LF	619 1.5 Inc I	h Copper Pipe LF	619-4016 2 Inch Copper LF	D 619-50 Pipe 3 Inch Plat EF ONST. PLAN A	T/ 240 tic Pipe 4 S CONST. F	ABULATION 619-5032(Inch Plastic LF PLAN AS C	I OF WATERLII 0 6 Pipe 6 Inch CONST. PLAI 82 16	19-50480 n Plastic Pipe LF N AS CONST.	8 Inch Plas LF PLAN A 546 735	640 itic Pipe	6 Inch Gate Val EACH PLAN AS COI	619- ve 8 Inch G E. IST. PLAN	ate Valve	6-Inch Re Coupling EAC PLAN	strained Adapter CH	619-7 8-Inch Re Coupling EA PLAN 38 58	estrained Adapter CH	619-7 Corpora EA PLAN 5 6	ation Stop
FROM 10+00	TO 16+00 22+95 14+00	ALIGNMENT UTE AVE (SHT 6) UTE AVE (SHT 7) PITKIN AVE (SHT 8)	619- 3/4 Inc PLAN 69 132 65	h Copper ipe LF	619 1.5 Inc PLAN 28	h Copper Pipe LF	619-4016 2 Inch Copper LF	D 619-50 Pipe 3 Inch Plas	T/ 240 tic Pipe 4 S CONST. F	ABULATION 619-50320 Inch Plastic	NOF WATERLII	19-50480 n Plastic Pipe LF N AS CONST.	8 Inch Plas LF PLAN A 546 735 392	640 itic Pipe	6 Inch Gate Val EACH PLAN AS COI 3	619- ve 8 Inch C E. IST. PLAN 2	ate Valve	6-Inch Re Coupling EAC PLAN 15	strained Adapter CH	619-7 8-Inch Re Coupling EA PLAN 38	estrained Adapter CH	619-7 Corpora EA PLAN 5	ation Stop
FROM 10+00 16+00 10+00	TO 16+00 22+95 14+00 18+49	ALIGNMENT UTE AVE (SHT 6) UTE AVE (SHT 7) PITKIN AVE (SHT 8) PITKIN AVE (SHT 8)	619- 3/4 Inc P PLAN 69 132 65 154	h Copper ipe LF	619 1.5 Inc PLAN 28	h Copper Pipe LF	619-4016 2 Inch Copper LF	D 619-50 Pipe 3 Inch Plat EF ONST. PLAN A	T/ 240 tic Pipe 4 S CONST. F	ABULATION 619-5032(Inch Plastic LF PLAN AS C	I OF WATERLII 100 6 100 6 100 6 100 10 100 49	19-50480 n Plastic Pipe LF N AS CONST.	8 Inch Plas LF PLAN A 546 735 392 520	640 itic Pipe	6 Inch Gate Val EACH PLAN AS COI 3 1	619- ve 8 Inch C E. IST. PLAN 2	ate Valve	6-Inch Re Coupling EAC PLAN 4 15 3	strained Adapter CH	619-7 8-Inch Re Coupling EA PLAN 38 58 58 26 54	estrained Adapter CH	619-7 Corpora EA PLAN 5 6	ition Stop
FROM 10+00 16+00	TO 16+00 22+95 14+00	ALIGNMENT UTE AVE (SHT 6) UTE AVE (SHT 7) PITKIN AVE (SHT 8)	619- 3/4 Inc PLAN 69 132 65 154 120	h Copper ipe LF	619 1.5 Inc PLAN 28	h Copper Pipe LF	619-4016 2 Inch Copper LF	D 619-50 Pipe 3 Inch Plat EF ONST. PLAN A	240 tic Pipe 4 S CONST. F	ABULATION 619-5032(Inch Plastic LF PLAN AS C	I OF WATERLII 10 6 Pipe 6 Inch CONST. PLAN 82 16 19	19-50480 n Plastic Pipe LF AS CONST.	8 Inch Plas LF PLAN A 546 735 392	640 itic Pipe	6 Inch Gate Val EACH PLAN AS CO! 3 1 1	619- /e 8 Inch G IST. PLAN 2 2 1	ate Valve	6-Inch Re Coupling EAC PLAN 4 15 3 4	strained Adapter CH	619-7 8-Inch Re Coupling EA PLAN 38 58 26	estrained Adapter CH	619-7 Corpora EA PLAN 5 6 11	ation Stop


	Print Date: 11/2/23				Sheet Revisions	_	Colorado Department of Transportation	n I	SSUED FOR BID		TH OF ROOD	Project No./Code
	File Name: 1.DWG			Date:	Comments	Init.	Grand Junction City Hall		No Revisions:	IABULA CITY WA	TION OF	NHPP 070A-037
drawings are applied to	Horiz. Scale: Unit Information	Vert. Scale: As Notec	\cong				Grand lunction 250 North 5th Street	- H			Structure	
the cover page(s)	KTOBROADWAY, SUITE SKO		\square				970-244-1501	- H	Neviseu.	Detailer: C. WITTENMEIER		23583
			\Box				KCC	C	Void:	Sheet Subset: WATERLINE	Subset Sheets: 3 of 38	Sheet Number

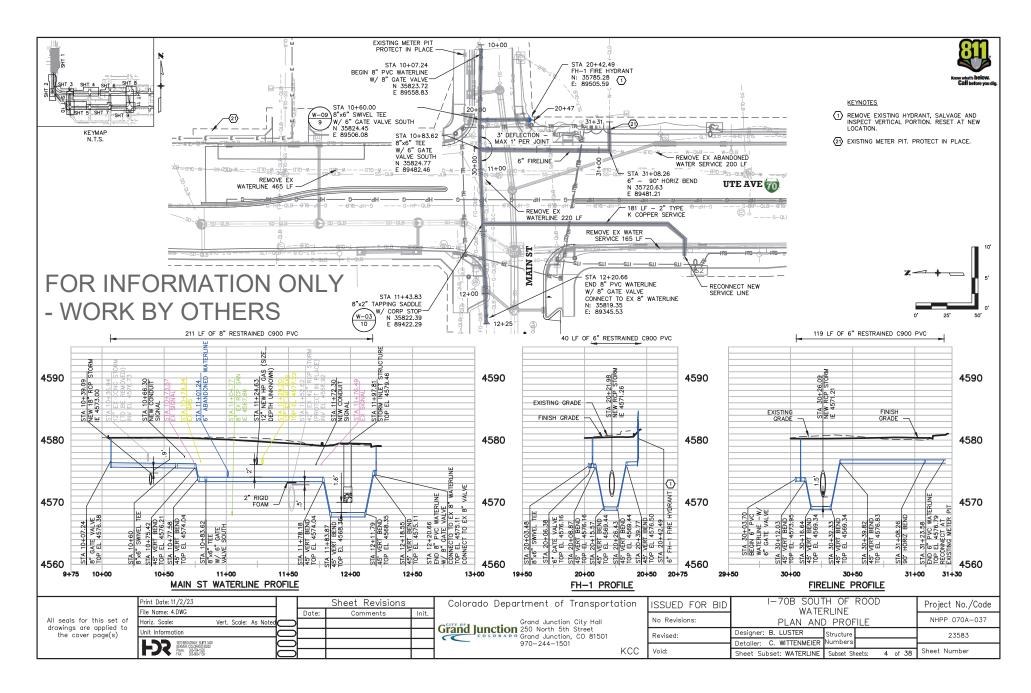


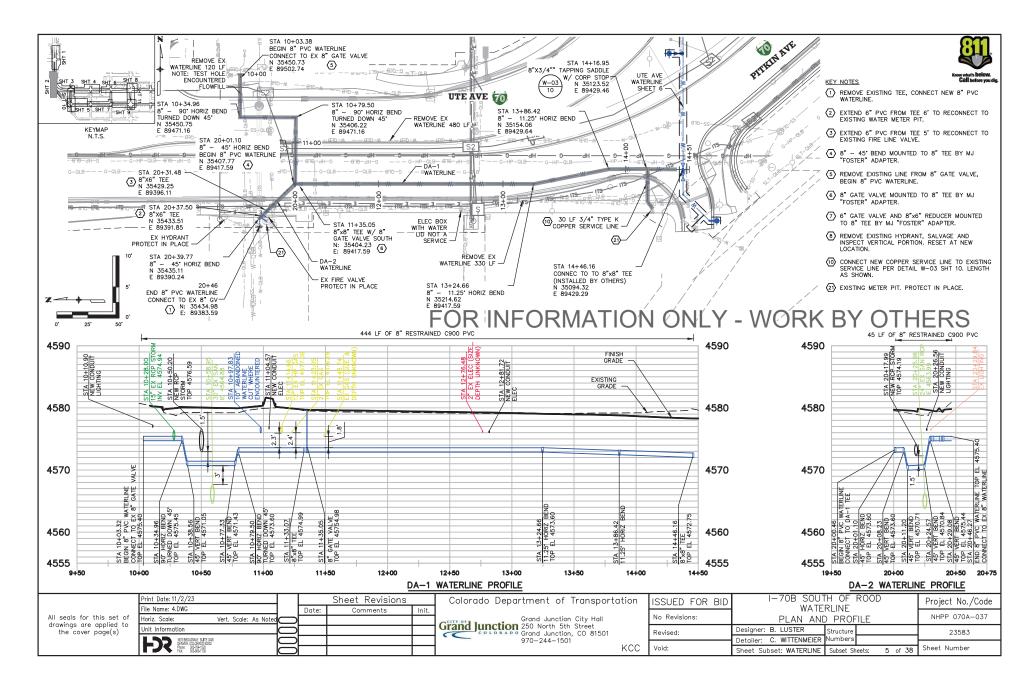


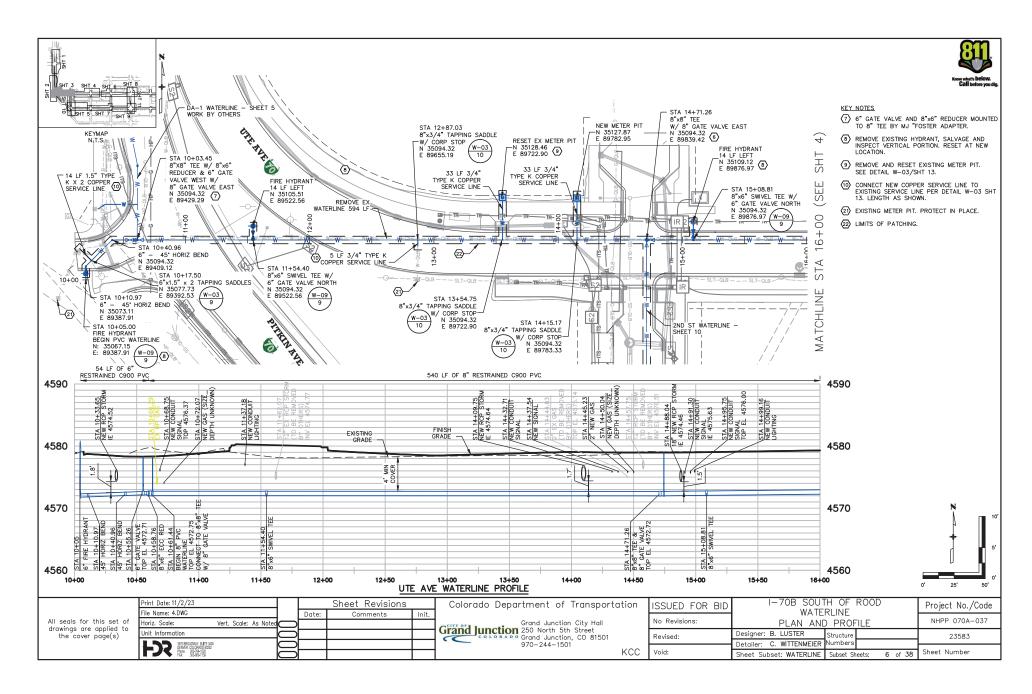

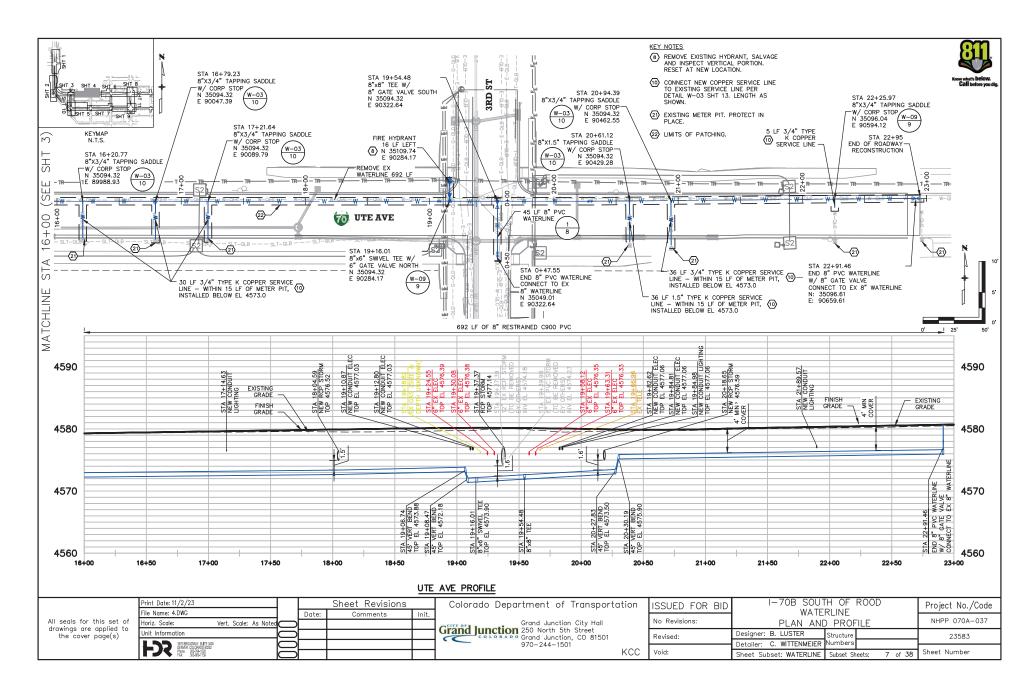

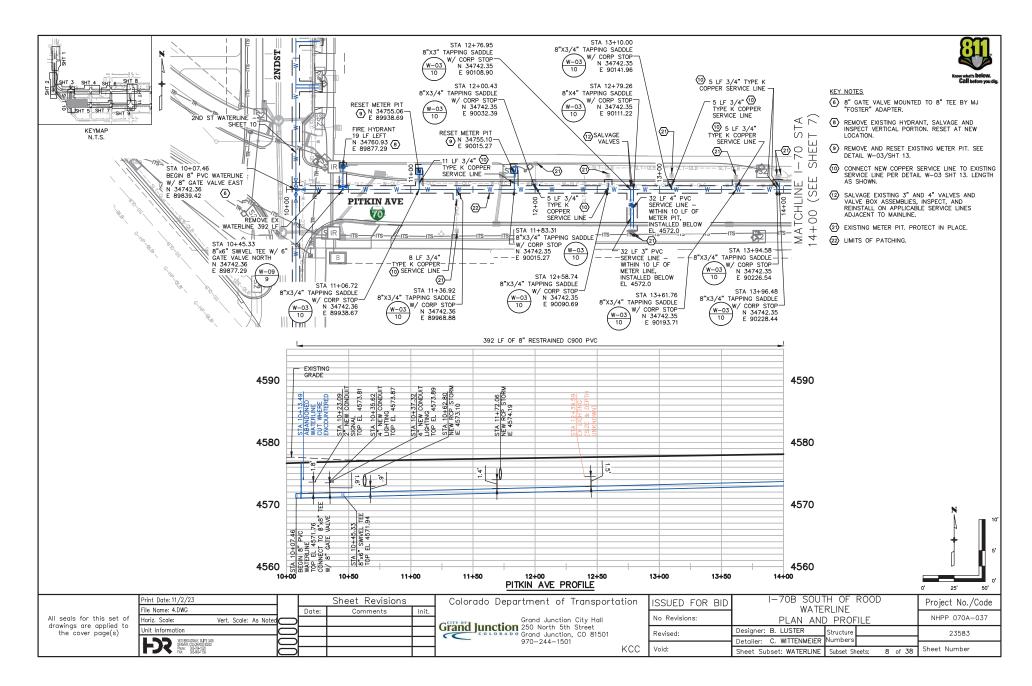

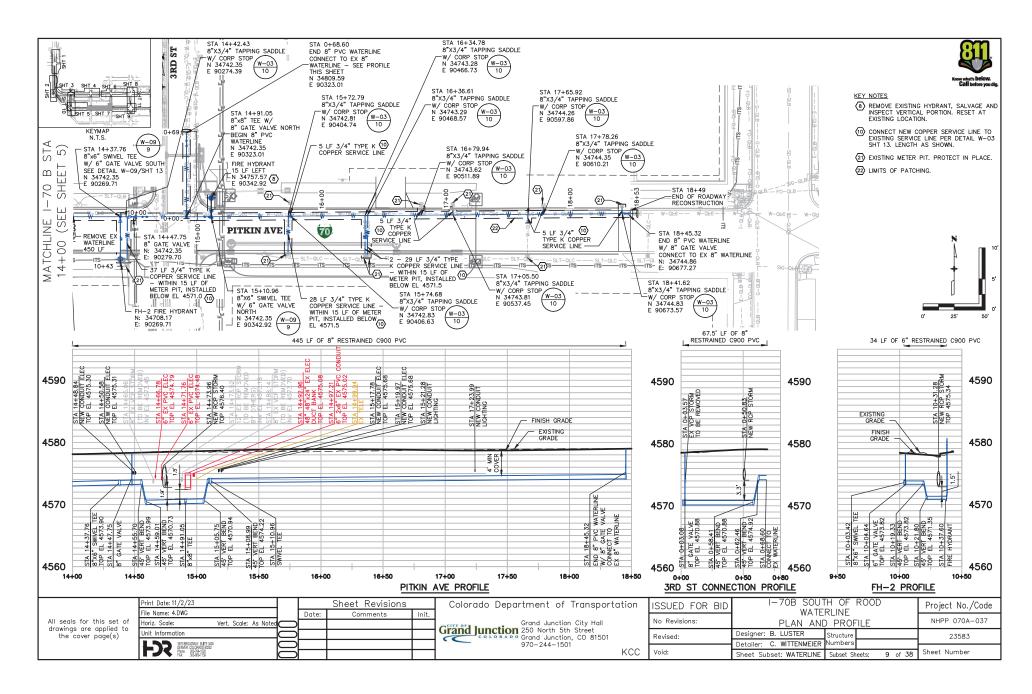


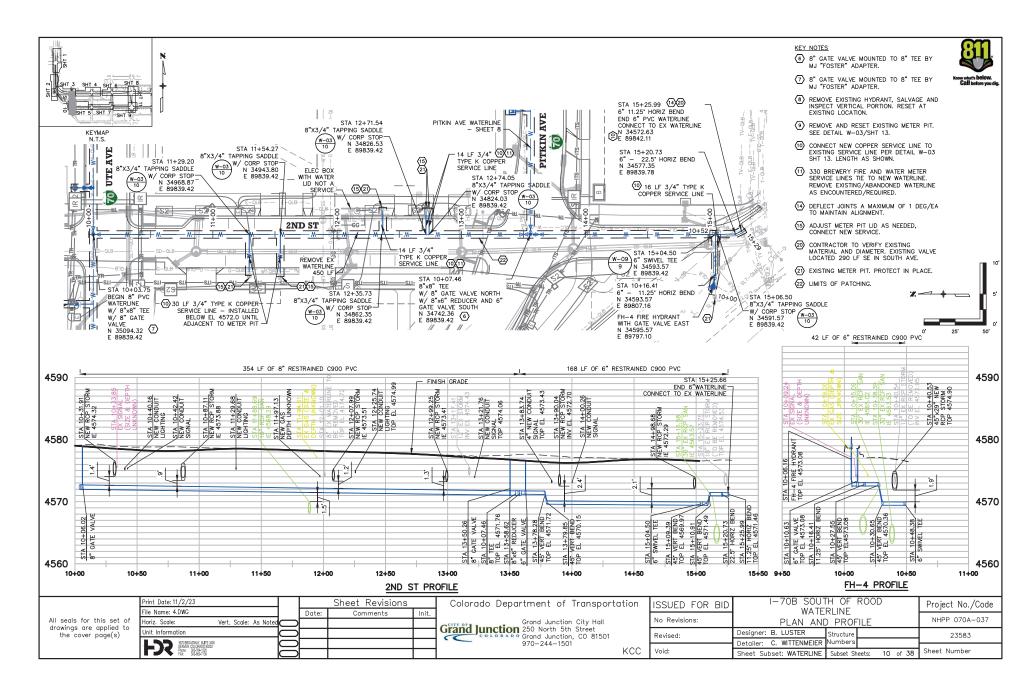

GENERAL NOTES:

- LEXISTING SEWERS, WATER MAINS, GAS MAINS, TELEPHONE CONDUITS, ELECTRIC CABLES, AND OTHER UNDERGOUND LITLITES AND STRUCTURES SHOWN ON THE DRAWINGS ARE DEPICITED AT QUALITY LEVEL B PER ASCE 38-02 UNLESS NOTED OTHERWISE. THESE SUBSURFACE UNILITES AND STRUCTURES ARE SHOWN ONLY TO THE EXTENT THAT SUCH INFORMATION HAS BEEN MADE AVAILABLE TO RD DISCOVERED BY THE ENGINEER. IT IS EXPECTED THAT THERE MAY BE DISCREPANCIES AND ONLY TO THE EXTENT THAT SUCH INFORMATION HAS BEEN MADE AVAILABLE TO RD DISCOVERED BY THE ENGINEER. IT IS EXPECTED THAT THERE MAY BE DISCREPANCIES AND ONLY TO THE LOCATION AND QUANTITES OF BURIED UTLITES AND STRUCTURES SHOWN. THIS INFORMATION ES SHOWN FOR THE CONVENIENCE OF THE CONTRACTOR BUT IS NOT GUARANTEED TO BE COMPLETE AND ALL RESPONSIBILITY OF THE ACCURACY AND COMPLETENESS IS EXPRESSLY DISCLAMED. THE CONTRACTOR SHALL MAKE SUCH INVESTIGATION AS HE THINKS INCESSARY TO VERIFY ITS CORRECTNESS AND COMPLETENESS. THE CONTRACTOR SHALL RELD LOCATE AND PROTECT, AHEAD OF CONSTRUCTION ACTIVES, ALL UNDERGROUND UTLITES AND STRUCTURES OTHAT THEY WILL NOT BE ACCIDENTALLY UT OR DAMAGED BY CONSTRUCTION OPERATIONS.
- ALL MATERIALS AND WORKMANSHIP SHALL BE SUBJECT TO INSPECTION BY THE CITY. THE CITY RESERVES THE RIGHT TO ACCEPT OR REJECT ANY MATERIALS AND WORKMANSHIP THAT DOES NOT CONFORM TO THE CITY STANDARDS AND SPECIFICATIONS.
- 3. THE CONTRACTOR SHALL HAVE ONE SIGNED COPY OF THE DRAWINGS (APPROVED BY THE CITY OF GRAND JUNCTION), ONE COPY OF ANY APPROPRIATE STANDARDS AND SPECIFICATIONS, AND A COPY OF ALL PERMITS NEEDED AT THE JOB SITE AT ALL TIMES.
- 4. EXISTING CITY OF GRAND JUNCTION OWNED VALVES SHALL ONLY BE OPERATED BY CITY OF GRAND JUNCTION PERSONNEL.
- 5. THE CONTRACTOR SHALL:
 - THE CONTRACTOR STALL: NOTIFY THE CITY'S PROJECT MANAGER AND THE ENGINEER AT LEAST 7 DAYS IN ADVANCE TO SHUT DOWN ANY PORTION OF THE EXISTING WATER SYSTEM. NOTIFY THE RESIDENT PROJECT REPRESENTATIVE AT LEAST 48 HOURS IN ADVANCE TO REQUEST FIELD OBSERVATION OR INSPECTIONS. NOTIFY THE CITY OF GRAND JUNCTION IMMEDIATELY OF EMERGENCIES SUCH AS LINE

 - BREAKS
- 6. THE CONTRACTOR SHALL BE RESPONSIBLE FOR REMOVING ANY GROUNDWATER ENCOUNTERED DURING CONSTRUCTION OF THIS PROJECT. GROUNDWATER SHALL BE PUMPED, PIPED, REMOVED, AND DISPOSED IN A MANNER WHICH DOES NOT CAUSE FLOODING. EROSION, OR TURBIDITY THAT MAY EFFECT DOWNSTREAM USERS. NO CONCRETE SHALL BE PLACED WHIFEE GROUNDWATER IS VISIELE OR UNTIL THE GROUNDWATER TABLE HAS BEEN LOWERED DURING THE PROPOSED IMPROVEMENTS. ANY UNSTABLE AREAS AS A RESULT OF GROUNDWATER TO SHALL BE STABILIZED AS AGREED UPON BY THE CONTRACTOR, THE CITY OF GRAND JUNCTION, AND HDR AT THE THE OF OCCURRENCE. A PERMIT IS REQUIRED FROM THE WATER MOLATIVE CONTRUCTION DEVALTERING DRAINAGE. CONSTRUCTION DEWATERING DRAINAGE.
- 7. CONTRACTOR TO MAINTAIN RECORD DRAWINGS OF AS-CONSTRUCTED LOCATION OF ALL VALVES, FITTINGS, AND CONNECTIONS TO EXISTING SYSTEM PIPES. RECORD NORTHING AND EASTING COORDINATES OF INSTALLED LOCATIONS.
- 8. THE CONTRACTOR SHALL MAINTAIN WATER SERVICE TO EXISTING SERVICE LOCATIONS AT ALL TIMES EXCEPT FOR SHORT DURATION OUTAGES DUE TO TIE-OVERS TO THE NEWLY INSTALLED WATER LINE
- 9. WATER SERVICE LOCATIONS TO BE IDENTIFIED BY STAMPED "W" IN THE REPLACED CURBFACE.

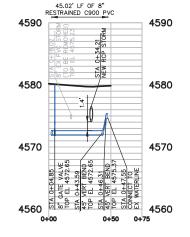



_ L												
- F		Print Date: 11/2/23				Sheet Revisions		Colorado Department of Transporta	ition	ISSUED FOR BID	I-70B SOUTH OF ROOD	Project No./Code
		File Name: 11.DWG		D	ate:	Comments	Init.				WATERLINE NOTES/DETAIL	· · · ·
	All seals for this set of	Horiz. Scale:	Vert. Scale: As Noted					Grand Junction City Hall		No Revisions:		NHPP 070A-037
	drawings are applied to the cover page(s)	Unit Information						Grand Junction 250 North 5th Street Grand Junction, CO 81501		Revised:	Designer: B. LUSTER Structure	23583
		LND ISTO BROADWAY, SLITE 340	k					970-244-1501			Detailer: C. WITTENMEIER Numbers	
								7	KCC	Void:	Sheet Subset: WATERLINE Subset Sheets: 11 of 38	Sheet Number






Sheet Number

12 of 38


Sheet Subset: WATERLINE Subset Sheets:

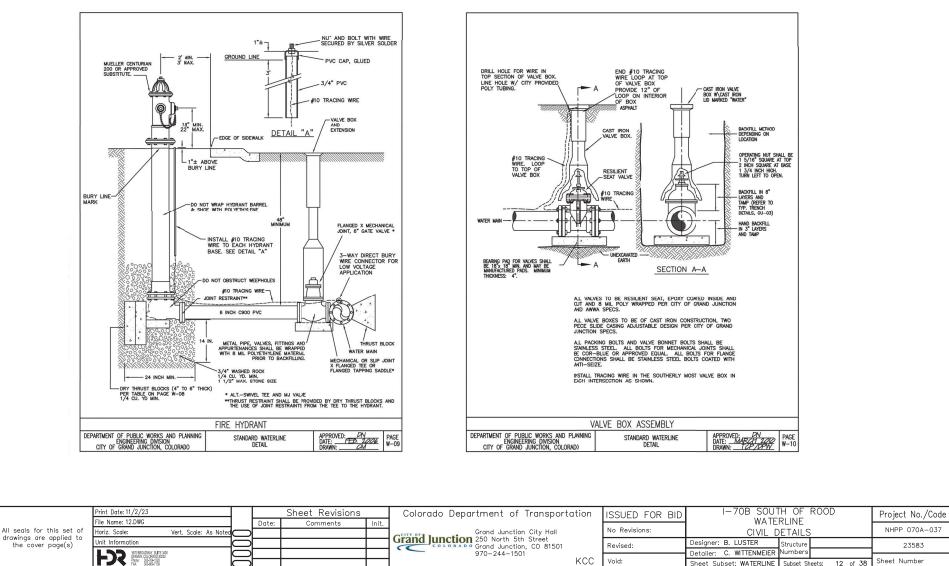


KCC

Void:



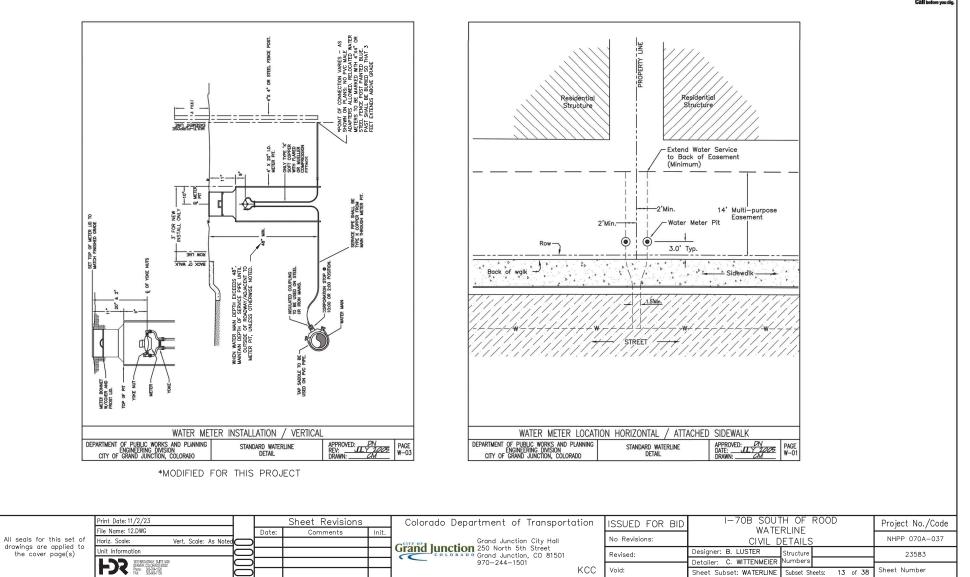




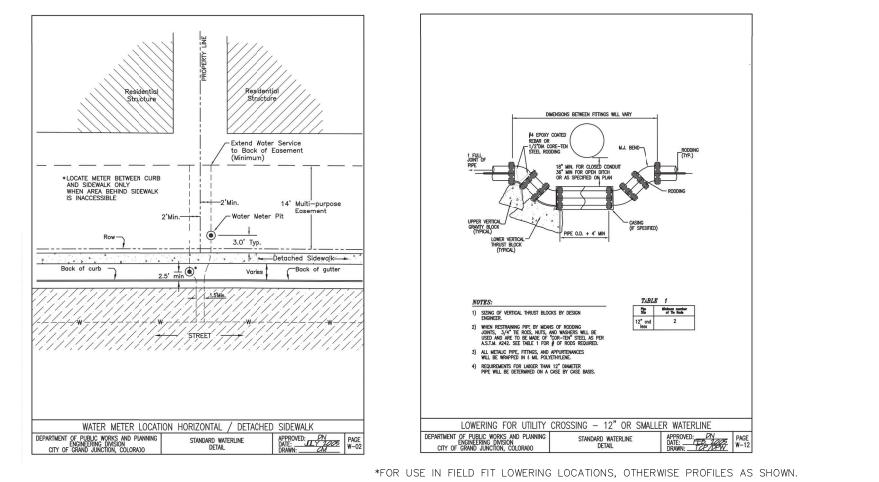



	Print Date: 11/2/23 File Name: 12.DWG	-		Sheet Revisions		Colorado Department of Transporta	ition	ISSUED FOR BID	I-70B SOUTH OF ROOD WATERLINE	Project No./Code
All seals for this set of drawings are applied to	Horiz. Scale: Vert. Scale: As Note		Date:	Comments	Init.	Grand Junction City Hall Grand Junction 250 North 5th Street		No Revisions:	CIVIL DETAILS	NHPP 070A-037
the cover page(s)	Unit Information	Þ				Grand Junction, CO 81501 970-244-1501		Revised:	Designer: B. LUSTER Structure Detailer: C. WITTENMEIER Numbers	23583
	HAR NOT BROUTINALY, SUFE SAID DENNER COLONOORDED DENNER COLONOORDED FAX: SUS-BACFTSS					970-244-1301	KCC	Void:	Sheet Subset: WATERLINE Subset Sheets: 14 of 38	Sheet Number



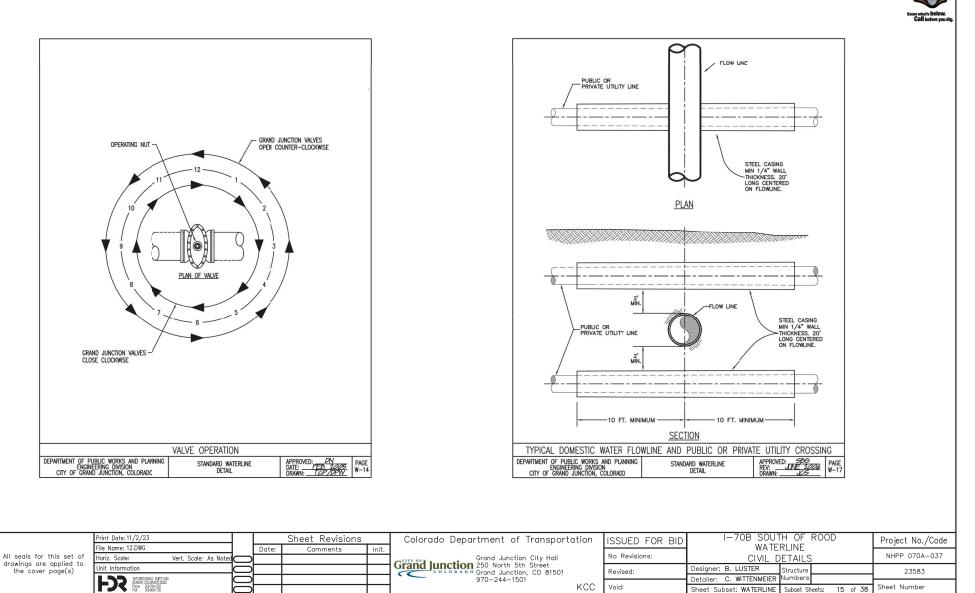



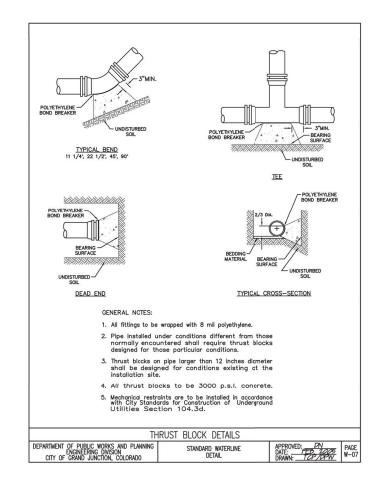


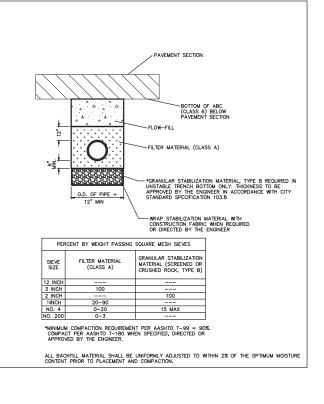



TYPICAL TRENCH DETAIL FOR WATERLINE**


**DETAIL MODIFIED FROM CITY OF GRAND JUNCTION, COLORADO, STANDARD DRAWING "TYPICAL TRENCH DETAIL


		Print Date: 11/2/23			Sheet Revisions		Colorado Department of Transportat	tion	ISSUED FOR BID	I-70B SOUTH OF ROOD	Project No./Code
All se		File Name: 12.DWG Horiz. Scale:	Vert. Scale: As Noted	Date	e: Comments	Init.	Grand Junction City Hall		No Revisions:	WATERLINE CIVIL DETAILS	NHPP 070A-037
drawir	nas are applied to	Unit Information	Vert. Scule. As Noted	≝⊢		+	Grand Junction 250 North 5th Street Grand Junction, CO 81501		Revised:	Designer: B. LUSTER Structure	23583
	0 00101 page(0)	HTOBROADWAY SUITE SKO	c	5			970-244-1501	KOO		Detailer: C. WITTENMEIER Numbers	
		FAC: 30-66-102		\square				KCC	Void:	Sheet Subset: WATERLINE Subset Sheets: 16 of 38	Sheet Number

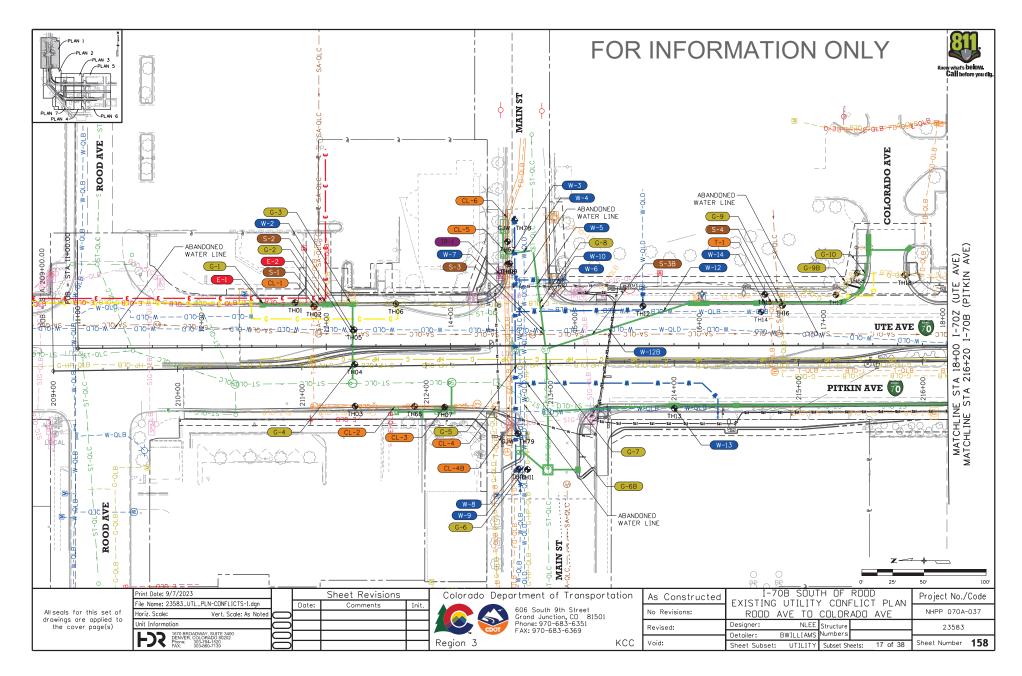


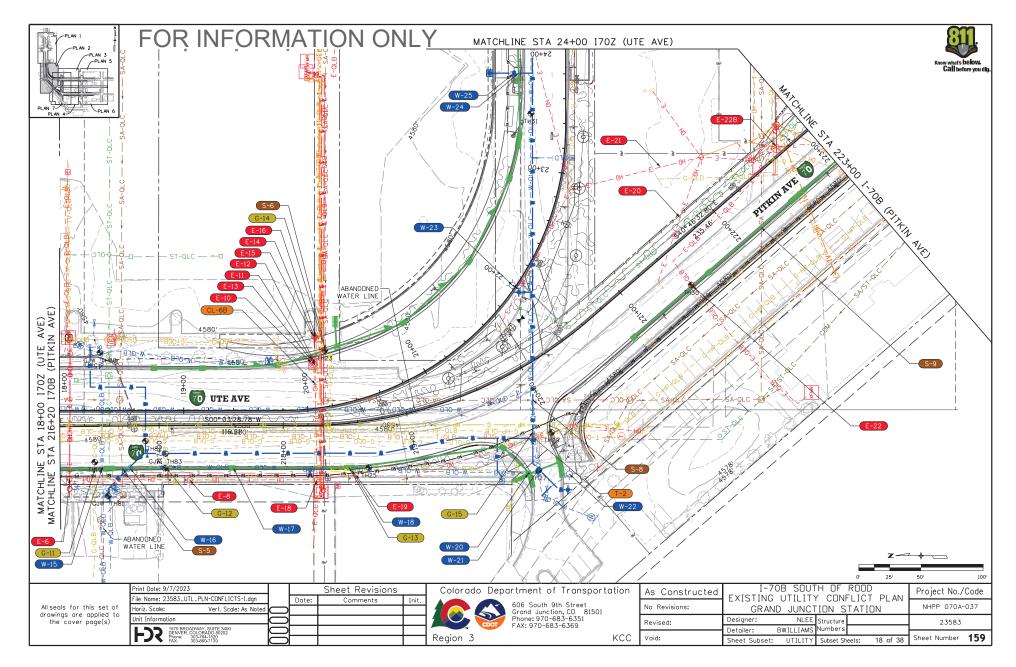


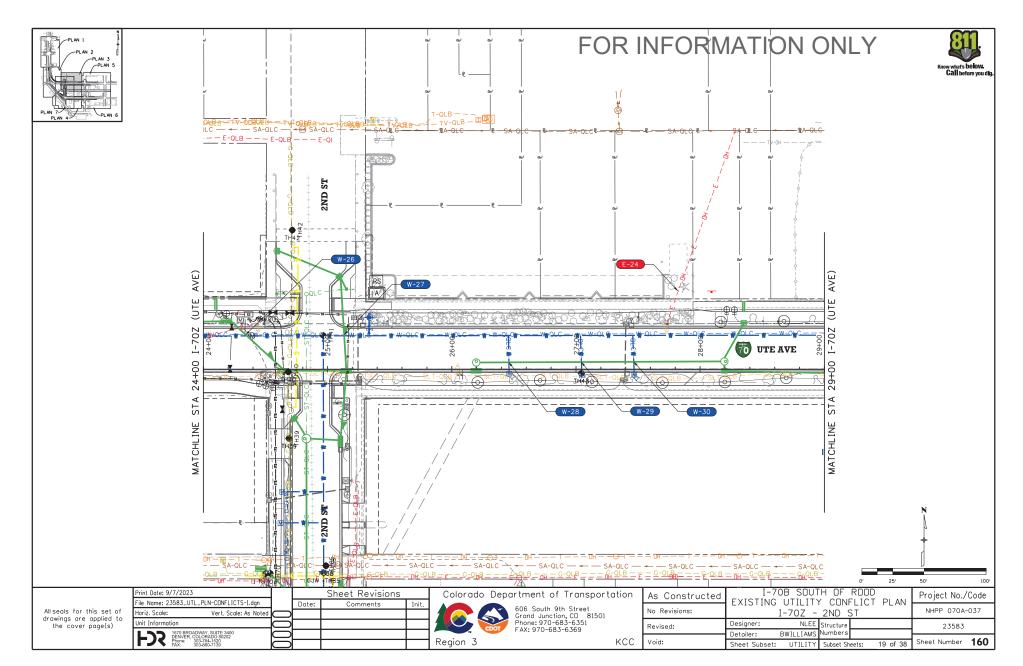

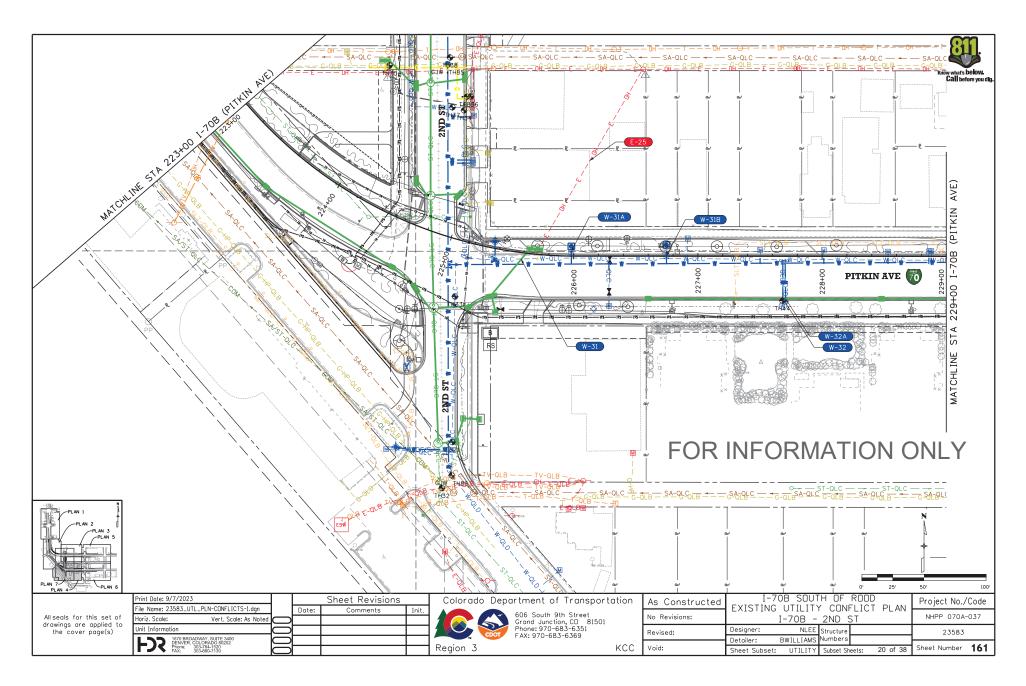

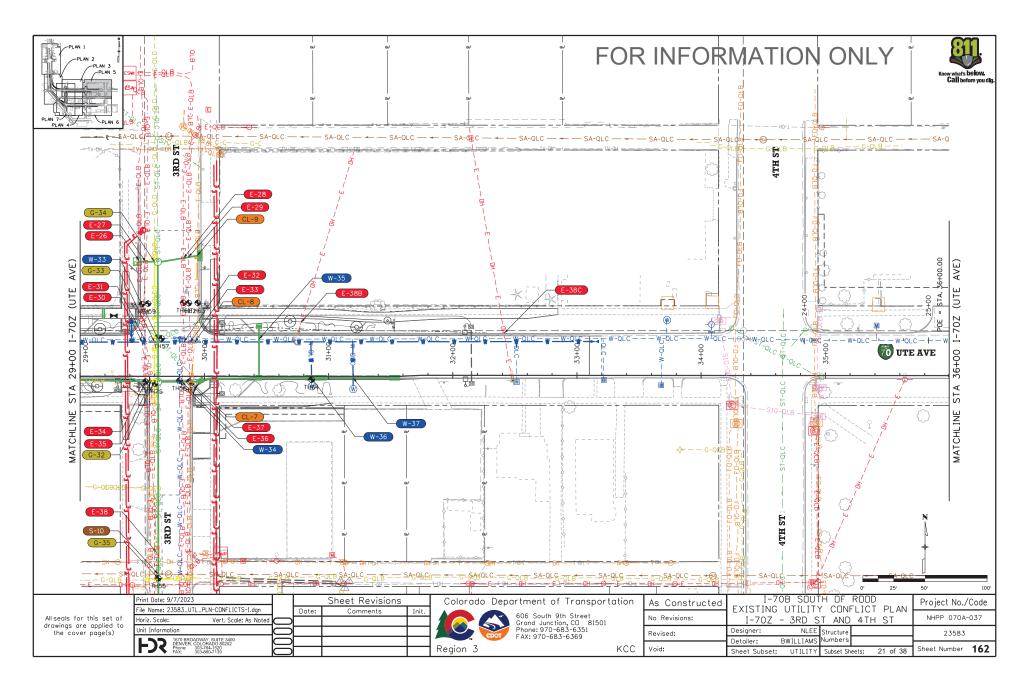

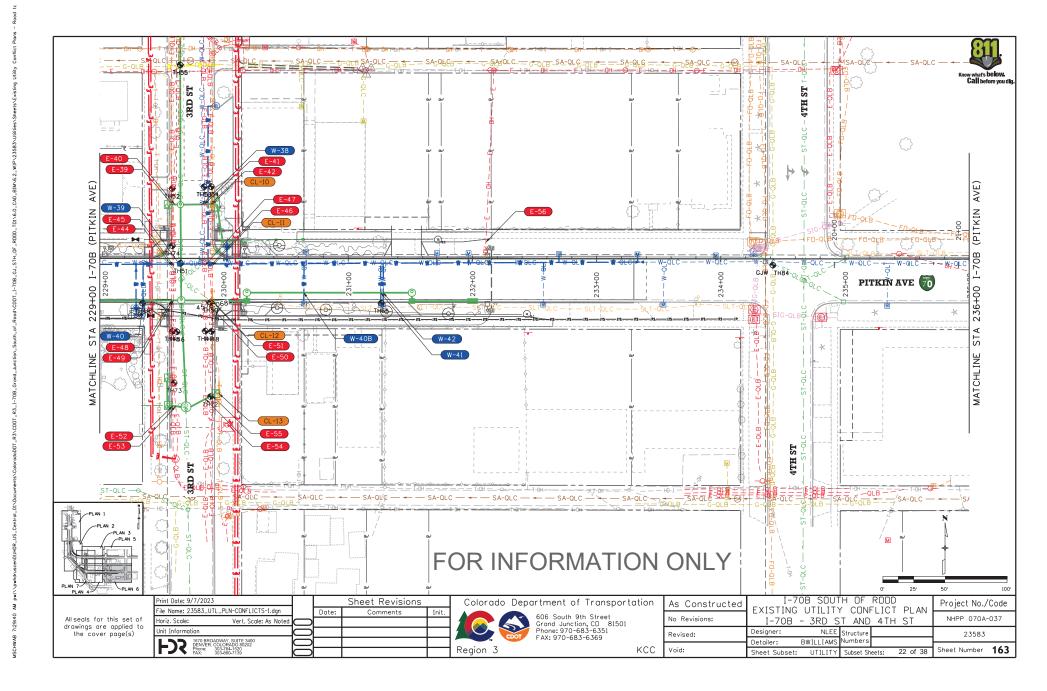

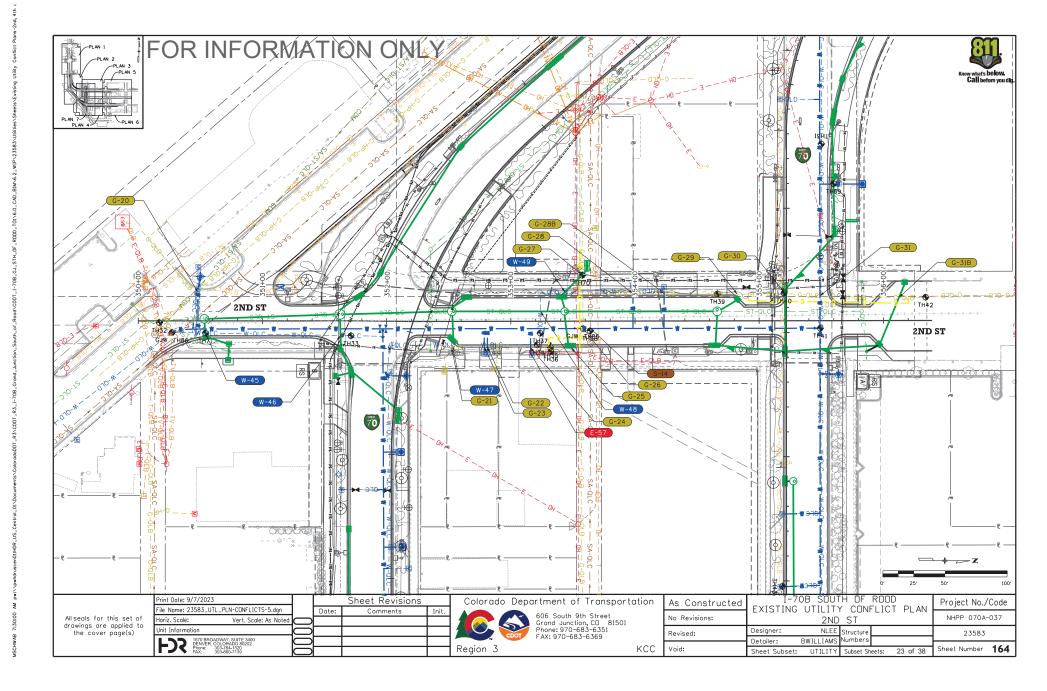

| 1#1 | | | |

 |

 |
 | | Halling Dat | | |
 | | | 0 | Bist Data 1 | 0 | Deeeler
 | - |
|----------|---|--|---
--
--
--
--
--
--|---
---	---	---	--
--	---	---	---
	Connic	t Locatio	

 |

 |
 | | Utility Data | | | Utility El
 | evation | Conflict | Cor
Elevation | nflict Data | Conflict | Est.
 | n |
| | Alignment Name | Station | Distance
Lt. / Rt. | Test
Hole No.

 | Size

 | Material
 | Northing | Easting | Surace
Elevation | Measure
Down | Тор
 | Bottom | Тор | Bottom | Detaled Conflict Description | Proposed Mitigation / Action | Resolution
 | Current status |
| 6-1 | I-70Z (Ute) | 12+31 | 35' LT | 1A

 | 2"

 | PLASTIC
 | 89487.42 | 36000.38 | 4580.47' | 3' | 4577.47'
 | 4577.30' | | | Inletlocated on LP gas line
(gas line parallel to
curb/gutter) | Relocation by Xcel |
 | |
| G-2 | I-70Z (Ute) | 13+00 | 36' LT | 1A

 | 2"

 | PLASTIC
 | 89487.42 | 36000.38 | 4580.47' | 3' | 4577.47'
 | 4577.30' | | | Inlet lccated on LP gas line (gas
line parallel to curb/gutter) | Relocation by Xcel |
 | |
| 6-3 | I-70Z (Ute) | 13+21 | 36' LT | 6

 | 2"

 | PLASTIC
 | 89486.34 | 35919.35 | 4580.70' | 3.33' | 4577.37'
 | 4577.20' | | | Inlet lccated on LP gas line (gas
line parallel to curb/gutter) | Relocation by Xcel |
 | |
| G-4 | I-7(B (Pitkin) | 211+41 | 1' LT | 4

 | 12"

 | STEEL
 | 89437.62 | 35952.42 | 4579.98' | 2.50' | 4577.48'
 | 4576.48' | | | Prcposed storm crosses
existing IP gas line | Relocation by Xcel |
 | |
| 6-5 | i- ሊዜ (Pitkin) | 212+73 | 1'RI |

 |

 |
 | | | | |
 | | | | Prcposed storm crosses
existing LP gas line | Relocation by Xcel |
 | |
| 6-6 | I-7(B (Pitkin) | 212+80 | 83' RT | 11

 | 10"

 | STEEL
 | 89352.80 | 35813.47 | 4579.76 | 2.92' | 4576.84'
 | 4575.01' | | | Prcposed storm crosses
existing IP gas line | Protect in Place |
 | |
| G-68 | I-7(B (Pitkin) | 212+81 | 16' RT |

 |

 |
 | | | | |
 | | | | Proposed water service
crosses IP gas line | Protect in Place |
 | |
| 6-7 | I-7(B (Pitkin) | 212+97 | 1' RT |

 |

 |
 | | | | |
 | | | | Proposed storm crosses
existing LP gas line | Relocation by Xcel |
 | |
| 6-8 | I-70Z (Ute) | 14+72 | 34' LT |

 |

 |
 | | | | |
 | | | | Proposed storm crosses
existing LP gas line | Protect in Place |
 | |
| 6-9 | I-70Z (Ute) | 16+67 | 33' LT | 16

 | 2"

 | STEEL
 | 89484.51 | 35608.07 | 4581.48 | 1.92' | 4579.56'
 | 4579.40' | | | Proposed storm crosses
existing LP gas line | Protect in Place |
 | |
| G-9B | I-70Z (Ute) | 17+18 | 52" LT | 68

 | 2"

 | PLASTIC
 | 89511.82 | 35541.45 | 4580.72' | 2.75' | 4576.97'
 | 4577.80' | | | Proposed storm inlet on top of
existing LP gas line | Relocation by Xcel |
 | |
| G-10 | I-70Z (Ute) | 17+34 | 58' LT | 68

 | 2"

 | PLASTIC
 | 89511.82 | 35541.45 | 4580.72' | 2.75' | 4576.97'
 | 4577.80' | | | Prcposed storm crosses
existing LP gas line | Relocation by Xcel |
 | |
| 6-11 | I-7(B (Pitkin) | 216+48 | 27' RT | 19

 | 2"

 | STEEL
 | 89410.68 | 35447.06 | 4580.27 | 2.50' | 4577.77'
 | 4577.60' | | | Prcposed storm crosses
existing LP gas line | Protect in Place |
 | |
| 6-12 | I-7(B (Pitkin) | 217+05 | 34' RT | 21B

 | 2"

 | STEEL
 | 89405.65 | 35390.33 | 4580.10' | 3.33' | 4576.77'
 | 4576.6' | | | existing LP gas line | Protect in Place |
 | |
| 6-13 | I-7(B (Pitkin) | 218+50 | 36' RT | 25

 | 2"

 | PLASTIC
 | 89405.91 | 35226.35 | 4579.62' | 4.58' | 4575.04'
 | 4574.87' | | | on existing LP gas line | Relocation by Xcel |
 | |
| G-14 | I-70Z (Ute) | 20+23 | 44' LT | 23

 | 2"

 | PLASTIC
 | 89500.38 | 35261.76 | 4581.48' | 2.67' | 4578.81'
 | 4573.65' | | | crostes existing LP gas line | Relocation by Xcel |
 | |
| 6-15 | I-7(B (Pitkin) | 219+84 | 50' RT | 29

 | 12"

 | STEEL
 | 89434.11 | 35079.24 | 4579.22' | 3.33' | 4575.89'
 | 4574.89' | | | existing IP gas line | |
 | |
| 110 1 | | | *************************************** |

 |

 | Cha-t
 | Deviair- | | N . I | Daa |
 | (T | | | | |
 | |
| of
to | | _UTL_PLN-M | | Noted

 |

 |
 | | Init. | | | 06 South 9
irand Junct
'hone: 970-1
 | 9th Street
ion, CD 8
583-6351 | | No | Revisions: | ING UTILITY CONFLIC |
 | Project No./
NHPP 070A
23583 |
| | | BROADWAY, SU
ER, COLORADO
303-764-153 | TE 3400
80202
20 | È

 | $\exists \Box$

 |
 | | | | GDOI F | AX: 970-68
 | 3-6369 | IZ. | | Detaile | r: BWILLIAMS Numbers |
 | |
| c | ¹ ² 615 614 613 611 610 698 69 68 67 668 66 63 63 62 63 62 63 63 63 63 63 63 63 63 63 63 63 63 63 63 63 63 63 63 64 63 63 63 63 64 63 63 63 63 64 63 63 63 63 63 63 63 63 64 63 63 63 63 63 63 63 63 63 63 64 63 63 63 63 63 63 63 63 63 64 63 63 63 63 63 63 63 63 63 63 63 63 63 63 64 63 63 63 64 64 63 63 63 64 | Image: Constraint of the sector of | Image: Constraint of the section of the sec | Interface Interface <thinterface< th=""> <thinterface< th=""> <th< td=""><td>Interface Interface Interface Interface Interface Image: Interface <t< td=""><td>Image: Control (Control (Contro) (Contro) (Control (Contro) (Control (Contro) (Contro) (Contro)</td><td>Image: Section of the sectin of the section of the</td><td>Image: Control Contrect Control Control Control Control Control</td><td>Image: Sector index ind</td><td>Image: Control of the large state of the large</td><td>Image: Control of the field of th</td><td>Image: Control in the state of the</td><td>Image: Control of the contr</td><td>Image: Control of the barding of the control of th</td><td>Image: constraint of the state of</td><td>$\begin{array}{ c c c c c c c c c c c c c c c c c c c$</td><td>$\begin{vmatrix} 1 + 1 + 1 + 1 \\ 1 + 1 + 1 \\ 2 + 1 + 1$</td><td>Image: Control in the standard of the s</td></t<></td></th<></thinterface<></thinterface<> | Interface Interface Interface Interface Interface Image: Interface <t< td=""><td>Image: Control (Control (Contro) (Contro) (Control (Contro) (Control (Contro) (Contro) (Contro)</td><td>Image: Section of the sectin of the section of the</td><td>Image: Control Contrect Control Control Control Control Control</td><td>Image: Sector index ind</td><td>Image: Control of the large state of the large</td><td>Image: Control of the field of th</td><td>Image: Control in the state of the</td><td>Image: Control of the contr</td><td>Image: Control of the barding of the control of th</td><td>Image: constraint of the state of</td><td>$\begin{array}{ c c c c c c c c c c c c c c c c c c c$</td><td>$\begin{vmatrix} 1 + 1 + 1 + 1 \\ 1 + 1 + 1 \\ 2 + 1 + 1$</td><td>Image: Control in the standard of the s</td></t<> | Image: Control (Control (Contro) (Contro) (Control (Contro) (Control (Contro) (Contro) (Contro) | Image: Section of the sectin of the section of the | Image: Control Contrect Control Control Control Control Control | Image: Sector index ind | Image: Control of the large state of the large | Image: Control of the field of th | Image: Control in the state of the | Image: Control of the contr | Image: Control of the barding of the control of th | Image: constraint of the state of | $ \begin{array}{ c c c c c c c c c c c c c c c c c c c$ | $ \begin{vmatrix} 1 + 1 + 1 + 1 \\ 1 + 1 + 1 \\ 2 + 1 + 1$ | Image: Control in the standard of the s |

	Т										I-70B	- Utility	Conflict	Matrix					
UTILITY OWNER	#	Conflic	t Locatio	on					Utility Data							nflict Data	Conflict	Resolutio	n
OTILITY OWNER	₽	Aligment Name	Station	Distance Lt. / Rt.	Test Hole No.	Size	Material	Northing	Easting	Surace Elevation	Measure Down	Utility E Top	Bottom	Conflict Top	Elevation Bottom	Detaled Conflict Description	Proposed Mitigation / Action	Est. Resolution	Current status
	G-20	2nd St	350+49	24' LT								TOP				Proposed water service crosses existing IP gas line	Protect in Place	Date	
	6-21	2nd St	352+53	21' RT												Proposed inlet adjacent to existing LP gas line	Protect in Place		
	G-22	2nd St	352+79	44												Proposed water service crosses existing LP gas line	Protect in Place		
	6-23	2nd St	352+81	21' RT												Proposed water service crosses existing LP gas line	Protect in Place		
	G-24	2nd St	352+83	21' RI												Proposed water service crosses existing LP gas line	Protect in Place		
	6-25	2nd St	353+48	22' RT	35	2"	STEEL	899854.70	34877.45	4575.98'	2.17'	4575.98'	4575.82'			Proposed storm inlet on top of existing LP gas line	Relocation by Xcel		
	G-26	2nd St	353+58	6' RT	85	3"	STEEL	89839.42	34903.49	4578.14	3.17'	4574.97	4574.72			Proposed storm crosses existing LP gas line	Relocation by Xcel		
	6-27	2nd St	353+58	37' LT	70	3"	STEEL	89839.42	34902.80	4577.70	3.0'	4574.70	4574.45			Proposed storm line crosses existing LP gas line	Relocation by Xcel		
GAS	G-28	2nd St	353+98	22' LT												Proposed water service crosses existing LP gas line	Protect in Place		
	G-28B	2nd St	354+23	22' LT												Proposed water service crosses existing LP gas line	Protect in Place		
	G-29	2nd St	354+82	20' LT	39	1"	STEEL	89811.58	35011.77	4578.27'	3.75'	4574.52'	4574.44'			Proposed storm inlet adjcent ofexisting LP gas line.	Protect in Place		
	G-30	2nd St	355+20	22' LT	40A	1"	STEEL	89811.14	35065.33	4581.48'	3.83	4577.65	4577.56			Proposed inlet on top of existing LP gas line	Relocation by Xcel		
	6-31	2nd St	355+49	20' LT												Proposed water line crosses existing LP gas line	Relocation by Xcel		
	G-31B	2nd St	356+13	19' LT												Proposed storm crosses existing LP gas line	Relocation by Xcel		
	G-32	I-70Z (Ute)	29+50	4' RT												Proposed storm crosses existing LP gas line. Gas line unable to be located during potholing.	Relocation by Xcel		
	G-33	I-70Z (Ute)	29+60	28' LT												Proposed water crosses existing LP gas line. Gas line unable to be located during notbeline	Relocation by Xcel		
NOTE: 1. NUMBER		OF CONFLICTS	IS NONCO	INTINUOUS												FOR	INFORMA	ŦЮ	N ONL
		Print Date: 9/7/2					Sheet	Revisions	;	Colorado	Depar	tment o	f Trans	portati	on A	s Constructed	I-70B SOUTH OF RO		Project No./Cod
All seals for this set	of	File Name: 23583	_UTL_PLN-N			Date		mments	Init.		с	606 South	9th Street			Revisions:	TING UTILITY CONFLIC		IX NHPP 070A-037
trawings are applied	to	Horiz. Scale: Unit Information	Ve	ert. Scole: As	Noted	\cong			1			Grand Junci Phone: 970-	ion. CD 8	1501			NLEE Structure		
the cover page(s)			BROADWAY, SU	ITE 3400 0 80202 20	—ķ	\equiv						AX: 970-68		12		Detail	er: BWILLIAMS Numbers		23583
		Phone FAX:	303-860-71	20 39		\square			Re	egion 3				K	CC Vo	bid: Sheet	Subset: UTILITY Subset Sheets	: 25 of 3	Sheet Number 16

											I-70B	- Utility (Conflict	Matrix					
UTILITY OWNER	#	Conflic	t Locatio	on					Utility Data							nflict Data	Conflict F		1
OTILITY OWNER		Alignment Name	Station	Distance	Test	Size	Material	Northing	Easting	Surface	Measure	Utility E	evation	Conflict	Elevation	Detaled Conflict Description	Proposed Mitigation / Action	Est. Resolution	Current status
	G-34	I-70Z (Ute)	29+58	Lt. / Rt. 92' LT	Hole No.	5126	Materia	Northing	Lasting	Elevation	Down	Тор	Bottom	Тор	Bottom	Inlet lccated less than two feet from existing LP gas line. Gas line unable to be located	Relocation by Xcel	Date	
GAS	G-35	I-70Z (Ute)	29+63	163' RT	55	2"	STEEL	90305.50	34904.17	4578.11'	3.58'	4574.53'	4574.36'			during potholing. Prcposed storm crosses existing LP gas line	Relocation by Xcel		
	CL-1	I-70Z (Ute)	12+90	34' LT	2	12"W x 16"H	CONCRETE	89484.21	35985.36	4580.43'	2.67'	4577.76'	4575.43'			Prcposed storm crosses exis:ing concrete encased telephone line	Protect in place		
	CL-2	I-7(B (Pitkin)	211+75	33' RT	66	10"	CONCRETE	89403.75	35904.22	4579.84'	1.67'	4578.17'	4577.34'			Proposed storm inlet adjacent to existing concrete encased telephone duct.	Protect in Place		
	CL-3	I-7(B (Pitkin)	212+15	33' RT	7	24" x 4"H	CONCRETE	89403.08	35880.10	4580.86'	1.75'	4579.11'	4573.78'			Proposed storm inlet adjacent to existing concrete encased telephone duct.	Protect in Place		
	CL-4	I-7(B (Pitkin)	212+56	33' RT												Fiber manhole in conflict with proposed gutter.	Protect in Place		
	CL-4B	I-7(B (Pitkin)	212+61	58' RT												Proposed signal pole adjacent to fiber vault.	Contractor to vacuum excavate signal caisson.		
	CL-5	I-70Z (Ute)	14+46	65' LT	67	12" DUCT	CONCRETE	89535.99	35829.58	4579.93'	3.17'	4576.76'	4575.76'			Proposed storm inlet adjacent to existing concrete encased telephone duct.	Protect in Place		
TELEPHONE AND FIBER LUMEN	CL-6	I-70Z (Ute)	14+46	104' LT	67	12" DUCT	CONCRETE	89535.99	35829.58	4579.93'	3.17'	4576.76'	4575.76'			Proposed storm inlet adjacent to existing concrete encased telephone duct.	Protect in Place		
(CENTURYLINK)	CL-6B	I-70Z (Ute)	20+08	20' LT												OH tel∋phone line attached to Xcelpoles to be removed.	Relocation by Lumen		
	CL-7	I-70Z (Ute)	29+90	4' RT												Prcposed storm crosses existing telephone line	Relocaticn by Lumen during CDOT construction		
	CL-8	I-70Z (Ute)	29+93	29' LT	63	2"	PLASTIC	90337.55	35125.83	4581.48'	3.42'	4578.06'	4577.90'			Proposed water line crosses existing telephone line	Protect in Place		
	CL-9	I-70Z (Ute)	29+95	97' LT	63	2"	PLASTIC	90337.55	35125.83	4581.48'	3.42'	4578.06'	4577.90'			Proposed inlet conflicts with existing telephone line	Relocation by Lumen during CDOT construction		
	CL-10	I-7(B (Pitkin)	229+90	44' LT	54A	2"	PLASTIC	90330.40	34806.05	4578.67'	3.17'	4575.50'	4575.34'			Propcsed inlet conflicts with existing telephone line	Relocation by Lumen during CDOT construction		
	CL-11	I-7(B (Pitkin)	229+90	4' RT												Prop₀sed water line crosses existing telephone line	Protect in Place		
	CL-12	I-7(B (Pitkin)	229+91	34' RT	50B	3"	STEEL	90329.67	34712.93	4578.67'	4.58'	4574.09'	4573.84'			Prcposed storm crosses existing telephone line	Relocation by Lumen during CDOT construction		
NOTE: 1. NUMBER	RING	OF CONFLICTS	IS NONCO	INTINUOUS												FOR	INFORMA	TIO	
All seals for this set drawings are applied the cover page(s)	of to	Print Date: 9/7/2 File Name: 23583 Horiz. Scale: Unit Information	023 _UTL_PLN-M Ve	MATRIX-1.dgn ert. Scale: As				Revisions	S Init.		SS §	tment o 06 South S rand Junct hone: 970-68	9th Street ion, CD 8 683-6351		No	Revisions: vised: Desi	I-70B SOUTH OF RO STING UTILITY CONFLIC SHEET 3 gner: NLEE Structure		IX Project No./Code NHPP 070A-037 23583
		HOR 1670 DENV Phone FAX:	BROADWAY, SU 'ER, COLORADO : 303-764-15 303-860-71	11E 3400) 80202 20 39					Re	gion 3				K	CC Vo	id: Deto	iler: BWILLIAMS Numbers et Subset: UTILITY Subset Sheets:	26 of 3	8 Sheet Number 167

											I-70B	- Utility (Conflict	Matrix					
UTILITY OWNER	#	Conflic	t Locatio	<u>n</u>					Utility Data						Col	nflict Data	Conflict I		n
OTILITY OWNER	 	Alignment Name	Station	Distance	Test	Size	Material	Northing	Easting	Surace	Measure	Utility E			Elevation	Detaled Conflict Description	Proposed Mitigation / Action	Est. Resolution	Current status
TELEPHONE AND FIBER LUMEN (CENTURYLINK)	CL-13	I-7(B (Pitkin)	229+96	Lt. / Rt. 109' RT	Hole No. 48	2"	PLASTIC	90330.42	34689.51	Elevation 4578.67'	Down 3.58'	Top 4575.09'	Bottom 4574.92'	Тор	Bottom	Proposed inlet within 2 ft of existing telephone line	Relocation by Lumen during CDOT construction	Date	
UNKNOWN	T-1	I-70Z (Ute)	16+70	33' LT												Prcposed storm crosses existing unidentified telephone line	Protect in Place		
TELEPHONE	T-2	I-7(B (Pitkin)	219+83	54' RT												Prcposed water crosses existing unidentified telephone line	Protect in Place		
	E-1	I-70Z (Ute)	12+49	35' LT												Inlet located on elec line (elec line parallel to curb/gutter)	Relocation by Xcel		
	E-2	I-70Z (Ute)	12+96	36' LT												Inlet located adjacent to elec line (elec line parallel to curb/gutter)	Relocation by Xcel		
	6-6	I-7(B (Pitkin)	216+28	42' RT												Utility Pole in conflict with proposed sidewalk	Relocation by Xcel		
	E-8	I-7(B (Pitkin)	217+25	44' RT												Utility Pole in conflict with proposed sidewalk	Remove by Xcel		
	E-10	I-70Z (Ute)	20+08	37' LT												Ground Test in conflict with proposed pavement	Remove by Xcel		
	E-11	I-70Z (Ute)	20+08	38' LT												Ground Test in conflict with proposed pavement	Remove by Xcel		
ELECTRIC	E-12	I-70Z (Ute)	20+09	36' LT												Electric Vault in conflict proposed pavement	Remove by Xcel		
	E-13	I-70Z (Ute)	20+11	35" LT												Utility Pole in conflict with proposed pavement	Remove by Xcel		
	E-14	I-70Z (Ute)	20+14	57' LT												Utility Pole in conflict with proposed sidewalk	Remove by Xcel		
	E-15	I-70Z (Ute)	20+15	56' LT												Ground Test in conflict with proposed pavement	Remove by Xcel		
	E-16	I-70Z (Ute)	20+16	57' LT												Ground Test in conflict with proposed pavement	Remove by Xcel		
	E-18	I-7(B (Pitkin)	218+26	44' RT												Utility Pole in conflict with proposed sidewalk	Relocation by Xcel		
	E-19	I-7(B (Pitkin)	218+54	42' RT												Utility Pole in conflict with proposed sidewalk	Remove by Xcel		
NOTE: 1. NUMBER	RING			NTINUOUS											<u>_</u>	FOR	INFORMA	<u>TIC</u>	<u>)n ONLY</u>
		Print Date: 9/7/2			$-\top$	_		Revisions		Colorado	Depar	tment o	f Trans	portati	on As	S Constructed	I-70B SOUTH OF RO STING UTILITY CONFLIC		Project No./Code
All seals for this set drawings are applied	of	File Name: 23583 Horiz. Scale:		ATRIX-1.dgn rt. Scale: As	Noted		: Co	mments	Init.		G	06 South 9 Frand Junct	ion, CD 8	1501	No	Revisions:	SHEET 4	, WAT	NHPP 070A-037
the cover page(s))	Unit Information	BROADWAY, SUI ER, COLORADO 303-764-152 303-860-713	TE 3400 80202 19					Re	egion 3	💛 Р	hone: 970- AX: 970-68	683-6351		Re CC Vo	vised: Desig id: Shee		: 27 of	23583 38 Sheet Number 168

											I-70B	- Utility (Conflict	Matrix					
	#	Conflic	t Locatio	n					Utility Data						Col	nflict Data	Conflict	Resolutio	n
UTILITY OWNER	#			Distance	Test					Surace	Measure	Utility El	evation	Conflict	Elevation			Est.	
		Alignment Name	Station	Lt. / Rt.	Hole No.	Size	Material	Northing	Easting	Elevation	Down	Тор	Bottom	Тор	Bottom	Detaled Conflict Description	Proposed Mitigation / Action	Resolution Date	Current status
	E-20	l-7(B (Pitkin)	221+83	49' LT												OH electric service to light pole to be removed by Xcel	Remove by Xcel		
	E-21	I-7(B (Pitkin)	221+78	15' LT												OH electric service to light pole to be removed by Xcel	Remove by Xcel		
	E-22	I-7(B (Pitkin)	221+48	38' RT	30	6"	PLASTIC	89552.64	34966.60	4578.77'	6.00'	4572.77'	4572.27'			Prcposed storm crosses existing electric	Protect in place		
	E-22B	I-7(B (Pitkin)	222+61	40' LT												Utility pole to be relocated further from roadway	Relocation by Xcel		
	E-24	I- /UZ (Ute)	227+28	50' LI												OH electric service to light pole to be removed by Xcel	Kemove by Xcel		
	E-25	I-7(B (Pitkin)	225+70	3' LT												OH electric service to light pole to be removed by Xcel	Remove by Xcel		
	E-26	I-70Z (Ute)	29+48	92' LT												Inlet located on elec line (elec line parallel to curb/gutter)	Relocation by Xcel		
ELECTRIC	E-27	I-70Z (Ute)	29+55	92' LT												Proposed storm crosses existing electrical line	Relocation by Xcel		
ELECTRIC	E-28	I-70Z (Ute)	29+83	95' LT												Proposed storm crosses existing electrical line	Relocation by Xcel		
	E-29	I-70Z (Ute)	29+87	95' LT												Proposed storm crosses existing electrical line	Relocation by Xcel		
	E-30	I-70Z (Ute)	29+50	28' LT	58	6"	PVC	90287.08	35124.55	4581.48'	3.83'	4577.65'	4577.15'			Prcposed water crosses existing electrical line	Relocation by Xcel		
	F-31	I-70Z (Ute)	29+55	28' LT	59	6"	PVC	90292.58	35124.83	4581.48'	3.83'	4577.65'	4577.15'			Prcposed water crosses existing electrical line	Relocation by Xcel		
	E-32	I-70Z (Ute)	29+84	29' LT	61	6"	PVC	90325.85	35125.86	4581.48'	4.00'	4577.48'	4575.98'			Prcposed water crosses existing electrical line	Relocation by Xcel		
	E-33	I-70Z (Ute)	29+89	29' LT	62	6"	PVC	90330.37	35125.63	4581.48'	4.00'	4577.48'	4575.98'			Prcposed water crosses existing electrical line	Relocation by Xcel		
	E-34	I-70Z (Ute)	29+53	3' RT	76	6"	PLASTIC	90295.35	35062.50	4579.77'	4.17'	4575.60'	4575.10'			Prcposed storm crosses existing electrical line	Relocation by Xcel		
	E-35	I-70Z (Ute)	29+58	3' RT	76	6"	PLASTIC	90295.35	35062.50	4579.77'	4.17'	4575.60'	4575.10'			Prcposed storm crosses existing electrical line	Relocation by Xcel		

	Print Date: 9/7/2023			eet Revisions		Colorad	lo Dep	artment of Transportation	As Constructed	I-70B SOUTH OF ROOD EXISTING UTILITY CONFLICT		Project No./Code
s for this set of	File Name: 23583_UTL_PLN-MATRIX-1.dgn Horiz. Scale: Vert. Scale: As Noted (\neg	Date:	Comments	Init.			606 South 9th Street Grand Junction, CD 81501	No Revisions:	SHEET 5	MAIRIX	NHPP 070A-037
s are applied to cover page(s)	Unit Information	\equiv					CDOT	Phone: 970-683-6351 FAX: 970-683-6369	Revised:	Designer: NLEE Structure		23583
	HOR 1670 BROADWAY, SUITE 3400 DENVER, COLORADO 80202 Phone: 302-764-1520 FAX: 303-860-7139	\exists				Region 3			Void:	Detailer: BWILLIAMS Numbers Sheet Subset: UTILITY Subset Sheets:	28 of 38	Sheet Number 169

											I-70B	- Utility (Conflict	Matrix					
LITY OWNER	#	Conflic	t Locatio	pn					Utility Data							nflict Data	Conflict	Resolutio	n
		Alignment Name	Station	Distance Lt. / Rt.	Test Hole No.	Size	Material	Northing	Easting	Surace Elevation	Measure Down	Utility El	Bottom	Conflict Top	Elevation Bottom	Detaled Conflict Description	Proposed Mitigation / Action	Est. Resolution Date	Current status
	E-36	I-70Z (Ute)	29+82	4' RT												Prcposed storm crosses existing electrical line	Relocation by Xcel		
	E-37	I-70Z (Ute)	29+88	4' RT	77	4"	PLASTIC	90330.55	35062.61	4579.71'	4.58'	4575.13'	4574.79'			Prcposed storm crosses existing electrical line	Relocation by Xcel		
	E-38	I-70Z (Ute)	29+61	140' RT												Proposed storm is adjacent to ex sting electrical line.	Relocation by Xcel		
	E-38B	I-70Z (Ute)	30+78	35' LT												OH electric service to light pole to be removed by Xcel	Remove by Xcel		
	E-33C	I-70Z (Ute)	32+47	3' RT												OH electric service to light pole to be removed by Xcel	Remove by Xcel		
	E-39	I-7(B (Pitkin)	229+58	43' LT	52	2x 6"	PVC	90298.89	34804.59	4578.50'	3.58'	4574.92'	4574.33'			Proposed storm inlet on top of electric line.	Relocation by Xcel		
	E-40	I-7(B (Pitkin)	229+64	43' LT	52	2x 6"	PVC	90298.89	34804.59	4578.50'	3.58'	4574.92'	4574.33'			Proposed storm manhole over existing electric line.	Relocation by Xcel		
ELECTRIC	E-41	I-7(B (Pitkin)	229+84	43' LT												Proposed storm crosses existing concrete encased electrical line.	Relocation by Xcel		
ELECTRIC	E-42	I-7(B (Pitkin)	229+89	43' LT	54B	16"Hx32"W	CONCRETE	90330.40	34806.05	4578.66'	2.67'	4575.99'	4574.66'			Proposed storm inlet on top of concrete encased electric line.	Relocation by Xcel		
	E-44	I-7(B (Pitkin)	229+58	6' RT	74	6"	PLASTIC	90298.53	34758.60	4578.51'	3.00'	4575.51'	4575.01'			Proposed water crosses existing electrical line	Relocation by Xcel		
	E-45	I-7(B (Pitkin)	229+63	6' RT												Prcposed water crosses existing electrical line	Relocation by Xcel		
	E-46	I-7(B (Pitkin)	229+89	6' RT												Proposed water crosses existing electrical line.	Relocation by Xcel		
	E-47	I-7(B (Pitkin)	229+84	6' RT												Prcposed water crosses ex sting electrical line.	Relocation by Xcel		
	E-48	I-7(B (Pitkin)	229+58	34' RT	45	6"	PVC	90298.88	34689.58	4578.51'	3.83'	4574.68'	4574.18'			Prcposed storm crosses existing electrical line	Relocation by Xcel		
	E-49	I-7(B (Pitkin)	229+62	34' RT	46	6"	PVC	90302.61	34689.30	4578.53'	4.17'	4574.36'	4573.86'			Prcposed storm crosses existing electrical line	Relocation by Xcel		
	E-50	I-7(B (Pitkin)	229+85	34' RT	50A	2x 6"	PVC	90329.67	34712.93	4578.66'	3.58'	4575.08'	4574.58'			Prcposed storm crosses exis:ing concrete encased electrical line	Relocation by Xcel		

Print Date: 9/7/2023 I-70B SOUTH OF ROOD Sheet Revisions Colorado Department of Transportation As Constructed Project No./Code EXISTING UTILITY CONFLICT MATRIX File Name: 23583_UTL_PLN-MATRIX-1.dgn 606 South 9th Street Grand Junction CD 81501 Phone 970-683-6351 FAX: 970-683-6369 Date: Comments Init. All seals for this set of drawings are applied to the cover page(s) NHPP 070A-037 No Revisions: SHEET 6 Vert. Scale: As Noted Horiz. Scale: Unit Information NLEE Structure Designer: 23583 Revised: HOR 1670 BROADWAY, SUITE 3400 DENVER, COLORADO 80202 Phone: 303-764-1520 FAX: 303-860-7139 Detailer: BWILLIAMS Numbers Region 3 КСС Void: Sheet Subset: UTILITY Subset Sheets: 29 of 38 Sheet Number 170

					-						I-70B	- Utility (Sonflict	Matrix	~	diat Data		1	
UTILITY OWNER	≞	Conflic	t Locatio	1					Utility Data			Utility E	evation	Conflict	Cor Elevation	nflict Data	Conflict F	Est.	n
		Alignment Name	Station	Distance Lt. / Rt.	Test Hole No.	Size	Material	Northing	Easting	Surace Elevation	Measure Down	Тор	Bottom	Тор	Bottom	Detaled Conflict Description	Proposed Mitigation / Action	Resolution Date	Current status
	E-51	I-7(B (Pitkin)	229+90	34' RT	50A	2x 6"	PVC	90329.67	34712.93	4578.66'	3.58'	4575.08'	4574.58'			Prcposed storm crosses existing electrical line	Relocation by Xcel		
	E-52	I-7(B (Pitkin)	229+58	100' RT	73	6"	PLASTIC	90299.71	34647.39	4578.51'	3.58'	4574.93'	4574.43'			Inlet located on elec line (elec line parallel to curb/gutter)	Relocation by Xcel		
	E-53	I-7(B (Pitkin)	229+62	106' RT												Prcposed storm crosses existing electrical line	Relocation by Xcel		
ELECTRIC	E-54	I-7(B (Pitkin)	229+85	109' RT	72	10"	CONCRETE	90330.31	34637.35	4578.66'	2.92'	4575.74'	4574.91'			Prcposed storm crosses existing concrete encased electrical line.	Relocation by Xcel		
	E-55	i- /ርB (Pitkin)	229+90	109 [,] KI	72	10"	CONCRETE	90330.31	34637.35	4578.66	2.92	45/5./4	4574.91			Inlet located onconcrete en:ased electrical line.	Kelocation by Xcel		
	E-56	I-7(B (Pitkin)	223+11	7' LT												OH electric service to light pole to be removed by Xcel	Remove by Xcel		
	E-57	2nd St	353+16	25' RT												Proposed water service crosses existing electric line	Protect in place		
																Proposed storm in conflict	Waterline is out of service. Contractor can		
	W-2	I-70Z (Ute)	13+20	14' LT	5	10"	STEEL	89465.50	35952.92	4580.56'	4.92'	4575.64'	4574.81'			with existing abandoned water line	cut and cap as necessary.		
	W-3	I-70Z (Ute)	14+49	74' LT	9	12"	PVC	89518.51	35827.72	4581.07'	4.00'	4577.07'	4575.07'			Proposed storm crosses existing water line	Waterline elocation by Contractor as shown on Waterline Plans		
	7-M	I-70Z (Ute)	14+59	76' LT												Proposed storm crosses existing water line	Waterline is out of service. Contractor can cut and cap as necessary.		
	W-5	I-70Z (Ute)	14+70	50' LT												Proposed storm crosses existing hydrant service	Waterline 'elocation by Contractor as shown on Waterline Plans		
WATER	9-M	I-70Z (Ute)	14+72	30' LT												Proposed storm crosses existing water service	Waterline relocation by Contractor as shown on Waterline Plans		
	V-7	I-70Z (Ute)	14+75	12' LT												Proposed storm crosses existing water line	Waterline is out of service. Contractor can cut and cap as necessary.		
	W-8	I-7(B (Pitkin)	212+74	82' RT	10	12"	PVC	89353.05	35820.79	4579.75'	4.17'	4575.58'	4574.58'			Proposed storm inlet in conflict with existing water line	Waterline relocation by Contractor as shown on Waterline Plans		
	6-W	I-7(B (Pitkin)	212+78	82' RT												Proposed storm inlet in conflict with existing water line	Waterline is out of service. Contractor can cut and cap as necessary.		
	W-10	I-70Z (Ute)	14+85	51'LT												Proposed curb ramp conflicts with existing fire hydrant	Reset hydrant as shown on Waterline Plans		
OTE: 1. NUMBERI	NG			NTINUOUS.					r							FOR	INFORMA		
eals for this set o wings are applied he cover page(s)		Print Date: 9/7/20 File Name: 23583. Horiz. Scale: Unit Information	_UTL_PLN-M Ve	ert. Scale: As	Noted			Revisions mments	Init.		SS §	06 South 9 irand Junct 'hone: 970-	9th Street ion, CD 8 683-6351		No	Constructed Revisions: vised: Desig	I-70B SOUTH OF RO STING UTILITY CONFLIC SHEET 7 gner: NLEE Structure		Project No./ NHPP 070A 23583
		HOR 1670 E DENVI Phone	BROADWAY, SU ER, COLORADC 303-764-15 303-860-71	ITE 3400 80202						gion 3		AX: 970-68	0-0208		CC Voi	Deta			38 Sheet Number

											I-70B	- Utility (Conflict	Matrix					
UTILITY OWNER	#	Conflic	t Locatio	on	1				Utility Data	1						nflict Data	Conflict F	Resolution	Î.
UTILITY OWNER		Alignment Name	Station	Distance	Test	Size	Material	Northing	Easting	Surface	Measure	Utility E	evation	Conflict	Elevation	Detaled Conflict Description	Proposed Mitigation / Action	Est. Resolution	Current status
		Aligiment Name	Station	Lt. / Rt.	Hole No.	Size	Wateria	Northing	Lasting	Elevation	Down	Тор	Bottom	Тор	Bottom			Date	Current status
	W-12	I-70Z (Ute)	15+71	28'LT												Proposed storm crosses existing water service	Waterline to be taken out-of-service by Contractor as shown on Waterline Plans		
	W-12B	I-70Z (Ute)	15+27	13' LT												Proposed storm crosses abandoned water line	Waterline is out of service. Contractor can cut and cap as necessary.		
	W-13	I-7(B (Pitkin)	213+99	37' RT	13A	2"	COPPER	89401.85	35695.23	4580.11'	4.08'	4576.03'	4575.86'			Proposed storm inlet in conflict with existing water line	Waterline relocation by Contractor as shown on Waterline Plans		
	W-14	I-70Z (Ute)	16+53	34' LT	15	10"	STEEL	89493.47	35622.23	4581.48	3.83'	4577.65'	4575.81'			Proposed storm crosses below existing water service	Waterline to be taken out-of-service by Contractor & shown on Waterline Plans		
	W-15	I-7(B (Pitkin)	216+54	27' RT												Proposed storm crosses below existing water line. Flowfill encountered during test holing.	Waterfine relocation by Contractor as shown on Waterline Plans		
	W-16	I-7(B (Pitkin)	216+76	34' RT	21A	10"	PVC	89405.65	35390.33	4580.10'	4.83'	4575.27'	4574.43'			Proposed storm crosses existing water line	Waterline relocation by Contractor as shown on Waterline Plans		
	W-17	I-7(B (Pitkin)	217+59	34' RT												Inlet placed on existing waterline (waterline parallel to cuib and gutter)	Waterline relocation by Contractor as shown on Waterline Plans		
WATER	W-18	I-7(B (Pitkin)	218+50	37' RT												Inlet placed on existing waterline (waterline parallel to curb and gutter)	Waterline relocation by Contractor as shown on Waterline Plans		
	W-20	I-7(B (Pitkin)	219+69	78' RT												Proposed storm crosses below existing water line.	Waterline relocation by Contractor as shown on Waterline Plans		
	W-21	I-7(B (Pitkin)	219+76	80' RT	27	10"	PLASTIC	89403.67	35089.44	4579.28'	4.92'	4574.36	4573.53'			Proposed storm crosses below existing water line.	Waterline relocation by Contractor as shown on Waterline Plans		
	W-22	I-7(B (Pitkin)	219+93	93' RT												Proposed curb ramp conflicts with existing fire hydrant	Reset hydrant as shown on Waterline Plans		
	W-23	I-70Z (Ute)	22+00	3' LT												Proposed roadway realignment conflicts with existing fire hydrant	Reset hydrant as shown on Waterline Plans		
	W-24	I-70Z (Ute)	23+81	38' LT	31	10"	PLASTIC	89690.97	35095.61	4581.48'	4.50'	4576.98'	4575.98'			Proposed storm crosses existing water service	Waterline relocation by Contractor as shown on Waterline Plans		
	W-25	I-70Z (Ute)	23+80	42' LT												Proposed curbramp conflicts with existing water meter pit	Reset Water Meter by Contractor as shown in on Waterline Plans		
	W-26	I-70Z (Ute)	24+21	28' LT												Proposed storm crosses existing water line	Waterline relocation by Contractor as shown on Waterline Plans		
	W-27	I-70Z (Ute)	25+13	28' LT												Proposed storm crosses existing water line	Waterline relocation by Contractor as shown on Waterline Plans		
NOTE: 1. NUMBER	RING			INTINUOUS												FOR	INFORMA		N ONL
		Print Date: 9/7/2		utoby t				Revisions	_	Colorado	Depar	tment o	f Trans	portati	on As	Constructed	I-70B SOUTH OF ROI		Project No./Co
seals for this set	of	File Name: 23583 Horiz. Scale:		MATRIX-1.dgn ert. Scale: As	Noted	Date	e: Co	mments	Init.		6	06 South	th Street		No	Revisions:	STING UTILITY CONFLIC SHEET 8	I MAIR	NHPP 070A-03
awings are applied the cover page(s)	l to	Unit Information	ve	ST C. SCUIC: AS		$\exists \vdash$			+			Frand Junct Phone: 970-	683-6351	1501			gner: NLEE Structure		23583
cover page(s)	,	FR PROFESSION	BROADWAY, SU ER, COLORADC	ITE 3400 80202		5					CDOT F	AX: 970-68	3-6369			Deta	011001010		
			a: 303-764-15 303-860-71	20 39	c				R	egion 3				K	CC Vo	id: Shee	t Subset: UTILITY Subset Sheets:	31 of 3	3 Sheet Number

											I-70B	- Utility (Conflict	Matrix					
	- 11	t Conflic	ct Locati	on					Utility Data			-			Cor	nflict Data	Conflict F	Resolution	1
UTILITY OWNE	ER 6	3		Distance	Test					Surface	Measure	Utility E	evation	Conflict	Elevation			Est.	
		Alignment Name	Station	Lt. / Rt.	Hole No.	Size	Material	Northing	Easting	Elevation	Down	Тор	Bottom	Тор	Bottom	Detaled Conflict Description	Proposed Mitigation / Action	Resolution	Current status
		[%] ∃ I-70Z (Ute)	26+46	5' LT												Proposed storm crosses existing water service	Waterline relocation by Contractor as shown on Waterline Plans	Date	
		7 I-70Z (Ute)	27+04	6' LT	43	1"	COPPER	90047.16	35063.84	4581.48'	3.17'	4578.31'	4578.23'			Prop₀sed storm crosses existing water service	Waterline relocation by Contractor as shown on Waterline Plans		
	1	1-70Z (Ute)	27+47	6' LT												Proposed storm crosses existing water service	Waterline relocation by Contractor as shown on Waterline Plans		
		I-7(B (Pitkin)	225+55	6' RT												Proposed storm crosses existing water line	Waterline 'elocation by Contractor as shown on Waterline Plans		
		err- I-7(B (Pitkin)	225+98	4' LT												Proposed curb conflicts with existing water meter pit	Reset Waler Meter by Contractor as shown on Waterline Plans		
		n r P I-7(B (Pitkin)	226+75	0" RT												Proposed curb conflicts with existing water meter pit	Reset Water Meter by Contractor as shown in on Waterline Plans		
	:	I-7(B (Pitkin)	227+68	34' RT	44	4"	PLASTIC	90108.65	34712.79	4577.82	5.17'	4572.65'	4572.32'			Proposed storm crosses existing water service	Protect in place		
WATER		I-7(B (Pitkin)	227+68	34' RT												Proposed storm crosses existing water service	Protect in place		
WATER	1	ີ່ I-70Z (Ute)	29+63	30' LT	57	8"	STEEL	90308.40	35097.21	4581.48'	4.58'	4576.90'	4575.23'			Proposed storm conflicts with existing water line	Waterline elocation by Contractor as shown on Waterline Plans		
		1-70Z (Ute)	29+80	4' RT	56	8"	PLASTIC	90322.66	35063.29	4581.48'	3.92'	4577.56'	4575.90'			Proposed storm conflicts with existing water line	Waterline is out of service. Contractor can cut and cap as necessary.		
	1	0. S I-70Z (Ute)	30+44	30' LT												Proposed storm conflicts with existing water line	Waterline elocation by Contractor as shown on Waterline Plans		
		6 5 I-70Z (Ute)	30+86	1' RT	64	1"	STEEL	90429.05	35064.03	4579.44'	3.75'	4575.69'	4575.61'			Proposed storm conflicts with existing water service	Waterline elocation by Contractor as shown on Waterline Plans		
) I-70Z (Ute)	31+20	1' RT												Proposed storm conflicts with existing water service	Waterline relocation by Contractor as shown on Waterline Plans		
		I-7(B (Pitkin)	229+82	44' LT	53	8"	PLASTIC	90324.65	34806.00	4578.63'	3.75'	4574.88'	4574.21'			Proposed storm conflicts with existing water line	Waterline relocation by Contractor as shown on Waterline Plans		
		I-7(B (Pitkin)	229+65	3' RT	51	8"	PLASTIC	90305.55	34744.44	4578.54'	3.83'	4574.71'	4574.04'			Proposed storm conflicts with existing water line	Waterline relocation by Contractor as shown on Waterline Plans		
	1	I-7(B (Pitkin)	229+35	34' RT	49	6"	PVC	90274.84	34712.19	4578.39'	4.00'	4574.39'	4573.89'			Proposed storm conflicts with existing water service	Waterline relocation by Contractor as shown on Waterline Plans		

	Print Date: 9/7/2023	4		Sheet Revisions		Colorad	lo Dep	partment of Transportation	n	As Constructed		TH OF ROOD	Project No./Code
All seals for this			Date:	Comments	Init.			606 South 9th Street Grand Junction, CD 81501		No Revisions:	SHE	CONFLICT MATRI> ET 9	NHPP 070A-037
drawings are app the cover pag	(s) Unit Information						CDOT	Phone: 970-683-6351 FAX: 970-683-6369		Revised:		Structure	23583
	1670 BROADWAY, SUITE 3400 DENVER. COLORADO 80202 Phone: 303-764-1520 FAX: 303-864-1520		<u> </u>		-	Region 3		KCC	c F	Void:	Detailer: BWILLIAMS Sheet Subset: UTILITY	Numbers Subset Sheets: 32 of 38	Sheet Number 173


											I-70B	- Utility (Conflict	Matrix					
	#	Conflic	t Locatio	n					Utility Data						Cor	nflict Data	Conflict F	Resolutio	n
UTILITY OWNER	"≙			Distance	Test					Surace	Measure	Utility El	evation	Conflict	Elevation			Est.	
	Ц	Alignment Name	Station	Lt. / Rt.	Hole No.	Size	Material	Northing	Easting	Elevation	Down	Тор	Bottom	Тор	Bottom	Detaled Conflict Description	Proposed Mitigation / Action	Resolution Date	Current status
	W-40B	I-7(B (Pitkin)	230+64	27' RT												Proposed storm crosses with existing water service	Waterline relocation by Contractor as shown on Waterline Plans		
	W-41	I-7(B (Pitkin)	231+26	34' RT	65B	1"	COPPER	90467.17	34712.09	4578.47'	2.50'	4575.97'	4575.89'			Proposed storm crosses with existing water service	Waterline relocation by Contractor as shown on Waterline Plans		
	W-42	I-7(B (Pitkin)	231+28	34' RT	65A	1"	COPPER	90467.17	34712.09	4578.48'	2.67'	4575.81'	4575.73'			Proposed storm conflicts with existing water service	Waterline relocation by Contractor as shown on Waterline Plans		
WATER	W-45	2nd St	350+54	10' RT	71	10"	STEEL	89841.97	34598.23	4576.84'	4.33'	4572.51'	4571.67'			Proposed storm conflicts with existing water line	Waterline relocation by Contractor as shown on Waterline Plans		
WATER	9t-M	2nd St	351+62	12' KI	33	8"	PLASTIC	89844.94	34/16.72	4577.28	5'	4572.28	4571.61			Proposed storm crosses existing water line	Waterline relocation by Contractor as shown on Waterline Plans		
	W-47	2nd St	352+52	17' RT												Proposed storm inlet adjacent to 2 ft of existing water line	Waterline relocation by Contractor as shown on Waterline Plans		
	W-48	2nd St	353+40	21' LT												Proposed storm inlet passes near existing water line	Waterline relocation by Contractor as shown on Waterline Plans		
	W-49	2nd St	353+45	23' LT												Proposed storm conflicts with existing water line	Waterline relocation by Contractor as shown on Waterline Plans		
	S-1	I-70Z (Ute)	12+94	34' LT												Proposed storm crosses above existing sanitary line	Protect in place		
	S-2	I-70Z (Ute)	13+21	10" LT												Proposed storm crosses above existing sanitary line	Protect in place		
	S-3	I-70Z (Ute)	14+75	9' LT												Proposed storm crosses above existing sanitary line	Protect in place		
SANITARY	S-36	I-70Z (Ute)	15+14	9' LT												Proposed storm crosses above existing sanitary line	Protect in place		
	S-4	I-70Z (Ute)	16+64	33' LT												Proposed storm crosses above existing sanitary line	Protect in place		
	S-5	I-7(B (Pitkin)	216+70	34' RT												Propo:ed storm crosses above existing sanitary line	Protect in place		
	S-6	I-70Z (Ute)	20+23	44' LT												Propo:ed storm crosses above existing sanitary line	Protect in place		

NOTE: 1. NUMBERING OF CONFLICTS IS NONCONTINUOUS.

	Print Date: 9/7/2023 File Name: 23583_UTL_PLN-MATRIX-1.dan		Sheet Revisions		Colorado Dep	partment of Transportation	As Constructed	I-70B SOUTH OF ROOD EXISTING UTILITY CONFLICT MATRI)	Project No./Code
All seals for this set of	Horiz. Scole: Vert. Scole: As Noted	\bigcirc	Date: Comments	Init.		606 South 9th Street Grand Junction, CD 81501	No Revisions:	SHEET 10	NHPP 070A-037
drawings are applied to the cover page(s)	Unit Information	$\overline{0}$				Dhanas 070-692-6351	Revised:	Designer: NLEE Structure	23583
	HOR BROADWAY, SUITE 3400 DENVER, COLORADO 80202 Phone: 303-764-1520 FAX: 303-860-7139	00			Region 3	КСС	A.C. 2.15	Detailer: BWILLIAMS Numbers Sheet Subset: UTILITY Subset Sheets: 33 of 38	Sheet Number 174

											I-70B	- Utility (Conflict	Matrix					
UTILITY OWNER	#	Conflic	t Locatio	on					Utility Data						Cor	nflict Data	Conflict F	Resolutio	n
UTILITY OWNER				Distance	Test		200 B 100 B	1000 0000	1000 T 1000	Surface	Measure	Utility El	levation	Conflict	Elevation			Est.	
		Aligrment Name	Station		Hole No.	Size	Material	Northing	Easting	Elevation	Down	Тор	Bottom	Тор	Bottom	Detaled Conflict Description	Proposed Mitigation / Action	Resolution Date	Current status
	S-8	I-7(B (Pitkin)	219+95	27' RT												Proposed water crosses above existing sanitary line	Protect in place		
SANITARY	8-9	I-7(B (Pitkin)	222+20	34' RT						1						Proposed storm crosses above existing sanitary line	Protect in place		
SANITART	S-10	I-70Z (Ute)	29+63	159' RT												Proposed storm crosses above existing sanitary	Protect in place		
	S-14	2nd St	353+64	6' RT												Proposed storm crosses above existing sanitary line	Protect in place		
IRRIGATION	IR-1	I-70Z (Ute)	14+40	58' RT												Existing irrigation pullbox in conflict with proposed sidewalk	Reset to Final Grade		

	Print Date: 9/7/2023			Sheet Revisions		Colorad	lo Dep	artment of Transportation	n	As Constructed	I-70B SUU	TH OF ROOD	Project No./Code
All seals for this set of	File Name: 23583_UTL_PLN-MATRIX-1.dgn Horiz. Scale: Vert. Scale: As Noted		Date:	Comments	Init.			606 South 9th Street		No Revisions:		' CONFLICT MATRI> ET 11	NHPP 070A-037
drawings are applied to the cover page(s)	Unit Information	U	\vdash				S>	Grand Junction, CD 81501 Phone: 970-683-6351	ŀ	Revised:		Structure	23583
	LOD 1670 BROADWAY, SUITE 3400 DENVER, COLORADO 80202						CDOT	FAX: 970-683-6369	- H		Detailer: BWILLIAMS	Numbers	
	FAX: 303-764-1520 FAX: 303-860-7139	\bigcirc				Region 3		ĸc	;C	Void:	Sheet Subset: UTILITY	Subset Sheets: 34 of 38	Sheet Number 175

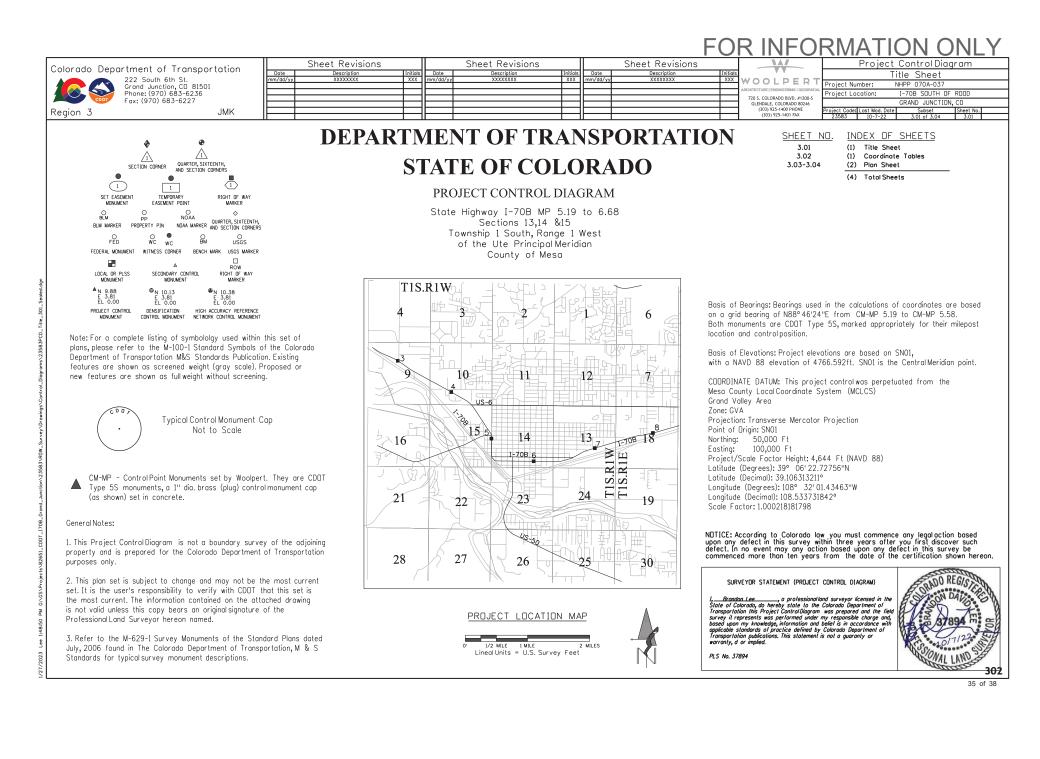

Colorado Department of Transportation		Sheet Revisions			Sheet Revisions			Sheet Revisions			Project Control Diagram
	Date	Description XXXXXXXX	Initials	Date mm/dd/yy	Description XXXXXXXX	Initials	Date	Description XXXXXXXX	Initials XXX		Coordinates Tabulation
222 South 6th St. Grand Junction, CD 81501	mm/dd/yy	******	***	mm/ 00/ yy	******	***	mm/dd/yy	*******	***	All seals for this set of	Project Number: NHPP 070A-037
Phone: (970) 683-6236										drawings are applied to the cover page(s)	Project Location: I-70B SOUTH OF ROOD
Fax: (970) 683-6227										the corter page(c)	GRAND JUNCTION, CO
Region 3 JMK			-								Project Code: Last Mod. Date Subset Sheet No. 23583 10-7-22 3.01 to 3.04 3.02
											25585 10-7-22 5.01 10 5.04 5.02

			PROJECT C	OORDINATE TABLE
Point No.	Project Co	oordinates	Elev(ft)	Description
FORTE NO.	Northing(ft)	Easting(ft)	(NAVD88)	Description
SN01	50000.00	100000.00	4766.59	NGS HARN POINT 88 GPS#100
519	35061.54	89796.49	4578.98	CDOT TYPE 5S -CDOT 5.19-
520	34783.83	89796.23	4577.32	CDOT TYPE 5S -CDOT 520-
522	34701.00	89861.67	4576.66	CDOT TYPE 5S -CDOT 5.22-
548	34692.23	91220.37	4580.04	CDOT TYPE 5S -CDOT 5.48-
558	35102.88	91727.10	4583.67	CDOT TYPE 5S -CDOT 5.58-
576	34749.01	92693.91	4581.25	CDOT TYPE 5S -CDOT 5.76-
586	35039.41	93239.42	4585.70	CDOT TYPE 5S -CDOT 5.86-
612	35116.52	94659.49	4589.54	CDOT TYPE 5S -CDOT 6.12-
613	34685.60	94657.76	4587.26	CDOT TYPE 5S -CDOT 6.13-
631	35042.43	95619.58	4591.31	CDOT TYPE 5S -CDOT 6.31-
632	34784.77	95629.91	4589.76	CDOT TYPE 5S -CDOT 6.32-
653	35119.73	96685.89	4596.83	CDOT TYPE 5S -CDOT 6.53-
668	35538.13	97389.09	4598.78	CDOT TYPE 5S -CDOT 6.68-
P036	34189.98	94689.07	4585.12	3.25 IN BC -JACOBS T1S R1W/S14 S13 S23 S24/2013/PLS24961-
515	35052.79	89450.31	4578.61	CDOT TYPE 5S
520	34783.90	89796.30	4577.32	CDOT TYPE 5S
210	35108.91	90361.03	4579.57	5D NAIL
818	35131.76	89871.19	4579.65	1" BP SET
820	35313.05	89490.49	4580.13	HINGE NAIL
902	35849.81	89496.42	4580.58	HINGE NAIL
903	35846.00	89389.00	4579.59	HINGE NAIL

303 36 of 38

