DEPARTMENT OF TRANSPORTATION STATE OF COLORADO

Related Projects:
P. E. UNDER PROJECT:
Project Number SHE M555-034
Project Code: 23652

R.O.W. Projects:

R.O.W. Project Description SHE M555-034

HIGHWAY CONSTRUCTION BID PLANS OF PROPOSED
FEDERAL AID PROJECT NO. SHE M555-034
Horizon Drive and G Road Roundabout
MESA COUNTY
CONSTRUCTION PROJECT CODE NO. 23652
SEC. 1, TOWNSHIP 1 SOUTH, RANGE 1 WEST, UTE PRINCIPAL MERIDIAN

Print Date: 6/18/2024 7:50:51 AM

File Name: COVER PAGE.dwg

Horiz. Scale: AS SHOWN Vert. Scale: NA

Unit Information: City of GJ Unit Leader Initials: LF

Grand Junction, CO, 81501
Phone: 970–244–1554

Date: Comments Init.

Sheet Revisions

Colorado Department of Transportation

606 South 9th Street
Grand Junction, CO, 81501
Phone: 970-683-6351 FAX: 970-683-6369

Region 3 KC

As Constructed	Project No./Code			
	Contractor:			
No Revisions:	Resident Engineer:	SHE M555-034		
Revised:	Project Engineer:	23652		
	PROJECT STARTED:/ ACCEPTED:/			
Void:	Comments:	Sheet Number 1		

Oversight / NHS FHWA REGION VIII OVERSIGHT? NATIONAL HIGHWAY SYSTEM? NO □YES

DESCRIPTION OF PROJECT

ROUNDABOUT DESIGN DATA:

DESIGN VEHICLE - AASHTO WB-67

DESIGN DIAMETER - 82'

DESIGN SPEED - 15 MPH

CURB, GUTTER AND SIDEWALK.

CONSTRUCT A MODERN STYLE ROUNDABOUT AT THE FOUR WAY

UNCLASSIFIED EXCAVATION, AGGREGATE BASE COURSE, HOT MIX ASPHALT, CONCRETE PAVEMENT, DRAINAGE PIPELINE INSTALLATION,

A MANDATORY PRE-BID CONFERENCE WILL BE HELD ON XXXX XX,

20XX AT 10:00 AM AT THE MESA CONFERENCE ROOM LOCATED

GRAND JUNCTION, COLORADO TO PRESENT A BRIEF OVERVIEW OF

THE PROJECT AND TO ANSWER QUESTIONS FROM PROSPECTIVE

AT 606 SOUTH 9TH STREET (CDOT MAINTENANCE BUILDING),

CIRCULATORY LANE WIDTHS - 12' INSIDE / 16' OUTSIDE

HORIZON DRIVE - MINOR ARTERIAL (A.D.T.=19890)

G ROAD - MAJOR COLLECTOR (A.D.T.=5291)

HORIZON DRIVE EXIT RADIUS - 450 FEET

G ROAD EXIT RADIUS - 400 FEET

ENTRY RADIUS' - 85 FEET

INTERSECTION OF HORIZON DRIVE AND G ROAD. THIS IS A

INTERSECTION UPGRADE FUNDED PROJECT WHICH INCLUDES

DEPARTMENT OF TRANSPORTATION STATE OF COLORADO

HIGHWAY CONSTRUCTION BID PLANS OF PROPOSED
FEDERAL AID PROJECT NO. SHE M555-034
Horizon Drive and G Road Roundabout
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SEC. 1, TOWNSHIP 1 SOUTH, RANGE 1 WEST, UTE PRINCIPAL MERIDIAN

30 H RD 8 to Rifle G RD OB Construction Project No. SHE M555-034 Horizon Dr. and G Rd Roundabout 29 GRAND JUNCTION PATTERSON RD

SHEET No. INDEX OF SHEETS

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- 3 CDOT STANDARD PLAN LIST

Related Projects:

R.O.W. Projects:

P. E. UNDER PROJECT:

Project Number

SHE M555-034

23652

R.O.W. Project Description SHE M555-034

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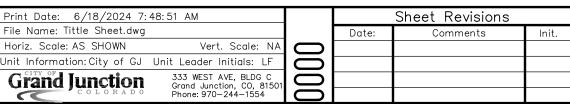
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Colorado Department of Transportation

606 South 9th Street
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Phone: 970-683-6351 FAX: 970-683-6369

Region 3 KC

PROJECT LOCATION MAP

As Constructed			
	Contractor:	Project No./Code	
No Revisions:	Resident Engineer:	SHE M555-034	
Revised:	Project Engineer:	23652	
	PROJECT STARTED://_ ACCEPTED://_	23352	
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Grand Junction

333 WEST AVE, BLDG C Grand Junction, CO, 81501 Phone: 970-244-1554

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	of GJ Unit Leader Initials: LF					606 South 9th Street Grand Junction, CO, 81501 Phone: 970-683-6351 FAX: 970-683-6	Rev	vised:	D	esigner:	JCS	Structure		23652
Grand lune	333 WEST AVE, BLDG C		1		450	Phone: 970-683-6351 FAX: 970-683-6	3369 [^{1\\extreme}}	,		etailer:	JCS	Numbers		2002

Region 3

ODOT STANDARD PLAN LIST

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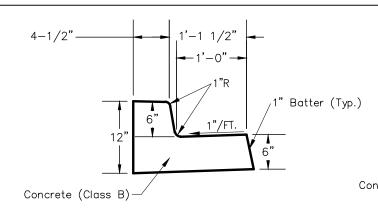
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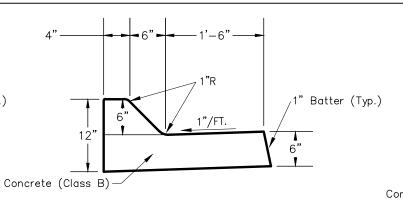
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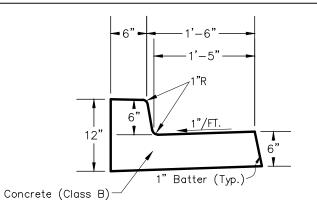





- Gutter Cross—Slope shall be 1/2" per ft. when draining away from curb and 1" per ft. when draining towards curb.
- Tie Bars between the concrete gutter and the concrete pavement shall be installed per Standard Plan M—412—1.
- Tie—bars shall be Grade 40, epoxy coated, and deformed. Bar size shall be as designated on the Standard Plan M—412—1.
- All Curb and Gutter shall be monolithic and shall not be Key-Way Type 4 Curbs.
 Where gutter is adjacent to Concrete
- Where gutter is adjacent to Concrete Pavement, the gutter thickness shall match that of the adjacent Concrete Pavement. See General Notes in M&S Standards M-609-1 for more information.








CURB AND GUTTER TYPE 2 (SECTION IB) (SPECIAL) (CATCH/SPILL GUTTER)

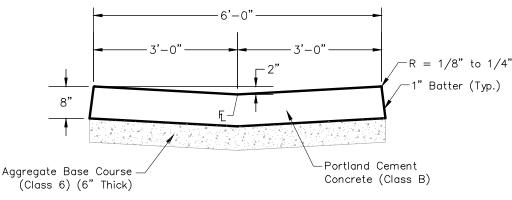

GUTTER TYPE 2 (SPECIAL) & GUTTER TYPE 2 (6 FOOT) (FAST TRACK)

Notes:


— Reason for Gutter Type 2 (Special) is that the concrete thickness is increased to 8 Inches for this project.

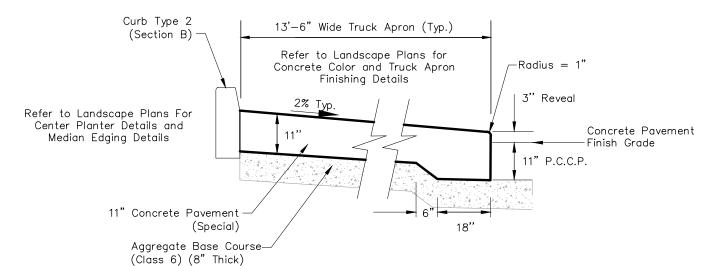

TRUCK APRON DETAIL

CURB AND GUTTER TYPE 2 (SECTION IM) (SPECIAL) (MOUNTABLE)

CURB AND GUTTER TYPE 2 (SECTION IIB) (SPECIAL)

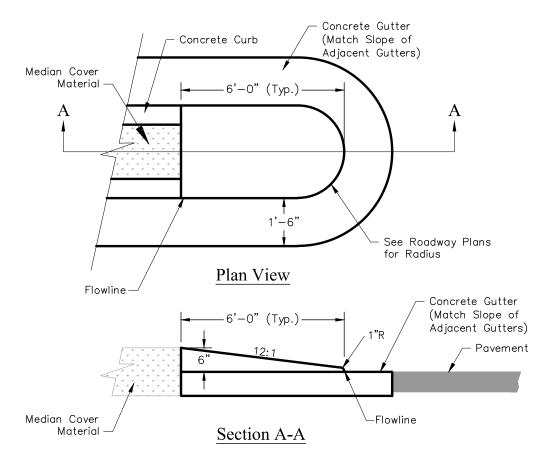

MEDIAN ISLAND NOSE DETAIL

Notes

 Median Nose will be included in the cost of curb and gutter and is measured at flow—line.
 Thickness of curb and gutter section shall match concrete pavement thickness.

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Horiz. Scale: AS SHOWN	Vert. Scale: NA			
Unit Information: City of GJ	Unit Leader Initials: LF			
Grand Junction	333 WEST AVE, BLDG C Grand Junction, CO, 81501			
COLORADO	Phone: 970–244–1554			

Colorado D	epartment of Transportation
CO	606 South 9th Street Grand Junction, CO, 81501 Phone: 970-683-6351 FAX: 970-683-6369

Region 3

KC


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Revised:	Designer: JCS	Structure	23652
No Revisions:	ROADWAY I	DETAILS - 1	SHE M555-034
As Constructed	1	G RD ROUNDABOUT	Project No./Code

File Name: Roadway Details.dwg

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Grand Junction

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Region 3

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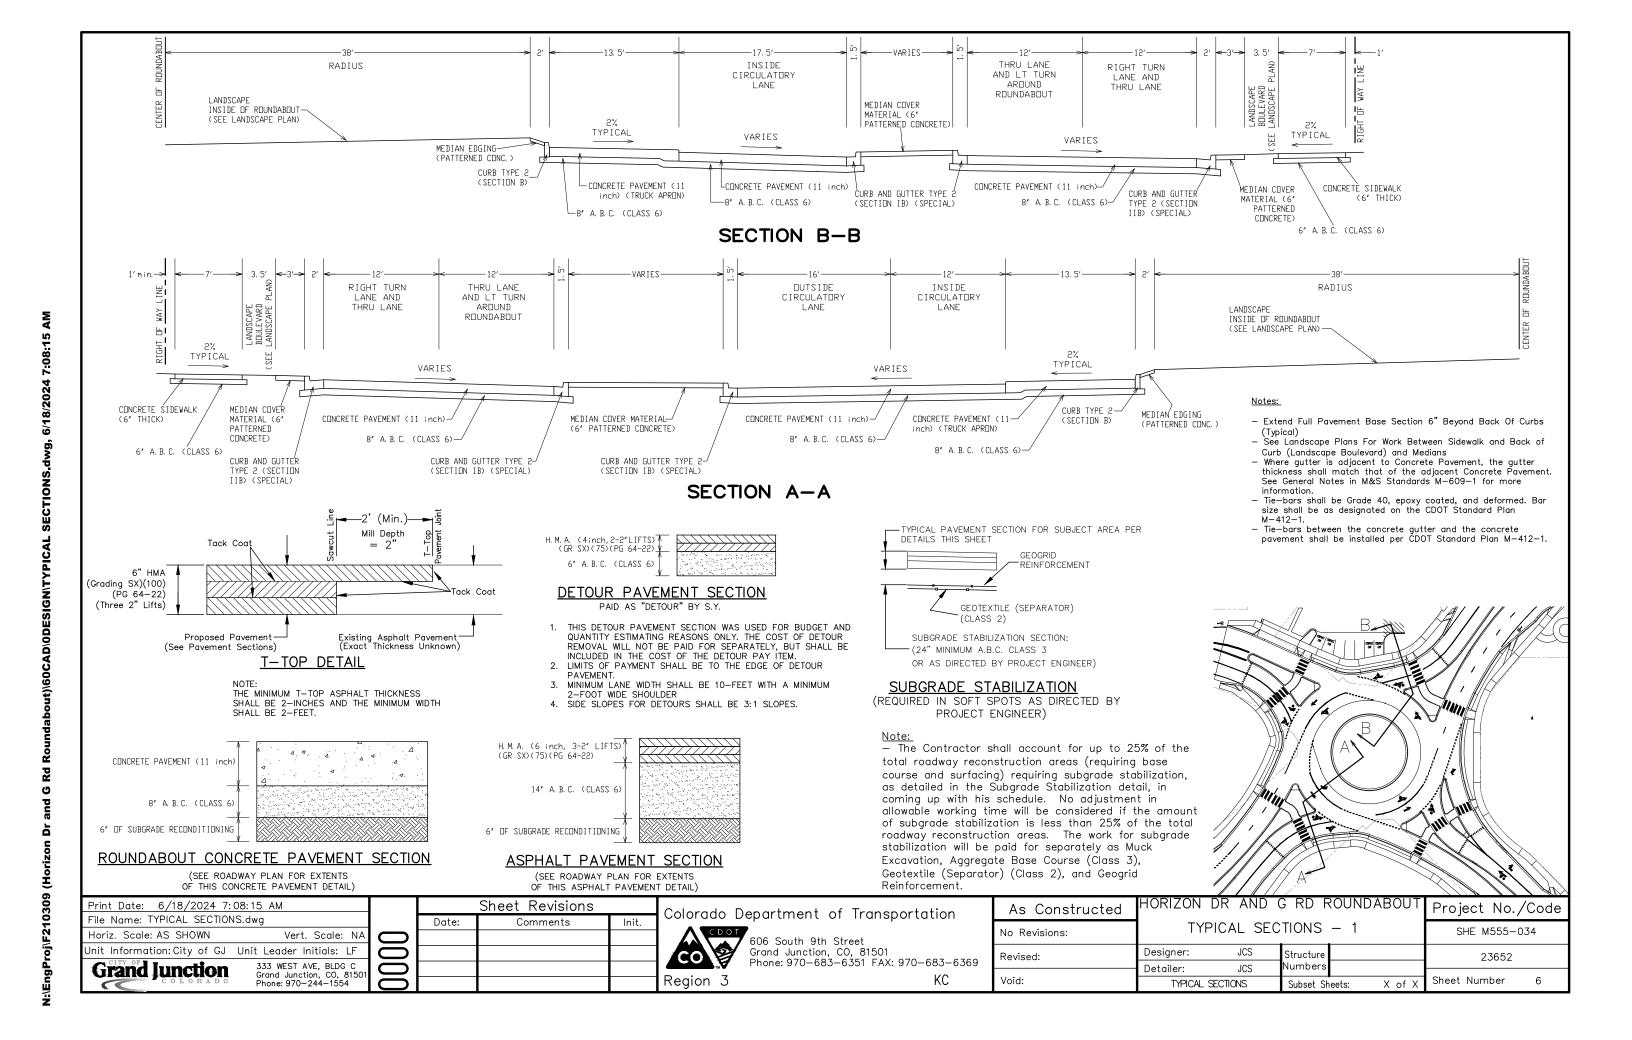
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CONSTRUCTION

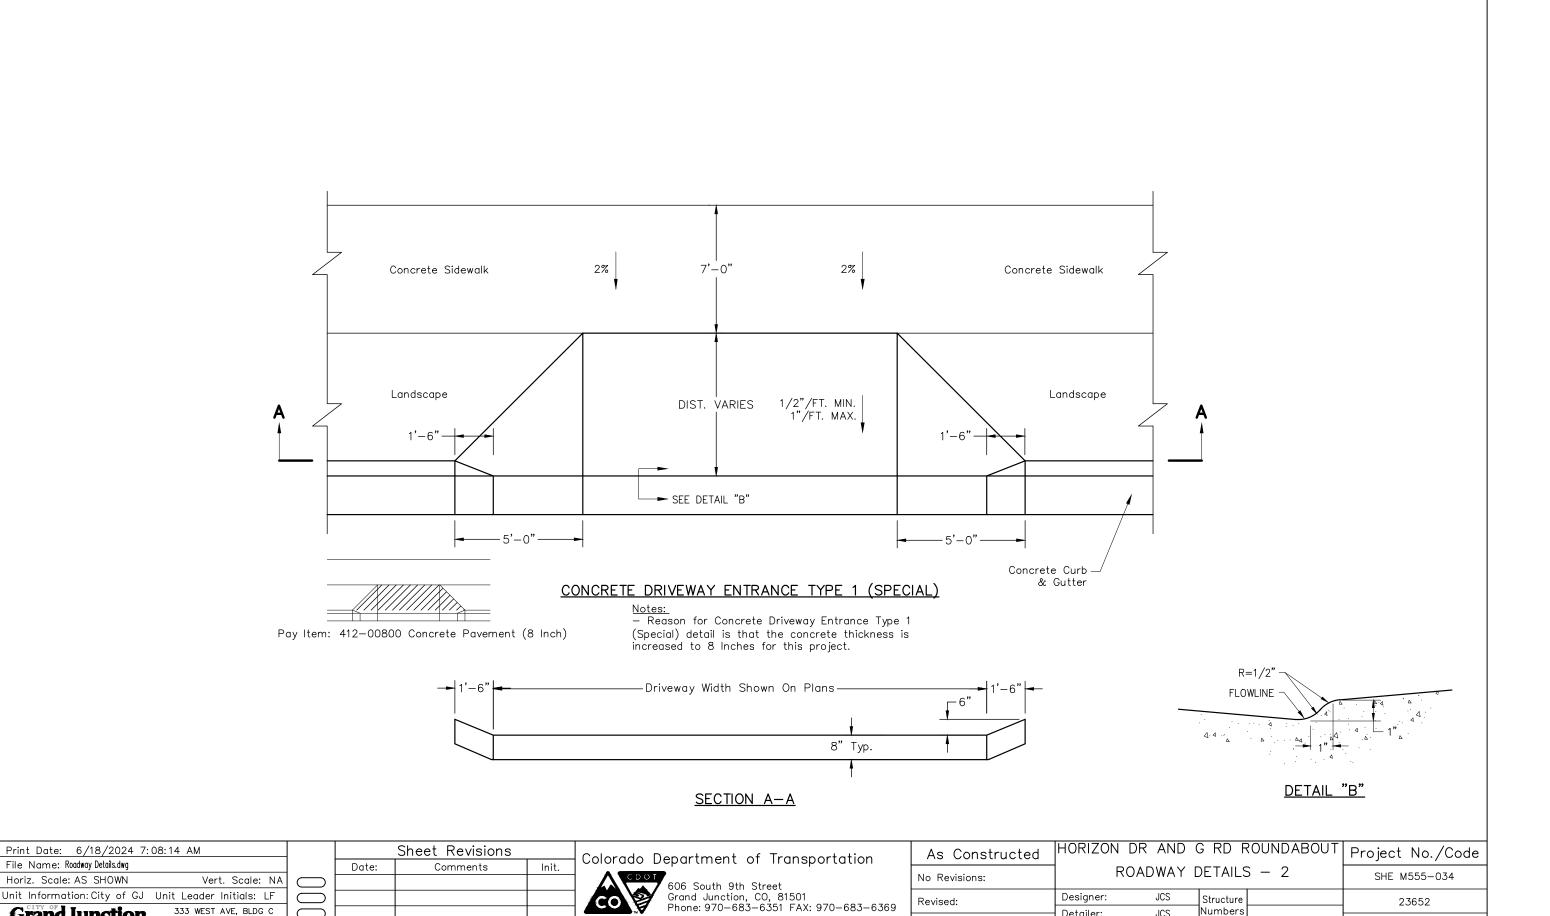HE FOLLOWING SHALL BE FURNISHED WITH EACH HOT MIX PAVER:

- A. A SKI TYPE DEVICE AT LEAST 30 FEET IN LENGTH.
- B. SHORT SKI OR SHOE
- C. TAUT STRING LINE (WIRE) SET TO GRADE.
- D. LASER CONTROL

THE SUBSEQUENT LIFT OF HOT MIX ASPHALT SHALL NOT BE PLACED UNTIL THE PROCEEDING LIFT IS COMPLETED TO FULL WIDTH

ASPHALT JOINTS SHALL FALL ON LINES, SHOULDERS LINES OR MEDIAN LINES, EXCEPT WHERE STATED IN THE PLANS.

WHEN MORE THAN ONE LIFT OF HOT MIX ASPHALT IS BEING PLACED, LONGITUDINAL JOINTS FORMED BY ADJACENT PASSES WITH THE PAVER IN A LIFT SHALL BE OFFSET BY A MINIMUM OF 8" BETWEEN LIFTS.

A TACK COAT IS REQUIRED PRIOR TO THE PLACEMENT OF SUBSEQUENT LIFTS OF HMA. BEFORE PLACEMENT OF THE TACK COAT, THE CONTRACTOR SHALL CLEAN THE ROADWAY AS DIRECTED BY THE ENGINEER. CLEANING SHALL NOT BE MEASURED AND PAID FOR SEPARATELY BUT SHALL BE CONSIDERED INCIDENTAL TO THE WORK.

A 2 INCH BUTT JOINT SHALL BE PROVIDED WHERE NEW ASPHALT PAVEMENT TIES INTO EXISTING ASPHALT PAVEMENT AT ROAD APPROACHES AND DRIVEWAYS. ASPHALT DRIVEWAY TIE INS BEHIND CURB AND GUTTER OR SIDEWALK SHALL BE A MAXIMUM OF 8 PERCENT UNTIL EXISTING GROUND IS MET.

WHERE EXISTING ASPHALT PAVEMENT, CONCRETE PAVEMENT, OR CONCRETE SIDEWALK IS TO BE REMOVED, IT SHALL BE CUT FULL DEPTH TO A NEAT WORK LINE WITH A SAW OR CUTTING WHEEL AS APPROVED BY THE ENGINEER. CUT FACES SHALL NOT REMAIN OVERNIGHT. THIS WORK WILL NOT BE PAID FOR SEPARATELY BUT SHALL BE CONSIDERED SUBSIDIARY TO THE WORK

DEPTH OF MOISTURE - DENSITY CONTROL FOR THIS PROJECT SHALL BE AS FOLLOWS:

- A. FULL DEPTH OF ALL EMBANKMENTS.
- B. BASES OF CUTS AND FILLS 6 INCHES
- C. EXCAVATION REQUIRED FOR COMPACTION OF BASES OF CUTS AND FILLS WILL BE CONSIDERED AS SUBSIDIARY TO THAT OPERATION, AND WILL NOT BE PAID FOR SFPARATFLY

UNLESS OTHERWISE DIRECTED BY THE ENGINEER, THE CONTRACTOR SHALL LIMIT CONSTRUCTION ACTIVITIES TO THOSE AREAS WITHIN THE LIMITS OF DISTURBANCE AND/OR TOES OF SLOPE AS SHOWN ON THE PLANS AND CROSS SECTIONS. ANY DISTURBANCE BEYOND THESE LIMITS SHALL BE RESTORED TO ORIGINAL CONDITION BY THE CONTRACTOR AT THEIR OWN EXPENSE. CONSTRUCTION ACTIVITIES IN ADDITION TO NORMAL CONSTRUCTION PROCEDURES SHALL INCLUDE THE PARKING OF VEHICLES OR FOULPMENT. DISPOSAL OF LITTER, AND ANY OTHER ACTION WHICH WOULD ALTER FXISTING CONDITIONS.

STRUCTURE EXCAVATION, STRUCTURE BACKFILL, CONCRETE COLLAR, AND COUPLING BANDS WILL NOT BE PAID FOR SEPARATELY BUT SHALL BE INCLUDED IN THE COST OF THE PIPE

THE TEMPORARY CONSTRUCTION EASEMENTS ARE LIMITED TO SPECIFIC CONSTRUCTION ITEMS AND THE AREA IS TO BE RETURNED TO EXISTING CONDITION AS SOON AS POSSIBLE. THE AREAS ARE NOT TO BE USED FOR STORAGE OR PARKING WHERE IT WOULD INTERFERE WITH BUSINESS OPERATIONS, ACCESS OR PARKING.

THE HORIZONTAL AND VERTICAL GEOMETRY FOR THE CURB, GUTTER AND SIDEWALK IS SHOWN TO THE LIP OF GUTTER UNLESS OTHERWISE NOTED ON THE PLANS.

A 5-FOOT (10:1 VERTICAL) TAPER SHALL BE USED ON ALL EXPOSED END OF CURB.

AGGREGATE BASE COURSE (CLASS 6) SHOULDER MATERIAL SHALL BE STABILIZED IMMEDIATELY UPON PLACEMENT.

WATER SHALL BE USED AS A DUST PALLIATIVE WHERE REQUIRED. APPLICATION SHALL BE AS DIRECTED BY THE ENGINEER. WATER AS A DUST PALLIATIVE AND ANY OTHER WETTING SHALL BE INCLUDED IN THE WORK AND WILL NOT BE PAID SEPARATELY.

WATER SOURCE USED FOR MOISTURE DENSITY CONTROL SHALL BE THE CONTRACTOR'S RESPONSIBILITY AND SHALL BE FREE OF EXCESSIVE SEDIMENTS OR OTHER CONTAMINANTS THAT MAY BE DETRIMENTAL TO EMBANKMENTS, SUB-BASES, AND BASE COURSE MATERIAL.

DURING CONSTRUCTION ACTIVITIES THE CONTRACTOR SHALL KEEP ALL WORK EQUIPMENT AND MATERIALS WITHIN THE EASEMENT AND/OR RIGHT OF WAY LIMITS.

HE FOLLOWING CLEAR ZONE CRITERIA SHALL BE USED DURING THIS PROJECT: 10 FEET ON HORIZON DRIVE AND G ROAD.

SULFATE RESISTANT CONCRETE FOR THIS PROJECT SHALL BE CLASS 2 (TYPE I—II SULFATE RESISTANT CEMENT). WATER SOLUBLE SULFATE LEVELS WERE ENCOUNTERED IN THE SITE SOILS IN CONCENTRATIONS AS HIGH AS 0.5%.

ALL SLOPES WILL BE ROUGHENED AS DIRECTED BY THE ENGINEER. COSTS ASSOCIATED WITH THIS WORK SHALL BE

EXCAVATION REQUIRED FOR COMPACTION OF BASES OF CUTS AND FILLS WILL BE CONSIDERED AS SUBSIDIARY TO THAT OPERATION AND WILL NOT BE PAID FOR SEPARATELY.

TRAVEL LANES ARE NOT SUBJECT TO SMOOTHNESS INCENTIVE/DISINCENTIVE PAYMENTS. ROADWAY SMOOTHNESS SHALL BE BASED ON THE STRAIGHTEDGE TESTING METHOD AS DESCRIBED IN THE STANDARD SPECIFICATIONS, SECTION 105.

THIS PROJECT WILL NOT BE SUBJECT TO QUALITY INCENTIVE PAYMENTS FOR ASPHALT QUALITY. THIS PROJECT WILL BE SUBJECT TO PRICE REDUCTIONS PER SECTION 105.05 OF THE STANDARD SPECIFICATIONS.

THIS PROJECT WILL NOT BE SUBJECT TO ASPHALT CEMENT COST ADJUSTMENT PAYMENTS FOR ASPHALT CEMENT.

FOR EXTENSION OF EXISTING PIPES, THE CONTRACTOR SHALL FIELD VERIFY ALL SIZES AND FLOW LINE ELEVATIONS PRIOR TO ORDERING MATERIALS. THE CONTRACTOR OR HIS SUBCONTRACTOR SHALL IMMEDIATELY NOTIFY THE ENGINEER WHENEVER FIELD CONDITIONS OR EXISTING TERRAIN WOULD RESULT IN LESS THAN OPTIMAL INSTALLATION OF SAID ITEMS.

CONSTRUCTION, (CONT.)

THE CONTRACTOR SHALL BE REQUIRED TO FIELD VERIFY LENGTHS, DIAMETERS, ELEVATIONS, LOCATIONS, AND THICKNESS BEFORE ORDERING MATERIALS.

NO VERTICAL SLOPES SHALL BE LEFT OVERNIGHT UNPROTECTED. ALL UNPROTECTED VERTICAL SLOPES SHALL BE FLATTENED TO A 4:1 SIDE SLOPE PRIOR TO THE END OF THE WORK DAY, OR AS DIRECTED BY THE ENGINEER.

FINAL STRIPING WILL BEGIN AT A POINT THAT MATCHES THE ADJACENT STRIPING LOCATION AND SPACING.

PREFORMED PLASTIC PAVEMENT MARKING (INLAID) EDGING SHALL BE STRAIGHT AND UNIFORM, AND UNIFORMLY ADHERED TO THE PAVEMENT.

ACCEPTANCE OF CONCRETE PAVEMENT SHALL BE BASED ON COMPRESSIVE STRENGTH.

THE CONTRACTOR WILL BE RESPONSIBLE FOR THE ADJUSTMENT OF ALL VALVE BOXES AND MANHOLES WITHIN THE PROJECT LIMITS. THE CONTRACTOR SHALL NOTIFY THE IMPACTED UTILITY COMPANY AT LEAST 48 HOURS PRIOR TO ANY WORK BEING ACCOMPLISHED.

THE CONTRACTOR WILL BE REQUIRED TO STAKE THE EASEMENT AREAS DURING CONSTRUCTION AT NO ADDITIONAL COST TO THE PROJECT.

ANY EXISTING SIGNS OR SIGNS TO BE RESET THAT ARE DAMAGED BY THE CONTRACTOR SHALL BE REPAIRED OR REPLACED AT NO ADDITIONAL COST TO THE PROJECT.

MAGNESIUM CHLORIDE SOLUTION SHALL BE USED AS A SEAL COAT WHERE REQUIRED. LOCATIONS SHALL BE ORDERED AND DIRECTED BY THE ENGINEER.

THIS PROJECT IS DESIGNATED AS NON-SIGNIFICANT.

UTILITIES

THE CONTRACTOR SHALL PROTECT EXISTING UTILITIES BY USING EVERY REASONABLE MEANS POSSIBLE, INCLUDING FIELD LOCATION OF THE UTILITY. REPAIR OF DAMAGE TO THE EXISTING UTILITIES DURING CONSTRUCTION SHALL BE THE RESPONSIBILITY OF THE CONTRACTOR SHALL DOCUMENT THE CONDITION OF EXISTING UTILITIES (VISIBLE FACILITIES) WITH THE ENGINEER AND UTILITY REPRESENTATIVES PRIOR TO COMMENCING CONSTRUCTION ACTIVITIES.

EXISTING UTILITY LINES AS SHOWN ON THE PLAN SHEETS ARE PLOTTED FROM THE BEST AVAILABLE INFORMATION, (ASCE STANDARD QUALITY LEVEL B).

UTILITY WORK NOT COMPLETED PRIOR TO THE START OF THE CONTRACTOR'S OPERATIONS WILL REQUIRE COORDINATION WITH CONTRACT WORK IN ACCORDANCE WITH SUBSECTION 105.11 OF THE STANDARD SPECIFICATIONS. THE CONTRACTOR SHALL COORDINATE AND COOPERATE WITH UTILITY OWNERS IN THEIR REMOVAL, ADJUSTMENT, AND/OR RELOCATION OPERATIONS SO THAT THE UTILITY WORK CAN BE ACCOMPLISHED WITHOUT IMPACTING THE CONSTRUCTION SCHEDULE.

THE CONTRACTOR SHALL COMPLY WITH ARTICLE 1.5 OF TITLE 9, CRS ("EXCAVATION REQUIREMENTS") WHEN EXCAVATING OR GRADING IS PLANNED IN THE AREA OF UNDERGROUND UTILITY FACILITIES. THE CONTRACTOR SHALL NOTIFY ALL AFFECTED UTILITIES AT LEAST TWO (2) BUSINESS DAYS, NOT INCLUDING THE ACTUAL DAY OF NOTICE, PRIOR TO COMMENCING SUCH OPERATIONS. THE CONTRACTOR SHALL CONTACT THE UTILITY NOTIFICATION CENTER OF COLORADO (UNCC) AT 811 OR 1-800-922-1987, TO HAVE LOCATIONS OF UNCC REGISTERED LINES MARKED BY MEMBER COMPANIES. ALL OTHER UNDERGROUND FACILITIES SHALL BE LOCATED BY CONTACTING THE RESPECTIVE OWNER. UTILITY SERVICE LATERALS SHALL ALSO BE LOCATED PRIOR TO BEGINNING EXCAVATION OR GRADING.

 $\verb|LOCATION| \ \ \text{AND} \ \ \text{NOTIFICATION} \ \ \text{OF} \ \ \text{BOTH} \ \ \text{UNCC} \ \ \text{MEMBER} \ \ \text{AND} \ \ \text{NON-MEMBER} \ \ \text{UTILITIES} \ \ \text{IS} \ \ \text{THE CONTRACTOR'S RESPONSIBILITY}.$

IT IS SUGGESTED THAT THE CONTRACTOR INITIATE A REQUEST TO XCEL ENERGY, CENTURYLINK AND CHARTER COMMUNICATIONS FOR ANY CONSTRUCTION RELATED TO TEMPORARY ELECTRICAL POWER AND TELEPHONE SERVICE AS SOON AS POSSIBLE.

THE CONTRACTOR SHALL BE RESPONSIBLE FOR VERIFYING THE LOCATION AND DEPTH OF ALL EXISTING UTILITIES AT PIPES, CULVERTS, CBC'S, AND OTHER AREAS OF EXCAVATION AS NECESSARY TO ENSURE THE UTILITIES WILL NOT BE IMPACTED.

POTHOLING OF AN AREA SHALL TAKE PLACE 10 DAYS PRIOR TO COMMENCEMENT OF CONSTRUCTION OPERATIONS IN THAT AREA.

- THE CONTRACTOR SHALL:

 A. NOTIFY UTE WATER, CITY OF GRAND JUNCTION WATER AND SEWER, AND ALL CUSTOMERS AFFECTED BY
- OUTAGE OF WATER DURING CONSTRUCTION AT LEAST 48 HOURS PRIOR TO DISRUPTION OF SERVICE.

 B. NOTIFY GRAND JUNCTION POLICE DEPARTMENT, GRAND JUNCTION FIRE DEPARTMENT, GRAND JUNCTION DEPARTMENT OF
- PUBLIC WORKS, MESA COUNTY SHERIFF'S OFFICE, MESA COUNTY PUBLIC WORKS, COLORADO STATE PATROL, UTE WATER CONSERVANCY DISTRICT, UNITED STATES POSTAL SERVICE, GRAND VALLEY TRANSIT, AND FIRST STUDENT BUS COMPANY OF ALL STREET CLOSINGS AND EXISTING FIRE HYDRANTS TO BE TAKEN OUT OF SERVICE AT LEAST 48 HOURS PRIOR TO THE START OF CONSTRUCTION AND UPDATED ON A BI-WEEKLY BASIS.

WHEN EXCAVATING BELOW EXISTING WATER OR SANITARY SEWER LINES THE CONTRACTOR SHALL SUBMIT, FOR APPROVAL, THE METHOD BY WHICH EXISTING WATER OR SANITARY SEWER LINES SHALL BE PROTECTED AND SUPPORTED.

THE STATION POINT AND ELEVATION SHOWN ON THE PLANS FOR THE STANDARD STORM INLET AND MEDIAN INLET IS LOCATED AT THE CENTER OF THE INLET BOX. THE STATION POINT OF ALL OTHER DRAINAGE, IRRIGATION, AND SANITARY SEWER STRUCTURES IS LOCATED AT THE CENTER POINT OF THE STRUCTURE AS WELL.

ESTIMATED QUANTITIES

FOR PRELIMINARY PLAN QUANTITIES, THE FOLLOWING RATES OF APPLICATION WERE USED:

Region 3

DILUTED EMULSIFIED ASPHALT FOR TACK COAT SHALL CONSIST OF 1 PART EMULSIFIED ASPHALT AND 1 PART WATER.

ESTIMATED QUANTITIES, (CONT.)

IT IS ESTIMATED THAT THE FOLLOWING SHALL BE REQUIRED FOR THIS PROJECT, AS DIRECTED BY THE PROJECT ENGINEER FOR MISCELLANEOUS WORK:

- (201-00000) CLEARING AND GRUBBING 1 LS
- (203-01500) BLADING 40 HOURS
- (203-01597) POTHOLING 10 HOURS - (203-02330) LABORER - 100 HOURS
- (209-00600) DUST PALLIATIVE (MAGNESIUM CHLORIDE) 1000 GALLONS
- (250-00010) ENVIRONMENTAL HEALTH AND SAFETY MANAGEMENT 1 LS
- (250-00050) MONITORING TECHNICIAN 20 HOURS
- (250-00110) HEALTH AND SAFETY OFFICER 20 HOURS
- (250-00200) MATERIAL HANDLING (STOCKPILE) 50 CY
- (250-00220) HAZARDOUS WASTE DISPOSAL 50 CY - (620-00002) FIELD OFFICE (CLASS 2) - 1 EA
- (620-00012) FIELD LABORATORY (CLASS 2) 1 EA
- (620-00020) SANITARY FACILITY 1 EA
- (625-00000) CONSTRUCTION SURVEYING 1 LS
- (625-00001) CONSTRUCTION SURVEYING (HOURLY) 10 HOURS
- (626-00000) MOBILIZATION 1 LS
- (626-01000) PUBLIC INFORMATION SERVICES 1 LS

PROOFROLLING WILL BE REQUIRED FOR THIS PROJECT AND WILL BE INCLUDED IN THE COST OF THE WORK.

CLEARING AND GRUBBING SHALL INCLUDE REMOVAL OF ALL TREES, LOGS, LIMBS, BRUSH, BUSHES, GROUND COVER, SOD, LANDSCAPING ITEMS, AND TRASH, ETC. AS SHOWN IN THE PLANS OR REQUIRED BY THE WORK TO AN OFF SITE LOCATION, UNLESS SHOWN ON THE PLANS TO BE PROTECTED. THIS WORK WILL BE PAID FOR AS 201-00000 CLEARING AND GRUBBING.

THE MOTOR GRADER USED FOR WORK TO BE PAID AS 203-01500 BLADING HOURS SHALL BE A 130 - 140 HORSEPOWER

AGGREGATE BASE COURSE (CL. 6) SHOWN TO BE PLACED UNDER CONCRETE CURBS, GUTTERS, SIDEWALKS, DRAINAGE PANS, INTERSECTION FILLETS, DRIVEWAY SECTIONS, AND CURB RAMPS IS DESIGNATED AS "AGGREGATE BASE COURSE (CLASS 6)" AND WILL BE MEASURED AND PAID FOR SEPARATELY.

ASPHALT MILLINGS MAY BE SUBSTITUTED FOR ABC CLASS 6 AS APPROVED BY PROJECT ENGINEER. ANY USE OF ASPHALT MILLINGS THAT DOES NOT MEET THE APPROVED REQUIREMENTS SHALL BE REMOVED AND REPLACED AT THE CONTRACTOR'S EXPENSE.

<u>ENVIRONMENTAL</u>

THE CONTRACTOR SHALL BE RESPONSIBLE FOR THE ACCEPTANCE AND CONTROL OF ALL SURFACE AND SUBSURFACE DRAINAGE AND GROUNDWATER ENTERING THE PROJECT AREA. THE CONTRACTOR IS RESPONSIBLE FOR PROVIDING DEWATERING IF NEEDED AT NO ADDITIONAL COST TO THE PROJECT. DEWATERING METHODS SHALL BE APPROVED BY THE ENGINEER. THE CONTRACTOR SHALL OBTAIN A CONSTRUCTION DEWATERING PERMIT FROM THE COLORADO DEPARTMENT OF PUBLIC HEALTH AND ENVIRONMENT. THE PERMIT WILL NOT BE PAID FOR SEPARATELY BUT SHALL BE INCLUDED IN THE WORK.

SEE STORMWATER MANAGEMENT PLAN FOR EROSION CONTROL MEASURES TO BE USED DURING CONSTRUCTION.
WHENEVER SEDIMENT IS TRANSPORTED ONTO A PUBLIC ROAD, THE ROAD SHALL BE CLEANED AT THE END OF EACH DAY.
SEDIMENT SHALL BE REMOVED FROM ROADS BY SHOVELING OR SWEEPING AND BE TRANSPORTED TO A CONTROLLED
SEDIMENT DISPOSAL AREA. STREET WASHING SHALL NOT BE ALLOWED. STREET SWEEPING METHODS/OPERATIONS SHALL BE
APPROVED BY THE ENGINEER PRIOR TO COMMENCEMENT OF SWEEPING OPERATIONS. OPEN STYLE MECHANICAL BROOM WILL NOT BE
ALLOWED FOR STREET SWEEPING.

ALL STAGING AREAS AND EQUIPMENT SHALL BE KEPT OUTSIDE WETLAND AND RIPARIAN AREAS AND SHALL BE LOCATED AT LEAST 100 FEET FROM ANY WATERCOURSE.

THE CONTRACTOR SHALL ADDRESS LOCAL DRAINAGE DURING EACH PHASE OF CONSTRUCTION. THIS WORK WILL NOT BE PAID SEPARATELY BUT SHALL BE CONSIDERED SUBSIDIARY TO THE WORK.

STORM WATER MANAGEMENT WILL REQUIRE MULTIPLE SEEDING AND MULCHING OPERATIONS. THE COST FOR SEEDING IN MULTIPLE OPERATIONS SHALL BE INCLUDED IN THE COST OF SEEDING AND MULCHING.

ANY DEWATERING WILL NOT BE PAID FOR SEPARATELY, BUT SHALL BE INCIDENTAL TO THE PROJECT.

DURING ALL SUBSURFACE ACTIVITIES, WORKERS SHALL BE ALERT FOR VISUAL AND OLFACTORY SIGNS OF CONTAMINATION. IF CONTAMINATION IS ENCOUNTERED, WORK SHALL STOP AND PROCEDURES ESTABLISHED IN THE CDOT 250 SPEC SHALL BE FOLLOWED. ANY CONTAMINATED SOILS OR LANDFILL MATERIAL SHALL BE PROPERLY HANDLED AND SAMPLED PRIOR TO DISPOSAL.

KEEP CONSTRUCTION CONCENTRATED TO AS SMALL OF AN AREA AS POSSIBLE AND ONLY USE PREVIOUSLY DISTURBED AREAS FOR STOCKPILING MATERIALS, PARKING, AND/OR STAGING.

STORMWATER CONSTRUCTION PERMIT IS REQUIRED. THE CITY WILL ACQUIRE THE PERMIT AND TRANSFER THE PERMIT TO THE CONTRACTOR.

IF VEGETATION REMOVAL CONSISTING OF LARGE TREES OR SHRUBS OCCURS BETWEEN APRIL 1-AUG 31, SPEC 240 CONTRACTOR'S BIOLOGIST SHALL BE INCLUDED TO PROTECT MIGRATORY BIRD SPECIES.

PROJECT UTILITY CONTACTS

CHARTER COMMUNICATIONS	MARK KOSTELECKY	970-245-8750
CITY OF GRAND JUNCTION (SANITATION)	LEE COOPER	970-256-4155
CITY OF GRAND JUNCTION (PERSIGO SEWER SYSTEMS)	LARRY BROWN	970-256-4168
CITY OF GRAND JUNCTION (FIBER OPTIC)	SCOTT HOCKINS	970-244-1540
CITY OF GRAND JUNCTION (IRRIGATION SPRINKLERS)	RANDY COLEMAN	970-254-3821
CITY OF GRAND JUNCTION (TRAFFIC/SIGNALS)	TOM LANAM	970-244-1573
CITY OF GRAND JUNCTION (STORM DRAINAGE)	BILL UBERSOX	970-640-2982
CENTURY LINK COMMUNICATIONS	CHRIS JOHNSON	970-244-4311
UTE WATER	JUSTIN BATES	970-242-7491
XCEL ENERGY (GAS)	SARAH DARRICAU	970-244-2656
XCEL ENERGY (ELECTRIC)	BRENDA BOES	970-244-2664

XCEL ENERGY (EL	ECTRIC)	BRENDA BOES 970-244-266	4
As Constructed	HORIZON DR AND (G RD ROUNDABOUT	Project No./Code
No Revisions:	GENERAL N	SHE M555-034	
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	Detailer: JCS	Numbers	
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Grand Junction

333 WEST AVE, BLDG C Grand Junction, CO, 81501
Phone: 970-244-1554

Colorado Department of Transportation

606 South 9th Street
Grand Junction, CO, 81501
Phone: 970-683-6351 FAX: 970-683-6369

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Book	Page	Sheet	ltem No.	Contract item	Offic	Plan	As Constr.
			201-00000	Clearing and Grubbing	LS	1	
			202-00010	Removal of Tree	EA	1	
				Removal of Inlet	EA	5	
				Removal of Manhole	EA	2	
				Removal of Pipe	LF	175	
			202-00090	Removal of Delineator	EA	1	
			202-00190	Removal of Concrete Median Cover Material	SY	89	
			202-00200	Removal of Sidewalk	SY	424	
			202-00201	Removal of Curb	LF	555	
			202-00202	Removal of Gutter	LF	36	
			202-00203	Removal of Curb and Gutter	LF	855	
			202-00204	Removal of Curb, Gutter and Sidewalk	LF	1009	
			202-00206	Removal of Concrete Curb Ramp	SY	32	
			202-00210	Removal of Concrete Pavement	SY	8	
			202-00220	Removal of Asphalt Mat	SY	730	
			202-00240	Removal of Asphalt Mat (Planing)	SY	6921	
			202-00250	Removal of Pavement Marking	SF	846	
			202-00700	Removal of Light Standard	EA	2	
			202-00705	Removal of Light Standard Foundation	EA	2	
				Removal of Pull Box	EA	7	
			202-00840	Removal of Traffic Signal Pole	EA	4	
			202-00848	Removal of Traffic Signal Controller and Cabinet	EA	1	
			203-00010	Unclassified Excavation (Complete In Place)	CY	3662	
				Muck Excavation	CY	1103	
			203-01597	Potholing	HOUR	10	
				Structure Backfill (Class 1)	CY	15	
			207-00205		CY	376	
				Stockpile Topsoil	CY	376	
				Erosion Log (12 inch)	LF	260	
				Aggregate Bag	LF	50	1
				Prefabricated Concrete Washout Structure (Type 1)	EA	1	1
				Storm Drain Inlet Protection (Type II)	EA	11	<u> </u>
				Prefabricated Vehicle Tracking Pad	EA	4	
				Removal and Disposal of Sediment (Labor)	HOUR	20	
				Removal and Disposal of Sediment (Equipment)	HOUR	20	
				Sweeping (Sediment Removal)	HOUR	60	
				Removal of Trash	HOUR	20	†
				Erosion Control Management (ECM)	DAY	60	†
			208-00300	Temporary Berms	LF	400	1
				Dust Palliative (Magnesium Chloride)	GAL	1000	
				Reset Ground Sign	EA	14	
				Relay Sprinkler System	LS	1	
				Adjust Manhole	EA	7	
				Modify Manhole	EA	1	+
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COLORADO Phone: 970-244-15				Γ

Colorado Department of Transportation

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Region 3

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			210-04020	Modify Inlet	EA	1	
			210-04050	Adjust Valve Box	EA	2	
			212-00706	Seeding (Native) Drill	AC	0.26	
			212-00050	Sod	SF	60	
			213-00065	Mulching (Weed Free Straw)	AC	0.26	
			213-00061	Mulch Tackifier	LB	52	
			213-00440	Metal Landscape Border (1/8 x 4 Inch)	LF	946	
			213-00700	Landscape Boulder (Small 3'x2'x2')	EA	91	
			213-00705	Landscape Boulder (Large, 3'x4'x2')	EA	1	
			213-00705	Metal Plants (Special)	EA	12	
			214-00000	Landscape Maintenance	LS	1	
			214-00215	Deciduous Tree (1.5 Inch Caliper)	EA	1	
			214-00350	Deciduous Shrub (5 Gallon Container)	EA	27	
			214-00506	Evergreen Tree (6 Foot) (Ball and Burlap)	EA	2	
			214-00650	Evergreen Shrub (5 Gallon Container)	EA	10	
			214-00910	Perennials (1 Gallon Container)	EA	176	
				Wildlife Biologist	HOUR	40	
				Hazardous Waster Disposal (Radioactive)	CY	35	
				Aggregate Base Course (Class 3)	TON	1980	
				Aggregate Base Course (Class 6)	TON	3856	
				Reconditioning	SY	7468	
				Hot Mix Asphalt (Patching) (Asphalt)	SY	20	
			403-34741		TON	147	
				Emulsified Asphalt (Slow-Setting)	GAL	80	
				Concrete Pavement (6 Inch)	SY	138	
				Concrete Pavement (8 Inch)	SY	80	
				Concrete Pavement (11 Inch)	SY	5707	
				Concrete Pavement (11 Inch) (Special)	SY	475	
				Concrete Pavement (11 Inch) (Fast Track)	SY	284	
				Geotextile (Separator) (Class 2)	SY	1650	
				Geogrid Reinforcement	SY	1650	1
				12 Inch Plastic Pipe	LF	264	
				Inlet Special (5 Foot)	EA	2	
				Inlet Special (10 Foot)	EA	2	+
				Manhole Slab Base (5 Foot)		2	
				Manhole Slab Base (10 Foot)	EA EA	3	+
				8 Inch Plastic Pipe Sewer (Polyvinyl Chloride)	LF	42	1
							1
		-		Concrete Sidewalk	SY	1004	+
				Concrete Curb Ramp	SY	139	1
				Detectable Warnings	SF	316	-
				Curb Type 2 (Section B)	LF	610	
			609-21023	Curb and Gutter Type 2 (Section II-B) (Special)	LF	1436	

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Grand Junction	333 WEST AVE, BLDG C Grand Junction, CO, 81501	
COLORADO	Phone: 970-244-1554	

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			609-21110	Curb and Gutter Type 2 (Section I-B) (Special)	LF	2007	
			610-00026	Median Cover Material (6 Inch Patterned Concrete)	SF	9023	
			610-00100	Median Edging (Pattern Concrete)	LF	445	
			612-00041	Delineator (Flexible) (Type I)	EA	1	
			613-01200	2 Inch Electrical Conduit (Plastic)	LF	2770	
			613-01201	2 Inch Electrical Conduit (Plastic) (Special)	LF	1157	
			613-01201	3/4 Inch Electrical Conduit (Plastic) (Special)	LF	100	
			613-07002	Type Two Pull Box	EA	35	
			613-07003	Type Three Pull Box	EA	3	
			613-10000	Wiring	LS	1	
			613-30001	Light Standard and Luminaire Single Post Top (Pedestrian)	EA	8	
			613-30002	Light Standard and Luminaire Dual Head (Pedestrian)	EA	8	
			613-40012	Light Standard Foundation Special	EA	16	
			613-50106	Lighting Control Center (Special)	EA	1	
			614-00011	Sign Panel (Class I)	SF	454.4	1
				Sign Panel (Class II)	SF	48	
				Steel Sign Support (2-inch Round)(Post and Socket)	EA	44	1
				Steel Sign Support (2-1/2 Inch Round NP-40)(Post & Slipbase)	EA	17	+
				Rectangular Rapid Flashing Beacon	EA	17	
				Traffic Signal Pedestal Pole Steel	EA	1	+
				Field Office (Class 2)	EA	1	+
				Field Laboratory (Class 2)	EA	1	+
				Sanitary Facility	EA	1	+
				Detour Pavement	SY	1700	+
				Drip Emitter Tubing	LF	1007	+
				Drip Emitter	EA	452	+
				1/2 Inch Flush Unit	EA	55	+
				1-1/2 Inch Plastic Pipe	LF	1420	+
				1 Inch Plastic Pipe	LF	1343	+
				4 Inch Plastic Pipe (Irrigation/Sleeve)	LF	240	+
				6 Inch Plastic Pipe (Irrigation/Sleeve)	LF	370	+
				1 Inch Backflow Preventor	EA	1	+
				1 Inch Pressure Reducing Valve	EA	1	+
				1 Inch Strainer	EA	1	+
				3/4 Inch Drain Valve	EA	1	+
				1 Inch Automatic Control Valve	EA	5	+
				1-1/2 Inch Automatic Control Valve	EA	1	+
				2-wire Control, including decoders, grounding (Special)	LS	1	+
				Power Source Wire	LF	130	+
				3/4 Inch Quick Coupler Valve		5	+
				•	EA		+
			623-04520	1-1/2 Inch Ball Valve (Special)	EA	5 5	+
			023-06900	Valve DUX	EA] 3	

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COLORADO Phone: 970–244–1554	

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Void: SUMM	Detailer: JCS ARY OF APPROXIMATE QUANTITIES		Sheet Number 10

Index			Contract	Contract Itom	Unit	Projec	ct Total
Book	Page	Sheet	ltem No.	Contract Item	Onit	Plan	As Constr.
			623-07601	1 Inch Flow Sensor (Special)	EA	1	
			623-08148	60 Station Automatic Controller (Special)	EA	1	
			623-09900	Sprinkler System	LS	1	
			625-00000	Construction Surveying	LS	1	
			626-00000	Mobilization	LS	1	
			626-01000	Public Information Services	LS	1	
			627-00013	Pavement Marking Paint (High Build)	GAL	1	
			627-00008	Modified Epoxy Pavement Marking	GAL	11	
			627-02010	Preformed Plastic Pavement Marking (Type II)	SF	973	
			627-30407	Preformed Thermoplastic Pavement Marking (Word-Symbol) (Special)	SF	776	
			627-30411	Preformed Thermoplastic Pavement Marking (Xwalk-Stop Line) (Special)	SF	1048	
			630-00000	Flagging	DAYS	90	
				Traffic Control Inspection	DAYS	30	
			630-00012	Traffic Control Management	DAYS	80	
			630-80336	Barricade (Type 3 M-B) (Temporary)	EA	12	
			630-80341	Construction Traffic Sign (Panel Size A)	EA	126	
			630-80342	Construction Traffic Sign (Panel Size B)	EA	44	
			630-80343	Construction Traffic Sign (Panel Size C)	EA	8	
			630-80344	Construction Sign Panel (Special)	SF	112	
			630-80355	Portable Message Sign Panel	EA	4	
			630-80357	Advance Warning Flashing or Sequencing Arrow Panel (B Type)	EA	5	
			630-80360	Drum Channelizing Device	EA	140	
			630-80364	Drum Channelizing Device (With Light) (Steady)	EA	20	
			630-80370	Barrier (Temporary)	LF	200	
			630-80380	Traffic Cone	EA	20	
			630-80390	Channelizing Device (Special)	EA	90	
				Impact Attenuator (Temporary)	EA	2	
				Night Work Lighting	DAY	30	
				F/A On The Job Trainee	HOUR	640	
			700-70025	F/A Quality Incentive Payment	FA	5000	
			700-70018	F/A Roadway Smoothness Incentive	FA	1000	
				F/A Asphalt Cement Cost Adjustment	FA	2000	
				F/A Fuel Cost Adjustment	FA	2500	
				F/A Erosion Control	FA	2500	
			700-70111	F/A Project First Program	FA	1000	
				F/A Concrete Pavement Incentive	FA	50000	
				F/A Minor Contract Revisions	FA	115600	

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File Name: SUMMARY OF APPI	ROXIMATE QUANTITIES.dwg	
Horiz. Scale: AS SHOWN	Vert. Scale: NA	
Unit Information: City of GJ		
Grand Junction	333 WEST AVE, BLDG C Grand Junction, CO, 81501	

	Sheet Revisions	
Date:	Comments	Init.

Colorado Department of Transportation 606 South 9th Street Grand Junction, CO, 81501 Phone: 970–683–6351 FAX: 970–683–6369

Region 3

	As Constructed	HORIZON DR A SUMMAR				Project No./Cod	е
	No Revisions:	0011111111111	JANTITIE		o,	SHE M555-034	
	Revised:	Designer: J0	CS Sti	ructure		23652	
ŀ		Detailer: J0	CS Nu	ımbers			
	Void: SUMMA	ARY OF APPROXIMATE QUA	ANTITIES SI	ubset She	eets: X of X	Sheet Number 11	

SUMMARY OF EARTHWORK QUANTITIES

	INDEX			PROJEC	T TOTAL
Book	Page	Sheet		PROJEC	ITOTAL
			203-00010 UNCLASSIFIED EXCAVATION (CIP)	CU. YD.	As Const.
			ON SITE (QUANTITY CALCULATED FROM CIVIL3D - TIN SUBTRACTION)		
			UNCLASSIFIED EXCAVATION ADDITION OF ROADWAY CROSS SECTIONS PRISM DEDUCT ASPHALT AND CONCRETE REMOVAL ITEMS	820 4359 1400	
			TOTAL FOR PAY QUANTITIES	3779	
			EMBANKMENT MATERIAL (CIP) (FOR INFORMATION ONLY)	CU. YD.	
			QUANTITY CALCULATED FROM CIVIL3D - TIN SUBTRACTION EMBANKMENT	920	
			TOTAL	920	

X	EARTHWORK QUANTITIES BALANCE	DDC IEC	TIOTAL
e Sher	(FOR INFORMATION ONLY)	PROJEC	TIOTAL
		CU. YD.	As Const.
	Total Unclassified Excavation Total Embankment (net) EMBANKMENT TIMES COMPACTION FACTOR 1.15 Excess Material leftover (Material to be hauled away from site by Contractor)	3779 920 1058 2721	
_	EX ge Shee	Total Unclassified Excavation Total Embankment (net) EMBANKMENT TIMES COMPACTION FACTOR 1.15 Excess Material leftover	Total Unclassified Excavation 3779 Total Embankment (net) 920 EMBANKMENT TIMES COMPACTION FACTOR 1.15 1058 Excess Material leftover 2721

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File Name: SUMMARY OF EARTHWORK	QUANTITIES.dwg	Date:	Comments	Init.
Horiz. Scale: AS SHOWN	Vert. Scale: NA			
Unit Information: City of GJ	Unit Leader Initials: LF			
Grand Junction	333 WEST AVE, BLDG C Grand Junction, CO, 81501			
COLORADO	Phone: 970-244-1554			

Colorado Department of Transportation

606 South 9th Street
Grand Junction, CO, 81501
Phone: 970-683-6351 FAX: 970-683-6369

As Constructed	HORIZON DR AND (Summary of	G RD ROUNDABOUT F FARTHWORK	Project No./Code
No Revisions:]	TIES - 1	SHE M555-034
Revised:	Designer: JCS	Structure Numbers	23652
Void:	Detailer: JCS Sheet Subset: SMAY GERHAX QUINES	Subset Sheets: X of X	Sheet Number 12

TABULATION OF REMOVALS (Section #1)

STATION	REM	2-00010) OVAL OF TREE	(202-0001 REMOVA OF INLET	AL F	202-00021) REMOVAL OF MANHOLE	(202-) (OPEN REMOVAL	(202-) (REMC		(202-) (OPEN REMOVAL	(202-) (OPE REMOVAI	REN	02-00035) 1OVAL OI PIPE	(202-) REM	(OPEN	REMO	00090) VAL OF EATOR	(202-) (0 REMO	OPEN DVAL	REMO	00190) VAL OF TE MEDIAN MATERIAL	(202-) (OPEN REMOVAL	(202-0 REMOV SIDEV	AL OF	(202-00201) REMOVAL OF CURB	(202-00202) REMOVAL OF GUTTER	COMMENTS
		EA	EA		EA	UNIT	UN		UNIT	EA		LF		NIT		A	UNI			SY	UNIT	S		LF	LF	
	Plan	As Const	Plan As Co	onst Pla	an As Const	Plan As Cons	t Plan As	s Const P	Plan As Const	Plan As Con	nst Plan	As Cons	st Plan	As Const	Plan A	As Const	Plan As	Const	Plan	As Const	Plan As Const	Plan A	s Const	Plan As Const	Plan As Const	
HORIZON DR																										
58+89, 48' LT TO 60+86, 59' LT																						229				N SIDE HORIZON W OF INT
61+79, 69' LT	1																					20				AZTECAS
61+63, 66' LT TO 61+88, 44' LT																						26				N CURB RETURN
61+86 TO 63+00																								232		BOTH SIDES MEDIAN
61+86 TO 63+00							\vdash												39							MEDIAN
61+90, 4' RT															1											AT BULLNOSE
61+87, 69' LT TO 62+60, 62' LT																								104		AZTECAS - HORIZON
62+29, 46' LT TO 62+29 67' LT																						10				AZTECAS - HORIZON
59+20, 48' RT TO 61+17, 69' RT																						120				S SIDE HORIZON W OF INT
61+78, 63' RT TO 61+98, 42' RT																						24				E CURB RETURN
62+92, 49' RT TO 63+00, 42' RT																						5				GVT BUS STOP PAD
,																										
G Road																										
- 11000																										
67+43, 34' LT																						5				SIGNAL CABINET PAD
67+08, 54' LT TO 67+39, 55' LT																									36	AZTECAS
67+06, 35' LT TO 67+48, 54' LT																								63	30	AZTECAS
07+00, 33 E1 10 07+48, 34 E1																								03		AZILOAS
HORIZON DR																										
60+96, 18' LT TO 62+03, 38' LT											110															EV CD DIDE (D1)
			1				-				110															EX. S.D. PIPE (R1)
62+03, 38' LT			1																							EX INLET (R2))
27 1/2 ROAD																										
68+88, 9' RT			1																							EX INLET (R7)
68+79, 48' LT			1																							EX INLET (R8)
HORIZON DR																										
62+02, 6' RT			1																							EX INLET (R3)
62+02, 6' RT TO 62+05, 35' RT											30															EX. S.D. PIPE (R4)
62+05, 35' RT			1																							EX INLET (R5)
62+05, 35' RT TO 61+95, 65' RT											35															EX. S.D. PIPE (R6)
52.00, 00 KT 10 01100, 00 KT											- 33											_				EX. C.D. I II E (NO)
27 1/2 ROAD												+	+									_				
ZI IIZ KOAD																										
60.44 20 DT				1	Di																					EV CCMIT (D4)
69+11, 20' RT				1																						EX SSMH (R1)
HORIZON DR							\perp						\perp													
63+00, 3' RT TO 63+78, 4' RT																								78		N SIDE MEDIAN HOR DR
63+00 TO 64+40											\perp								50							MEDIAN
63+00, 7' RT TO 63+78 8' RT																								78		S SIDE MEDIAN HOR DR
63+00, 50' RT TO 63+11, 50' RT																						5				GVT BUS STOP PAD
PROJECT TOTAL	1		5	1		0	0		0	0	175		0		1		0		89		0	424		555	36	

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Jnit Information: City of GJ Unit Leader Initials: LF			
Grand Junction 333 WEST AVE, BLDG C Grand Junction, CO, 816 Phone: 970-244-1554			
COLORADO Phone: 970–244–1554			

Colorado Department of Transportation

606 South 9th Street
Grand Junction, CO, 81501
Phone: 970-683-6351 FAX: 970-683-6369

Region 3 KC

As Constructe	d HORIZON D	OR AND (LATION (G RD F	NOVALS	BOUT	Project No.,	'Code
No Revisions:	1/100	LATION	1	OVALS		SHE M555-0	34
Revised:	Designer:	JCS	Structure			23652	
	Detailer:	JCS	Numbers				
Void:	FABULATION OF REMOVAL	S	Subset Sh	ieets:	X of X	Sheet Number	13

										JLATION C			(000.00	···-,	I		I						
STATION	REMOVA	00203) L OF CURB SUTTER	REMOVAL GUTT	00204) L OF CURB, ER AND WALK	(202-00206) REMOVAL OF CONCRETE CURB RAMP	REMO	-00210) DVAL OF ICRETE EMENT	(202-00220) REMOVAL OF ASPHALT MAT	REMO ASPHA	00240) VAL OF LT MAT .NING)	(202-0 REMO\ PAVEI MARI	/AL OF MENT	REMO	-00700) DVAL OF STANDARD	(202-007 REMOVAL OF STANDA FOUNDAT	LIGHT RD	(202-00827) REMOVAL OF PULL BOX	REM TRAFF	2-00840) IOVAL OF FIC SIGNAL POLE	REMOVAL SIGNAL C	2-00848) LOF TRAFFIC CONTROLLER CABINET	(250-00224) HAZARDOUS WASTE DISPOSAL (RADIOACTIVE)	COMMENTS
		F		LF	SY	_	SY	SY		SY	S			EA	EA		EA		EA		EA	CY	
HORIZON DR	Plan	As Const	Plan	As Const	Plan As Const	Plan	As Const	Plan As Const	Plan	As Const	Plan	As Const	Plan	As Const	Plan A	s Const	Plan As Const	Plan	As Const	Plan	As Const	Plan As Const	
HORIZON DR																							
58+78 TO 63+00									4946														HORIZON, G, AND 27
									4940														RDWY
58+89, 36' LT TO 60+93, 60' LT	228																						N SIDE HORIZON
60+86, 42' LT					8																		W CURB RETURN
59+63, 47' LT													1		1								
59+65, 46' LT																	1						
60+77, 44' LT																		1					W. COR. INTERSECTION
60+80, 48' LT																	1						
61+56, 65' LT TO 61+88, 37'LT	45																						N CURB RETURN
61+66, 74' LT															 					1			N CURB RETURN
61+70, 48' LT			-	1	8		-														1		N CURB RETURN
61+73, 61' LT	-		-														1	-			1		N CURB RETURN
61+77, 55' LT																		1			1		N CURB RETURN
61+88, 37' LT TO 63+00, 36'LT			106										-										N SIDE HORIZON
61+44, 176' LT TO 62+60, 63' LT								450															REM ASPH AZTECA
								V -0															PARKING ENTIREL
58+78, 25' RT TO 62+73, 8' RT	12 FEE																					600	ANTICIPATED
59+17, 36' RT TO 61+20, 68' RT	212																						S SIDE HORIZON
61+04, 62' RT																		1					S CURB RETURN
61+10, 68' RT																	1						S CURB RETURN
61+12, 56' RT					8																		S CURB RETURN
61+72, 64' RT TO 61+99, 35' RT	43																						E CURB RETURN
61+83, 47' RT					8																		E CURB RETURN
61+90, 53' RT																		1					E CURB RETURN
61+91, 61' RT																	1						E CURB RETURN
61+98, 42' RT TO 63+00, 44' RT			108																				S SIDE HORIZON
G Rd																							
66+22, 22' LT TO 67+49, 24' LT			138																				E SIDE OF G ROAL
66+52, 29' LT TO 66+50, 42' LT	13																						W SIDE C. CLUB DW
66+76, 29' LT TO 66+76 70' LT	81																						BETWEEN CC AND AZ
66+98, 30' LT TO 67+07, 35'LT	54																						AZTECAS
66+33, 34' RT TO 67+45, 32' RT			100																				W SIDE OF G ROA
27 1/2 RD																							
				1																			
68+69, 45' LT TO 69+50, 45' LT	1		60																				E SIDE OF 27 1/2 F
68+70, 70' LT AND 69+12, 63' LT	1					6																	2 SMALL PADS
68+72, 56' LT						3											1						E SIDE OF 27 1/2
68+80, 10' RT TO 69+50, 12' RT			75				-								 		'	-			1		W SIDE OF 27 1/2
69+12, 20' RT	+		75			2																	SMALL PAD W SID
00+12, 20 KT																							OWALL PAD W SID
HODIZON DD	-																						
HORIZON DR																		-	1				
E7.00 CLLT TO F0.70 CLT																							DEM DDI VELLOVI
57+90, 6' LT TO 58+78, 6' LT											90												REM DBL YELLOW H
57+20, 14' RT TO 58+78, 6' RT											160												REM DBL YELLOW H
G Rd																							
				-																			
65+60, 14' LT TO 66+22, 18' LT											40												N EDGE LINE G R
65+60 @CL TO 66+22, 3' LT											70										1		DBL YELLOW G R
65+60, 24' RT TO 66+22, 29' RT											30												S EDGE LINE G R
SHEET 2 SUBTOTAL	676		587		32	8		450	4946		390		1		1		6	4		1		600	

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Grand Junction 333 WEST AVE, BLDG C Grand Junction, CO, 81501			
Phone: 970–244–1554			

Init.	Colorado D	epartment of Transportation
	CO	606 South 9th Street Grand Junction, CO, 81501 Phone: 970-683-6351 FAX: 970-683-6369
	Region 3	KC

As Constructed	HORIZON DR A					Project No./Code
No Revisions:	TABOLATI	OIN O	2	OVALS		SHE M555-034
Revised:	Designer: JC		Structure Numbers			23652
Void: TABUL	Detailer: JC: ATION OF REMOVALS	5	Subset Sh		of X	Sheet Number 14

SHEET 3 SUBTOTAL SHEET 2 SUBTOTAL PROJECT TOTAL

			(202-	00204)	(202	2-00206)	(202-	00210)				TION OF F		00250)			(20	2-00705)	12	02-00827	(20	2-00840)	(202	2-00848)			
		00203)		OF CURB.		OVAL OF		VAL OF		2-00220)		VAL OF		VAL OF		-00700)		AL OF LIG		EMOVAL		OVAL OF		L OF TRAFFIC	(202-04	100) ABANDON	
STATION		L OF CURB		ER AND		RETE CURE				OVAL OF		ALT MAT		MENT		VAL OF	ST.	ANDARD		OF PULL				CONTROLLER	(202 01	WELL	
	AND G	UTTER		WALK		RAMP		EMENT	ASPH	ALT MAT		ANING)		KING	LIGHTS	TANDARD		INDATION	`	BOX		POLE		CABINET		***	COMMENTS
		LF		LF		SY	-	SY		SY		SY		SF		EA		EA		EA	'	EA	7.112	EA		EA	-
	Plan	As Const	Plan	As Const		As Const	_					As Const		As Const		As Const	Plan	As Cor	st Pla		t Plan	As Const	Plan	As Const	Plan	As Const	1
HORIZON DR			2.0000								7, 2002	112 2 1112 5			1.7907												

63+00 TO 64+64											1225																HORIZON E OF INT
63+00, 36' LT TO 63+26, 35' LT			28																								N SIDE HORIZON
63+78 TO 64+40	130																										BOTH SIDES MEDIA
63+00, 37' RT TO 64+63, 37' RT			164																								S SIDE HORIZON
63+87, 44' RT TO 63+87, 69' RT	25																										S SIDE G RD DWY
64+22, 44' RT TO 64+22, 68' RT	24																										N SIDE G RD DWY
27 1/2 RD																											
70+11, 45' LT															1												E SIDE 27 1/2 S OF II
70+12, 44' LT																			1								E SIDE 27 1/2 S OF IN
69+50, 45' LT TO 70+80, 33' LT			140																								E SIDE 27 1/2 S OF IN
69+50 TO 70+80											750																27 1/2 RD S OF INT
70+80 TO 72+45									280																		FOR LEFT TURN
69+50, 12.5' RT TO STA 70+44, 23' RT			90																								W SIDE OF 27 1/2 S OF
70+80, 21' LT TO 71+54, 21' LT													74														CHANNEL LINE
70+80, 17' LT TO 71+54, 17' LT													37														EDGE LINE
71+17, 27' LT													20														RT TURN AROW
71+17 AT CL													20														LT TURN AROW
70+44, 7' RT TO 71+34, 7' RT													90														DBL YELLOW LINE
72+45 7' RT TO 72+50, 7' RT													5														DBL YELLOW LINE
70+44,19' RT TO 72+50, 19' RT													210														EDGE LINE

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File Name: TABULATION OF REMOVALS.dwg	Date:	Comments	Init.		·		— TABULATION I	OF REMOVALS —	-
Horiz. Scale: AS SHOWN Vert. Scale: NA				CDO	606 South 9th Street	No Revisions:		3	SHE M555-034
Unit Information: City of GJ Unit Leader Initials: LF				CO S	Grand Junction, CO, 81501	Revised:	Designer: JCS	Structure	23652
Grand Junction 333 WEST AVE, BLDG C Grand Junction, CO, 81501 Phone: 970–244–1554				TNV	Phone: 970-683-6351 FAX: 970-683-6369	110110001	Detailer: JCS	Numbers	
COLORADO Phone: 970–244–1554				Region 3	KC	Void: TA	BULATION OF REMOVALS	Subset Sheets: X of X	Sheet Number 15

TABULATION OF SURFACING

STATION	Exca (Sub	100) Muck wation ograde ization)	AGGREG COURSE (SUB	03000) ATE BASE (CLASS 3) GRADE JZATION)	AGREGA	06000) ATE BASE (CLASS 6)		01000) ditioning	Asphalt (41 Hot Mix Grading SX) PG 64-22)	CON	-00600) CRETE EMENT INCH)	PAVE	O0800) CRETE EMENT NCH)	412-01100 Concrete Pavement (11 Inch)	Paveme	2-01105 oncrete ent (11 Inch) Special)	CONC PAVE (11 INC	01120) CRETE EMENT H)(FAST ACK)	GEO' (SEPA (CL (SUE	0-00133) TEXTILE ARATOR) ASS 2) BGRADE LIZATION)	(506-01020) GEOGRID REINFOREMENT (SUBGRADE STABILIZATION)	COMMENTS
		CY		ON		ON		Υ	-	ON		SY	-	SY	SY		SY		SY		SY	SY	
Under a Britan	Plan	As Const	Plan	As Const	Plan	As Const	Plan	As Const	Plan	As Const	Plan	As Const	Plan	As Const	Plan As Const	Plan	As Const	Plan	As Const	Plan	As Const	Plan As Const	
Horizon Drive																							
58+89, 48' LT TO 60+51, 145' LT					57																		6"AT SIDEWALK WEST QUADRANT
60+66, 88' LT TO 60+52, 145' LT		-		-	17					-	1					-							12" BELOW RETAIINING WALL FOOTING
59+25, 39' LT		-		-	3												_						8" AT CURB RAMP
60+25, 38' LT		+		-	4																		8" AT CURB RAMP
60+25, 38 LT 60+77, 102' LT		-			4											-	_						8" AT CURB RAMP
60+65, 134' LT					3																		8" AT CURB RAMP
					6																		
60+29, 40' LT TO 60+77, 96' LT		-			34		01																4" AT CONC MED COV MATL
58+89, 36' LT TO 60+55, 150' LT 61+25, 83' LT TO 60+93, 155' LT					18		81 42																8" AT CURB & GUT WEST QUADRANT
				-	19		42																8" AT C&G NW SPLITTER ISLE
61+25, 83' LT TO 60+93, 155' LT 61+17, 104' LT					6						20					_							4"@CONC MED COV MATL NW SPLIT ISLE
61+40, 87' LT					2		3				20					_							CROSSWALK NW SPLIT ISLE 8"@MED NOSE NW SPLIT ISLE
60+99, 197' LT TO 61+30, 180' LT					11		15		5														HMA CONNECT WALK TO G RD SHLDR
61+30, 180' LT TO 61+34, 173' LT		+		-	2		15		5														6"AT SIDEWALK NORTH QUADRANT
61+34, 173' LT TO 61+63, 134' LT					34								80										COUNTRY CLUB AND AZTECAS DRIVE
61+63, 134' LT TO 63+26, 44' LT		+		+	47								80										6"AT SIDEWALK NORTH QUADRANT
61+58, 118' LT					4																		8" AT CURB RAMP
61+60, 113' LT TO 62+33, 43' LT				1	7																		4" AT CONC MED COV MATL
62+40, 42' LT					4																		8" AT CURB RAMP
63+02, 35' LT					2																		8" AT CURB RAMP
60+93, 192' LT TO 63+25, 35' LT					34		81																8" AT CURB & GUT NORTH QUADRANT
61+41,175'LT-61+75,130'LT-62+19,63'LT					3		01																6" AT ALL C&G'S AZTECAS AND CC
61+44, 175' LT TO 62+60, 63' LT					170		240		85														AZTECAS AND COUNTRY CLUB PAVE
58+78 TO 63+00					1555		3900								3900			195					RD PAVE HORIZON, G, AND 27 1/2 RD
58+80 TO 60+56					38		89								0000			100					8" AT C&G SW SPLITTER ISLE
58+80 TO 60+56					40		- 55																4"@CONC MED COV MATL SW SPLIT ISLE
60+36					7						22												CROSSWALK SW SPLIT ISLE
60+54, 14' LT					2		4				 												8"@MED NOSE SW SPLIT ISLE
60+84 TO 61+91					200		475									475							TRUCK APRON
60+98 TO 61+78					9		28																6"AT CURB INSIDE TRUCK APRON
61+00 TO 61+76					8																		4"@MEDIAN EDGE INSIDE TRUCK APRON
62+08 TO 63+00					23		53																8" AT C&G NE SPLITTER ISLE
62+08 TO 63+00					26																		4"@CONC MED COV MATL NE SPLIT ISLE
62+10, 20' RT					2		4																8"@MED NOSE NE SPLIT ISLE
62+22					9						30												CROSSWALK NE SPLIT ISLE
59+17,36'RT TO 69+50,20' RT (27 1/2 RD)					31		72																8" AT CURB & GUT SOUTH QUADRANT
59+34, 36' RT					3																		8" AT CURB RAMP
60+25, 40' RT					4																		8" AT CURB RAMP
60+32, 41 RT TO 61+07, 113' RT					7																		4" AT CONC MED COV MATL
61+10, 118' RT					4																		8" AT CURB RAMP
59+17,48'RT TO 69+50,36' RT (27 1/2 RD)					58																		6"AT SIDEWALK SOUTH QUADRANT
27 1/2 ROAD																							
68+94 TO 69+50					13		31																8" AT C&G SE SPLITTER ISLE
SHEET 1 SUBTOTAL	0		0		2530		5118		90		72		80		3900	475		195		0		0	
SHEET TOUBTOTAL	U		U		2330		3110		90		12		00		3900	4/3		190		U		U	

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Horiz. Scale: AS SHOWN Vert. Scale: NA	
Unit Information: City of GJ Unit Leader Initials: LF	
Grand Junction 333 WEST AVE, BLDG C Grand Junction, CO, 81501 Phone: 970–244–1554	

	Sheet Revisions	
Date:	Comments	Init.
	Date:	Date: Comments

Colorado D	epartment of Transportation
CDOI	606 South 9th Street Grand Junction, CO, 81501 Phone: 970-683-6351 FAX: 970-683-6369
അ	Grand Junction, CO, 81501 Phone: 970-683-6351 FAX: 970-683-6369
	Filone: 970-663-6331 FAX: 970-663-6369
Region 3	KC

As Constructed		G RD ROUNDABOUT OF SURFACING	Project No./Code
No Revisions:	TABOLATION -	- 1	SHE M555-034
Revised:	Designer: JCS	Structure Numbers	23652
Void: TABUL	Detailer: JCS ATION OF SURFACING	Subset Sheets: X of X	Sheet Number 16

STATION	(203-0010 Excava (Subg Stabiliz CY Plan	ation rade ation)	COURSE (SUBC STABILI	ATE BASE (CLASS 3) GRADE	AGREGA COURSE TO Plan	06000) ITE BASE (CLASS 6) ON As Const	Recond S Plan	01000) ditioning SY As Const	403-34741 Ho Asphalt (Gradi (75) (PG 64 TON	ng SX)	(412-00600 CONCRETE PAVEMENT (6 INCH)	CONCRETÉ	412-01100 Concrete Pavement (11 Inch)	412-01 Conci Pavement (Spec	rete (11 Inch)	(412-011 CONCRE PAVEME (11 INCH)(TRACE	ETE ENT FAST	GEOTI (SEPAR (CLA (SUBG	00133) EXTILE RATOR) SS 2) GRADE IZATION)	GE REINF (SU	6-01020) EOGRID FOREMENT BGRADE ILIZATION)	COMMENTS
27 1/2 ROAD 68+94 TO 69+50 68+96, 12' RT 69+17 68+79, 52' LT TO 69+50 24' LT 68+79, 52' LT TO 69+50 24' LT 69+23, 30' LT Horizon Drive 61+73, 124' RT TO 63+00, 28' RT 61+80, 114' RT 61+82, 110' RT TO 62+35, 47' RT 62+38, 44' RT 62+34, 42' RT TO 63+00 33' RT 61+88, 120' RT TO 63+00, 48' RT					11 2 5		Plan			Const : P		SY	ev				•					
27 1/2 ROAD 68+94 TO 69+50 68+96, 12' RT 69+17 68+79, 52' LT TO 69+50 24' LT 68+79, 52' LT TO 69+50 24' LT 69+23, 30' LT Horizon Drive 61+73, 124' RT TO 63+00, 28' RT 61+80, 114' RT 61+82, 110' RT TO 62+35, 47' RT 62+38, 44' RT 62+34, 42' RT TO 63+00 33' RT 61+88, 120' RT TO 63+00, 48' RT	ridii	ASCUISE	Pidil	AS CONST	11 2 5	As Const		AS CONST	Fian As	Const w F		nst Plan As Cons	1-7-1	SY Plan	As Const	SY Plan A		Plan	As Const	Plan	SY As Const	
68+96, 12' RT 69+17 68+79, 52' LT TO 69+50 24' LT 68+79, 52' LT TO 69+50 24' LT 69+23, 30' LT Horizon Drive 61+73, 124' RT TO 63+00, 28' RT 61+80, 114' RT 61+82, 110' RT TO 62+35, 47' RT 62+38, 44' RT 62+43, 42' RT TO 63+00 33' RT 61+88, 120' RT TO 63+00, 48' RT					2 5		1.			111	MII AS CO	ist Flatt As Cons	Plati As Collst	Pian /	AS CONST	Platt P	is Const	Fidii	AS CONST	Fian	AS CONST	
68+96, 12' RT 69+17 68+79, 52' LT TO 69+50 24' LT 68+79, 52' LT TO 69+50 24' LT 69+23, 30' LT Horizon Drive 61+73, 124' RT TO 63+00, 28' RT 61+80, 114' RT 61+82, 110' RT TO 62+35, 47' RT 62+38, 44' RT 62+43, 42' RT TO 63+00 33' RT 61+88, 120' RT TO 63+00, 48' RT					2 5		-		I												,	
69+17 68+79, 52' LT TO 69+50 24' LT 68+79, 52' LT TO 69+50 24' LT 69+23, 30' LT Horizon Drive 61+73, 124' RT TO 63+00, 28' RT 61+80, 114' RT 61+82, 110' RT TO 62+35, 47' RT 62+38, 44' RT 62+43, 42' RT TO 63+00 33' RT 61+88, 120' RT TO 63+00, 48' RT					5		1/4														1	4"@CONC MED COV MATL SE SPLIT ISLE
68+79, 52' LT TO 69+50 24' LT 68+79, 52' LT TO 69+50 24' LT 69+23, 30' LT Horizon Drive 61+73, 124' RT TO 63+00, 28' RT 61+80, 114' RT 61+82, 110' RT TO 62+35, 47' RT 62+38, 44' RT 62+43, 42' RT TO 63+00 33' RT 61+88, 120' RT TO 63+00, 48' RT							4														,	8"@MED NOSE SE SPLIT ISLE
68+79, 52' LT TO 69+50 24' LT 69+23, 30' LT Horizon Drive 61+73, 124' RT TO 63+00, 28' RT 61+80, 114' RT 61+82, 110' RT TO 62+35, 47' RT 62+38, 44' RT 62+43, 42' RT TO 63+00 33' RT 61+88, 120' RT TO 63+00, 48' RT					40						15										,	CROSSWALK SE SPLIT ISLE
68+79, 52' LT TO 69+50 24' LT 69+23, 30' LT Horizon Drive 61+73, 124' RT TO 63+00, 28' RT 61+80, 114' RT 61+82, 110' RT TO 62+35, 47' RT 62+38, 44' RT 62+43, 42' RT TO 63+00 33' RT 61+88, 120' RT TO 63+00, 48' RT					40						-											[
68+79, 52' LT TO 69+50 24' LT 69+23, 30' LT Horizon Drive 61+73, 124' RT TO 63+00, 28' RT 61+80, 114' RT 61+82, 110' RT TO 62+35, 47' RT 62+38, 44' RT 62+43, 42' RT TO 63+00 33' RT 61+88, 120' RT TO 63+00, 48' RT					13		31														,	8" AT C&G SE SLIPLANE ISLE
69+23, 30' LT Horizon Drive 61+73, 124' RT TO 63+00, 28' RT 61+80, 114' RT 61+82, 110' RT TO 62+35, 47' RT 62+38, 44' RT 62+43, 42' RT TO 63+00 33' RT 61+88, 120' RT TO 63+00, 48' RT					8																,	4"@CONC MED COV MATL SE SLIPLN ISLE
Horizon Drive 61+73, 124' RT TO 63+00, 28' RT 61+80, 114' RT 61+82, 110' RT TO 62+35, 47' RT 62+38, 44' RT 62+34, 42' RT TO 63+00 33' RT 61+88, 120' RT TO 63+00, 48' RT					4						13											CROSSWALK SE SLIPLANE ISLE
61+73, 124' RT TO 63+00, 28' RT 61+80, 114' RT 61+82, 110' RT TO 62+35, 47' RT 62+38, 44' RT 62+43, 42' RT TO 63+00 33' RT 61+88, 120' RT TO 63+00, 48' RT																						
61+80, 114' RT 61+82, 110' RT TO 62+35, 47' RT 62+38, 44' RT 62+43, 42' RT TO 63+00 33' RT 61+88, 120' RT TO 63+00, 48' RT																					,	
61+80, 114' RT 61+82, 110' RT TO 62+35, 47' RT 62+38, 44' RT 62+43, 42' RT TO 63+00 33' RT 61+88, 120' RT TO 63+00, 48' RT																						
61+80, 114' RT 61+82, 110' RT TO 62+35, 47' RT 62+38, 44' RT 62+43, 42' RT TO 63+00 33' RT 61+88, 120' RT TO 63+00, 48' RT					21		50															8" AT CURB & GUT EAST QUADRANT
62+38, 44' RT 62+43, 42' RT TO 63+00 33' RT 61+88, 120' RT TO 63+00, 48' RT					3																	8" AT CURB RAMP
62+38, 44' RT 62+43, 42' RT TO 63+00 33' RT 61+88, 120' RT TO 63+00, 48' RT					6																	4" AT CONC MED COV MATL
62+43, 42' RT TO 63+00 33' RT 61+88, 120' RT TO 63+00, 48' RT					5																,	8" AT CURB RAMP
					4																,	4" AT CONC MED COV MATL
Horizon Drive					38																,	6"AT SIDEWALK EAST QUADRANT
Horizon Drive																					,	
																					ļ	
63+00, 4' LT TO 64+64, 7' LT					217		520						520			26					ļ	RD PAVE N SIDE HORIZON DR
64+35, 52' LT					3						11										ļ	GVT BUS STOP
64+35, 42' LT					3						9										ļ	FILL BETWEEN WALK AND C&G GVT
63+00, 4' LT TO 64+64, 7' LT					15		36														<u> </u>	8" AT C&G N SIDE MEDIAN HORIZON DR
63+00 TO 64+64					27																<u> </u>	4" AT CONC MED COV MATL
63+68 TO 64+64					7																ļ'	4" AT CONC MEDIAN EDGING
63+00, 4' RT TO 64+64, 7' RT					15		36														ļ	8" AT C&G S SIDE MEDIAN HORIZON DR
63+00, 4' RT TO 64+64, 7' RT					300		710						710			35					<u> </u>	RD PAVE S SIDE HORIZON DR
63+00, 28' RT TO 63+91, 69' RT					13		30															8" AT CURB & GUT SOUTH SIDE HORIZON
63+00, 33' RT TO 63+18, 32' RT					1																<u> </u>	4" AT CONC MED COV MATL
63+20, 35' RT					3																	8" AT CURB RAMP
63+72, 47' RT					6																	8" AT CURB RAMP
63+00, 48' RT TO 63+56, 92' RT					37																	6"@WALK S SIDE HORIZON W OF G RD
64+21, 68' RT TO 64+70, 36' RT					8		19															8" AT CURB & GUT SOUTH SIDE HORIZON
64+39, 47' RT					6																ļ	8" AT CURB RAMP
64+40, 64' RT TO 64+63, 50' RT					7																<u> </u>	6"@WALK S SIDE HORIZON E OF G RD
64+69, 38' RT TO 64+70, 44' RT					1																	6" AT TYPE 2 CURB
64+97, 48' RT TO 65+16, 48' RT					5						15											GVT BUS STOP (INCLUDES T2 CURB ABO
65+12, 40' RT					1						3											FILL BETWEEN WALK AND C&G GVT
64+64, 36' RT TO 64+70, 36' RT					1		2		1												<u> </u>	SMALL HMA PATCH S SIDE HORIZON
																						I
27 1/2 ROAD																					ļ	<u> </u>
00.50 40H T TO 70.00 00H T					4-7		40														ļ	OILAT OLIDD & OLIT EAST OLDE ST. 1/2 ES
69+50, 46' LT TO 70+80, 33' LT					17		40										\longrightarrow				ļ	8" AT CURB & GUT EAST SIDE 27 1/2 RD
70+52, 36' LT					3										+		\longrightarrow				ļ	8" AT CURB RAMP
69+50, 61' LT TO 70+80, 40' LT					34		405						405		+		\longrightarrow			-	ļ	6"@WALK E SIDE OF 27 1/2 ROAD
69+50, 3' LT TO 70+80, 7' LT					170		405						405		+	20					ļ	RD PAVE E SIDE 27 1/2 RD
69+53, 23' LT					1		2	-							\longrightarrow		\longrightarrow				ļ'	8"@MED NOSE SE SLIP LANE ISLE
69+50 TO 71+50					38		90														ļ	8" AT CURB & GUT MEDIAN 27 1/2 RD
69+50 TO 71+42					20															I	1 ,	4" AT CONC MED COV MATL
71+45					1		1	1													+	
SHEET 2 SUBTOTAL		U			1			-														8"@MEDIAN NOSE END 27 1/2 RD MEDIAN

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Unit Information: City of GJ Unit Leader Initials: LF			
Grand Junction 333 WEST AVE, BLDG C Grand Junction, CO, 81501 Phone: 970-244-1554			
Phone: 970–244–1554			

t.		epartment of Transportation
	CO	606 South 9th Street Grand Junction, CO, 81501 Phone: 970-683-6351 FAX: 970-683-6369
	Region 3	KC

As Constructed	HORIZON DR TABUL <i>A</i>		Project No./Cod	le		
No Revisions:	TABOLA	- TION	· 2	VI ACING	SHE M555-034	
Revised:			Structure Numbers		23652	
Void: TABUL	Detailer: ATION OF SURFACING	JCS	Subset Sh	eets: X of	X Sheet Number 17	

										TABULA	TION O	F SURF	ACING (C	ONT.)									
STATION	Excar (Sub	00) Muck vation grade ization)	AGGREG COURSE (SUB	03000) FATE BASE (CLASS 3) GRADE IZATION)	AGREGA	06000) ATE BASE (CLASS 6)		01000) ditioning	Asphalt (0	41 Hot Mix Grading SX) G 64-22)	CON	-00600) CRETE EMENT INCH)	(412-008 CONCRE PAVEME (8 INC)	ETE	412-01100 Concrete Pavement (11 Inch)	Paveme	e-01105 ncrete nt (11 Inch) pecial)	CONC PAVE (11 INC	01120) CRETE EMENT H)(FAST ACK)	GEO (SEP/ (C 2)(SU	D-00133) TEXTILE ARATOR) CLASS IBGRADE LIZATION)	REINF (SU	6-01020) EOGRID FOREMENT BGRADE BILIZATION)	COMMENTS
		As Const	Plan	As Const	Plan	As Const	Plan	As Const		As Const		SY As Const	SY		SY Plan As Const		SY As Const	Plan	As Const		SY	Plan	SY As Const	
27 1/2 ROAD	rian	A3 CONSt	rian	A3 Collat	rian	A3 CONST	Fian	AS CONST	rian	A3 CONST	l lan	A3 CONST	rian As	COIISE	Pian As Const	riaii	A3 COIISE	rian	A3 COllat	Fian	A3 CONST	Fian	A3 CONST	
71+71 TO 72+43					16		37																	8" AT CURB & GUT MEDIAN 27 1/2 RD
71+71 TO 72+43					16																			4" AT CONC MED COV MATL
70+44, 6' RT TO 72+45					98		140		56															27 1/2 RD ASPH PATCH TO INSTALL MEDIAN
69+50, 3' RT TO 70+44, 4' RT					72		172								172			8						RD PAVE W SIDE 27 1/2 RD
69+50, 20' RT TO 70+44, 23' RT					11		25																	8" AT CURB & GUT WEST SIDE 27 1/2 RD
70+08, 28' RT					3																			8" AT CURB RAMP
69+50, 36' RT TO 70+44, 30' RT					30																			6"@WALK W SIDE OF 27 1/2 ROAD
Horizon Drive, G Road, & 27 1/2 Road	1103		1980																	1650		1650		25% of total Roadway Reconstruction area
																								1
																						1		
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				+		-	-				 						+					1		
																								<u> </u>
SHEET 3 SUBTOTAL	1103		1980		246		374		56		0		0		172	0		8		1650		1650		
SHEET 1 SUBTOTAL	0		0						90		72					475				0		0		
					2530		5118						80		3900			195						
SHEET 2 SUBTOTAL	0		0		1080		1976		1		66		0		1635	0		81		0		0		
PROJECT TOTAL	1103		1980		3856		7468		147		138		80		5707	475		284		1650		1650		

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nit Information: City of GJ Unit Leader Initials: LF			
Grand Junction 333 WEST AVE, BLDG C Grand Junction, CO, 81501			
C O L O R A D O Phone: 970–244–1554			

+	Colorado D	epartment of Transportation	
ι.	TO TO	606 South 9th Street Grand Junction, CO, 81501 Phone: 970–683–6351 FAX: 970–683–6	3
	Region 3	KC	

As Constructed	HORIZON DR	AND (G RD F	ROUNDABOUT RFACING	Project No./	'Code		
No Revisions:	TADOL	-A HON -	- 3	IN ACING	SHE M555-034			
Revised:	Designer:	JCS	Structure Numbers		23652			
Void: TABU	Detailer: .ATION OF SURFACING	003	Subset Sh		Sheet Number	18		

TABULATION OF RETAINING WALL, SIDEWALK, CURB RAMP, CURB & GUTTER, AND MEDIAN COVER MATERIAL

						.,,				, 50112			10 111		_ , _ , (MATERIA	· <u>·</u>																
STATION		CONCRETE SIDEWALK		CONCRETE CURB RAMP		Warnings		CURB TYPE 2 (SECTION B)		(Patterned Concrete)		(SECTION II-B) (SPECIAL)	3	(SPECIAL)	(610-00026) MEDIAN COVER MATERIAL (6 INCH PATTERNED CONCRETE)		(610-00026) MEDIAN COVER MATERIAL (6 INCH PATTERNED CONCRETE)								(610-00026) MEDIAN COVER MATERIAL (6 INCH PATTERNED CONCRETE)		(610-00026) MEDIAN COVER MATERIAL (6 INCH PATTERNED CONCRETE)				SF		COMMENTS
		SY		SY	3	SF		LF		LF		LF		LF		SF																	
	Plan	As Const	Plan	As Const	Plan	As Const	Plan	As Const	Plan	As Const	Plan	As Const	Plan	As Const	Plan	As Const																	
HORIZON DRIVE																																	
58+89, 48' LT TO 60+51, 145' LT	191																SIDEWALK WEST QUADRANT																
59+25, 39' LT			6														CURB RAMP WEST QUADRANT																
60+25, 38' LT			8		16												CURB RAMP WEST QUADRANT																
60+77, 102' LT			8		16												CURB RAMP WEST QUADRANT																
60+65, 134' LT			7														CURB RAMP WEST QUADRANT																
60+66, 88' LT TO 60+52, 145' LT																	RETAINING WALL WEST QUADRANT																
60+29, 40' LT TO 60+77, 96' LT															253		CONC MED COV MATL W QUADRANT																
58+89, 36' LT TO 60+55, 150' LT											292						C & G WEST QUADRANT																
36+69, 36 E1 10 60+33, 130 E1											232						C & G WEST QUADRAINT																
64.0E 93UTTO 00.03 455UT	-					\vdash							100				C & G NW SPLITTER ISLAND																
61+25, 83' LT TO 60+93, 155' LT													190																				
61+25, 83' LT TO 60+93, 155' LT															893		CONC MED COV MATL NW SPLIT ISLE																
61+17, 104' LT					32		40										CROSSWALK NW SPLIT ISLE																
61+30, 180' LT TO 61+34, 173' LT	6																SIDEWALK NORTH QUADRANT																
61+63, 134' LT TO 63+26, 44' LT	155																SIDEWALK NORTH QUADRANT																
61+58, 118' LT			8		16												CURB RAMP NORTH QUADRANT																
61+60, 113' LT TO 62+33, 43' LT															310		CONC MED COV MATL NORTH QUAD																
62+40, 42' LT			8		16												CURB RAMP NORTH QUADRANT																
63+02, 35' LT			5														CURB RAMP NORTH QUADRANT																
60+93, 192' LT TO 63+25, 35' LT											292						CURB & GUT NORTH QUADRANT																
61+34, 174' LT TO 61+44, 176' LT											5						CURB & GUT W SIDE C.C. DWY																
61+63, 134' LT TO 61+67, 124' LT							37										CURB AT AZTECAS DWY																
62+19, 63' LT TO 62+60, 62' LT							39										CURB AT AZTECAS PARKING																
61+70, 122' LT TO 62+20, 65' LT							42										ACTUALLY PARKING BLOCKS AZTECAS																
01+70, 122 L1 10 02+20, 03 L1							42										ACTUALLY PARKING BLOCKS AZTECAS																
50.00 TO CO.5C													400				ON C OW ODLITTED IOLE																
58+80 TO 60+56													400				C&G SW SPLITTER ISLE																
58+80 TO 60+56															1770		CONC MED COV MATL SW SPLITTER ISLE																
60+36					32		45										CROSSWALK SW SPLIT ISLE																
60+98 TO 61+78							250										CURB INSIDE TRUCK APRON																
61+00 TO 61+76									245								MEDIAN EDGING INSIDE TRUCK APRON																
62+08 TO 63+00													240				CURB AND GUTTER NE SPLITTER ISLE																
62+08 TO 63+00															1200		CONC MED COV MATL NE SPLITTER ISLE																
62+22					32		65										CROSSWALK NE SPLIT ISLE																
59+17,36'RT TO 69+50,20' RT (27 1/2 RD)											262						CURB & GUT SOUTH QUADRANT																
59+34, 36' RT			7														CURB RAMP SOUTH QUADRANT																
60+25, 40' RT			8		16												CURB RAMP SOUTH QUADRANT																
60+32, 41 RT TO 61+07, 113' RT															320		CONC MED COV MATL SOUTH QUADRANT																
61+10, 118' RT			8		16												CURB RAMP SOUTH QUADRANT																
59+17,48'RT TO 69+50,36' RT (27 1/2 RD)	195		Ť														SIDEWALK SOUTH QUADRANT																
33717, 40101 10 00700,00 ICI (27 1/2 ICD)	···				—	\vdash											OIDENMEN COOTH QUADIMIN																
27 1/2 ROAD	 			_	—						_		 		 																		
21 112 ROAD	\vdash		\vdash	_	\vdash	\vdash					\vdash				\vdash																		
68+94 TO 69+50	\vdash				\vdash	\vdash					\vdash		141		 	\vdash	CURB & GUTTER SE SPLITTER ISLAND																
	⊢—			_	<u> </u>								141		EDE																		
68+94 TO 69+50	⊢		—	_		\vdash	00				—		—		525	\vdash	CONC MED COV MATL SE SPLITTER ISLAND																
69+17					32		28										CROSSWALK SE SPLIT ISLE																
	L																																
68+79, 52' LT TO 69+55 24' LT	L												141				C&G SE SLIPLANE ISLE																
68+79, 52' LT TO 69+55 24' LT	L														390		CONC MED COV MATLE SE SLIPLANE ISLE																
69+23, 30' LT					32		24										CROSSWALK SE SLIPLANE ISLE																
SHEET 1 SUBTOTAL	547		73		256		570		245		851		1112		5661																		

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File Name: TABULATION OF SIDEWALK CURB and GUTTER	nd MEDIA	1 С Ф УҢ Б :dwg	Comments	Init.
Horiz. Scale: AS SHOWN Vert. Scale: NA				
Unit Information: City of GJ Unit Leader Initials: LF				
Grand Junction C O L O R A D O 333 WEST AVE, BLDG C Grand Junction, CO, 81501				
COLORADO Phone: 970–244–1554				

Colorado Department of Transportation

606 South 9th Street
Grand Junction, CO, 81501
Phone: 970-683-6351 FAX: 970-683-6369

Region 3

As Constructed	HORIZON DR AND	G RD ROUNDABOUT DEWALK CURB AND	Project No./Code
No Revisions:	· · · · · · · · · · · · · · · ·	DIAN COVER - 1	SHE M555-034
Revised:	Designer: JCS	Structure	23652
	Detailer: JCS	Numbers	
TABULATION OF SIDEWALK CURB	AND GUTTER AND MEDIAN COVER	Subset Sheets: X of X	Sheet Number 19

TABULATION OF RETAINING WALL, SIDEWALK, CURB RAMP, CURB & GUTTER, AND MEDIAN COVER MATERIAL

		ABOLAT	1014 01	ILLIA	VIIVO V	VALL, 31	DLVVA	LN, CON	D IVAII	ir, coiti	3 & GU	TIEN, A		DIAN C	JVLI	MATERIA	<u></u>																		
STATION	(00000-809)	CONCRETE SIDEWALK	(608-00010)	CONCRETE CURB RAMP	608-00015 Detectable	Warnings	(609-20010)	CURB TYPE 2 (SECTION B)	610-00100 Median Edging	(Patterned Concrete)	(609-21023) CIIRB & GIITTER TYPE 2	(SPECIAL)	(609-21110) CIIRR & GIITTER TYPE 2	(SPECIAL)	(610-00026) MEDIAN COVER MATERIAL (6 INCH PATTERNED CONCRETE)								(610-00026) MEDIAN COVER MATERIAL (6 INCH PATTERNED CONCRETE)		(610-00026) MEDIAN COVER MATERIAL (6 INCH PATTERNED CONCRETE)		(610-00026) MEDIAN COVER MATERIAL (6 INCH PATTERNED CONCRETE)		(610-00026) MEDIAN COVER MATERIAL (6 INCH PATTERNED CONCRETE)		(610-00026) MEDIAN COVER MATERIAL (6 INCH PATTERNED CONCRETE)				COMMENTS
	,	SY		SY	0	SF		LF		LF		LF		LF		SF																			
	Plan	As Const	Plan	As Const	Plan	As Const	Plan	As Const	Plan	As Const	Plan	As Const	Plan	As Const	Plan	As Const																			
HORIZON DRIVE																																			
61+73, 124' RT TO 63+00, 28' RT											180						CURB AND GUTTER AT EAST QUADRANT																		
61+80, 114' RT			6		16												CURB RAMP AT EAST QUADRANT																		
61+82, 110' RT TO 62+35, 47' RT															255		CONC MED COV MATL EAST QUADRANT																		
62+38, 44' RT			11		16												CURB RAMP AT EAST QUADRANT																		
62+43, 42' RT TO 63+00 33' RT															190		CONC MED COV MATL EAST QUADRANT																		
61+88, 120' RT TO 63+00, 48' RT	125																SIDEWALK AT EAST QUADRANT																		
HORIZON DRIVE																																			
63+00, 4' LT TO 64+64, 7' LT													165				C&G N SIDE MEDIAN HORIZON DR																		
63+00 TO 64+64															1180		CONC MED COV MATL HORIZON DR MEDIAN																		
63+68 TO 64+64									200						1.00		MEDIAN EDGING HORIZON DR MEDIAN																		
63+00, 4' RT TO 64+64, 7' RT													164				C&G S SIDE MEDIAN HORIZON DR																		
55.55, 111115 51.51, 1111													101				OGO O OIDE MEDINATIONEDIA																		
63+00, 28' RT TO 63+91, 69' RT											108						CURB & GUT SOUTH SIDE HORIZON WEST OF G RD																		
63+00, 33' RT TO 63+18, 32' RT											100				30		CONC MED COV MATL SOUTH SIDE HORIZON																		
63+20, 35' RT			7														CURB RAMP SOUTH SIDE HORIZON																		
63+72, 47' RT			15		14												CURB RAMP SOUTH SIDE HORIZON																		
63+00, 48' RT TO 63+56, 92' RT	125		-10														WALKS SOUTH SIDE HORIZON WEST OF G RD																		
00100, 40 101 10 00100, 32 101	120																WILLIA GOOTH GIBE HORIZON WEGT OF GIRB																		
64+21, 68' RT TO 64+68, 36' RT											65						CURB & GUT SOUTH SIDE HORIZON EAST OF G RD																		
64+69, 37' RT			1								- 00						CURB RAMP SMALL PORTION JOIN TO EXIST																		
64+69, 38' RT TO 64+70, 44' RT							7										AT CURB RAMP S SIDE HORIZON EAST END																		
64+39, 47' RT			14		14												CURB RAMP E CURB RETURN HORIZON AND G																		
64+40, 64' RT TO 64+63, 50' RT	24		- 1-7														WALK SOUTH SIDE HORIZON EAST OF G RD																		
64+97, 48' RT TO 65+16, 48' RT							33										CURB AT GVT BUS STOP																		
04101, 40 101 10 001 10, 40 101																	COND AT GVT BOO OTO!																		
27 1/2 ROAD																																			
ET ITE ROAD																																			
69+50, 46' LT TO 70+80, 33' LT											142						CURB & GUT EAST SIDE 27 1/2 RD																		
70+52, 36' LT			5								172						CURB RAMP 27 1/2 RD																		
69+50, 61' LT TO 70+80, 40' LT	113																WALK E SIDE OF 27 1/2 ROAD																		
00100, 01 21 10 10100, 40 21	110																WALKE OIDE OF 21 112 NOAD																		
69+50 TO 71+50													400				CURB & GUT MEDIAN 27 1/2 RD																		
69+50 TO 71+50															875		MEDIAN COV MATL 27 1/2 RD																		
71+71 TO 72+43													166		T		CURB & GUT MEDIAN 27 1/2 RD																		
71+71 TO 72+43															832		MEDIAN COV MATL 27 1/2 RD																		
171171012110																																			
69+50, 20' RT TO 70+44, 23' RT											90						CURB & GUT WEST SIDE 27 1/2 RD																		
70+08, 28' RT			7														CURB RAMP WEST SIDE OF 27 1/2																		
69+50, 36' RT TO 70+44, 30' RT	70																WALK W SIDE OF 27 1/2 ROAD																		
	- 1																William Constant																		
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SHEET 2 SUBTOTAL	457		66		60		40		200		585		895		3362																				
SHEET 1 SUBTOTAL	547		73		256		570		245		851		1112		5661																				
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PROJECT TOTAL	1004		139		316		610		445		1436		2007		9023																				

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Horiz. Scale: AS SHOWN Vert. Scale: NA				
Unit Information: City of GJ Unit Leader Initials: LF				
Grand Junction 333 WEST AVE, BLDG C Grand Junction, CO, 81501				
Phone: 970–244–1554				

Colorado Department of Transportation

606 South 9th Street

(CO)	Grand Junction, CO, 81501 Phone: 970–683–6351 FAX: 970–683–6369
Region 3	KC

As Constructed	HORIZON DR AND (TABULATION OF SII	G RD ROUNDABOUT	Project No./Code
No Revisions:	GUTTER AND MEI		SHE M555-034
Revised:	Designer: JCS	Structure	23652
TABULATION OF SIDEWALK CURB	Detailer. 003	Numbers Subset Sheets: X of X	Sheet Number 20

TABULATION OF MISCELLANEOUS ITEMS

				ABOLATIO							
STATION		10) Relay r System	ΑĽ	0-04010) DJUST NHOLE	(210-04015) MODIFY MANHOLE			0-04020) lify Inlet		0-04050) Valve Box	COMMENTS
	L	.S		EA		EA		EA	EA		
	Plan	As Const	Plan	As Const	Plan	As Const	Plan	As Const	Plan	As Const	
HORIZON DRIVE											
60+91, 17' LT			1								EX STORM MH (M1)
61+93, 70' RT			1		1						EX STORM MH (M2)
62+30, 60' LT	1										FOR AZTECA'S NORTH QUADRANT
63+08, 11' LT									1		
64+07, 11' LT									1		
64+22, 51' RT							1				EX INLET (M2) AT INT OF HORIZON AND G
61+26, 18' RT			1								EX SAN SEW MH (M2)
62+28, 24' RT			1								EX SAN SEW MH (M3)
63+18, 20' RT			1								EX SAN SEW MH (M4)
63+66, 19' RT			1								EX SAN SEW MH (M5)
27 1/2 ROAD											
69+13, 3' LT			1								EX SAN SEW MH (M1)
69+13, 63' LT			1								EX SAN SEW MH (M1a)
PROJECT TOTAL =	1		8		1		1		2		

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	File Name: TABULATION OF M	ISCELLANEOUS ITEMS.dwg
	Horiz. Scale: AS SHOWN	Vert. Scale: NA
ſ	Unit Information: City of GJ	Unit Leader Initials: LF
	Grand Junction	333 WEST AVE, BLDG C Grand Junction, CO, 81501 Phone: 970-244-1554

Date:	Init.	

	epartment of T	ransportation
	Grand Junction, CO,	
Region 3		KC

As Constructed	ed HORIZON DR AND G RD ROUNDABOUT TABULATION OF		Project No./Code		
No Revisions: MISCELLANEOUS ITEMS - 1		SHE M555-034			
Revised:	Designer: JCS	Structure Numbers		23652	
Void: TABUL	Detailer: JCS ATION OF MISCELLANEOUS ITEMS	Subset Sheets:	X of X	Sheet Number 21	l

File Name: Concrete Jointing Plan.dwg

Unit Information: City of GJ Unit Leader Initials: LF

Horiz. Scale: AS SHOWN

Grand Junction

Date:

Vert. Scale: NA


333 WEST AVE, BLDG C

Grand Junction, CO, 815 Phone: 970-244-1554

Comments

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Region 3

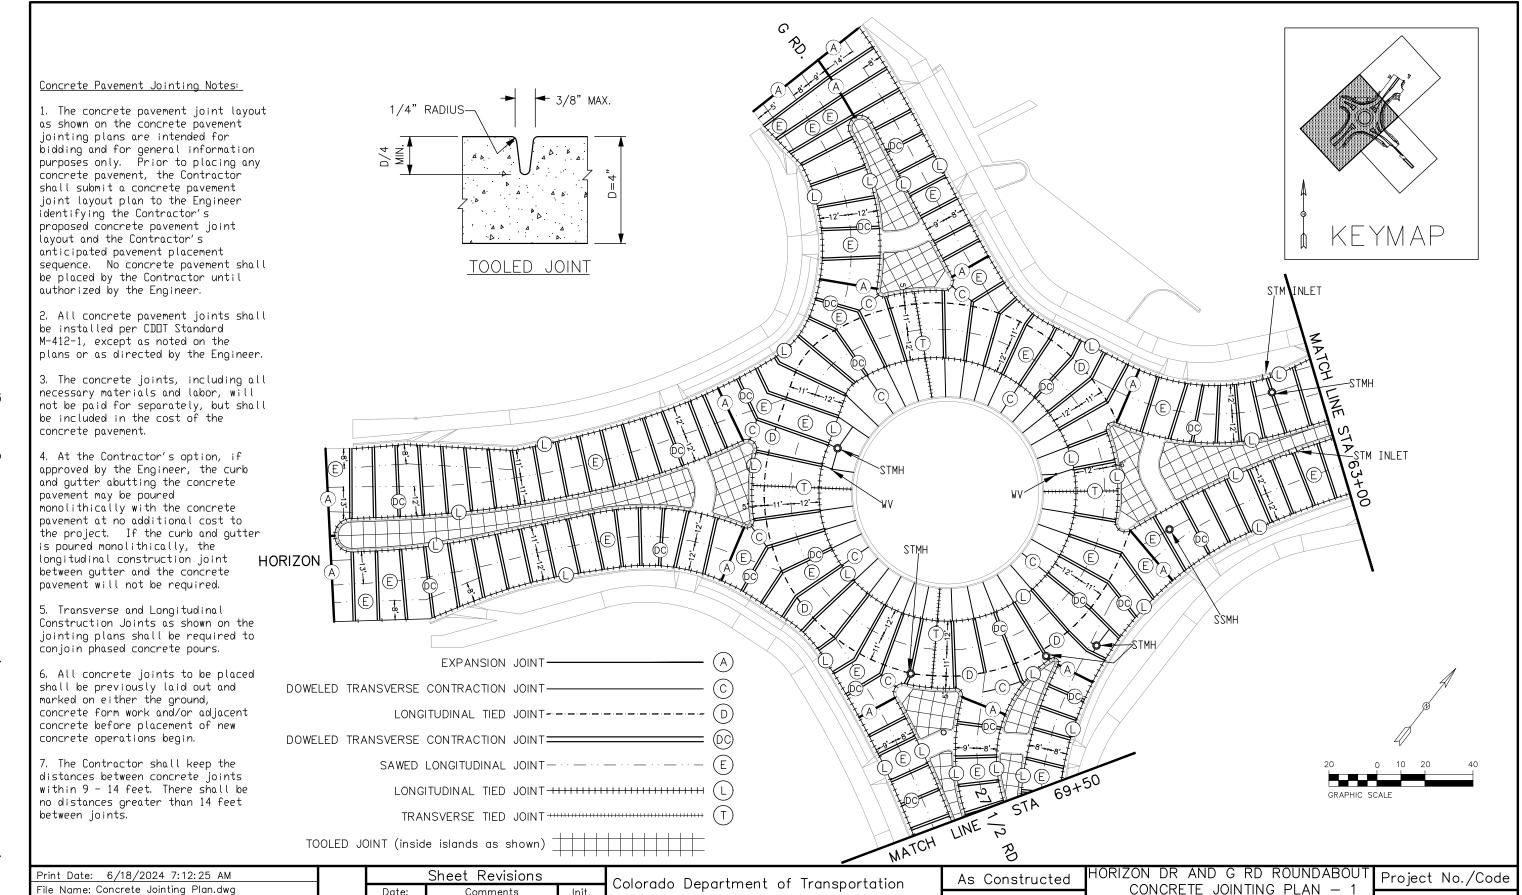

606 South 9th Street

Grand Junction, CO, 81501 Phone: 970–683–6351 FAX: 970–683–6369

No Revisions:

Revised:

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SHE M555-034

23652

Sheet Number

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STA 58+00 TO 63+00

JCS

CONCRETE JOINTING PLAN


Structure

Numbers

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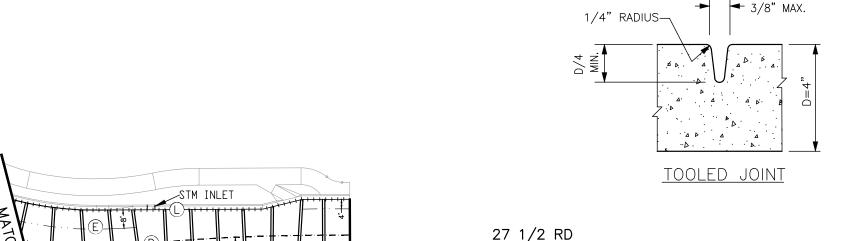
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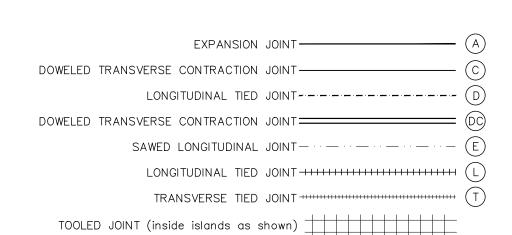
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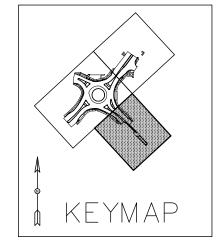



Concrete Pavement Jointing Notes:

- 1. The concrete pavement joint layout as shown on the concrete pavement jointing plans are intended for bidding and for general information purposes only. Prior to placing any concrete pavement, the Contractor shall submit a concrete pavement joint layout plan to the Engineer identifying the Contractor's proposed concrete pavement joint layout and the Contractor's anticipated pavement placement sequence. No concrete pavement shall be placed by the Contractor until authorized by the Engineer.
- 2. All concrete pavement joints shall be installed per CDOT Standard M-412-1, except as noted on the plans or as directed by the Engineer.
- 3. The concrete joints, including all necessary materials and labor, will not be paid for separately, but shall be included in the cost of the concrete pavement.
- 4. At the Contractor's option, if approved by the Engineer, the curb and gutter abutting the concrete pavement may be poured monolithically with the concrete pavement at no additional cost to the project. If the curb and gutter is poured monolithically, the longitudinal construction joint between gutter and the concrete pavement will not be required.
- 5. Transverse and Longitudinal Construction Joints as shown on the jointing plans shall be required to conjoin phased concrete pours.
- 6. All concrete joints to be placed shall be previously laid out and marked on either the ground, concrete form work and/or adjacent concrete before placement of new concrete operations begin.
- 7. The Contractor shall keep the distances between concrete joints within 9 - 14 feet. There shall be no distances greater than 14 feet between joints.

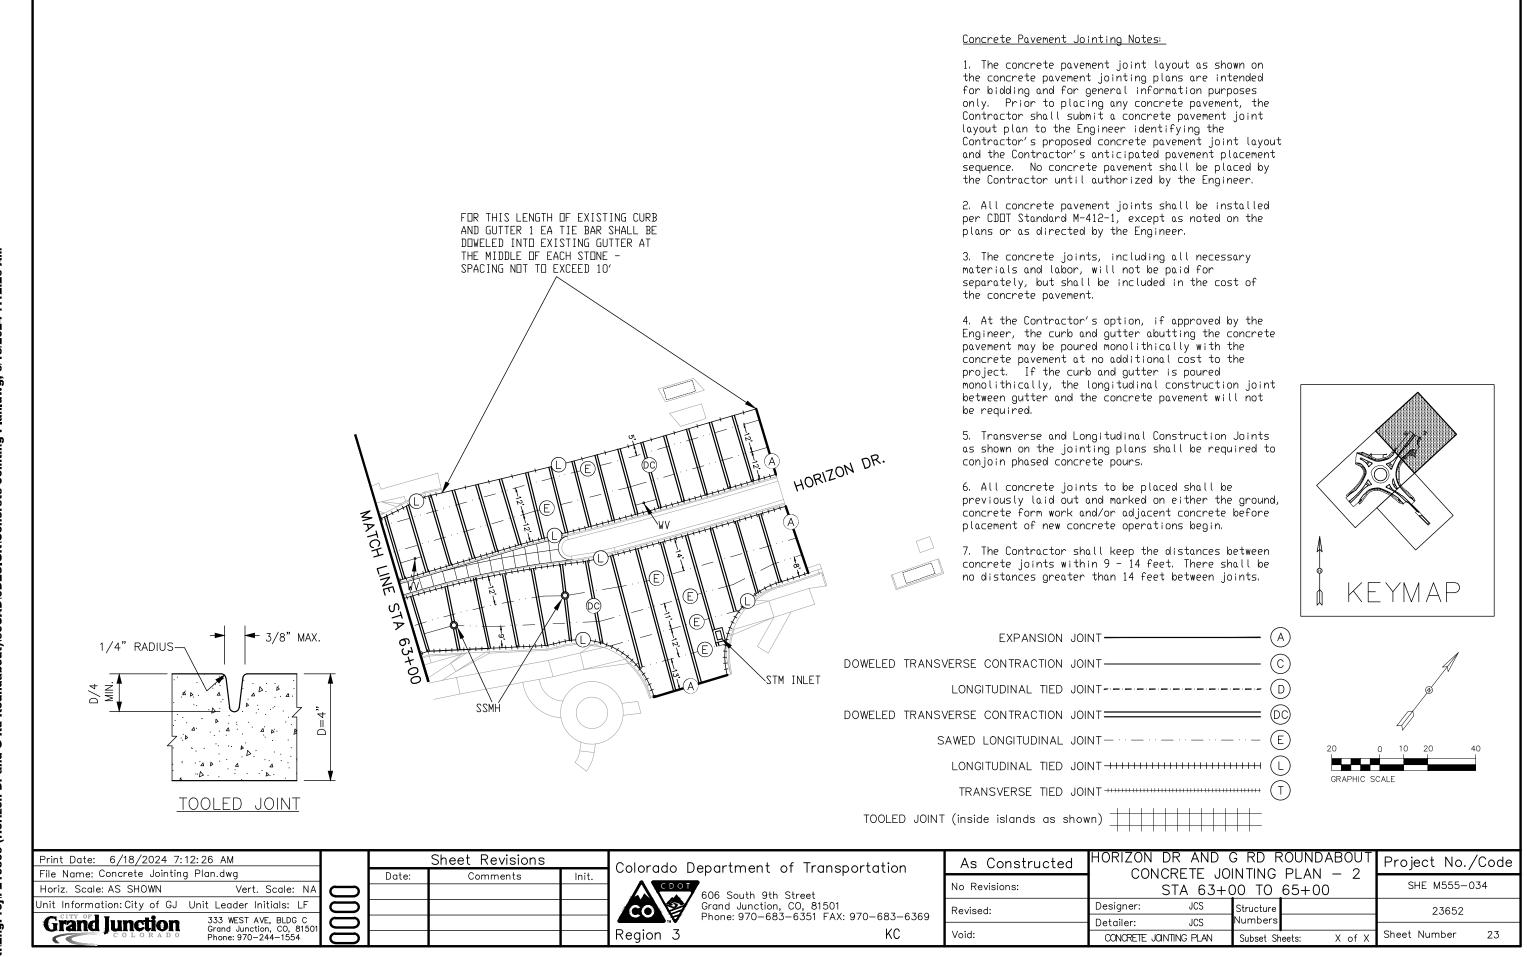





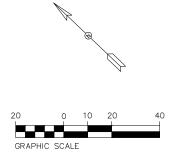

Grand lunction	333 WEST AVE, BLD
Unit Information: City of GJ	Unit Leader Initials:
Horiz. Scale: AS SHOWN	Vert. Scale
File Name: Concrete Jointin	g Plan.dwg
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Vert. Scale: NA		
it Leader Initials: LF		
333 WEST AVE, BLDG C Grand Junction, CO, 81501	0	
Phone: 970-244-1554	0	

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STM INLET

Colorado D	epartment of	Transportation
CO	606 South 9th St Grand Junction, C Phone: 970-683-6	reet 0, 81501 6351 FAX: 970-683-63


Region 3


7	, 606 South 9th Street Grand Junction, CO. 81501
	Phone: 970-683-6351 FAX: 970-683-6369
	KC

As Constructed	HORIZON DR AND G RD ROUNDABOUT CONCRETE JOINTING PLAN — 3		Project No./Code
No Revisions: STA 69+50 TO 72+00			SHE M555-034
Revised:	Designer: JCS	Structure	23652
	Detailer: JCS	Numbers	
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TO ESTABLISH GEOMETRIC CONTR PROJECT, THE DEPARTMENT HAS					11.5			ix Asphalt (Section 403) tion 412)	´ [6]	(Y/N) Special	Offset —	<u> </u>	avement Marking (Secti □ Striping (Temp ⊠ Striping (Perm) ·			
Format * 3D Design Modeling Electronic Files Fir Horizontal Control Project Survey Vertical Control Project Survey Roadway Alignment Officinal Terrain Data Existing Ground	Control and Sto	aking Plan S aking Plan S	Sheet in PDI Sheet in PDI	- format		_	☐ Heating & Sco ☐ Prime Coat, To (Section	arifying Treatment ack Coat & Rejuvenatin 407) Chip Seal (Section 409)	8 1	on — — — — — — — — — — — — — — — — — — —	- - - -	Te	Symbols Other: Other: Signal pole loc Sign Locations	cations and e ations and e s (Temp)	elevations (Temp	(a	630)
 Other: * Specify the information format, ie., plan sh The information marked is either contained 					_		way Elements ⊠ Curb and Gutt ⊠ Drop inlets —	er (Section 609)		Tangent Curve Interval Interval Specified o	Special Offset	🖂 A	Other:	taking by P.L			
 ☐ Signalization ☐ Safety Improvement ☐ Asphalt Overlay ☐ Concrete Overlay 	Major Recon New Roadwa Bridge Repla Bridge Wider New Bridge Other:	y Construct Icement Iing	tion		_		alignmen Retaining Walls Guard Rail (Se Sidewalk (Sect Overlay Station Other: p (Perm) (Section !	t and grades (Section 6 section 606) ion 608) ning 506)	604)	Staking Pla Left Center Interval Interval Specified o Staking Pla	Right Interval	WORK PERFORI	Right of Way (Temp Sta MED BY THE CON onumentation (Section Control Right of Way Education	NTRACTOF 629) Aliquot corn	R'S SURVEY Refer to Survey Co for Work under Sec	the Right of Way I ontrol Diagram Hor to be performed b ction 629	SECTION 629: Plans and Project & Land izon Dr and G Rd Roundabout by the Contractor's Surveyor
SURVEY WORK TO BE PERFORMED BY OTHERS:						⊠ Minor	e and Ditch Paving Structures		200)			_ _		pecified exist	ting monuments	: ** <u>not require</u>	
WORK PERFORMED BY THE CONTRA A complete passing Base Line report (An instrument calibration Certification Establish and Maintain Project Centerlin Verification and Maintenance of Horizor Verify or Determine existing grades and Verify or Determine existing topography Clearing and Grubbing Limits (Section 202) Removal Limits (Section 202)	(completed with (completed with line or Engineer ontal and Verticond alignments	in 6 month nin 6 month Approved C	ns prior to t hs prior to	he start of the start o	f the project)		□ Culverts (Sect □ Culverts w/ H □ Concrete Box ▷ Pipes (Section □ ☑ Sani □ ☑ Stor □ □ Wat □ □ Irrig □ □ Misc	eadwalls and Wingwalls (Culverts w/ Headwalls (603) itary Sewer rm Sewer er ation sellaneous	(Section 601)			*** GENERAL NOTES: 1. Unless indicated of be done in accordance 2. Adequate informat	of evidence for mo A Tabulation of Surve therwise on this Survey te with the latest edition ion for establishing lines, lditional information requ	hall include onuments to rey Monumen Tabulation Sh n of the CDO s, grades, and	adequate resear be set. its may be prov neet, all survey v IT Survey Manual d locations for a	rch, calculations, vided on the plans work and staking in l. ull work items have	and evaluations s. htervals shall been specified
⊠ Reset Items (Section 210) ⊠ Excavation and Embankment (Section 2 ⊠ Excavation ⊠ Excavation ⊠ Unclassified	203)	e Staking (Y/N)		0.000	Special nterval	_	✓ Manholes (Sec ✓ Inlets (Section ✓ Permanent Wa ✓ Other: Retaini	tion 604) 604) ter Quality BMP (Section ng Wall West Side of G	n 208) Rd North of H	orizon_		the Contractor's surv 3. The Contractor's su items indicated on th		estimate of t s sheet, with	the man—hours r the estimated r	necessary to comp man—hours written	lete the work on the
Stripping Muck Rock Borrow Other: Potholing		aking	- - - -	- - - -	- - - -		and Structure Exco Concrete Box Piling locations	head Signs (Section 614 all other structures ass avation limits (Section 2 Culverts (Section 603) s and cut off elevations ons and elevations (Sec	signed a struct 206) w/ Headwalls (s (Section 502)	ure number and Wingwalls (Sect		Engineer days 4. Stakes and Monumereplaced by the Control 5. The Contractor shall to the Engineer prior	prior to the Presurvey C ents which are damaged ractor at no additional of furnish an As Staked (o to completion of twenty	Conference — or destroyed cost to the [or 3D Design y percent (20	Construction Sud by the progres Department. Modeling Electro 0%) of the plann	urvey. is of construction inic Files) Earthwor ned earthwork in a	shall be k Quantity report ny phase as per the
\omegas Embankment \omegas Site Grading \omegas Erosion Control (Perm) \omegas Other: \omegas Staked Earthwork Quantitie (See General Notes)	nbankm St.	ecified on aking an	- - -	- - -	- - -		Footing locatic Abutment/Pier Wingwall skew Structural con Substructure	ons, alignment, and elev locations, alignment, a	vations ond elevations	Overhead signs (S-	-614-50)	data report and a co Engineer. The Contract 6. Prior to beginning Contractor shall certi 7. The Contractor's su	A printed copy of the A omputer disk with that in ctor shall field verify orig work on any subsequent fy in writing to the Engin urveyor shall perform all	nformation or ginal ground t operation, s ineer that the	n it, in the spec cross sections a such as placing e final grade is	cified format shall at a maximum 500 base course or po within specified tol	be' submitted to the feet intervals. ving, the erance.
□ Landscaping □ Top Soil (Section 207) □ Seeding (Section 212)							Deck grades of Slope and Dita	ot Girder 10th or "n" th ch Paving (Section 507)	point location	s and elevations	,		II coordinate construction	,	, ,	, ,	information recorded shall contain:
Mulching (Section 213) 							ing (Section 607) Temporary Permanent Sound Barrier Other:					date, crew members electronically, inform and related to the tops, shall have the	s' names, point no., des nation recorded shall be supplemental informatior	scription, stak provided to n recorded in ormation relat	king information, the Project Engi In the field books ted to the meas	and sketches. If t ineer in a hard co s. All linear surveys sured information. I	the survey information is collected py format that is intuitive, clear , such as slope stakes and blue Non—linear surveys such as
Seeding (Temp) Silt Fence Erosion Bales Erosion Logs Riprop (Temp)					_	 ⊠ Lighti		nd Traffic Control Device	es (Permanent)	(Section 614)		⊠ Vertical Control ⊠ Property Pin Tie	trol (Primary & Secondar I (i.e. Benchmarks) es	•	dbooks to the Er	ngineer:	
— □ Other: Roadway Bases □ □ Untreated Subgrade □ □ Treated Subgrade □ □ Aggregate Base Course (Sect □ □ Reconditioning □ □ PMBB - Plant Mix Bituminous □ □ Other:	<u>\$</u>	Specified on Staking Plan	(CYAS) - - - - - -	Special Interval — — — — —	Special Offset		□ Light pole local □ Sign locations	cations and elevations ations and elevations and elevations and post locations, elevat	ions, and lengt	hs before fabricati	ion.	 ☒ Horizontal Align ☒ Grading ☒ Slope Staking ☒ Minor Structure ☒ Major Structure ☒ One fieldbook f ☒ Other Fieldbook 11. The Contractor's sur 	es es for each work category s c(s):			on the project) to	the Engineer:
Driet Date: 6 /49 /0004 7 40 00 41	Т	Т		Ch	+ Davistere						<u> </u>		trument Calibrations	AND C	S BU BUI	INDAROUT	
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Unit Information: City of GJ Unit Leader Ir								606 South 9th S Grand Junction, 9	CO, 81501	270 007 0700	Pavia	evisions: ed:		100	Structure		23652
Grand Junction Grand Junction Grand Junction Phone: 970-	AVE, BLDG C tion, CO, 81501 -244-1554						Region 3	Phone: 970–683-	-0331 FAX:	970–683–6369 KC	Void:		Detailer: SURVEY TABULATION	****	Numbers Subset Sheets:	X of X	Sheet Number 25



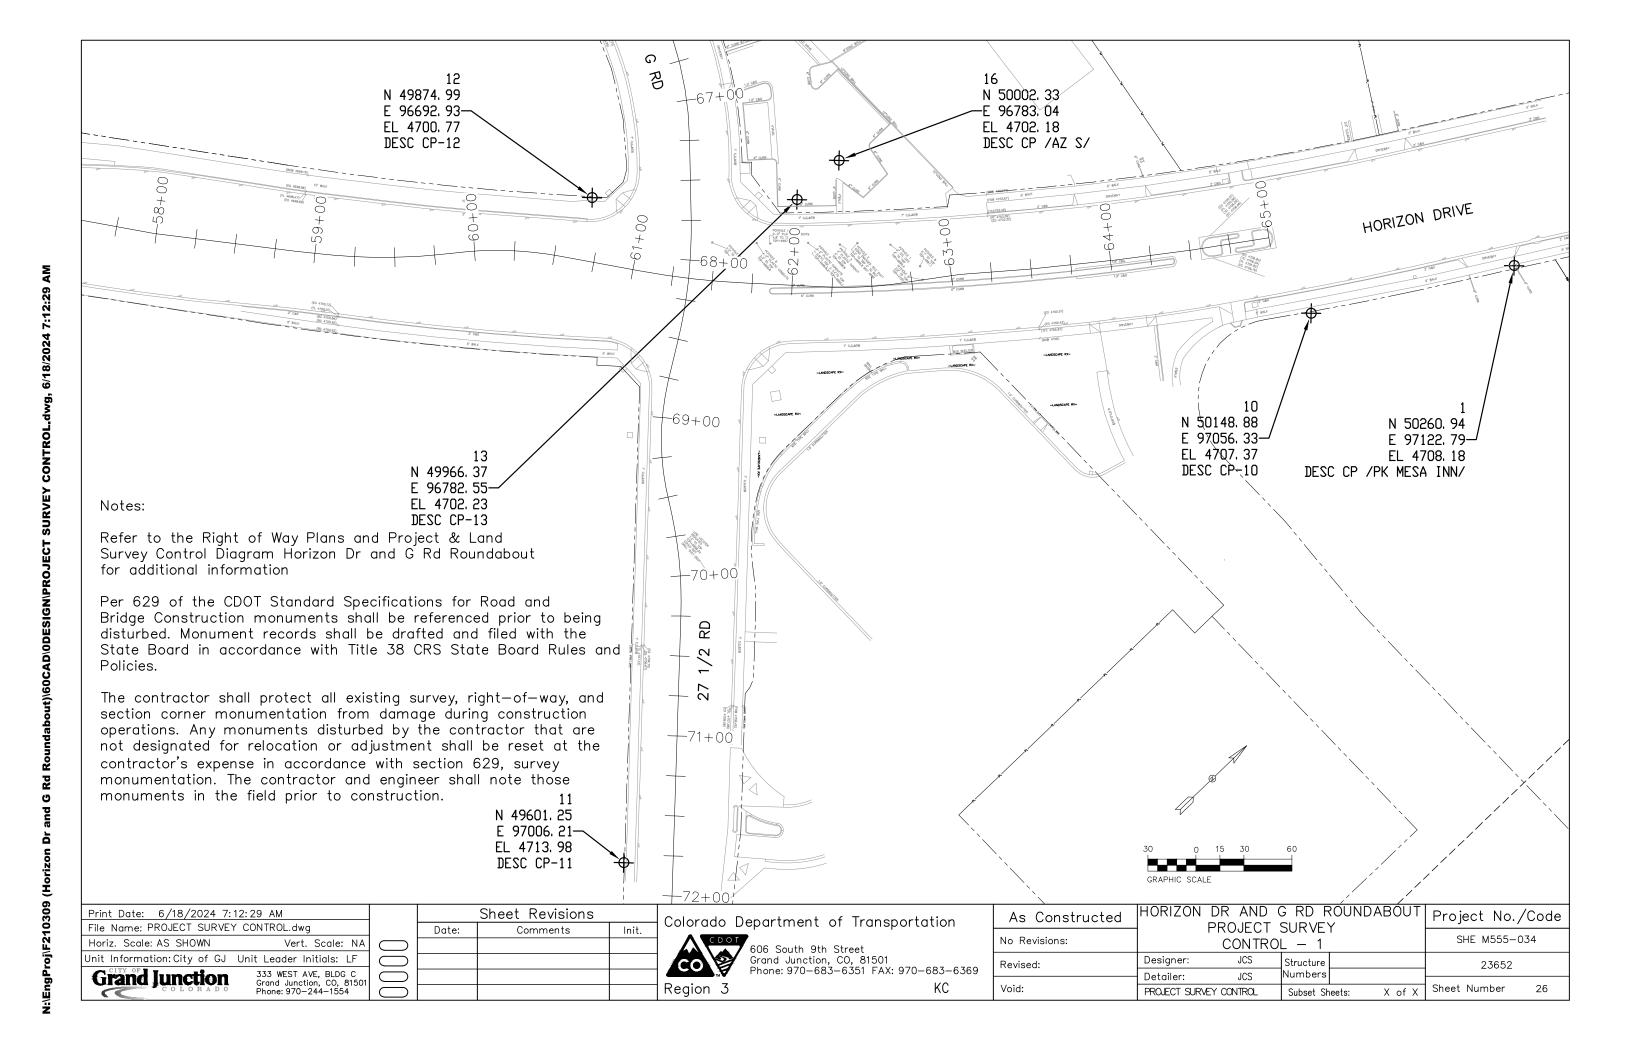

Sheet Subset: STAKING PLAN | Subset Sheets:

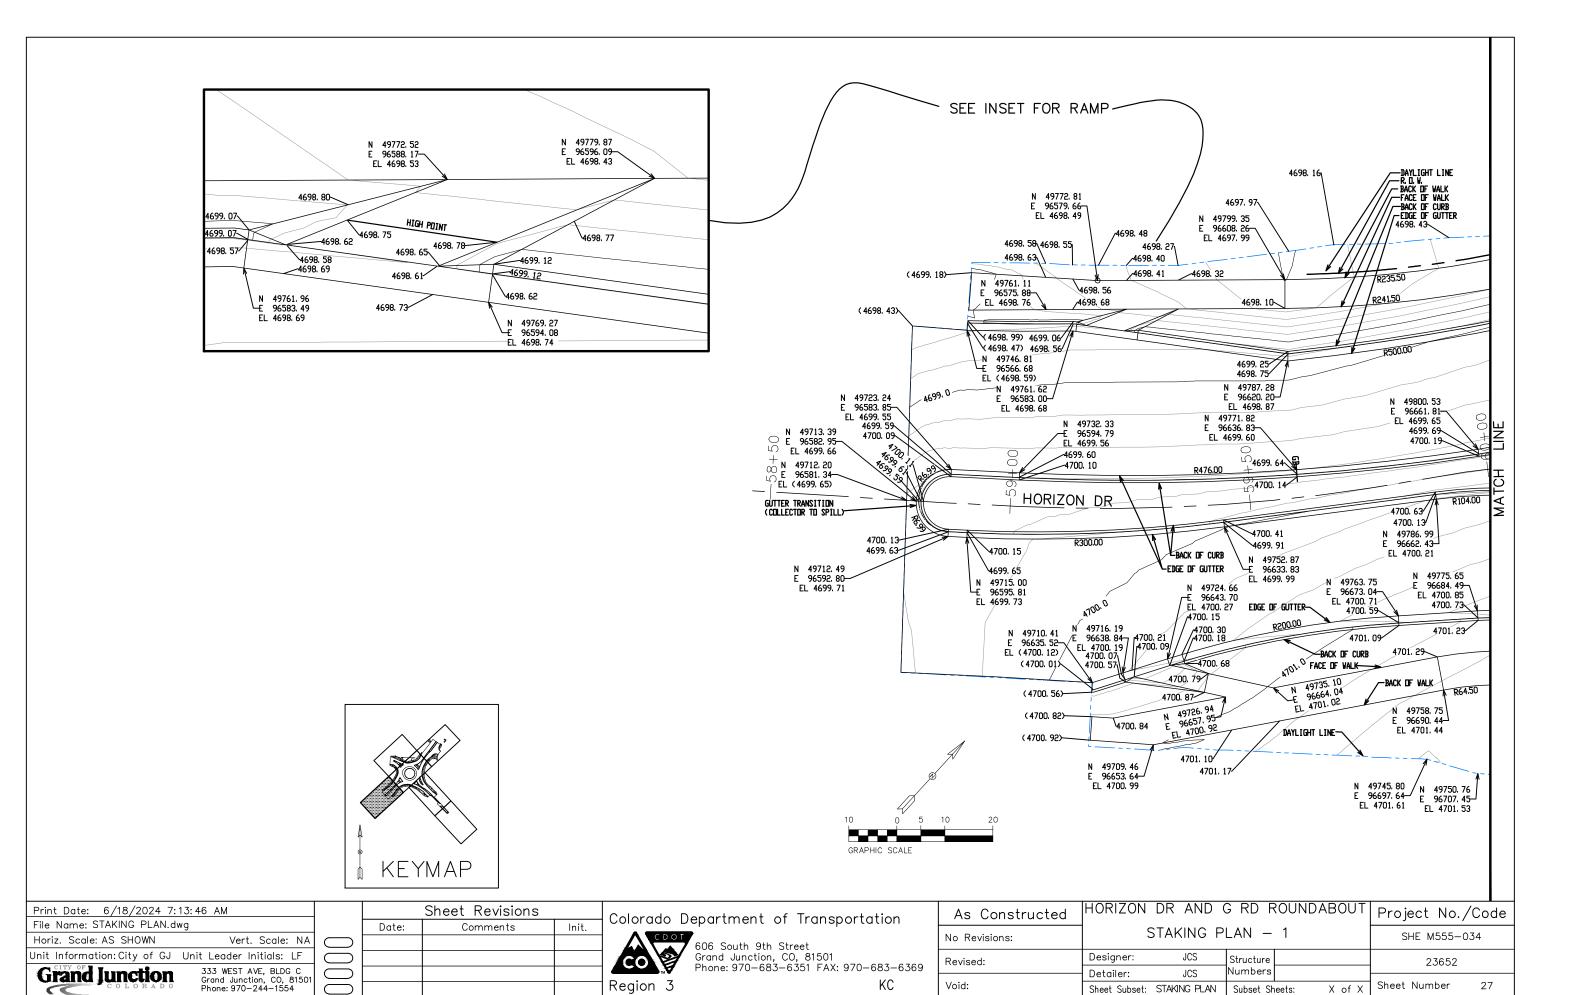X of X

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E 96698. 23 EL 4699. 50

E 96669, 88-

EL 4698. 21

49892. 26

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BACK DIF CURB

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4700, 14

49957, 92

96716. 63

96720, 05

EL 4700, 40

N 49998.09 E 96789.19

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E 96849, 15— EL (4703, 57)

N 50030.78

96743, 67

BACK OF VALK


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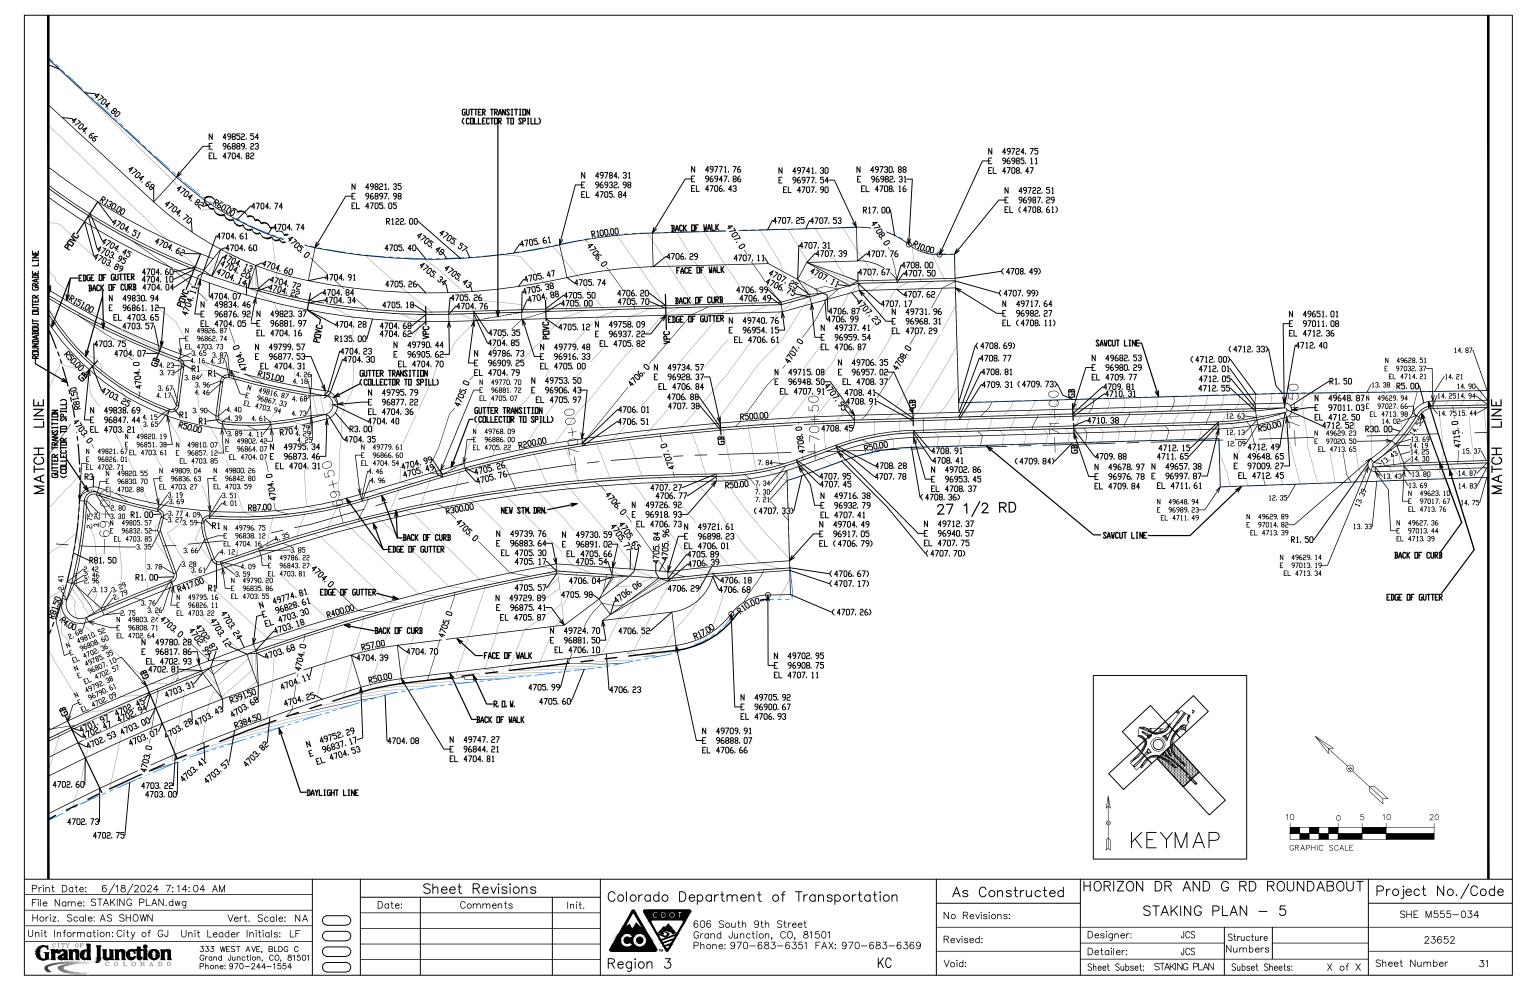


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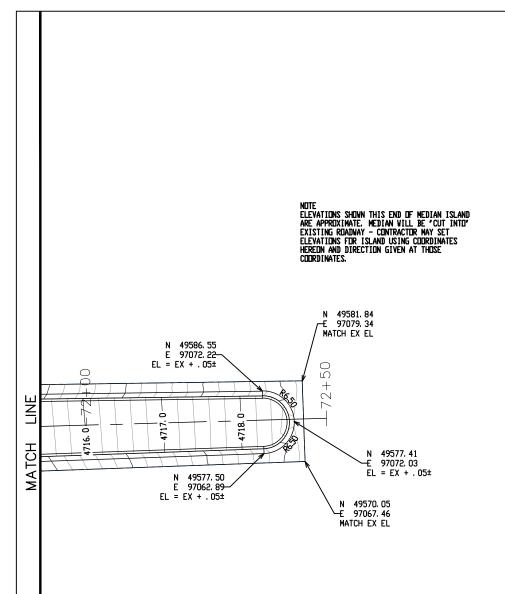
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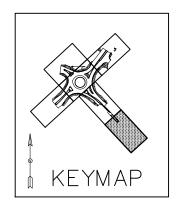
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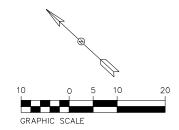






27 1/2 RD

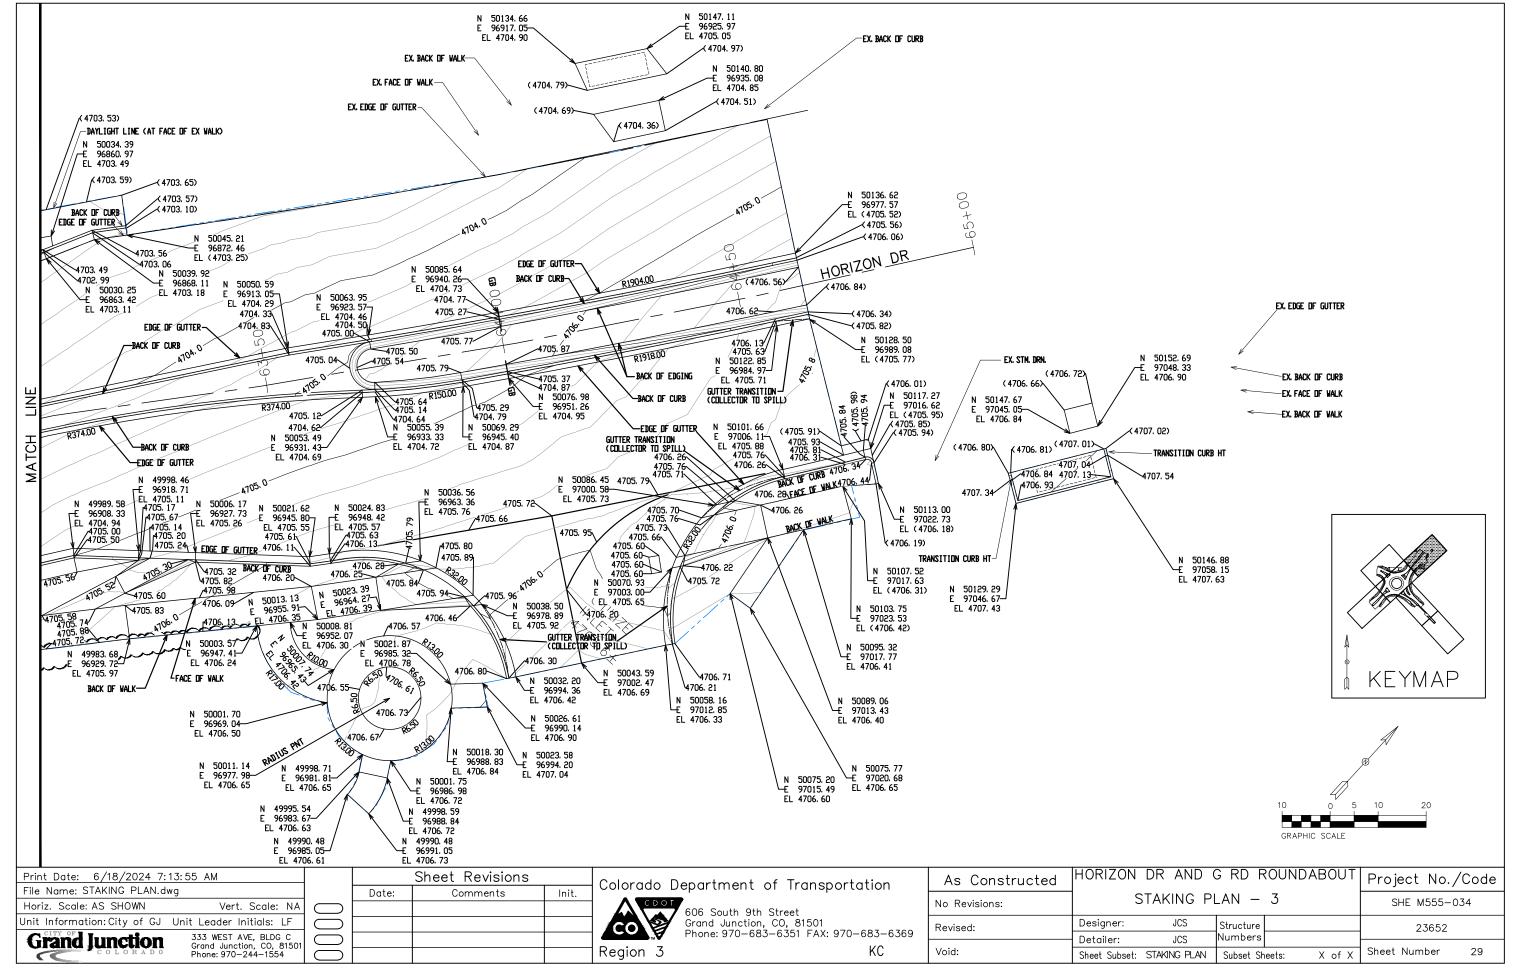




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Unit Information: City of GJ Unit Leader Initials: LF			
Grand Junction 333 WEST AVE, BLDG C Grand Junction, CO, 81501			
COLORADO Phone: 970-244-1554			

Colorado D	epartment of Transportation
CO	606 South 9th Street Grand Junction, CO, 81501 Phone: 970-683-6351 FAX: 970-683-6369

Region 3

KC

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Region 3
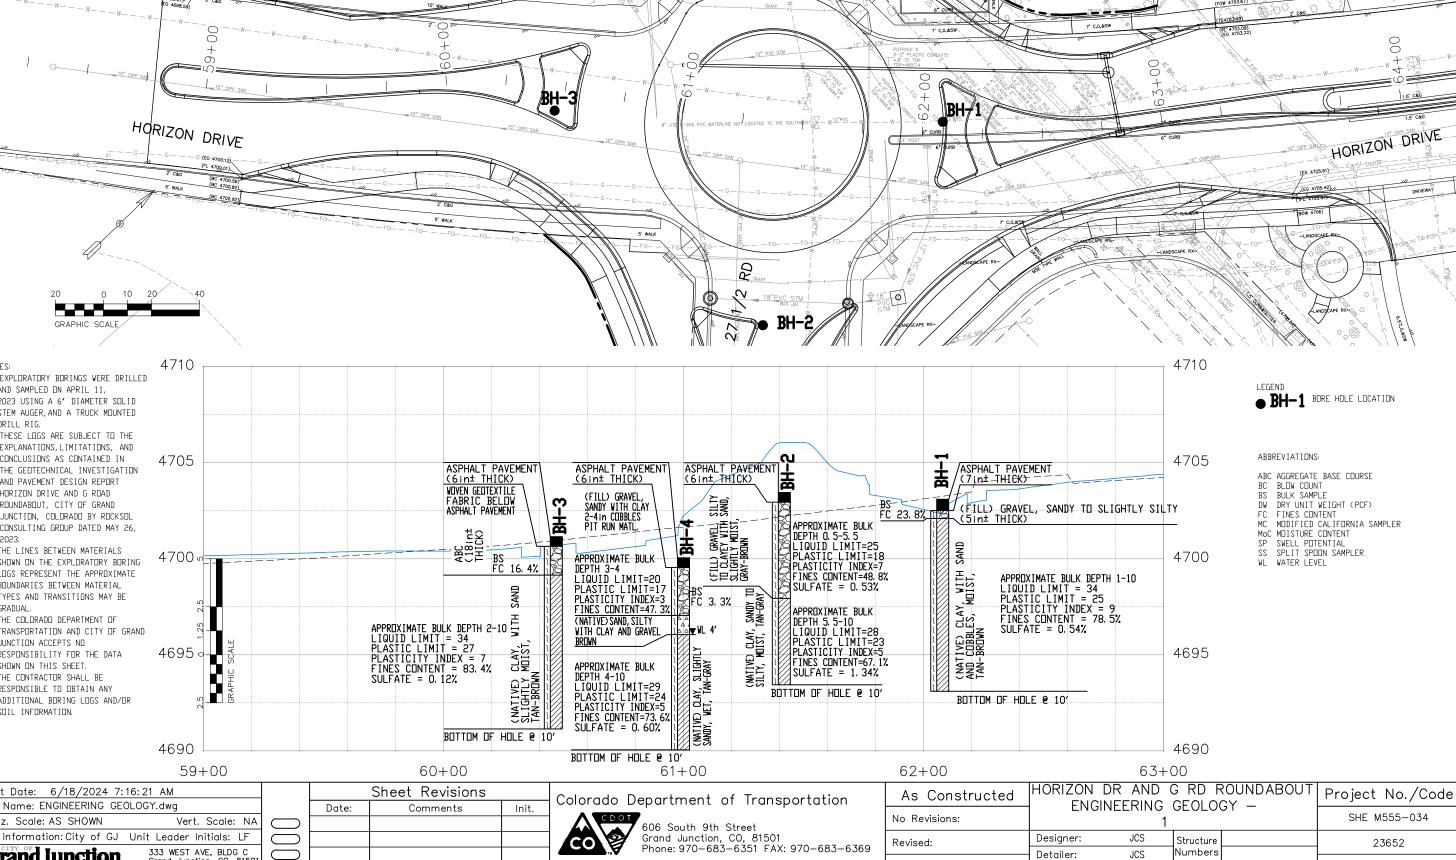
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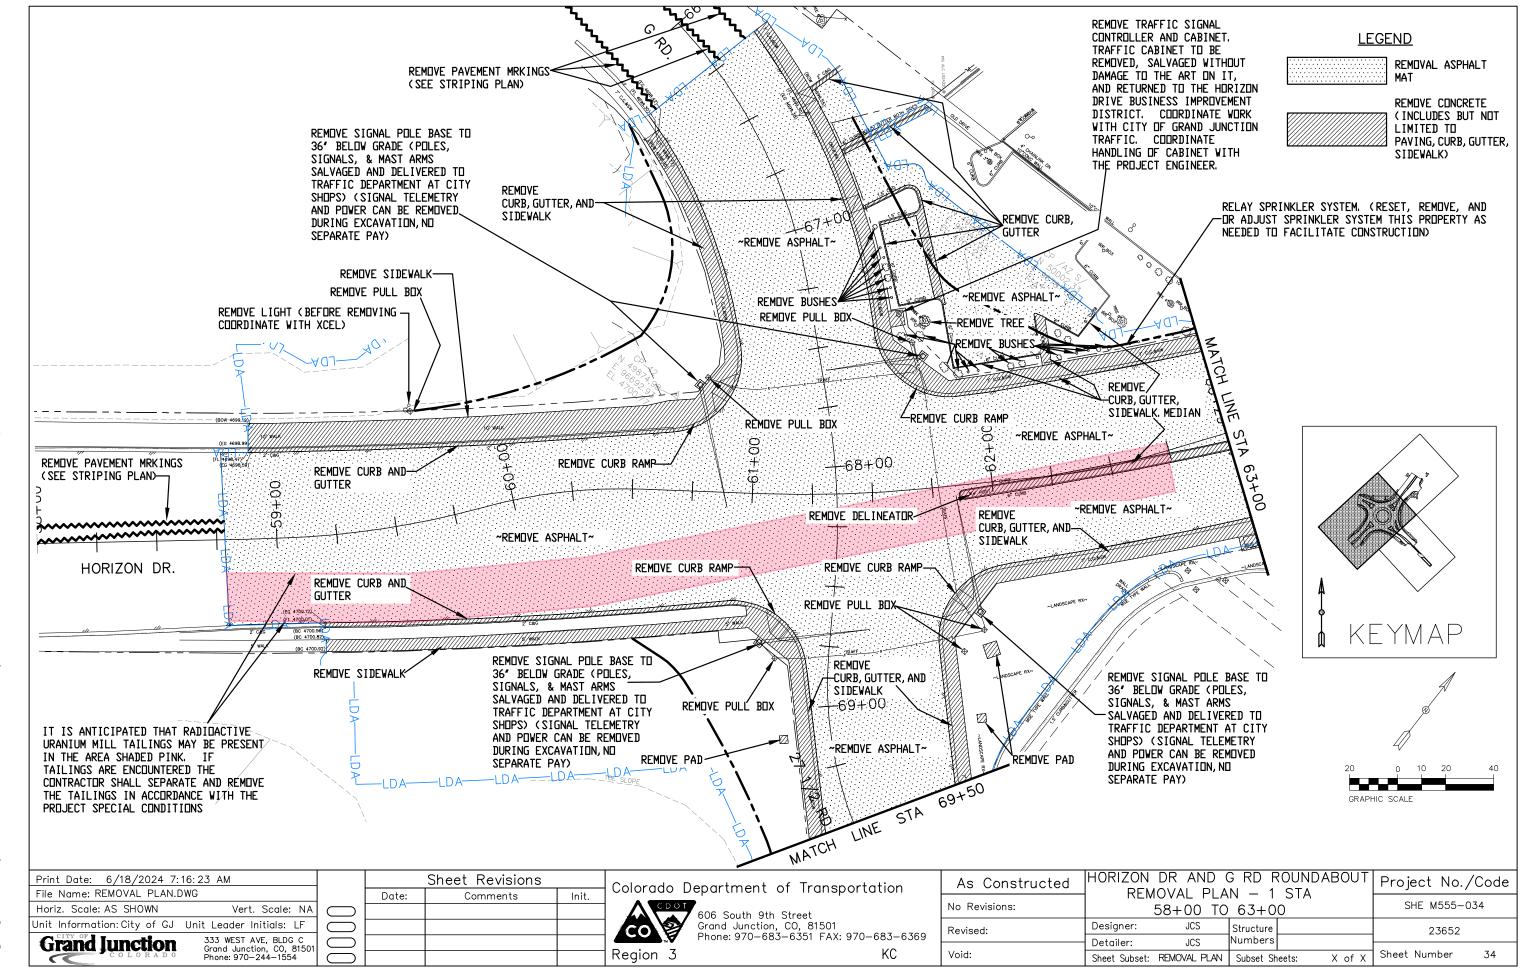
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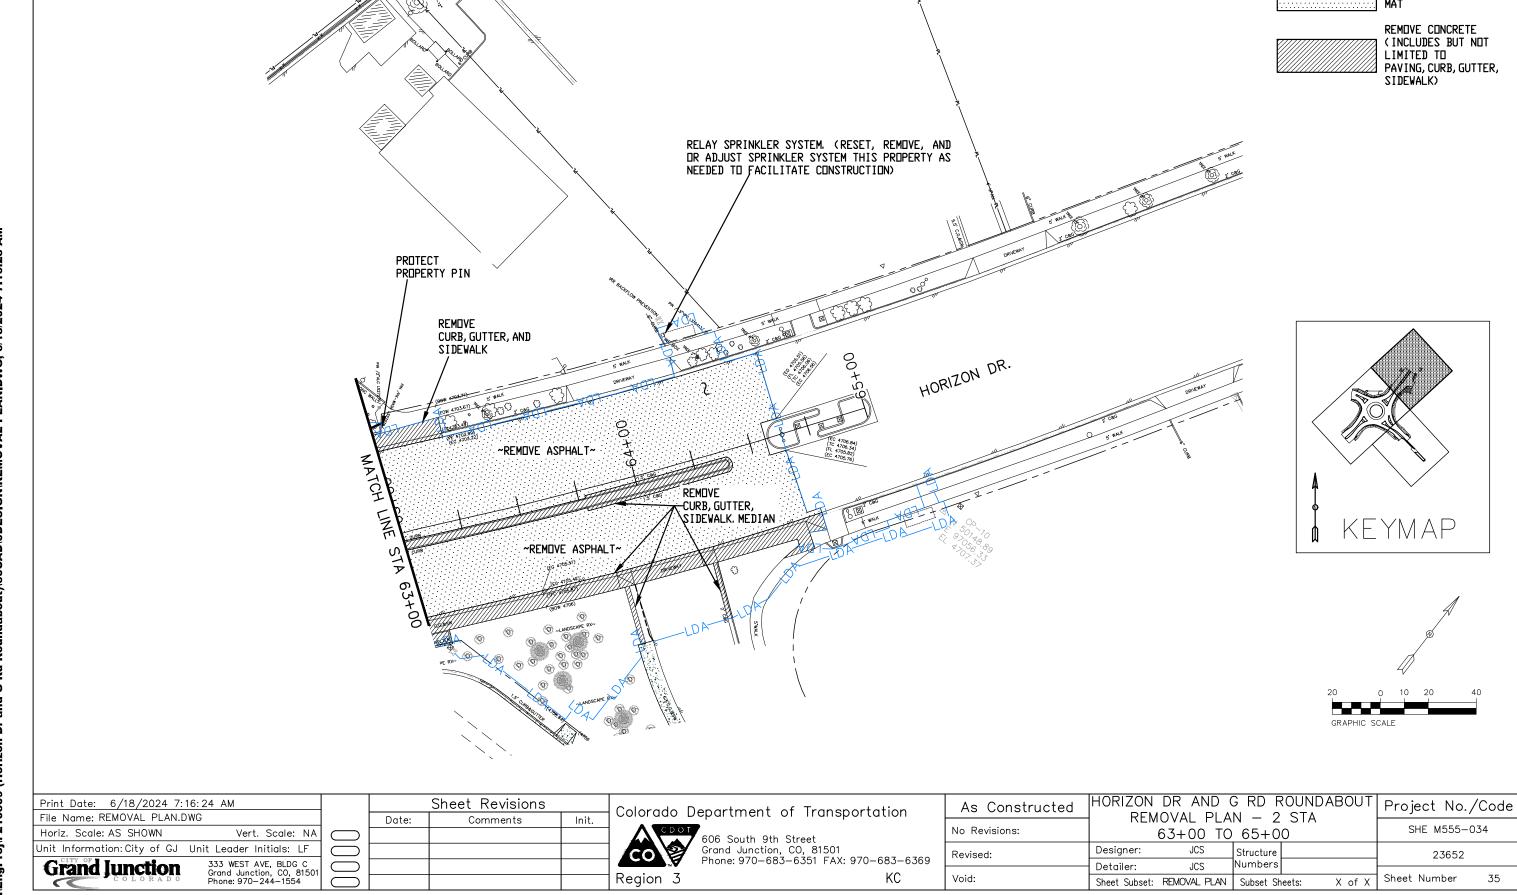
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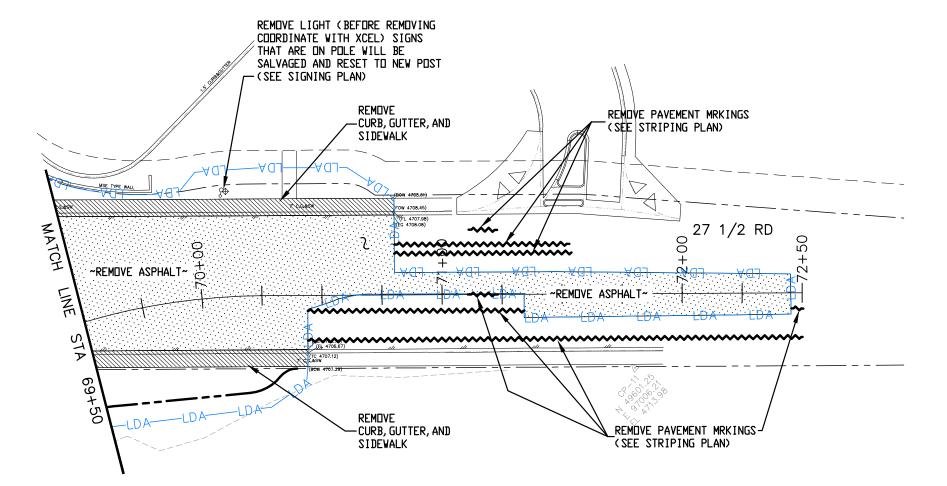
REMOVAL ASPHALT


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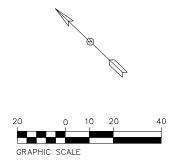


REMOVAL ASPHALT MAT

REMOVE CONCRETE (INCLUDES BUT NOT LIMITED TO PAVING, CURB, GUTTER, SIDEWALK)





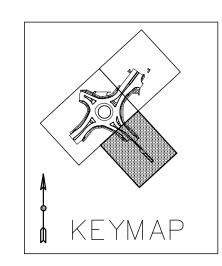

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Grand Junction	333 WEST AVE, BLDG C Grand Junction, CO, 81501	,
COLORADO	Phone: 970-244-1554	1 (

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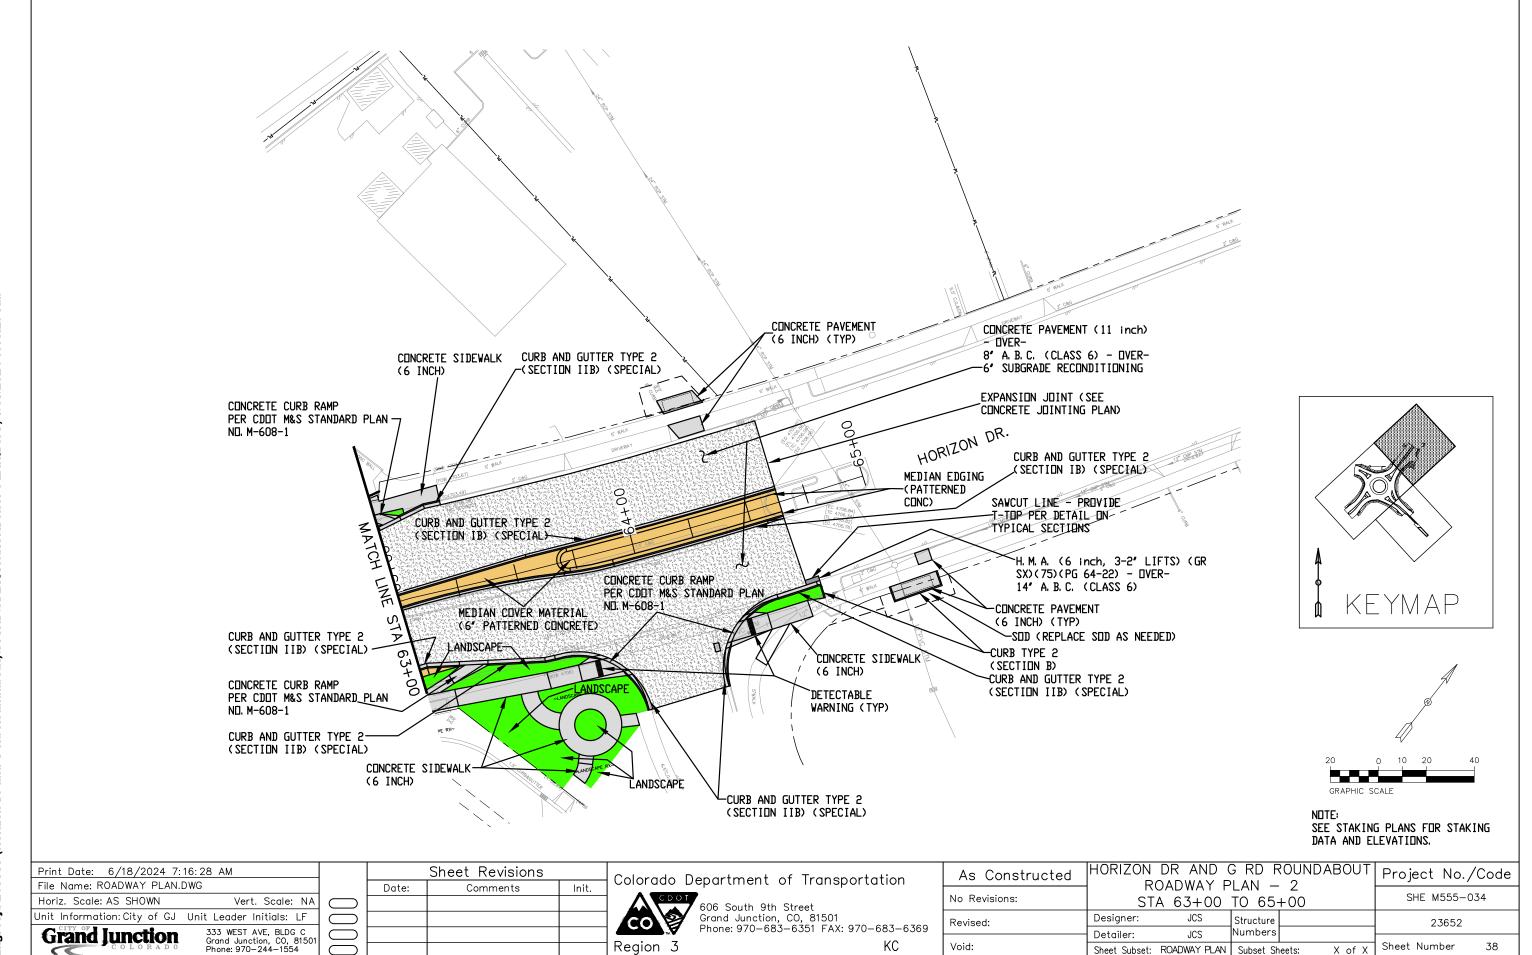
Colorado	Department of Transportation
co S	606 South 9th Street Grand Junction, CO, 81501 Phone: 970-683-6351 FAX: 970-683-636


Region 3

7	606 South 9th Street Grand Junction, CO, 81501 Phone: 970-683-6351 FAX: 970-683-6369
	KC

As Constructed	HORIZON	DR AND (Project No./Code				
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File Name: ROADWAY PLAN.DWG

Horiz. Scale: AS SHOWN Vert. Scale: NA

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Grand Junction, CO, 81501
Phone: 970-244-1554

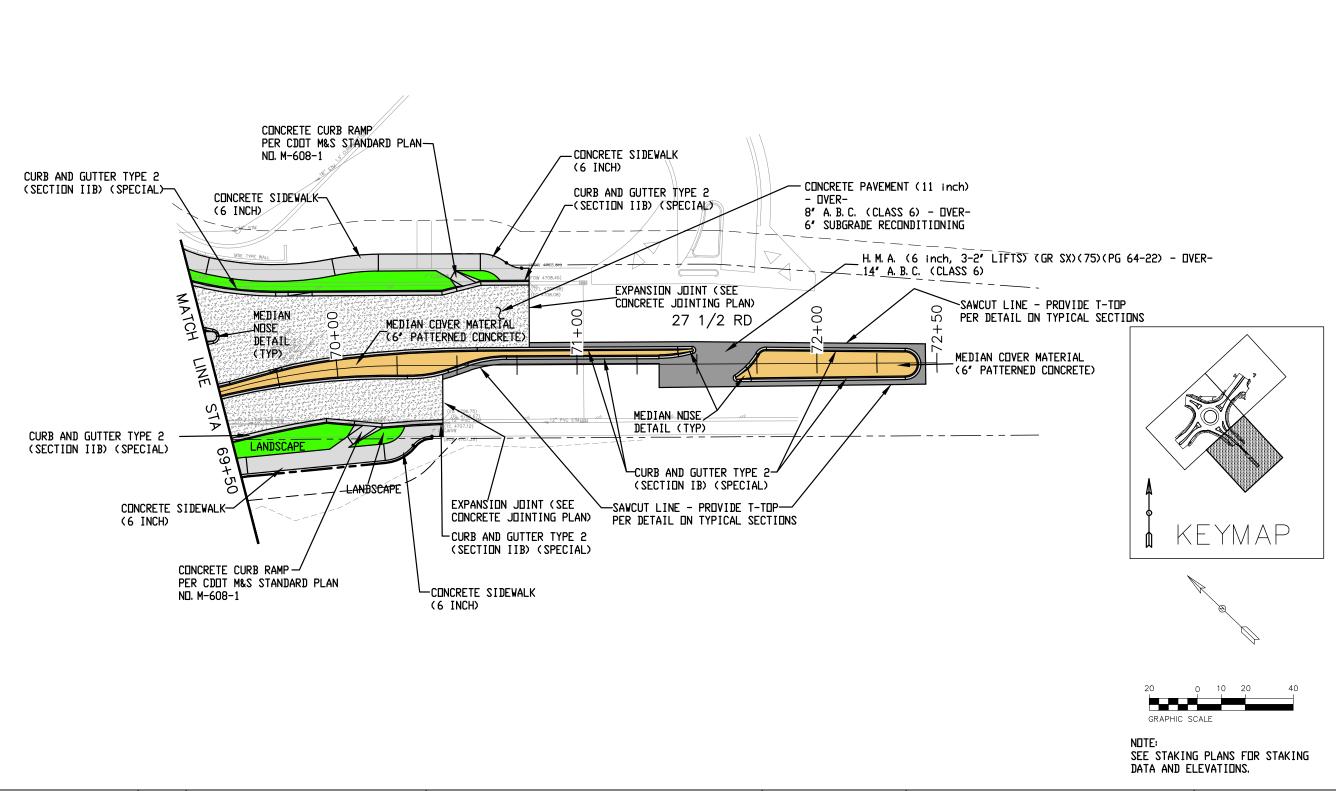Sheet Revisions

Date: Comments Init.


Colorado Department of Transportation


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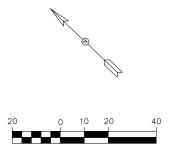
Region 3

606 South 9th Street Grand Junction, CO, 81501 Phone: 970-683-6351 FAX: 970-683-6369

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Colorado D	epartment of Transpor	tation
CO	606 South 9th Street Grand Junction, CO, 81501 Phone: 970-683-6351 FAX: 970)–683–63
Region 3		KC

7	606 South 9th Street Grand Junction, CO, 81501 Phone: 970-683-6351 FAX: 970-683-6369
,	KC
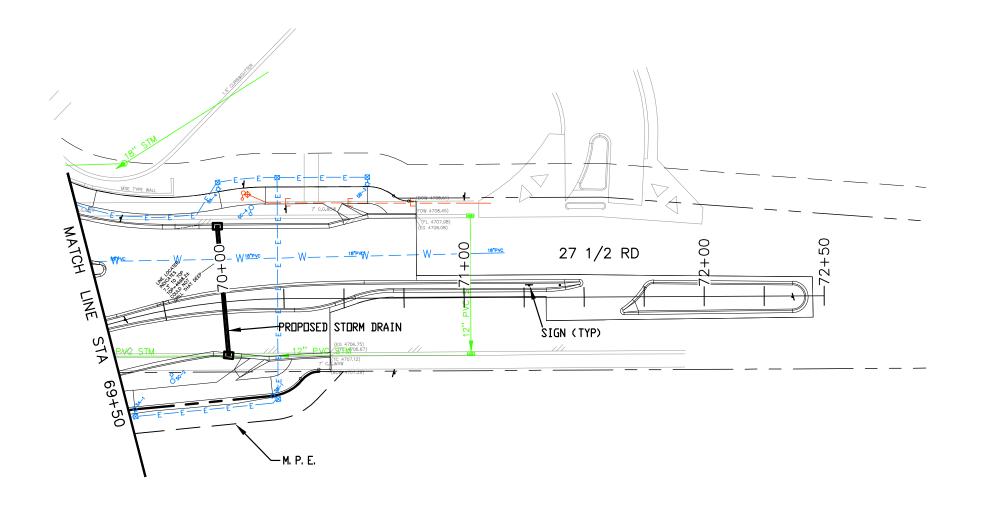
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TABULATION OF DRAINAGE ITEMS

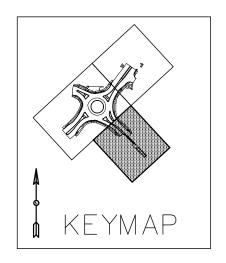TABULATION OF DRAINAGE ITEMS									
STATION			005) INLET . (5 FOOT)			(604-30010) MANHOLE SLAB BASE (10 FOOT)		COMMENTS	
		LF	EA			EA	1	EA	
	Plan	As Const	Plan	As Const	Plan	As Const	Plan	As Const	
HORIZON DRIVE									
60+96, 18' LT TO 62+81, 22' LT	177								PIPE (A2)
62+81, 22' LT							1		MH (A1)
62+80, 29' LT			1						INLET (AA1)
62+80, 29' LT TO 62+81, 22' LT	7								PIPE (AA2)
62+81, 22' LT TO 62+82, 4' RT	26								PIPE (AA3)
62+82, 4' RT					1				INLET (AA4)
27 1/2 ROAD									
68+88, 9' RT							1		MH (R7)
68+79, 48' LT							1		MH (R8)
70+00, 22' RT					1				INLET (B1)
70+00, 22' RT TO 70+00, 32' LT	54								PIPE (B2)
70+00, 32' LT			1						INLET (B3)
SHEET 1 SUBTOTAL	264		2		2		3		


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Unit Information: City of GJ Unit Leader Initials: LF			
Grand Junction 333 WEST AVE, BLDG C Grand Junction, CO, 81501			
C O L O R A D O Phone: 970–244–1554			

Colorado Department of Transportation

606 South 9th Street
Grand Junction, CO, 81501
Phone: 970-683-6351 FAX: 970-683-6369

Region 3

As Constructed		G RD ROUNDABOUT OF DRAINAGE	Project No./Code
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	Detailer: JCS	Numbers	
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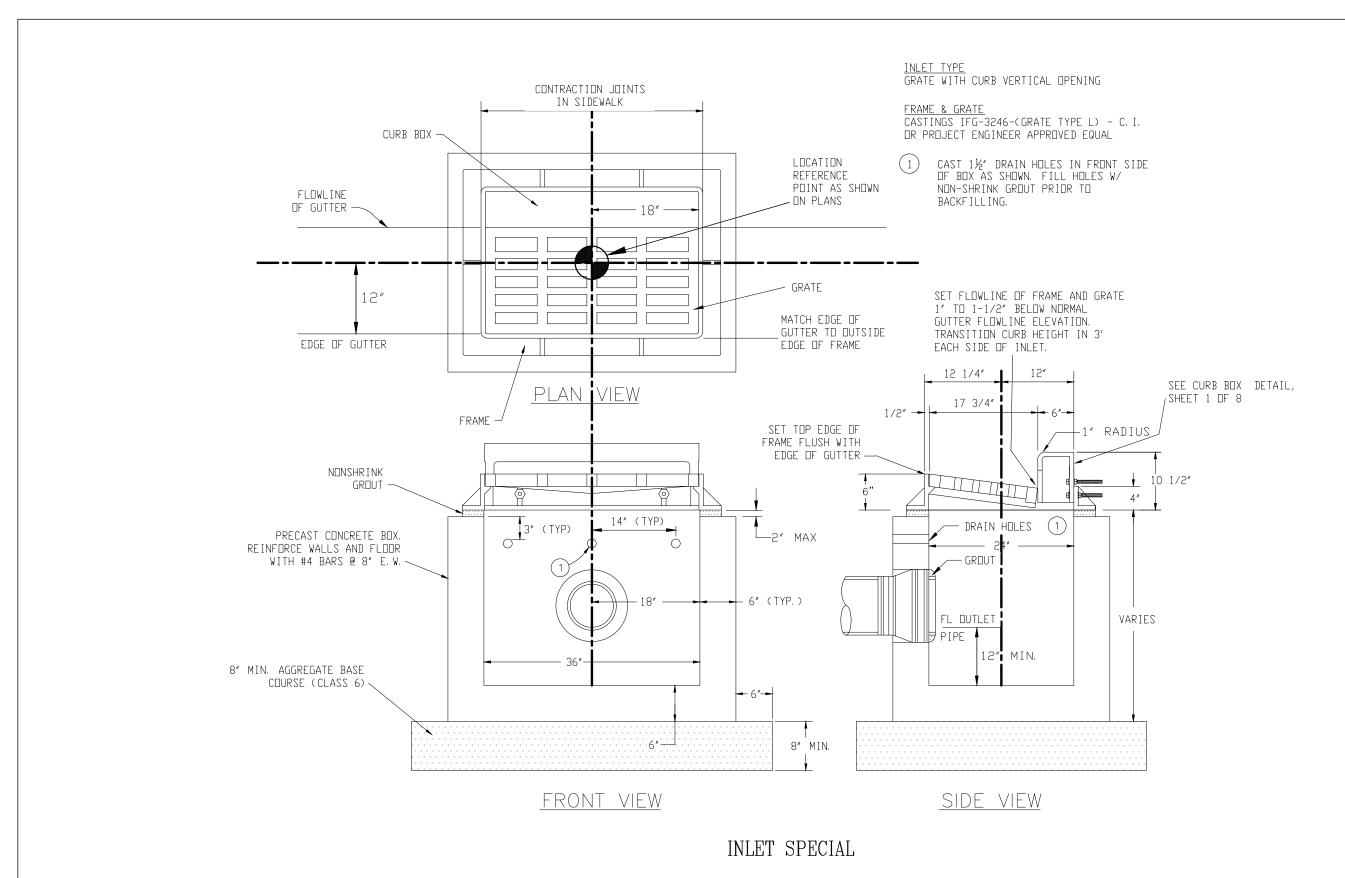
INLET CURB BOX DETAIL
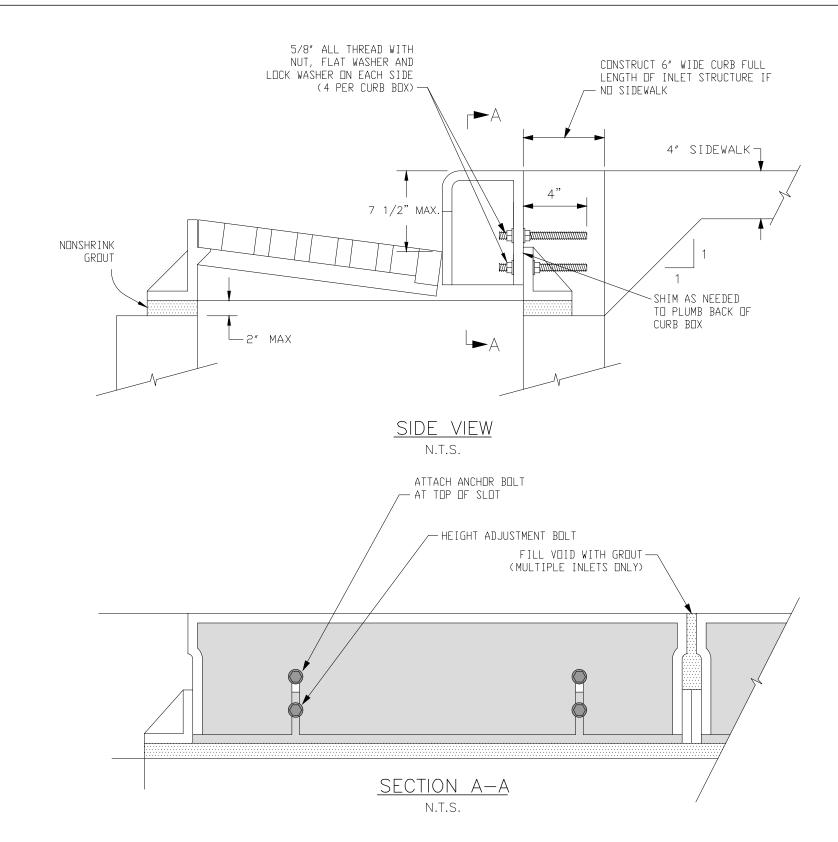
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Grand Junction 333 WEST AVE, BLDG C Grand Junction, CO, 81501 Phone: 970-244-1554					
Grand Junction, CO, 81501 Phone: 970–244–1554					Reg


Colorado De	partment of Transp	ortation
CO	606 South 9th Street Grand Junction, CO, 81501 Phone: 970—683—6351 FAX:	970-683-6369
Region 3		KC

As Constructed	HORIZON DR AND G RD ROUNDABOUT DRAINAGE DETAILS —					Project No./Code		
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Horiz. Scale: AS SHOWN Vert. Scale: NA				C D O	606 South 9th Street	No Revisions:		SHEE	T 2		SHE M555-034
Unit Information: City of GJ Unit Leader Initials: LF					Grand Junction, CO, 81501 Phone: 970-683-6351 FAX: 970-683-6369	Revised:	Designer:	JCS	Structure		23652
Grand Junction 333 WEST AVE, BLDG C Grand Junction, CO, 81501				TM V	Phone: 9/0-683-6351 FAX: 9/0-683-6369		Detailer:	JCS	Numbers		
Grand Junction, CO, 81501 Phone: 970–244–1554				Region 3	KC	Void:	Sheet Subset: DF	RAINAGE DETAILS	Subset Sheets:	X of X	Sheet Number 46



NONSHRINK GROUT NEW PIPE PIPE D. D. PLUS 4" TYP. 12" MIN.

RUBBER "O" RING

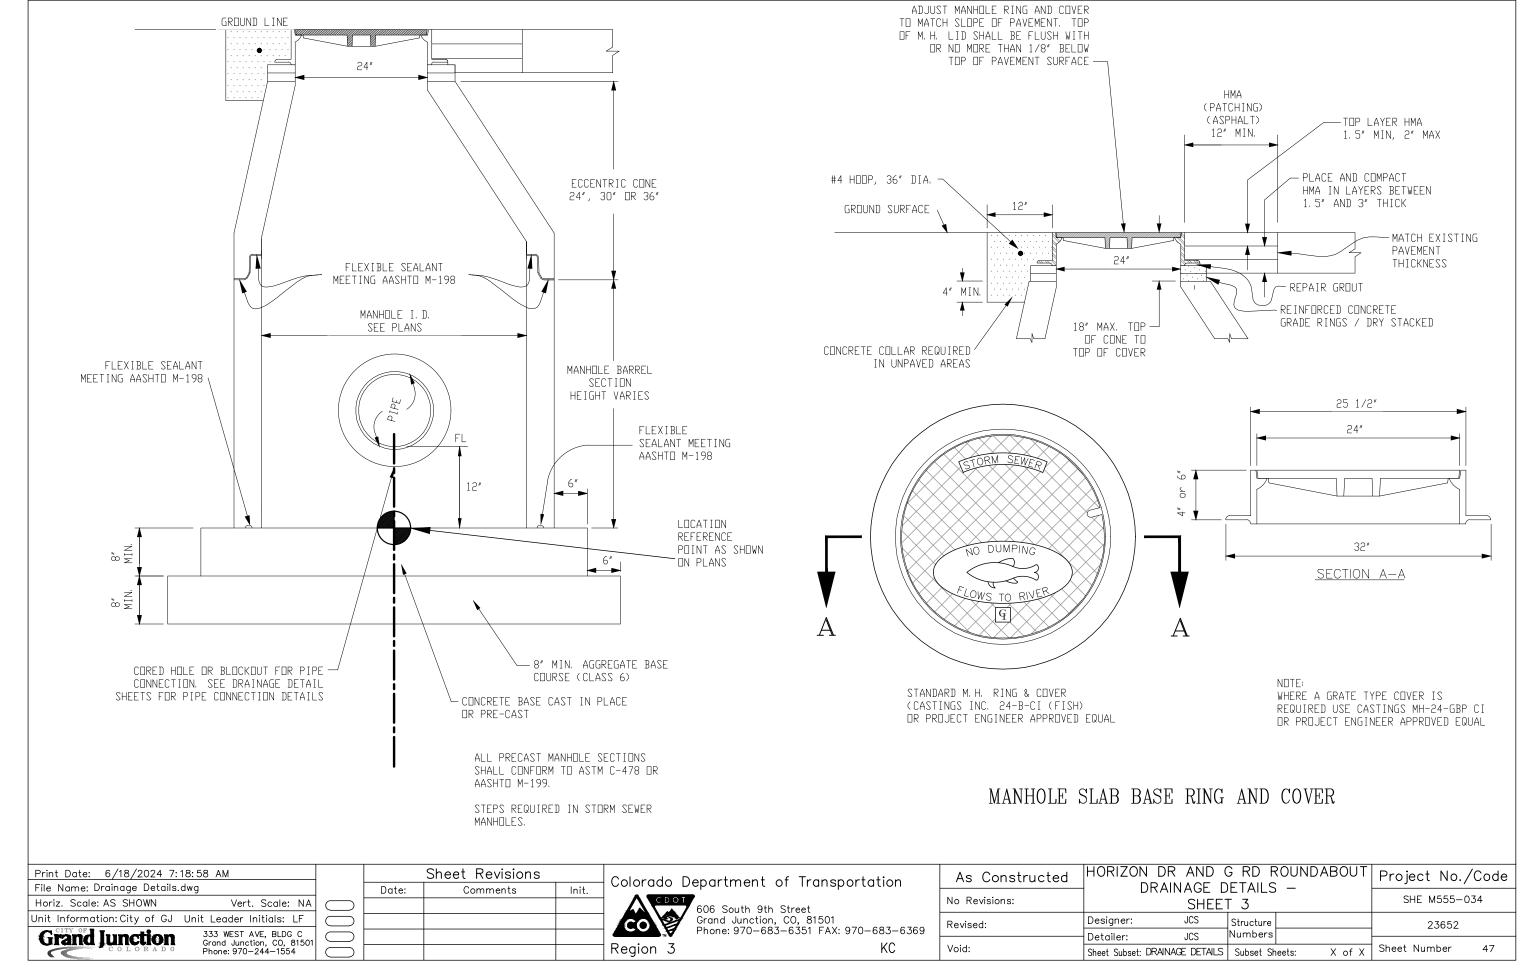CO)

GROUTED PIPE CONNECTION

1" MAX. —

(FOR CONNECTIONS TO EXISTING STRUCTURES)


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Colorado Department of Transportation

606 South 9th Street Grand Junction, CO, 81501 Phone: 970–683–6351 FAX: 970–683–6369 Region 3

GENERAL NOTES


- BACKFILL AROUND MANHOLES, INLET BOXES, AND OTHER STRUCTURES SHALL BE PLACED IN 8" LODSE LIFTS AND COMPACTED TO 95% AASHTO T-180.
- ALL BACKFILL MATERIAL SHALL BE UNIFORMLY ADJUSTED TO WITHIN 2% OF THE OPTIMUM MOISTURE CONTENT PRIOR TO PLACEMENT AND COMPACTION.
- ALL PORTLAND CEMENT CONCRETE SHALL BE CLASS "B". (SECTION 601.02).
- ANY EXISTING PAVEMENT NOT DESIGNATED FOR REMOVAL WHICH IS DAMAGED BY CONSTRUCTION SHALL BE REPLACED IN-KIND BY CONTRACTOR.
- SEE APPROVED CONSTRUCTION DRAWINGS FOR ALL LOCATIONS, GRADES AND ELEVATIONS OF ALL DRAINAGE IMPROVEMENTS.
- MANHOLE RING AND COVER AND INLET GRATE AND FRAME SHALL BE ADJUSTED TO FINISHED GRADE USING NON-SHRINK GROUT AND PRE-CAST CONCRETE GRADE RINGS. GROUT THICKNESS SHALL NOT EXCEED 2 INCHES. GROUT SHALL BE PLACED UNDER THE CAST IRON RING OR FRAME. NO GROUT SHALL BE PLACED BETWEEN THE CONCRETE GRADE RINGS. STEEL GRADE ADJUSTMENT RINGS MAY BE USED FOR ADJUSTMENT OF MANHOLE COVERS ONLY WHEN STREETS ARE OVERLAID.
- 7. ALL WORK SHALL BE IN ACCORDANCE WITH APPROVED PLANS.
- STORM DRAIN INLET BOXES MAY BE MADE FROM STACKABLE PRECAST BOX SECTIONS WITH TONGUE AND GROOVE JOINTS AND FLEXIBLE SEALANT BETWEEN SECTIONS. THE TOP SECTION OF THE INLET BOX SHALL HAVE A GROOVE-LESS FLAT SURFACE TO SUPPORT THE INLET FRAME AND GRATE.

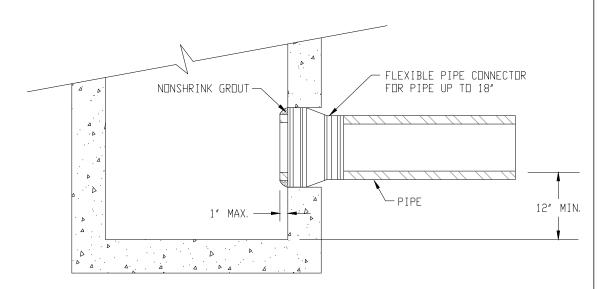



PVC PIPE CONNECTION

INLET CURB BOX DETAIL


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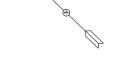


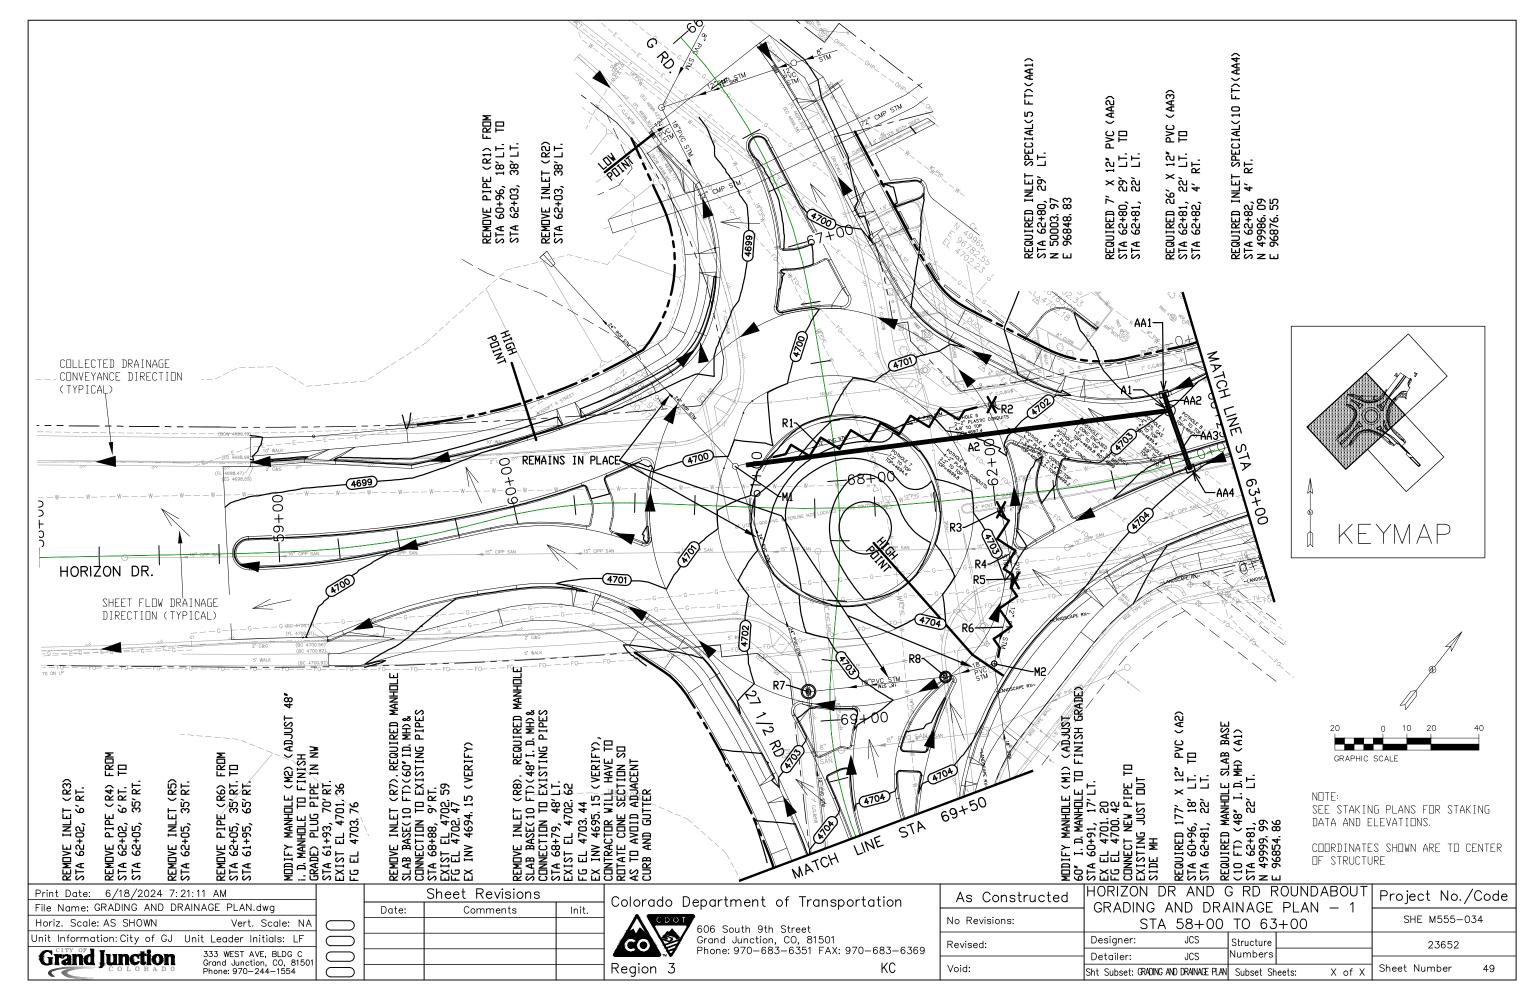


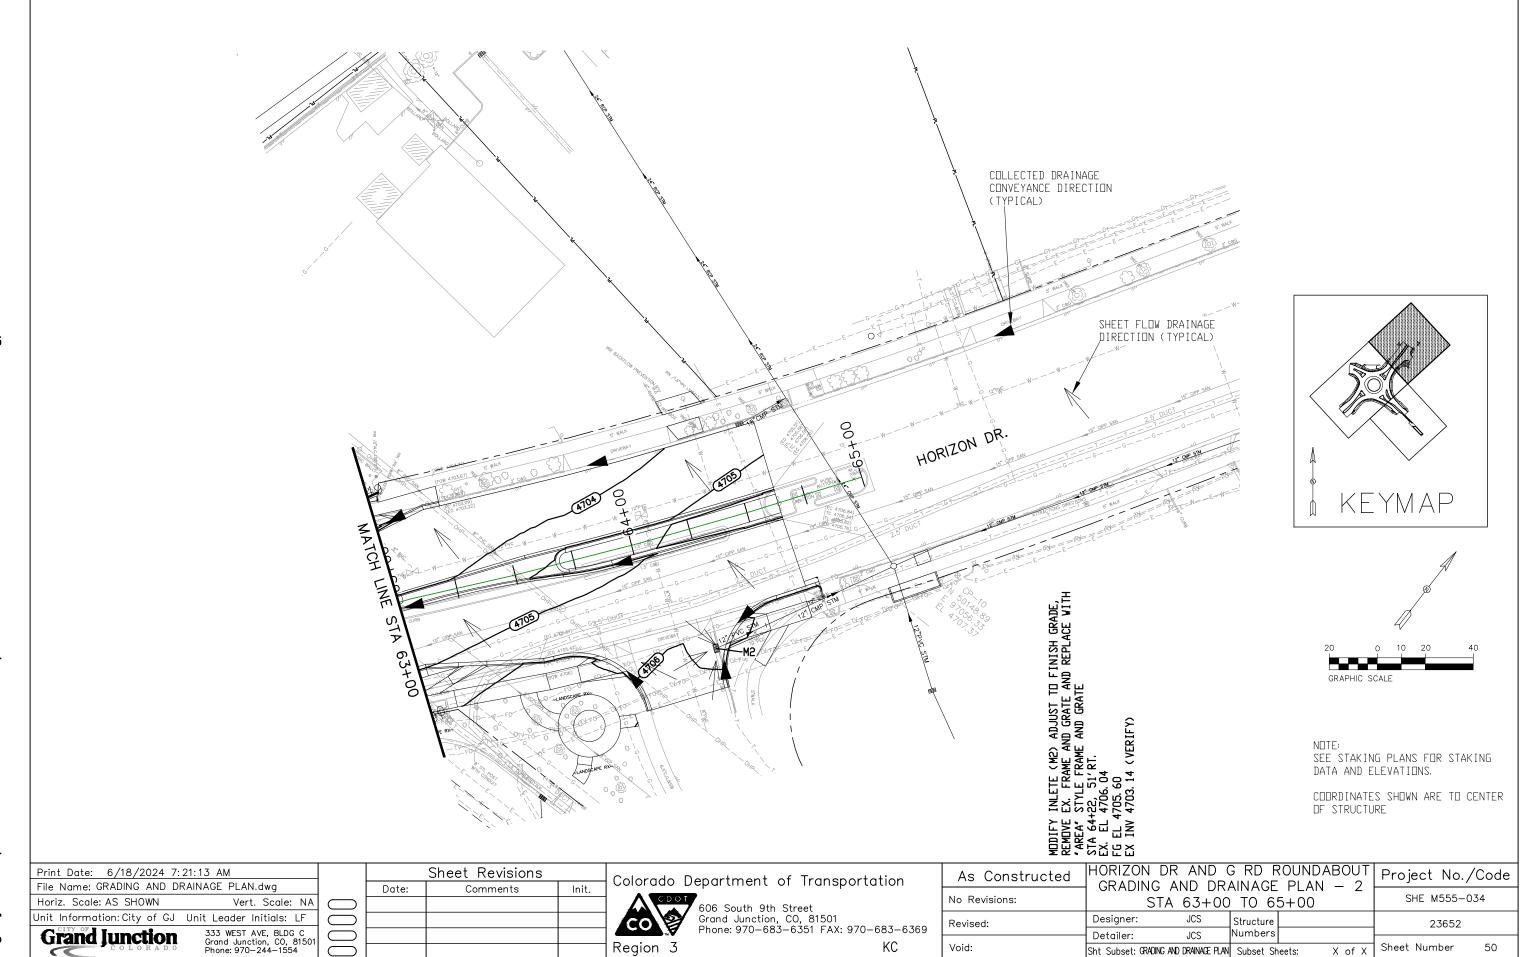

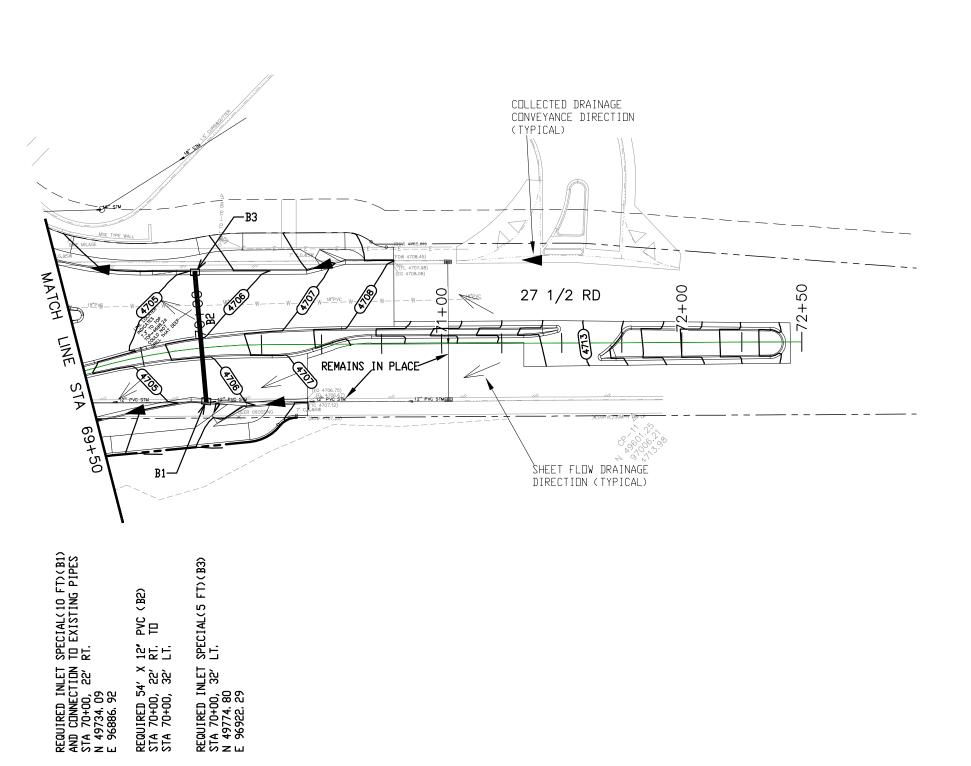Region 3



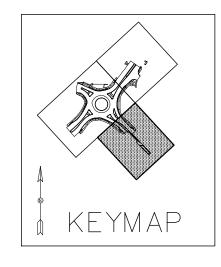

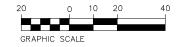

NOTE: SEE STAKING PLANS FOR STAKING DATA AND ELEVATIONS.

COORDINATES SHOWN ARE TO CENTER OF STRUCTURE

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Unit Information: City of GJ					
Grand Junction	333 WEST AVE, BLDG C Grand Junction, CO, 81501 Phone: 970-244-1554				

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Colorado [Department of	Transportation
CO	606 South 9th Sti Grand Junction, Co Phone: 970-683-6	reet 0, 81501 6351 FAX: 970—683—6


7	606 South 9 Grand Junct Phone: 970—		683–63	369
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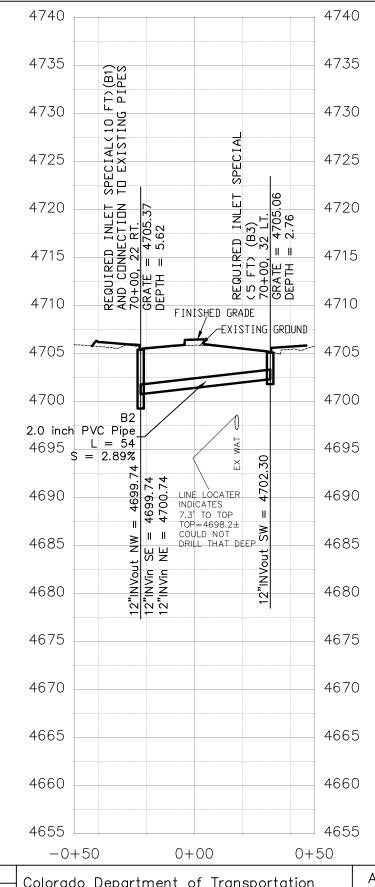
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Call before you dig.

Know what's below.

- ALL MANHOLE SLAB BASE STRUCTURES AND INLET

STRUCTURES SHALL HAVE A 12 INCH SUMP PROVIDED BELOW THE LOWEST PIPE INVERT OUT ELEVATION, (TYP.)

333 WEST AVE, BLDG C Grand Junction, CO, 81501 Phone: 970-244-1554
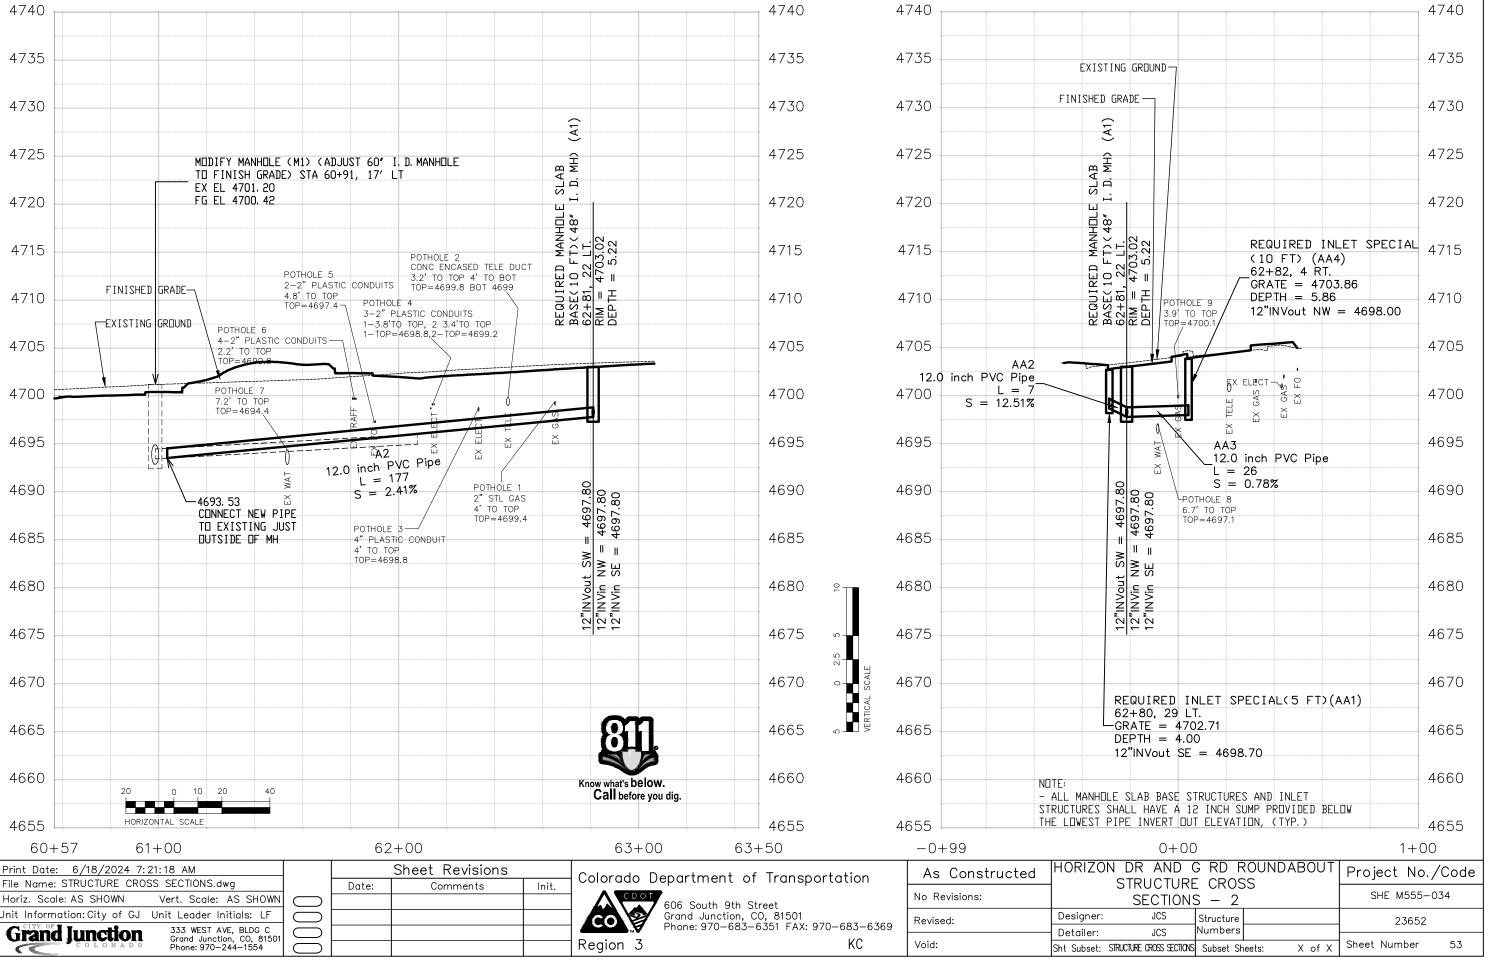
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CO	606 South 9th Grand Junction, Phone: 970—683
Region 3	

Street 3-6351 FAX: 970-683-6369 KC

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TABULATION OF SANITARY SEWER ITEMS

TABOLA	VER ITEM 108) 8 INCH TIC PIPE					
STATION	(604-30005) MANHOLE SLAB BASE (5 FOOT)		SE (POL	EWER .YVINYL ORIDE)	COMMENTS	
		EA		LF		
	Plan	As Const	Plan	As Const		
HORIZON DRIVE						
69+09, 51' RT	1				SSMH (A1)	
69+12, 17' RT TO 69+09, 51' RT			34		PIPE (A2)	
SHEET 1 SUBTOTAL	1		34			

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File Name: TABULATION OF S	ANITARY SEWER ITEMS.dwg	Date:	
Horiz. Scale: AS SHOWN	Vert. Scale: NA		
Unit Information: City of GJ			
Grand Junction	333 WEST AVE, BLDG C Grand Junction, CO, 81501		
COLORADO	Phone: 970-244-1554		

	Sheet Revisions							
Date:	Comments	Init.						

Colorado Department of Transportation

606 South 9th Street
Grand Junction, CO, 81501
Phone: 970-683-6351 FAX: 970-683-6369

Region 3

As Constructed	1	G RD ROUNDABOUT OF SANITARY	Project No./Code
No Revisions:		ITEMS - 1	SHE M555-034
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GENERAL SEWER NOTES

- A. CONTRACTOR SHALL HAVE ONE SIGNED COPY OF PLANS AND A COPY OF THE CITY OF GRAND JUNCTION'S STANDARD SPECIFICATIONS AT THE JOB SITE AT ALL TIMES.
- B. ALL SEWER MAINS SHALL BE PVC SDR 35 (ASTM 3034) UNLESS OTHERWISE NOTED.
- C. ALL SEWER MAINS SHALL BE LAID TO GRADE UTILIZING A PIPE LASER.
- D. ALL SERVICE LINE CONNECTIONS TO NEW MAINS SHALL BE ACCOMPLISHED WITH FULL BODY WYES OR TEES. TAPPING SADDLES WILL NOT BE ALLOWED.
- E. SERVICE LINE CONNECTIONS TO EXISTING NON—PVC MAINS SHALL BE ACCOMPLISHED USING "INSERTA TEES"
 MANUFACTURED BY INSERTA FITTINGS COMPANY OF HILLSBORO, OREGON. FOR EXISTING PVC MAINS, TAPPING
 SADDLES SHALL BE USED.
- F. 4 INCH SERVICES SHALL NOT BE CONNECTED DIRECTLY INTO MANHOLES. ALL 6 INCH SERVICES SHALL BE CONNECTED TO THE MAIN AT A MANHOLE.
- G. THE CONTRACTOR SHALL NOTIFY THE CITY INSPECTOR 48 HOURS PRIOR TO COMMENCEMENT OF CONSTRUCTION.
- H. THE CONTRACTOR IS RESPONSIBLE FOR ALL REQUIRED SEWER LINE TESTING TO BE COMPLETED IN THE PRESENCE OF THE ENGINEER OR HIS REPRESENTATIVE. PRESSURE TESTING WILL BE PERFORMED AFTER INSTALLATION OF DRY UTILITIES, AFTER ALL COMPACTION OF STREET SUBGRADE AND PRIOR TO STREET PAVING. FINAL LAMPING WILL ALSO BE ACCOMPLISHED AFTER PAVING IS COMPLETED. THESE TESTS SHALL BE THE MINIMUM BASIS OF ACCEPTANCE OF THE SEWER LINE EXTENSION.
- 1. THE CONTRACTOR SHALL OBTAIN CITY OF GRAND JUNCTION STREET CUT PERMIT FOR ALL WORK WITHIN EXISTING CITY RIGHT—OF—WAY PRIOR TO CONSTRUCTION.
- J. A CLAY CUT-OFF WALL SHALL BE PLACED 10 FEET UPSTREAM FROM ALL NEW MANHOLES UNLESS OTHERWISE NOTED. THE CUT-OFF WALL SHALL EXTEND FROM 6 INCHES BELOW TO 6 INCHES ABOVE GRANULAR BACKFILL MATERIAL AND SHALL BE 2 FEET WIDE. IF NATIVE MATERIAL IS NOT SUITABLE, THE CONTRACTOR SHALL IMPORT MATERIAL APPROVED BY THE ENGINEER.
- K. SEWER SERVICE STUB OUTS SHALL BE CAPPED AND PLUGGED. STUB OUT SHALL BE MARKED WITH A 4X4 INCH POST PAINTED GREEN BURIED WITH 3 FEET ABOVE GRADE. AS—BUILT SURVEYING FOR VERTICAL GRADE OF STUB OUT REQUIRED PRIOR TO BACKFILL.
- L. RED LINE AS—BUILTS SHALL BE SUBMITTED TO THE CITY UTILITY ENGINEER AT LEAST 72 HOURS PRIOR TO PAVING FOR REVIEW.


MANHOLE NOTES


- 1. CONCRETE SHALL BE COLORADO DEPARTMENT OF TRANSPORTATION CLASS "B" (SECTION 601.02)
- 2. ALL CEMENT USED IN MORTAR, CONCRETE BASES, GRADE RINGS, RISER SECTIONS AND CONES FOR SANITARY SEWER MANHOLES, SHALL BE TYPE V OR MODIFIED TYPE II PORTLAND CEMENT WITH LESS THAN 5% TRICALCIUM ALUMINATE.
- 3. MANHOLE RISER SECTIONS, CONES AND GRADE RINGS SHALL BE PRECAST REINFORCED CONCRETE CONFORMING TO ASTM C-478 OR AASHTO M-199.
- 4. BACKFILL AROUND MAHHOLES AND OTHER PIPELINE STRUCTURES SHALL BE PLACED IN 8" MAX. LIFTS AND COMPACTED TO 95% AASHTO T-99 WITH HAND OPERATED MECHANICAL EQUIPMENT.
- 5. ALL WORK SHALL BE IN ACCORDANCE WITH APPROVED PLANS AND CITY SPECIFICATION.
- 6. THE MANHOLE CONE AND BARREL SECTIONS SHALL BE POSITIONED SUCH THAT THE MANHOLE RING AND STEPS ARE AT A 45° ANGLE FROM THE INLET PIPE (SEE DETAIL).
- 7. MANHOLE RING AND COVER SHALL BE SET TO FINISH GRADE USING RAPID ROAD REPAIR GROUT TO ADJUST RIM ELEVATION. GROUT SHALL NOT EXCEED 2". THICKNESS. GROUT SHALL BE PLACED BETWEEN TOP OF CONCRETE GRADE RING AND RING AND COVER. STEEL GRADE ADJUSTMENT RINGS MAY BE USED FOR ADJUSTMENT OF MANHOLE COVERS ONLY WHEN STREETS ARE OVERLAID.
- 8. INVERTED MANHOLE RINGS WILL NOT BE ALLOWED UNLESS APPROVED BY THE ENGINEER.

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Horiz. Scale: AS SHOWN	Vert. Scale: NA					
Unit Information: City of GJ Unit Leader Initials: LF						
Grand Junction	333 WEST AVE, BLDG C Grand Junction, CO, 81501					
COLORADO	Phone: 970-244-1554					



As Constructed	HORIZON DR AND G RD ROUNDABOUT SANITARY SEWER					Project No./Code			
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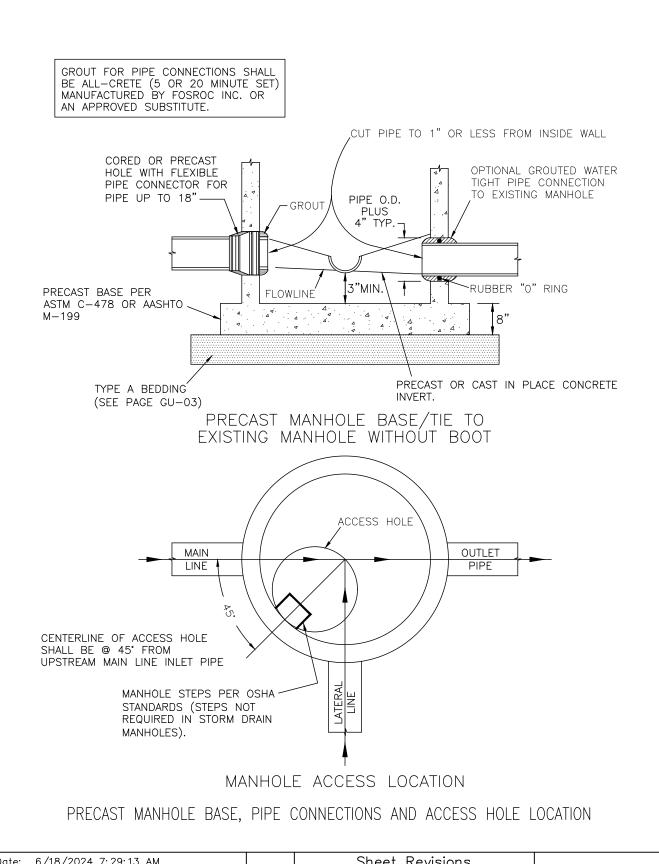
SEE STANDARD

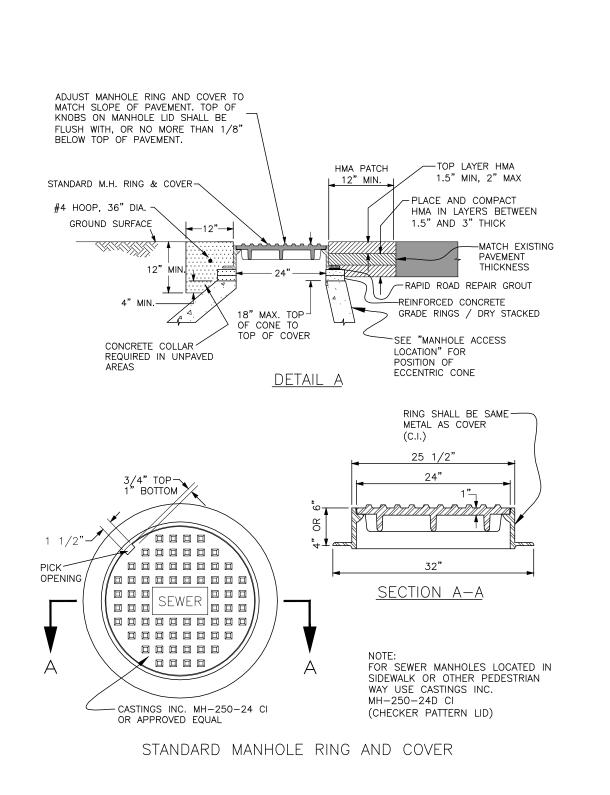Print Date: 6/18/2024 7:29:13 AM Sheet Revisions File Name: SANITARY SEWER DETAILS.dwg Date: Comments Init. Horiz. Scale: AS SHOWN Vert. Scale: NA Unit Information: City of GJ Unit Leader Initials: LF 333 WEST AVE, BLDG C Grand Junction, CO, 8150 Phone: 970-244-1554 **Grand Junction**

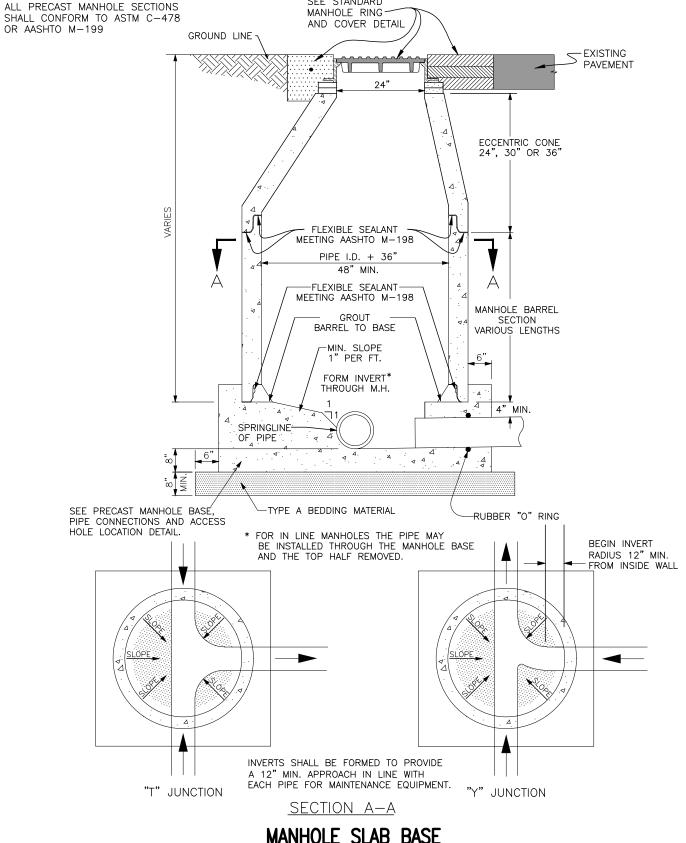
Colorado Department of Transportation CO' Region 3

606 South 9th Street Grand Junction, CO, 81501 Phone: 970–683–6351 FAX: 970–683–6369

As Constructed	HORIZON	DR AND (SANITARY	G RD F	OUNDA	ABOUT	Project No./	Code
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Revised:	Designer:	JCS	Structure			23652	
	Detailer:	JCS	Numbers				
Void:	SANITARY SEWI	ER DETAILS	Subset Sheets: X of X		Sheet Number 57		



TONGUE END					GROOVE END					JOINT							
WALL SIZE	ACT. SIZE	SE	BE	TW	Pı	CC GAGE PT.	S	SE'	BE'	SW	PP GAGE PT.	В	P2	Υ	O	AS ₁	AS
48-5	48 1/8	52.054	52.466	2.171	4 1/2	52.318	.062	52.312	52.600	2.844	52.452	58	41/2	2.188	1.594	.067	.129
60-6	60 1/8	64.958	65.386	2.631	4 3/4	65.222	.062	65.216	65.520	3.392	65.356	72	4 3	2.188	1.594	.067	.129

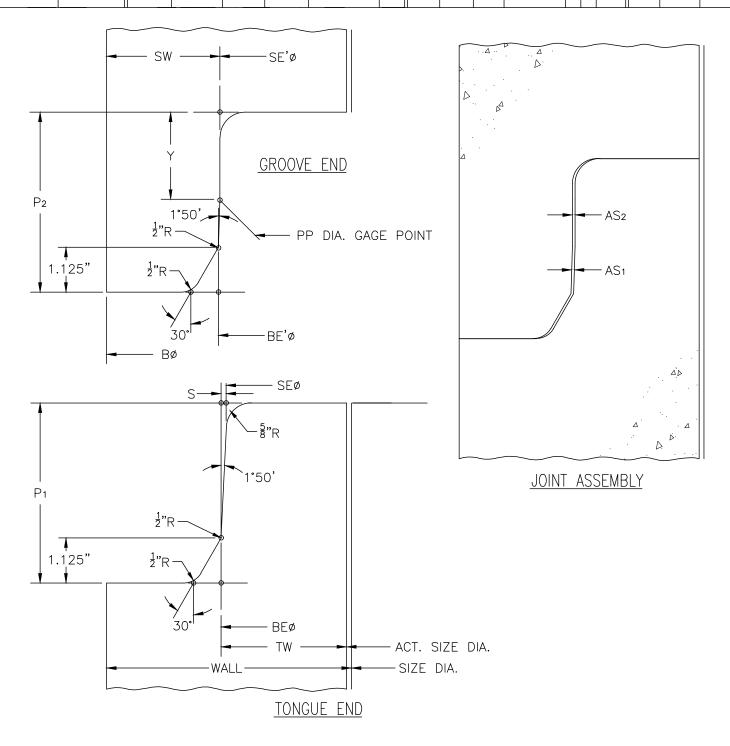


MANHOLE BARREL JOINT DETAILS (48" & 60")

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Grand Junction	333 WEST AVE, BLDG C Grand Junction, CO, 81501				₩ ₩	Phone: 970-683-6351 FAX: 97	0-683-63
COLORADO	Phone: 970–244–1554				Region 3		KC

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As Constructed	HORIZON	DR AND (SANITARY	G RD F	ROUND <i>A</i>	ABOUT	Project No./	Code
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Revised:	Designer:	JCS	Structure			23652	
	Detailer:	JCS	Numbers				
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HORIZON DR AND G RD ROUNDABOUT – SWMP UPDATED 03/01/2023

1. SITE DESCRIPTION

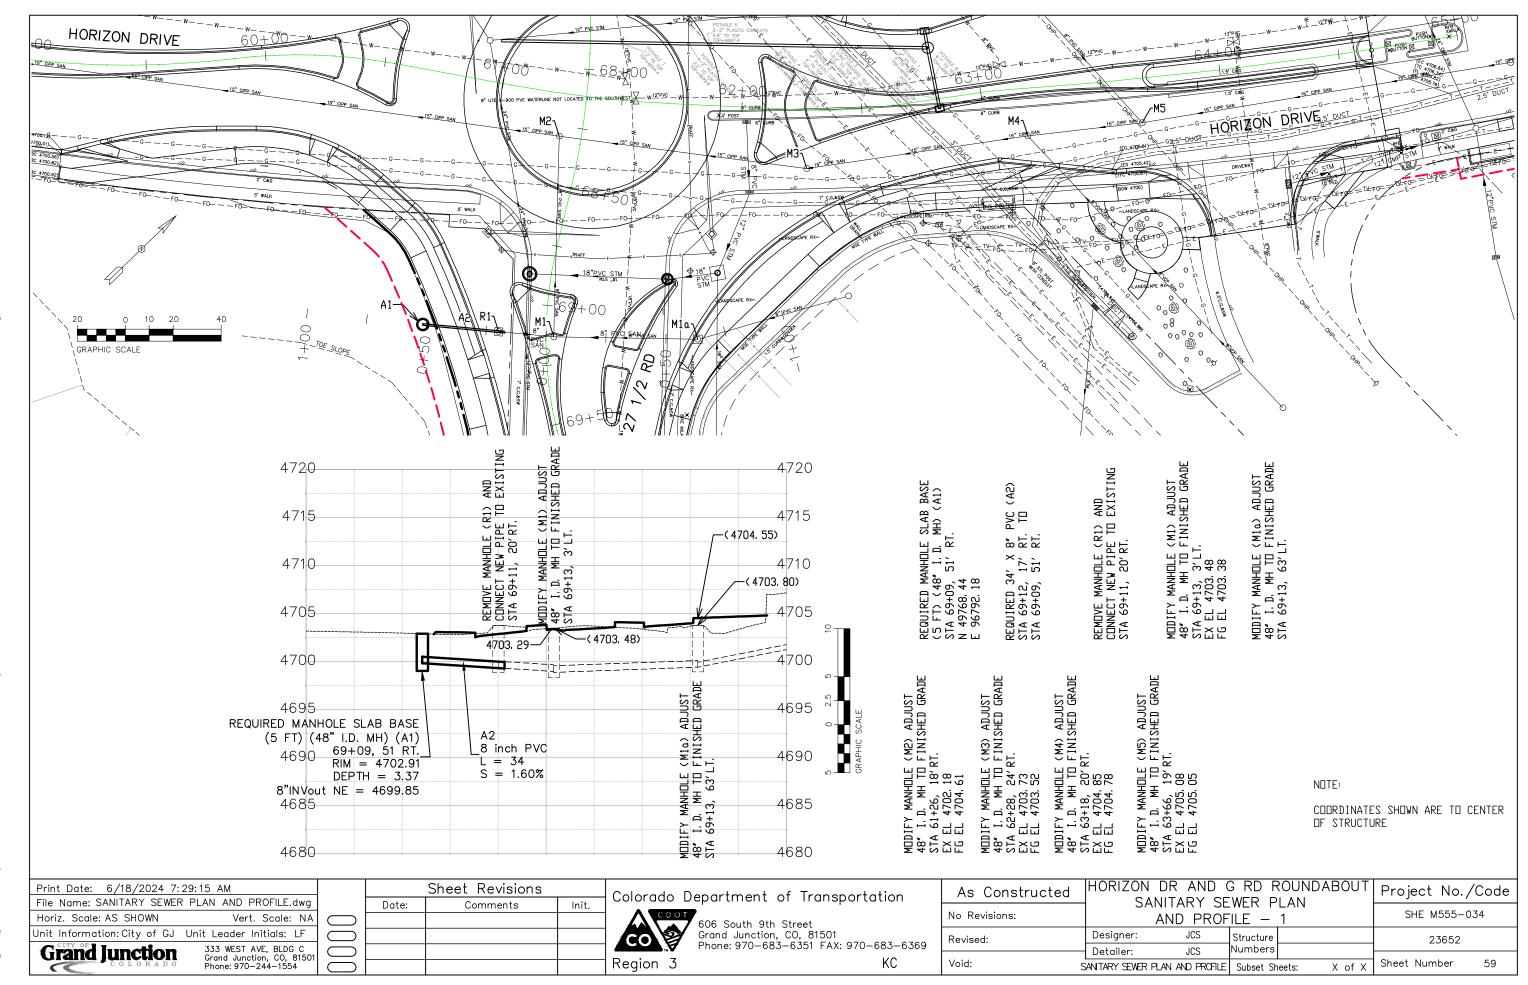The Contractor shall comply with all CDOT contractual requirements, and all requirements associated with the CDPS-SCP on this project. The SWMP Administrator for Construction shall update the SWMP to reflect current project site conditions.

A. PROJECT SITE LOCATION:

The intersection of Horizon Drive and G Road (north) and 27 ½ Road (south) Location or address of construction office: Southwest Corner of Horizon and 27 12 Road

B. PROJECT SITE DESCRIPTION:

Construct a modern style roundabout at the four-way intersection of Horizon Drive and G Road. This is an intersection upgrade funded project which includes unclassified excavation, aggregate base course, hot mix asphalt, concrete pavement, drainage pipeline installation, curb, gutter and sidewalk.

C. PROPOSED SCHEDULE FOR SEQUENCE FOR MAJOR CONSTRUCTION ACTIVITIES:

The project will begin with installation of vehicle tracking pads, concrete wash out structures, and perimeter sediment controls. The project will proceed with clearing and grubbing, asphalt-concrete & all other needed removals, site grading, utility relocation, installation of drainage pipes and appurtenances, construction of the Roundabout and connection to existing at all 4 leas, and Final landscaping. Disturbed areas not otherwise covered with paving, revegetation, or landscaping will receive native seeding by drilling methods.

D. ACRES OF DISTURBANCE:

- 1. Total area of construction site (LOC (PERMITTED AREA)): 2.70 acres
- 2. Total area of proposed disturbance (LDA): 2.39 acres
- 3. Total area of seeding: 0.26 acres
- 4. Total area of pre-project impervious surface: 84118 saft.
- 5. Total area of final impervious surface: 85765 sq. ft.
- E. EXISTING SOIL DATA: Killpack Silty Clay, 2 to 5 percent slopes. Parent Material: Residuum weathered from clayey shale. Runoff class is: Medium. Depth to water table: More than 80 inches. Hydrologic Soil Group: C.
- F. EXISTING VEGETATION, INCLUDING PERCENT OF VEGETATIVE COVER: Existing vegetation consists of maintained landscaping by both the City of Grand Junction and the local businesses adjacent to the project. Existing vegetation consists of sod, trees, shrubs, perennials, inorganic mulch, native grasses, and native bushes. The native grasses and bushes are primarily located at the undeveloped properties at the South and West corners of the intersection. The property at the East corner of the intersection is currently being developed and therefor has been cleared and grubbed and free of all vegetation.

A survey including general description of existing vegetation shall be conducted by the Erosion Control Supervisor prior to any ground disturbance on project. The Erosion Control Supervisor shall photo-document existing vegetation where all work will be occurring. The Erosion Control Supervisor shall also perform the vegetation survey transect(s) including photo documentation as outlined in Chapter 4.11.2 of CDOT's Erosion Control and Stormwater Quality Guide.

<u>Pre-Construction</u> Date of survey: Description of existing vegetation:	Percent Existing Vegetative Cover:
Method for determining percent vegetative	
Post-Construction Date of survey:	Percent Vegetative Cover:

G. POTENTIAL POLLUTANTS SOURCES:

Refer to Potential Pollutant Sources in SWMP Section 4A. The SWMP Administrator for Construction shall prepare a list of all potential pollutants and their locations in accordance with subsection 107.25.

H. DRAINAGE PATTERNS AND RECEIVING WATER(S):

- 1. Outfall locations: The owner of the new and existing storm pipes that are underneath and crossing Horizon Drive, G Road, and 27 ½ Road are owned and maintained by the City of Grand Junction. All storm drain piping that's part of this project conveys storm water to a centralized point and discharges the storm water into an existing drainage channel where the storm water is then conveyed and discharged into the upper limits of Ranchman's Ditch. This project is located within MS4 boundaries. This project increases the imperious area by 2%.
- 2. Names of receiving water(s) on site and the ultimate receiving water: Ranchman's Ditch and the Colorado River as the ultimate receiving waters.
- 3. Distance ultimate receiving water is from project: 3.5 Miles
- 4. There are no stream crossings located within the Construction Site Boundary

I. ALLOWABLE NON-STORMWATER DISCHARGES:

Discharge Description	Site Map #	Method Statement (Location)
Uncontaminated Springs		
Concrete Washout Water (in-ground washout structure) #	See Site Map	A Concrete Washout Structure shall be provided by the contractor
Landscape Irrigation Return Flows		
Discharges from Diversions of State Waters		
Emergency Fire Fighting		

#Concrete washout water associated with the washing of concrete tools and concrete mixer chutes can be discharged to the ground if site is managed accordingly to prevent the water from leaving the site as surface runoff or reaching receiving waters.

J. DIVERSION CRITERIA:

- 1. Is a diversion planned for the Site? Yes _____ No X
- 2. If yes, complete information below:
 - a. What is the 2-year peak flow for the waterway being diverted (cubic feet per second)?
 - b. What are the monthly averages if available? (provide averages for Jan-Dec if available)
 - c. What is the upstream contributing drainage area and imperviousness?
 - d. A method statement must be prepared by the Contractor and approved by CDOT for each diversion. Diversion structures must minimize soil transport and erosion within the entire diversion, minimize erosion during discharge, and minimize run-on into the diversion and meet the conditions in the SCP.
 - e. If the conditions in the SCP cannot be met and an alternative is required, CDOT must approve the alternative and then it must be submitted and approved by CDPHE's Water Quality Control Division prior to implementation.

K. ALTERNATIVE TEMPORARY STABILIZATION SCHEDULE:

[If applicable, provide a description of the alternative temporary stabilization schedule. If temporary stabilization exceeds the 14-day schedule, then the SWMP must document the constraints necessitating the alternative schedule, provide the alternative

schedule, and identify all the locations where the alternative schedule is applicable on the site map. Alternative temporary stabilization schedules must be approved by CDOT prior to implementation]

2. SITE MAP COMPONENTS:

Pre-construction

A. PROJECT CONSTRUCTION POTENTIAL SITE BOUNDARIES:

See Storm Water Management Site Plan

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File Name: STORMWATER MANAGEMENT PLAN.dwg	Date:	Comments	Init.
Horiz. Scale: AS SHOWN Vert. Scale: NA			
Unit Information: City of GJ Unit Leader Initials: LF			
Grand Junction 333 WEST AVE, BLDG C Grand Junction, CO, 81501 Phone 970–244-1554			
COLORADO Phone: 970-244-1554			

606 South 9th Street

Colorado Department of Transportation

Region 3

Grand Junction, CO, 81501 Phone: 970–683–6351 FAX: 970–683–6369 KC

As Constructed	HORIZON DR AND (STORMWATER MAN	Project No./Code	
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	Detailer: JCS	Numbers	
Void:	STORMWATER MANAGEMENT PLAN	Subset Sheets: X of X	Sheet Number 60

B. FLOW ARROWS THAT DEPICT STORMWATER FLOW DIRECTIONS ON-SITE, RUN-ON AND RUNOFF DIRECTION:

See Storm Water Management Site Plan

C. ALL AREAS OF GROUND SURFACE DISTURBANCE:

See Storm Water Management Site Plan

D. AREAS OF CUT AND FILL:

See Storm Water Management Site Plan and Cross Sections

E. AREAS USED FOR STORING AND STOCKPILING OF MATERIALS, STAGING AREAS (field trailer, fueling, etc.) and LOCATIONS OF ALL WASTE ACCUMULATION and BATCH PLANTS INCLUDING MASONRY MIXING STATIONS:

See Storm Water Management Site Plan

F. LOCATION OF NON-STRUCTURAL CONTROL MEASURES AS APPLICABLE IN THE SWMP: See Storm Water Management Site Plan

3. QUALIFIED STORMWATER MANAGERS:

A. SWMP ADMINISTRATOR FOR DESIGN:

CDOT Certified Individual responsible for developing SWMP Plan Sheets and SWMP Site Maps during the design phase.

Name/Title	Contact Information [phone & email]	Certification #
Lisa Froshhaug	970-244-1592 lisafr@gjcity.org	

B. <u>SWMP ADMINISTRATOR FOR CONSTRUCTION:</u> (As defined in Section 208) The Contractor shall designate a SWMP Administrator for Construction upon accepting co-permittee of the permit. The SWMP Administrator for Construction shall become the operator for the SWMP and assume responsibility for all design changes to the SWMP implementation and maintenance in accordance to 208.03, the SWMP shall remain the property of CDOT. The SWMP Administrator for Construction shall be responsible for implementing, maintaining and revising SWMP, including the title and contact information. The activities and responsibilities of the SWMP Administrator for Construction shall address all aspects of the project's SWMP. (Update the information below for each new SWMP Administrator for Construction) (A copy of TECS Certification must be included in the SWMP.)

Name/Title	Contact Information (phone & email)	Certification #	Start Date	Engineer Approval

C. <u>EROSION CONTROL INSPECTOR</u>: (As defined in Section 208) The Contractor may designate an Erosion Control Inspector. The Erosion Control Inspector shall complete duties in accordance with subsection 208.03 (c) (Copy of TECS Certification must also be included in the SWMP.)

Name/Title	Contact Information (phone & email)	TECS Certification #	Start Date	Engineer Approval

- D. <u>PERMANENT STABILIZATION SUBJECT MATTER EXPERT:</u> This qualified individual will be either a Regional Environmental Staff member, or an Independent Contractor Controller (Independent Assurance Program). This expert is a project team leader responsible for ensuring project adherence to requirements of the 207 and 212 Project Special Provisions as follows and will be available for questions regarding permanent stabilization requirements.
 - 1. Review the Topsoil Management Plan and the Permanent Stabilization Site Maps.
 - 2. Attend the Environmental Pre-Construction Conference.
 - 3. Coordinate the Site Pre-Vegetation Conference.
 - 4. Review and recommend approval of products.
 - 5. Review and recommend approval of the Quantities Verification Prerequisite.
 - 6. Attend the Partial Landscape Completion Walkthrough.
 - 7. Attend the Final Landscape Completion Walkthrough.

Name/Title	Contact Information [phone & email]

4. STORMWATER MANAGEMENT CONTROLS FOR FIRST CONSTRUCTION ACTIVITIES

THE CONTRACTOR SHALL PERFORM THE FOLLOWING:

A. POTENTIAL POLLUTANT SOURCES:

Evaluate, identify, locate and describe all potential sources of pollutants at the site in accordance with subsection 107.25, CDPS-SCP and place in the SWMP. All control measures related to potential pollutants shall be shown on the SWMP Site Map by the Contractor's SWMP Administrator for Construction. Pollutant Sources include:

- Sediment from ground disturbance
- Vehicle tracking of sediments.
- Liquid and solid construction waste, paints, solvents, adhesives, concrete washout water, asphalt waste, and any other material that could conceivably be dissolved in or carried by stormwater.
- Loading and unloading operations
- Vehicle and equipment maintenance and fueling
- Significant dust or particulate generating processes.
- Non-industrial waste sources such as worker trash and portable toilets

B. OFFSITE DRAINAGE (RUN ON WATER):

Describe and record control measures on the SWMP Site Map that have been implemented to address off site run-on water in accordance with subsection 208.03.

C. VEHICLE TRACKING CONTROL:

Control measures shall be implemented in accordance with subsection 208.04.

D. PERIMETER CONTROL:

- 1. Perimeter control shall be established as the first item on the SWMP to prevent the potential for pollutants leaving the construction site boundaries, entering the stormwater drainage system, or discharging to state waters. Perimeter control shall be in accordance with subsection 208.04
- 2. Perimeter control may consist of berms, silt fence, erosion logs, existing landforms, or other control measures as approved.

5. DURING CONSTRUCTION

RESPONSIBILITIES OF THE SWMP ADMINISTRATOR FOR CONSTRUCTION: Considered a "living document", the SWMP is continuously reviewed and modified throughout the construction phases. During construction, SWMP Administrator for Construction shall add, update, or amend the items A-G below as needed in accordance with subsection 208.03.


During construction, indicate how items that were not addressed during design are being handled in construction. If items are covered in other sections of the SWMP, indicate below what section the discussion takes place.

- A. <u>MATERIALS HANDLING AND SPILL PREVENTION AND RESPONSE PLAN:</u> Prior to construction commencing the Contractor shall submit a Spill Response Plan. Materials handling and Spill Response Plan shall be in accordance with subsection 208.06.
- B. OTHER CDPS PERMITS: List applicable CDPS permits associated with the permitted site and activities.
- C. STOCKPILE MANAGEMENT: Shall be done in accordance with subsections 107.25 and 208.07.
- D. <u>CONCRETE WASHOUT</u>: Concrete washout water or waste from field laboratories and paving equipment shall be contained in accordance with subsection 208.05.
- E. <u>SAW CUTTING</u>: Shall be done in accordance with subsections 107.25, 208.04, 208.05
- F. STREET SWEEPING: Shall be done in accordance with subsection 208.04.

Template Revised: 2.25.2022

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Unit Information: City of GJ	Unit Leader Initials: LF	
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Region 3

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6. INSPECTIONS

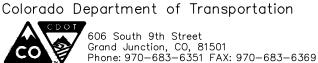- A. Water Quality Inspections shall be in accordance with subsection 208.03(c).
- B. Permanent Stabilization Inspections shall be in accordance with subsections 208.04(e)4 and 208.10.

7. CONTROL MEASURE MAINTENANCE

Maintenance shall be in accordance with subsection 208.04(f).

8. RECORD KEEPING

Records shall be kept in accordance with subsection 208.03(d).

9. INTERIM, PERMANENT STABILIZATION and LONG-TERM STORMWATER MANAGEMENT

The Contractor shall comply with all interim stabilization and permanent stabilization requirements in accordance with subsection 208.04(e).

A. SEEDING PLAN:

Seeding will be required for an estimated 0.26 acres of disturbed area within the right-of-way limits, which are not surfaced. The following seed mix(es) and rates are for drill seeding method as shown on the Permanent Stabilization Site Maps shall be used:

COMMON NAME	BOTANICAL NAME	LBS. PLS PER ACRE
GALLETA GRASS	HILARIA JAMESII	20%
HARD FESCUE	FESTUCA OVINA 'DURAR'	20%
INDIAN RICEGRASS	ORIZOPSIS HYMENOIDES ' PALOMA'	12%
NEEDLE & THREAD GRASS	STIPA COMATA	1%
SHEEP FESCUE	FESTUCA OVINA 'COVAR'	8%
WESTERN WHEATGRASS	AGROPYRON SMITHII 'ARRIBA'	30%
SAND DROPSEED	SPOROBOLUS CRYPTANDRUS	1%
BLUE GRAMMA	BOUTELOUA GRACILIS	5%
SIDE OATS GRAMMA	BOUTELOUA CURTIPENDULA	3%
SEED AT 5 LB/ACRE PLS		
		Total 100%

B. SEEDING APPLICATION METHOD:

Drill seed 0.25 inch to 0.5 inch into the soil. In small areas not accessible to a drill, hand broadcast or hydroseed at double the rate and rake 0.25 inch to 0.5 inch into the soil.

C. MULCHING APPLICATION:

Apply a minimum of 2 tons of certified weed free straw per acre and in accordance with Section 213, and mechanically crimp it into the soil in combination with an organic mulch tackifier.

 Prior to winter shutdown or the summer seeding window: Uncompleted slopes shall be mulched with 2 tons of mulching (weed free) per acre, mechanically crimped into the topsoil in combination with an organic mulch tackifier per section 213.

D. SOIL STABILIZATION METHODS:

Minimum soil stabilization methods (attached mulch) for all disturbances to receive seeding.

E. SPECIAL REQUIREMENTS:

1. Soil amendments, seedbed preparation, and permanent stabilization mulching shall be accomplished within four working days of placing the topsoil on the de-compacted civil subgrades. If placed topsoil is not mulched with permanent stabilization mulch within four working days, the Contractor shall complete interim stabilization methods in accordance with subsection 208.04(e) at no additional cost to the Department.

- 2. Complete permanent stabilization mulching within 24 hours of hydraulic application of native seed.
- 3. The Contractor shall submit a proposed Permanent Stabilization Phasing Plan to the Engineer for approval showing how implementation of SWMP Permanent Stabilization Plans will minimize damage to seeded areas.

F. <u>SOIL AMENDMENT REQUIREMENTS:</u> Minimum amendment material requirements for all disturbances to receive seeding.

BIOLOGICAL NUTRIENT ORGANIC BASED	HUMATE	COMPOST (CY/ACRE)
FERTILIZER (LBS/ACRE)*	(LBS/ACRE)	(1/2 INCH DEPTH)
600	200	261

*BIOLOGICAL NUTRIENT SHALL NOT EXCEED 8-8-8 (N-P-K). HUMATE BASED MATERIAL AND COMPOST SHALL BE IN ACCORDANCE WITH SECTION 212

G. Permanent Stabilization Application Under Structures:

Under structures shade patterns should be considered and the use of Median Cover Material (Stone) or other stabilized options with an approved Project Special Provision should be used. See SWMP Site Map for locations.

H. RESEEDING OPERATIONS/CORRECTIVE STABILIZATION:

Prior to stormwater construction work partial acceptance.

- 1. All seeded areas shall be reviewed by the SWMP Administrator for Construction and or Erosion Control Inspector for bare soils caused by surface or wind erosion. Bare areas caused by surface or gully erosion, blown away mulch, etc. shall be re-graded, seeded, and have the designated mulching applied as necessary, at no additional cost to the project.
- 2. The Contractor shall maintain seeding/mulch/tackifier/blanket/TRM, mow to control weeds or apply herbicide to control weeds in the seeded areas, at no additional cost to the project.
- I. <u>LOCATION AND DESCRIPTION OF PLANNED PERMANENT CONTROL MEASURES</u>: Is Permanent Water Quality Required. Yes______No___X___.

10. PRIOR TO PROJECT FINAL ACCEPTANCE

- A. When directed by the Engineer, removal and disposal of temporary control measures shall be included in the cost of work.
- B. At the end of the project, all ditch checks shall consist of either temporary erosion logs (or equivalent) or permanent riprap.
- C. Refer to subsection 208.10 for Items to be completed prior to requesting partial acceptance of water quality work.

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Unit Information: City of GJ Unit Leader Initials: LF

Grand Junction

Grand Junction, CO, 81501
Phone: 970-244-1554

CO Region 3

, 606 South 9th Street Grand Junction, CO, 81501 Phone: 970–683–6351 FAX: 970–683–6369

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11. NARRATIVES

Control Measure Matrixes During Construction:

1. Control measure narratives have been included for the CDOT Standard Specifications and Standard Plan M-208 and M-216 along with any non-standard control measures approved during the design process. If a Non-Standard Control Measure not included in the SWMP is proposed and approved by the Engineer the SWMP Administrator for Construction shall do the following: Place an "X" in the column for non-standard and complete a Non-Standard Control Measure Specification and Narrative covering the what, when, where and why the control measure is being used shall be add to the SWMP. The appropriate "X" shall also be added to the implementation phase(s).

2. The SWMP Administrator for Construction shall place an "X" in the column In Use On Site when the control measure has been installed.

3. A "B" in the Initial Activities Column indicates that the control measure shall be installed **before** construction activity starts. Locations and quantities will be discussed during the Environmental Pre-Construction Conference with the Regional Water Pollution Control Manager.

STRUCTURAL Control Measures that may be potentially used on the project for erosion and sediment control; practices may include, but are not limited to the following:

,	sed of the project for crosion and sediment control, practices may include, but are not infinited to the following			CONTROL MEASURE IMPLEMENTATION PHASE			
APPLICATION, CONTROL MEASURE	NARRATIVE	M- 208 STANDARD or "X" for NON- STANDARD		INITIAL ACTIVITIES	INTERIM ACTIVITIES	PERMANENT STABILIZATION	
PROTECTION OF EXISTING WETLANDS Fence (plastic) and erosion logs	Fence (plastic) shall be placed in combination with erosion logs to prevent encroachment of construction traffic and sediment into state waters prior to start of construction disturbances. Fence (plastic) shall be placed adjacent to the wetlands; erosion logs shall be placed between the plastic fence and disturbance area. Logs shall be placed to direct flows away from or filter water running into wetlands from disturbance areas.						
PROTECTION OF EXISTING TREES/LANDSCAPING Fence (plastic)	Fence (plastic) shall be used in areas indicated in the plans to prevent encroachment of construction traffic and sediment for the protection of sensitive habitat, mature trees and/or existing landscaping prior to start of construction disturbances.						
CHECK DAM/DITCH CHECK Erosion log, silt berm, silt dike, rock check dam	Placed in ditches immediately upon completion of ditch grading to reduce velocity of runoff in ditch. For existing ditches, place prior to start of construction disturbances.	M-208					
Storm Drain Inlet Protection In Paved Roadways (Type 1, 2 and 3 as shown on M-208-1, sheet 5 of 11)	Manufactured storm drain inlet protection placed prior to construction disturbances as detailed in M-208-1, to protect existing inlets or immediately upon completion of new inlets to prevent sediment from entering the inlet throughout construction.	M-208		X	X		
Storm Drain Inlet Protection In Native Seed Areas (M-604 Standard Inlets Type C and D)	Erosion logs or aggregate bags placed around inlet grate to prevent sediment from entering inlet. Place prior to construction disturbances to protect existing inlets or immediately upon completion of new inlets.	M-208					
CULVERT INLET/OUTLET PROTECTION Erosion logs, aggregate bags	Placed at mouth of culvert inlets and over top of culvert at inlet and outlet where disturbance may be occurring adjacent to pipe to prevent sediment laden water from entering pipe or drainage. Place prior to the start of construction disturbances.	M-208					
TYPE C, TYPE D AND TYPE 13 PROTECTION Erosion logs, aggregate bags, erosion bales	Placed around inlet grate or slope and ditch paving to prevent sediment from entering inlet. Place prior to the start of construction disturbances.	M-208					
STOCKPILE PROTECTION Temporary berm, erosion logs, aggregate bags*	Placed within specified distance, in accordance with subsection 208.06, from toe to contain sediment around stockpile. *Aggregate bags are easily moved and replaced for access during the work day. Place prior to start of stockpiling, increase control as the stockpile increases size.	M-208					
TOE OF FILL PROTECTION Erosion logs, temporary berm, silt fence, topsoil windrow*	Place prior to slope/embankment work to capture sediment and protect and delineate undisturbed areas. *Can be used to stockpile topsoil for salvage.	M-208		X	X		
PERIMETER CONTROL Erosion logs, silt fence, temporary berm, topsoil windrow*	Placed prior to construction commencing to address potential run-on water from off site, and to divert around disturbed area. *Can be used to stockpile topsoil for salvage.	M-208		X	X		
SLOPE CONTROL Silt fence, erosion logs	Placed on the contour of a slope to contain and slow down construction runoff. Place prior to the start of construction disturbances.	M-208					
TEMPORARY SEDIMENT TRAP	Used to capture sediment laden runoff from disturbed areas < 5 acres during construction. Place prior to the start of construction disturbances. Outlets that withdraw water from or near the surface may be installed when discharging from basins and impoundments.	M-208					
TEMPORARY SLOPE DRAIN	Placed as a conduit or chute to drain runoff down slope and to prevent erosion of slope.	M-208					
OUTLET PROTECTION Riprap, or approved other	Material placed as an energy dissipater to prevent erosion at outlet structure.	M-601-12					

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Revised:	Designer: JCS	Structure Numbers	23652
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				CONTROL MEASURE IMPLEMENTATION PHASE			
APPLICATION, CONTROL MEASURE	NARRATIVE		IN USE ON SITE	INITIAL ACTIVITIES	INTERIM ACTIVITIES	PERMANENT STABILIZATION	
CONCRETE WASHOUT In-ground or fabricated	Construction control, used for waste management of concrete and concrete equipment cleaning. Place prior to the start of concrete activities.	M-208		X	X		
VEHICLE TRACKING PAD	Source control, placed to prevent tracking of sediment from disturbed area to offsite surface. Place prior to the start of construction disturbances.	M-208		X	X		
Engineered SEDIMENT BASIN	Constructed early in the project, prior to storm sewer/ditches and in accordance with 208.05(p) to capture storm flow. Outlet structure and/or outfall shall be modified for temporary sediment control using an approved non-standard detail. Outlets that withdraw water from or near the surface shall be installed when discharging from basins and impoundments, unless infeasible						
DEWATERING (Contractor is responsible for obtaining a permit from Colorado Department of Health and Environment.)	Shall be done in such a manner to prevent potential pollutants from entering state waters.						
TEMPORARY STREAM CROSSING	Constructed over stream or drainage to prevent discharge of pollutants from construction equipment into water.						
CLEAN WATER DIVERSION	Placed to divert clean surface or groundwater around the disturbance area to prevent it from mixing with construction runoff.						
OTHER							

Template Revised: 2.25.2022

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File Name: STORMWATER MANAGEMENT PLAN.dwg	Date:	Comments	Init.
Horiz. Scale: AS SHOWN Vert. Scale: NA			
Unit Information: City of GJ Unit Leader Initials: LF			
Grand Junction 333 WEST AVE, BLDG C Grand Junction, CO, 81501 Phone: 970-244-1554			
COLORADO Phone: 970–244–1554			

Colorado Department of Transportation Region 3

606 South 9th Street Grand Junction, CO, 81501 Phone: 970-683-6351 FAX: 970-683-6369

As Constructed	HORIZON DI STORMWAT					Project No./	Code
No Revisions:	3 TORWWAT	5 MAIN	AGLIVILI	NI FLA	–	SHE M555-03	34
Revised:	Designer:	JCS	Structure			23652	
	Detailer:	JCS	Numbers		ŀ		
Void:	STORMWATER MANAGEMENT	PLAN	Subset Sh	eets:	X of X	Sheet Number	64

NON-STRUCTURAL Control Measures that may be potentially used on the project for erosion and sediment control; practices may include, but are not limited to:

Erosion control devices are used to limit the amount of soil loss on site. Sediment control devices are designed to capture sediment on the project site. Construction controls are control measures related to construction access and staging. Control Measure locations are indicated on the SWMP Site Map.

* Use of vegetative buffer strip requirements. The CDPHE Water Quality Control Division Technical Memorandum dated August 27, 2015 clarifies the requirements for utilization of existing vegetation as a buffer type of sediment control measure, while maintaining compliance with the CDPS permit for Stormwater Discharges Associated with Construction Activity – CDPS Permit No. COR4000000. In general, the division does not recommend that vegetated buffers be implemented as a sediment removal control measure for runoff from disturbed areas at construction sites, unless implemented as a "finishing" component of a treatment train comprised of additional, adequate up-gradient Control Measures. The entire memorandum can be found at: https://www.colorado.gov/pacific/sites/default/files/Vegetative%208uffer%20Memo.pdf

				CONTROL MEAS	JRE IMPLEMEN	TATION PHASE
APPLICATION, CONTROL MEASURE	NARRATIVE		IN USE ON SITE	INITIAL ACTIVITY	INTERIM ACTIVITIES	PERMANENT STABILIZATION
* VEGETATIVE BUFFER STRIP	Finishing component for filtering sediment-laden runoff from disturbance area. Area within CDOT ROW or temporary easement to be identified on SWMP prior to construction starting.					
GRADING APPLICATIONS (LANDFORM)	Existing or created landforms may be used as a control measure if they prevent sediment from entering or leaving the disturbance area. If a landform directs flow of water to a concentrated outfall point, the outfall point shall be protected to prevent erosion. Area to be identified on SWMP prior to construction starting.	M-208				
TOPSOIL MANAGEMENT STOCKPILE/SALVAGE Stockpile	Prior to any site disturbance work commencing, existing topsoil shall be scraped to a depth six inches or as specified, and placed in stockpiles or windrows. Upon completion of final grading, topsoil shall be evenly distributed over embankment to a depth of six inches or as specified.	M-208				
SURFACE ROUGHENING / GRADING TECHNIQUES	Temporary stabilization of disturbance and to minimize wind and erosion.					
SEEDING (TEMPORARY)	Temporary stabilization used for over wintering of disturbance or used to control erosion for areas scheduled for future construction.					
BONDED FIBER MATRIX or MULCHING (HYDRAULIC)	Not to be used in areas of concentrated flows, i.e. ditch lines. To be for either Interim or Permanent Stabilization placed as a surface cover for erosion control. May be used as surface cover when work is temporarily halted and as approved by the Engineer for stockpiles.					
Straw or Hay MULCH/MULCH TACKIFIER	Interim or Permanent Stabilization placed as a surface cover for erosion control and or seeding establishment. To be installed as Interim Stabilization as a surface cover when work is temporarily halted and as approved by the Engineer					X
SPRAY-ON MULCH BLANKET (Not to be used in areas of concentrated flows, i.e. ditch lines.)	Interim or Permanent Stabilization placed as a surface cover for erosion control and or seeding establishment. To be installed as temporary surface cover when work is temporarily halted and as approved by the Engineer					
SEEDING PERMANENT (NATIVE PERENNIAL)	Permanent Stabilization of disturbance and to reduce runoff and control erosion on disturbed areas.					X
SOIL RETENTION BLANKET (SRB)	Permanent Stabilization of disturbance and to reduce runoff and control erosion on disturbed areas.	M-216				
TURF REINFORCEMENT MAT (TRM)	Permanent Stabilization of disturbance and to reduce runoff and control erosion on disturbed areas. Placed in channels or on slopes for erosion control, channel liner and seeding establishment.	M-216				
Sweeping	Source control, used to remove sediment tracked onto paved surfaces and to prevent sediment from entering drainage system. Sweep daily and at the end of the construction shift as needed. Kick brooms shall not be permitted.				X	
OTHER						

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Horiz. Scale: AS SHOWN	Vert. Scale: NA	
Unit Information: City of GJ	Unit Leader Initials: LF	
Grand Junction	333 WEST AVE, BLDG C Grand Junction, CO, 81501	
COLORADO	Phono: 970-244-1554	

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Colorado Department of Transportation

Region 3

As Constructed	HORIZON DR AND (STORMWATER MAN	G RD ROUNDABOUT	Project No./Code
No Revisions:	510KWWATEK WAN	AGLINENT LAN —	SHE M555-034
Revised:	Designer: JCS	Structure	23652
	Detailer: JCS	Numbers	
Void:	STORMWATER MANAGEMENT PLAN	Subset Sheets: X of X	Sheet Number 65

12. TABULATION OF STORMWATER QUANTITIES

- A. Control Measure sediment removal and disposal shall be paid for as: 208 Removal and Disposal of Sediment (Equipment) and 208 Removal and Disposal of Sediment (Labor). All other control measure maintenance shall be included in the cost of the control measure.
- B. It is estimated that 10 hours of blading (140-250 horsepower) may be required for construction of temporary berm as directed by the Engineer. Work shall be paid for as: (203-01500) BLADING.

PSP Spec.	Pay Item	Description	Pay Unit	Initial Const.	Interim Const.	Permanent Stabilization	*Total Quantity
	203-01500	Blading	Hour	10			
	208-00002	Erosion Log Type 1 (12 inch)	LF	260			
	208-00035	Aggregate Bag	LF	50			
	208-00046	Pre-fabricated Concrete Washout Structure (Type 1)	Each	1			
	208-00054	Storm Drain Inlet Protection (Type II)	Each	11			
	208-00075	Pre-fabricated Vehicle Tracking Pad	Each	4			
	208-00103	Removal and Disposal of Sediment (Labor)	Hour	20			
	208-00105	Removal and Disposal of Sediment (Equipment)	Hour	20			
	208-00106	Sweeping (Sediment Removal)	Hour	60			
	208-00107	Removal of Trash	Hour	20			
	208-00207	Erosion Control Management (ECM)	Day	60			
	208-00300	Temporary Berm	LF	400			
	212-00706	Seeding (Native) Drill	Acre	0.26			
	213-00004	Mulching (Weed Free Straw)	Acre	0.26			
	213-00061	Mulch Tackifier	LB	52			

*It is anticipated that additional control measures and control measure quantities not shown on the SWMP Site Maps shall be required on the project for unforeseen conditions and replacement of items that are beyond their useful service life, see subsections 208.03 and 208.04. Quantities for all control measures shown above are estimated and have been increased for unforeseen conditions and normal control measure life expectancy. Quantities shall be adjusted according to the conditions encountered in the field as directed and approved by the Engineer. Payment shall be for the actual work completed and material used.

***Pay Item 208-00071 is included for anticipated maintenance of vehicle tracking pads based on the service life of the control measure in the field. The use of the material shall be directed and approved by the Engineer.

**** F/A refers to CDOT's Force Account Pay Items.

13. BIOLOGICAL IMPACTS and DEWATERING

A. ENVIRONMENTAL IMPACTS:

1. Wetland Impacts: NO

2. Stream Impacts: NO

3. Threatened and Endangered Species: No species are anticipated to be impacted by the project.

B. DEWATERING:

(Not covered under the CDPHE guidance document Low Risk Discharge Guidance Discharges of Uncontaminated Groundwater to Land):

https://www.colorado.gov/pacific/sites/default/files/WQ%20LOW%20RISK%20GW.pdf


- 1. Dewatering: Refer to other environmental permits in accordance with subsection 107.02 and the permits contained in Tab 16 of the SWMP.
- 2. If groundwater does not meet water quality standards for receiving water a separate CDPS Dewatering Permit shall be obtained by the Contractor from CDPHE in accordance with subsections 107.02 and 107.25.

14. <u>NOTES</u>

1. Due to high failure rates, hydroseeding will not be allowed for the application of native seeding.


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Unit Information: City of GJ Unit Leader Initials: LF			606 South 9th Street Grand Junction, CO, 81501 Phone: 970-683-6351 FAX: 970-683-6369	Revised:	Designer: JCS	Structure	23652
Grand Junction 3333 WEST AVE, BLDG C Grand Junction, CO, 81501 Phone: 970–244–1554				Void:	Detailer: JCS STORMWATER MANAGEMENT PLAN	Numbers Subset Sheets: X of X	Sheet Number 66

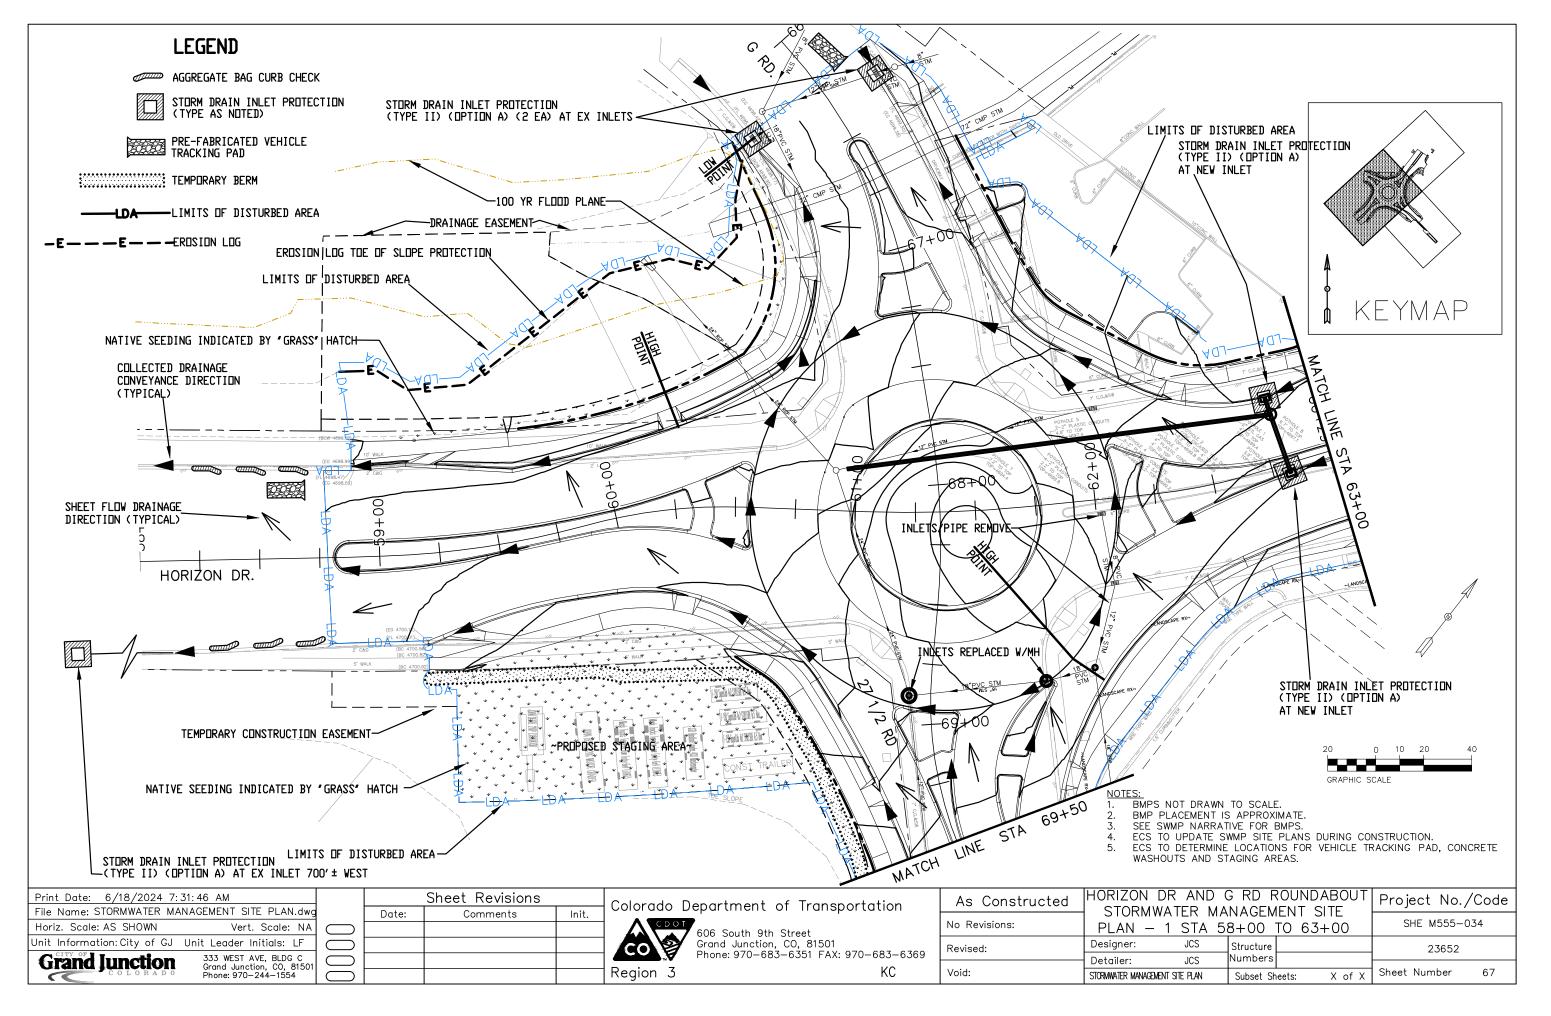

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Grand Junction



Region 3

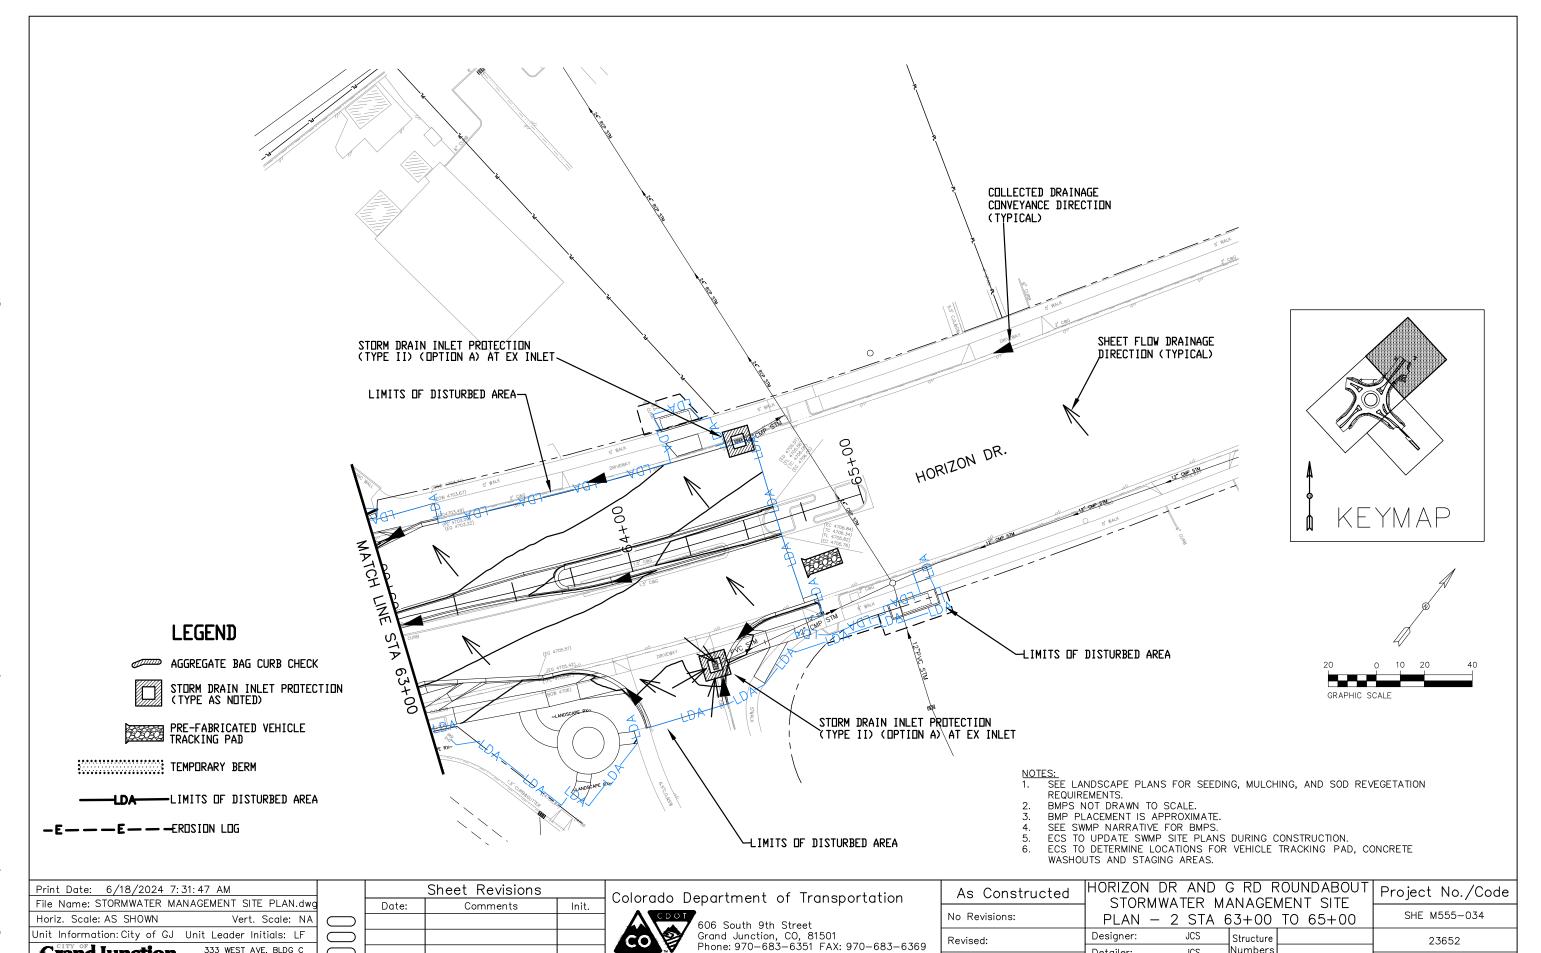Numbers

Subset Sheets:

Sheet Number

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Detailer:

STORMWATER MANAGEMENT SITE PLAN


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LEGEND

AGGREGATE BAG CURB CHECK

STORM DRAIN INLET PROTECTION (TYPE AS NOTED)

PRE-FABRICATED VEHICLE TRACKING PAD

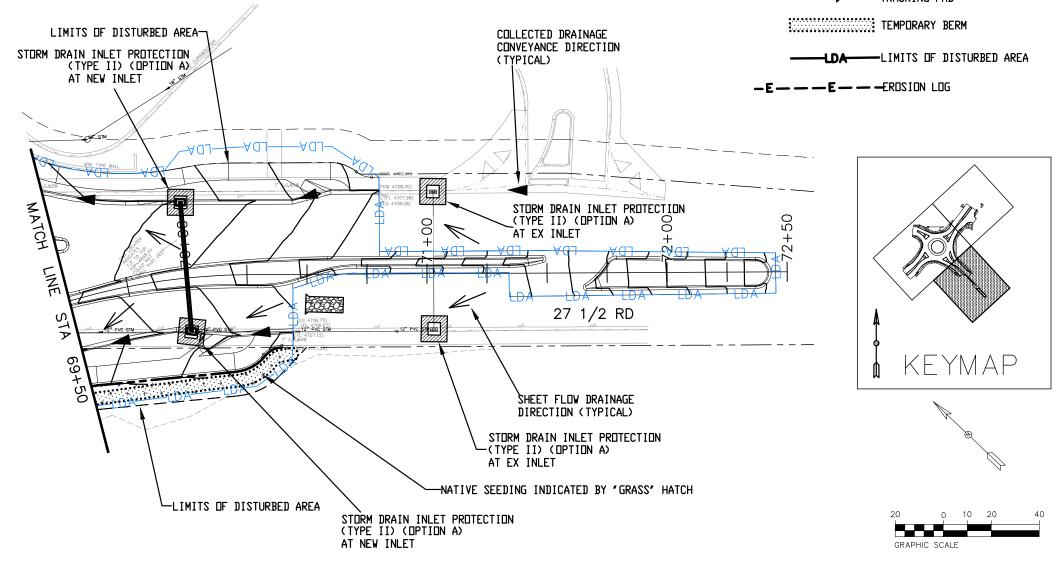

- NOTES:
 1. SEE LANDSCAPE PLANS FOR SEEDING, MULCHING, AND SOD REVEGETATION REQUIREMENTS.
- BMPS NOT DRAWN TO SCALE.
- BMP PLACEMENT IS APPROXIMATE.
- SEE SWMP NARRATIVE FOR BMPS.
- ECS TO UPDATE SWMP SITE PLANS DURING CONSTRUCTION.
 ECS TO DETERMINE LOCATIONS FOR VEHICLE TRACKING PAD, CONCRETE
 WASHOUTS AND STAGING AREAS.

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Unit Information: City of GJ	Unit Leader Initials: LF	
Grand Junction	333 WEST AVE, BLDG C Grand Junction, CO, 81501	
COLORADO	Phone: 970-244-1554	

Sheet Revisions									
Date:	Comments	Init.							
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Colorado D	epartment of Transportation
CO	606 South 9th Street Grand Junction, CO, 81501 Phone: 970–683–6351 FAX: 970–683–6369

Region 3

As Constructed	HORIZON DR AND (STORMWATER M.	Project No./Code				
No Revisions:	SHE M555-034					
Revised:	Designer: JCS	Structure Numbers	23652			
Void:	Detailer: JCS STORMWATER MANAGEMENT STE PLAN	Subset Sheets: X of X	Sheet Number 69			

							TABULAT	ION OF F	INAL SIG	SNING								
IGN NO.	ALIGNME NT	STATION	SIDE	NORTHING EASTING	DIMENSIONS	S SIGN CODE	LEGEND	(210-00810) RESET GROUND SIGN	(612-00041) DELINEATOR (FLEXIBLE) (TYPE 1)	(614-00011 SIGN PANE (CLASS I)	L SIGN PANEL	STEEL SIG (2" R	01503) N SUPPORT DUND) SOCKET)	STEEL SIG (2 1/2" RO	01573) IN SUPPORT UND NP-40) SLIPBASE)	10) FLASHING BEACO		NOTES
_								EACH	EACH	SF	SF		CH		ACH		ACH	
IR	HORIZON	60+31	RT	49788.39 96716.48	30 X 30	W11-2	PEDESTRIAN CROSSING SIGN FLUORESCENT YELLOW-GREEN	Plan As Con	Plan As Co	6.25	on Plan As Co	Plan 1	As Const	Plan	As Const	Plan 1	As Const	
_		60+31		49788.39 96716.48	24 X 12	W16-7P	DOWNWARD DIAGONAL ARROW LEFT SIGN FLUORESCENT YELLOW-GREEN			2.00		·						ON POST WITH SIGN A BOVE
				49840.86 96652.01	30 X 30	W11-2	PEDESTRIAN CROSSING SIGN FLUORESCENT YELLOW-GREEN			6.25		1				1		
				49840.86 96652.01	24 X 12	W16-7P	DOWNWARD DIAGONAL ARROW LEFT SIGN FLUORESCENT YELLOW-GREEN			2.00						13		ON POST WITH SIGN ABOVE
R				49821.43 96686.98 49821.43 96686.98	30 X 30 24 X 12	W11-2 W16-7P	PEDESTRIAN CROSSING SIGN FLUORESCENT YELLOW-GREEN DOWNWARD DIAGONAL ARROW RIGHT SIGN FLUORESCENT YELLOW-GREEN			6.25 2.00		1				1		ON POST WITH SIGN ABOVE
R		60+42			30 X 30	W11-2	PEDESTRIAN CROSSING SIGN FLUORESCENT YELLOW-GREEN			6.25		1				1		ON OUT WITH CIGHTABOVE
R	HORIZON	60+42	RT	49822.6 96700.15	24 X 12	W16-7P	DOWNWARD DIAGONAL ARROW RIGHT SIGN FLUORESCENT YELLOW-GREEN			2.00								ON POST WITH SIGN ABOVE
R	<u> </u>			49946.13 96825.69	30 X 30	W11-2	PEDESTRIAN CROSSING SIGN FLUORESCENT YELLOW-GREEN			6.25		1				1		
२ २		62+18		49946.13 96825.69 49943.42 96845.31	24 X 12 30 X 30	W16-7P W11-2	DOWNWARD DIAGONAL ARROW RIGHT SIGN FLUORESCENT YELLOW-GREEN PEDESTRIAN CROSSING SIGN FLUORESCENT YELLOW-GREEN			2.00 6.25		1				1		ON POST WITH SIGN A BOVE
_				49943.42 96845.31	24 X 12	W16-7P	DOWNWARD DIAGONAL ARROW RIGHT SIGN FLUORESCENT YELLOW-GREEN			2.00		1				- '		ON POST WITH SIGN ABOVE
				49929.14 96880.52	30 X 30	W11-2	PEDESTRIAN CROSSING SIGN FLUORESCENT YELLOW-GREEN			6.25		1				1		
-				49929.14 96880.52	24 X 12	W16-7P	DOWNWARD DIAGONAL ARROW LEFT SIGN FLUORESCENT YELLOW-GREEN			2.00								ON POST WITH SIGN A BOVE
2				49979.05 96811.06	30 X 30	W11-2	PEDESTRIAN CROSSING SIGN FLUORESCENT YELLOW-GREEN			6.25		1				11		ON DOCT MITH CION A DOVE
₹ ₹	HORIZON G RD	62+31 69+29	_	49979.05 96811.06 49837.15 96879.61	24 X 12 30 X 30	W16-7P W11-2	DOWNWARD DIAGONAL ARROW LEFT SIGN FLUORESCENT YELLOW-GREEN PEDESTRIAN CROSSING SIGN FLUORESCENT YELLOW-GREEN			2.00 6.25		1				1		ON POST WITH SIGN A BOVE
1	G RD			49837.15 96879.61	24 X 12	W16-7P	DOWNWARD DIAGONAL ARROW LEFT SIGN FLUORESCENT YELLOW-GREEN			2.00						-		ON POST WITH SIGN A BOVE
R	G RD	69+29	RT	49768.43 96824.58	30 X 30	W11-2	PEDESTRIAN CROSSING SIGN FLUORESCENT YELLOW-GREEN			6.25		1				1		
R	G RD			49768.43 96824.58	24 X 12	W16-7P	DOWNWARD DIAGONAL ARROW LEFT SIGN FLUORESCENT YELLOW-GREEN			2.00								ON POST WITH SIGN A BOVE
R	G RD	69+18	LT LT		30 X 30	W11-2	PEDESTRIAN CROSSING SIGN FLUORESCENT YELLOW-GREEN			6.25		1				1		ON DOCT MITH SION A BOVE
R R	G RD G RD			49825.1 96858.47 49808.01 96833.72	24 X 12 30 X 30	W16-7P W11-2	DOWNWARD DIAGONAL ARROW LEFT SIGN FLUORESCENT YELLOW-GREEN PEDESTRIAN CROSSING SIGN FLUORESCENT YELLOW-GREEN			2.00 6.25		1				-1		ON POST WITH SIGN A BOVE
R	G RD	69+10			24 X 12	W16-7P	DOWNWARD DIAGONAL ARROW RIGHT SIGN FLUORESCENT YELLOW-GREEN			2.00		<u> </u>						ON POST WITH SIGN A BOVE
R	G RD	69+23			30 X 30	W11-2	PEDESTRIAN CROSSING SIGN FLUORESCENT YELLOW-GREEN			6.25		1				1		
R	G RD	69+23			24 X 12	W16-7P	DOWNWARD DIAGONAL ARROW RIGHT SIGN FLUORESCENT YELLOW-GREEN			2.00								ON POST WITH SIGN A BOVE
R	G RD G RD	66+93 66+93		49987.11 96701.99 49987.11 96701.99	30 X 30	W11-2	PEDESTRIAN CROSSING SIGN FLUORESCENT YELLOW-GREEN			6.25		1				1		ON POST WITH SIGN A BOVE
R	G RD	67+03		ACCURATION AND ADDRESS OF THE PARTY OF THE P	24 X 12 30 X 30	W16-7P W11-2	DOWNWARD DIAGONAL ARROW LEFT SIGN FLUORESCENT YELLOW-GREEN PEDESTRIAN CROSSING SIGN FLUORESCENT YELLOW-GREEN			2.00 6.25		1				1		ON FOST WITH SIGNABOVE
iR	G RD	10-100 -0-10-10-10-10-10-10-10-10-10-10-10-10-1		49925.54 96667.95	24 X 12	W16-7P	DOWNWARD DIAGONAL ARROW LEFT SIGN FLUORES CENT YELLOW-GREEN			2.00								ON POST WITH SIGN A BOVE
R	G RD	67+00	LT		30 X 30	W11-2	PEDESTRIAN CROSSING SIGN FLUORESCENT YELLOW-GREEN			6.25		1				1		
R	G RD			49963.49 96692.8	24 X 12	W16-7P	DOWNWARD DIAGONAL ARROW RIGHT SIGN FLUORESCENT YELLOW-GREEN			2.00								ON POST WITH SIGN A BOVE
7R 7R	G RD G RD	67+11 67+11	RT	49949.99 96696.31 49949.99 96696.31	30 X 30 24 X 12	W11-2 W16-7P	PEDESTRIAN CROSSING SIGN FLUORESCENT YELLOW-GREEN DOWNWARD DIAGONAL ARROW RIGHT SIGN FLUORESCENT YELLOW-GREEN			6.25 2.00		1				1		ON POST WITH SIGN A BOVE
BA	HORIZON		RT		36 X 36 X 36		YELD			3.90				1				ON OCT WITHOUT ABOVE
A	HORIZON	60+55	RT	49823.6 96714.74	36 X 36 X 36	R1-2	YELD			3.90				1				
		61+91					YELD			3.90				1				
A	HORIZON	62+09 68+55				R1-2	YELD			3.90				1				
A	G RD G RD	68+85				R1-2 R1-2	MELD YIELD			3.90 3.90				1				
Α	G RD	68+98	LT	49819.37 96827.94	36 X 36 X 36	R1-2	YELD			3.90				1				
A				49895.64 96677.94			YELD			3.90				1				
A				49934.61 96700.87			YIELD			3.90				1				
				49852.18 96789.1 49888.26 96808.32	48 X 24 48 X 24	R6-4A R6-4A	ROUNDABOUT DIRECTIONAL (3 CHEVRONS) ROUNDABOUT DIRECTIONAL (3 CHEVRONS)			8.00				1				
_				49918.76 96763.01	48 X 24	R6-4A	ROUNDABOUT DIRECTIONAL (3 CHEV RONS)			8.00				1				
3	HORIZON	61+04	LT	49869.78 96741.79	48 X 24	R6-4A	ROUNDABOUT DIRECTIONAL (3 CHEVRONS)			8.00				1				
				49312.29 96134.66		W2-6	CIRCULAR INTERSECTION			6.25		1						ON DOCTIME LOSSY - TOY-
_				49312.29 96134.66 49553.88 96453.7		W16-9P	AHEAD (PLAQUE)			2.00		1						ON POST WITH SIGN A BOVE
_				49553.88 96453.7	30 X 30 24 X 24	W2-6 W13-1P	CIRCULAR INTERSECTION ADVISORY SPEED (15 MPH) PLAQUE			6.25 4.00								ON POST WITH SIGN A BOVE
5	HORIZON	58+80	RT	49682.27 96607.05	48 X 36	R-8 (SPECIAL)	ADVANCE INTERSECTION LANE CONTROL SIGN (RT LANE - RT TURN & THRU , LT LANE - THRU & LT TURN AROUND DOT)				12.00			1				
_				49717.86 96588.33 49771.08 96684.97	24 X 30	R4-7	KEEP RIGHT			5.00		1						
				49771.08 96684.97	36 x 36 36 x 36	R1-5 R1-5	YELD HERE TO PEDS YELD HERE TO PEDS			9.00		1						
_				49996.63 96838.26		R1-5	YIELD HERE TO PEDS			9.00		1						
_				49971.62 96857.8	36 x 36	R1-5	YELD HERE TO PEDS			9.00		1						
-				49951.32 96641.91	36 x 36	R1-5	YELD HERE TO PEDS			9.00		1						MAY DE INOTALLES ON VOTE CONTROL
f	G RD G RD			49982.01 96651.85 49806.2 96896.67	36 x 36 36 x 36	R1-5 R1-5	YIELD HERE TO PEDS YIELD HERE TO PEDS			9.00		1						MAYBE INSTALLED ON XCEL LIGHT POST
ig ih	G RD			49775.41 96867.44	36 x 36	R1-5	YIELD HERE TO PEDS YELD HERE TO PEDS			9.00		1						
\Box																		
							SHEET 1 SUBTOTAL	0	0	302.9	12	28		14		17		

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Unit Information: City of GJ Unit Leader Initials: LF			
Grand Junction 333 WEST AVE, BLDG C Grand Junction, CO, 81501 Phone: 970-244-1554			
C O L O R A D O Phone: 970–244–1554			

Colorado Department of Transportation
606 South 9th Street

CO	606 South 9th Street Grand Junction, CO, 81501 Phone: 970-683-6351 FAX: 970-683-6369
Region 3	KC

As Constructed	HORIZON DR AND (G RD ROUNDABOUT	Project No./Code
No Revisions:	SIGNING	• • • • • • • • • • • • • • • • • • • •	SHE M555-034
Revised:	Designer: JCS	Structure	23652
Void:	Detailer: JCS TABULATION OF FINAL SIGNING	Numbers Subset Sheets: X of X	Sheet Number 70

						TABULATION	OF FI	NAL	SIGN	ING (CON	T.)						
SIGN ALIGNI NO. NT		STATION	SIDE NORTHING EASTING	DIMENSIONS	NIMENSIONS SIGN CODE	LEGEND	(210-00 RESI GROU SIGI	ET IND	(612-000 DELINEA (FLEXIBI (TYPE	OR SIGN PANE	L SIGN PANEL	STEEL SIGN (2" RC	01503) N SUPPORT DUND) SOCKET)	(614-01573) STEEL SIGN SUPPORT (2 1/2" ROUND NP-40) (POST & SLIPBASE)	RECTANGU FLASHING		NOTES
0.7	HODIZON	00.00	LT 40000 00 00040 04	EMOTINO	5446	ADODE A OTDEET AND AND WEED AND ADDRESS TO ODE OFFICE A CONTION.	EAC	H	EACH	SF	SF	EA	CH	EACH	EA	ACH .	
37	HURIZUN	60+00	LT 49820.06 96640.24	EXISTING	D14-2	ADOPT A STREET ACKNOWLEDGMENT SIGN RESET TO SPECIFIED LOCATION	1										COORDINATE SIGN COMPOSITION WITH SCOTT
38	HORIZON	60+51	LT 49843.57 96696.58	60 X 18	D3-1 (SPECIAL)	STREET NAME - HORIZON DR WITH DOWNWARD DIAGONAL ARROW RIGHT AND CITY OF GRAND JUNCTION LOGO				7.50		1					FRAZIER, TRAFFIC CREW LEADER, CITY OF GJ (970)256-4117
39	G RD	68+98	RT 49806.98 96814.01	60 X 18	D3-1 (SPECIAL)	STREET NAME - 27 1/2 RD WITH DOWNWARD DIAGONAL ARROW RIGHT AND CITY OF GRAND JUNCTION LOGO				7.50		1					COORDINATE SIGN COMPOSITION WITH SCOTT FRAZIER, TRAFFIC CREW LEADER, CITY OF GJ (970)256-4117
40	G RD	69+49	LT 49800.51 96872.47	60 X 18	D3-1 (SPECIAL)	STREET NAME - HORIZON DR WITH DOWNWARD DIAGONAL ARROW RIGHT AND CITY OF GRAND JUNCTION LOGO				7.50		1					COORDINATE SIGN COMPOSITION WITH SCOT FRAZIER, TRAFFIC CREW LEADER, CITY OF GJ (970)256-4117
41	HORIZON	62+13	RT 49924.27 96839.46	60 X 18	D3-1 (SPECIAL)	STREET NAME - HORIZON DR WITH DOWNWARD DIAGONAL ARROW RIGHT AND CITY OF GRAND JUNCTION LOGO				7.50		1					COORDINATE SIGN COMPOSITION WITH SCOT FRAZIER, TRAFFIC CREW LEADER, CITY OF GJ (970)256-4117
42	G RD	67+24	LT 49952.22 96714.89	60 X 18	D3-1 (SPECIAL)	STREET NAME - G ROAD WITH DOWNWARD DIAGONAL ARROW RIGHT AND CITY OF GRAND JUNCTION LOGO				7.50		1					COORDINATE SIGN COMPOSITION WITH SCOT FRAZIER, TRAFFIC CREW LEADER, CITY OF GJ (970)256-4117
43	G RD	59+41	RT 49981.39 95941.42	30 X 30	W2-6	CIRCULAR INTERSECTION				6.25		1					(970)230-4117
44	G RD	59+41	RT 49981.39 95941.42	24 X 12	W16-9P	AHEAD (PLAQUE)				2.00							ON POST WITH SIGN ABOVE
45	G RD		RT 49981.84 96341.42	30 X 30	W2-6	CIRCULAR INTERSECTION				6.25		1					ON DOOT WITH OLON ADON'S
46	G RD		RT 49981.84 96341.42	24 X 24	W13-1P R-8	ADVISORY SPEED (15 MPH) PLAQUE ADVANCE INTERSECTION LANE CONTROL SIGN (RT LANE - RT TURN & THRU , LT	+			4.00	+						ON POST WITH SIGN ABOVE
47	G RD	65+56	RT 49966.87 96553.21	48 X 36	(SPECIAL)	LANE - LTTURN AROUND DOT)					12.00			1			
48	G RD	66+56	CL 49982.01 96651.85	24 X 30	R4-7	KEEP RIGHT				5.00							MAY BE INSTALLED ON XCEL LIGHT POST
49	G RD	66+43	LT 50012.88 96648.86	EXISTING	D14-2	ADOPT A STREET ACKNOWLEDGMENT SIGN RESET TO SPECIFIED LOCATION	1										
50	HORIZON		LT 50017.19 96849.23	EXISTING	D1-4A	DESTINATION AND DISTANCE SIGN FOR BIKERS - RESET TO SPECIFIED LOCATION	1										
51 52	HORIZON HORIZON	62+92 62+78	LT 50017.19 96849.23 LT 50003.53 96844.49	EXISTING EXISTING	D1-2 R14-1	DESTINATION SIGN - MAP FOR BIKERS - RESET TO SPECIFIED LOCATION TRUCK ROUTE - RESET TO SPECIFIED LOCATION	1										
				LAISTING	K14-1	TROCK ROUTE - RESET TO SPECIFIED ECCATION	'										COORDINATE SIGN COMPOSITION AND
53 54	HORIZON	65+00 64+46	RT 50133.49 97045.61 LT 50149.09 96931.07	EXISTING	RS-031	BUS STOP SIGN - GRAND VALLEY TRANSIT - RESET TO NEW KIOSK	1										PLACEMENT WITH GRAND VALLEY TRANSIT COORDINATE SIGN COMPOSITION AND
34	HONZON	04140	L1 30143.03 90931.07	EXISTING	RS-031	BUS STOP SIGN - GRAND VALLEY TRANSIT - RESET TO NEW KIOSK	1										PLACEMENT WITH GRAND VALLEY TRANSIT
55	HORIZON	63+75	LT 50086.53 96898.88	48 X 36	R-8 (SPECIAL)	ADVANCE INTERSECTION LANE CONTROL SIGN (RT LANE - RT TURN & THRU , LT LANE - THRU & LT TURN AROUND DOT)					12.00			1			
56	HORIZON	64+13	RT 50090.76 96955.04	54 X 18	R6-1R	ONE WAY RIGHT SIGN				6.75		1					
57	HORIZON			36 X 36	R3-2	NO LEFT TURN				9.00							
58	HORIZON	64+30	RT 50074.39 97006.23	48 X 12	D3-1 (SPECIAL)	STREET NAME - HORIZON DR WITH CITY OF GRAND JUNCTION LOGO				4.00		1					COORDINATE SIGN COMPOSITION WITH SCOT FRAZIER, TRAFFIC CREW LEADER, CITY OF G (970)256-4117
59	HORIZON	64+30	RT 50074.39 97006.23	48 X 12	D3-1 (SPECIAL)	STREET NAME - G ROAD WITH CITY OF GRAND JUNCTION LOGO				4.00							COORDINATE SIGN COMPOSITION WITH SCOT FRAZIER, TRAFFIC CREW LEADER, CITY OF G (970)256-4117
60	HORIZON	64+30	RT 50074.39 97006.23	36 X 36	R1-1	STOP				9.00							(0.07=00.111)
61			RT 50099.48 97009.76	EXISTING	R1-5	YIELD HERE TO PEDS - RESET TO SPECIFIED LOCATION	1										
62	HORIZON		LT 50270.51 97024.63	30 X 30	W2-6	CIRCULAR INTERSECTION				6.25		1					
63	HORIZON HORIZON	65+98 69+67	LT 50270.51 97024.63 LT 50584.96 97218.13	24 X 24	W13-1P	ADVISORY SPEED (15 MPH) PLAQUE				4.00		4					
65	HORIZON	69+67	LT 50584.96 97218.13	30 X 30 24 X 12	W2-6 W16-9P	CIRCULAR INTERSECTION AHEAD (PLAQUE)				6.25 2.00		1					
66	G RD		LT 49759.43 96947.02	EXISTING	D1-3A	DESTINATION AND DISTANCE SIGN FOR BIKERS - RESET TO SPECIFIED LOCATION	1			2.00							
67	G RD	70+26	LT 49759.43 96947.02	EXISTING	D1-2	DESTINATION SIGN - MAP FOR BIKERS - RESET TO SPECIFIED LOCATION	1										
68	G RD	70+11	LT 49779.32 96942.23	EMOTINO		TO COM DESCRIPTION OF CONTROL											SIGN WILL BE REMOVED, SALVAGED, AND RESET TO NEW POST. INCLUDES ALL NEED
69	G RD	70+11	LT 49779.32 96942.23	EXISTING	M4-5	TO SIGN - RESET TO SPECIFIED LOCATION	1					1					HARDWARE SIGN WILL BE REMOVED, SALVAGED, AND RESET TO NEW POST. INCLUDES ALL NEED!
70	G RD	70+11	LT 49779.32 96942.23	EXISTING	M1-1	INTERSTATE ROUTE SIGN - RESET TO SPECIFIED LOCATION	1										HARDWARE SIGN WILL BE REMOVED, SALVAGED, AND RESET TO NEW POST. INCLUDES ALL NEED
		1 Table 1		EXISTING	M6-1	DIRECTIONAL ARROW (RIGHT) - RESET TO SPECIFIED LOCATION	1										HARDWARE
71	G RD	71+00	LT 49709.68 97002.54	48 X 36	R-8 (SPECIAL)	ADVANCE INTERSECTION LANE CONTROL SIGN (RT LANE - RT TURN , LT LANE -					12.00			1			
72	G RD	70+71	RT 49679.21 96929.4	EXISTING	W11-3	THRU & LT TURN AROUND DOT) NON-VEHICULAR WARNING SIGN (DEER) - RESET TO SPECIFIED LOCATION	1										
73	G RD	73+00	LT 49558.36 97133.26	30 X 30	W2-6	CIRCULAR INTERSECTION				6.25		1					
74	G RD	73+00	LT 49558.36 97133.26	24 X 24	W13-1P	ADVISORY SPEED (15 MPH) PLAQUE				4.00							
75	G RD		LT 49241.13 97377.81	30 X 30	W2-6	CIRCULAR INTERSECTION				6.25		1					
76	G RD	77+00	LT 49241.13 97377.81	24 X 12	W16-9P	AHEAD (PLAQUE)				2.00							
77 78	G RD G RD	72+37 71+27	CL 49582.07 97067.51 LT 49664.27 96994.7	24 X 30	R4-7	KEEPRIGHT				5.00		1					LETS TRAFFIC EXITING STARBUCKS DEVELOPMENT KNOW ONLY RIGHT TURNS
79	G RD	71+27	LT 49664.27 96994.7	54 X 18	R6-1R	ONE WAY RIGHT SIGN				6.75		1					ALLOWED AND LEFTS ARE PROHIBITED LETS TRAFFIC EXITING STARBUCKS DEVELOPMENT KNOW ONLY RIGHT TURNS
13	OILD	111721	L1 45004.21 50554.1	36 X 36	R3-2	NO LEFT TURN				9.00							ALLOWED AND LEFTS ARE PROHIBITED
80	G RD	71+40	LT 49655.17 97003.73			DELINEATOR (FLEXIBLE) (TYPE 1)			1								
						SHEET 2 SUBTOTAL SHEET 1 SUBTOTAL			0	151.5 302.9	36 12	16 28		3 14	0 17		
						PROJECT TOTAL		+	1	454.4	48	44		17	17	-	
	I																

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Horiz. Scale: AS SHOWN

Unit Information: City of GJ

Grand Junction

333 WEST AVE, BLDG C Grand Junction, CO, 81501 Phone: 970–244–1554

Sheet Revisions


Date: Comments Init.

Region 3

Colorado Department of Transportation

606 South 9th Street
Grand Junction, CO, 81501
Phone: 970-683-6351 FAX: 970-683-6369

As Constructed	HORIZON DR AND (G RD ROUNDABOUT	Project No./Code		
No Revisions:	SIGNING	· · · · · · · · · · · · · · · · · · ·	SHE M555-034		
Revised:	Designer: JCS	Structure	23652		
Void:	Detailer: JCS TABULATION OF FINAL SIGNING	Numbers Subset Sheets: X of X	Sheet Number 71		

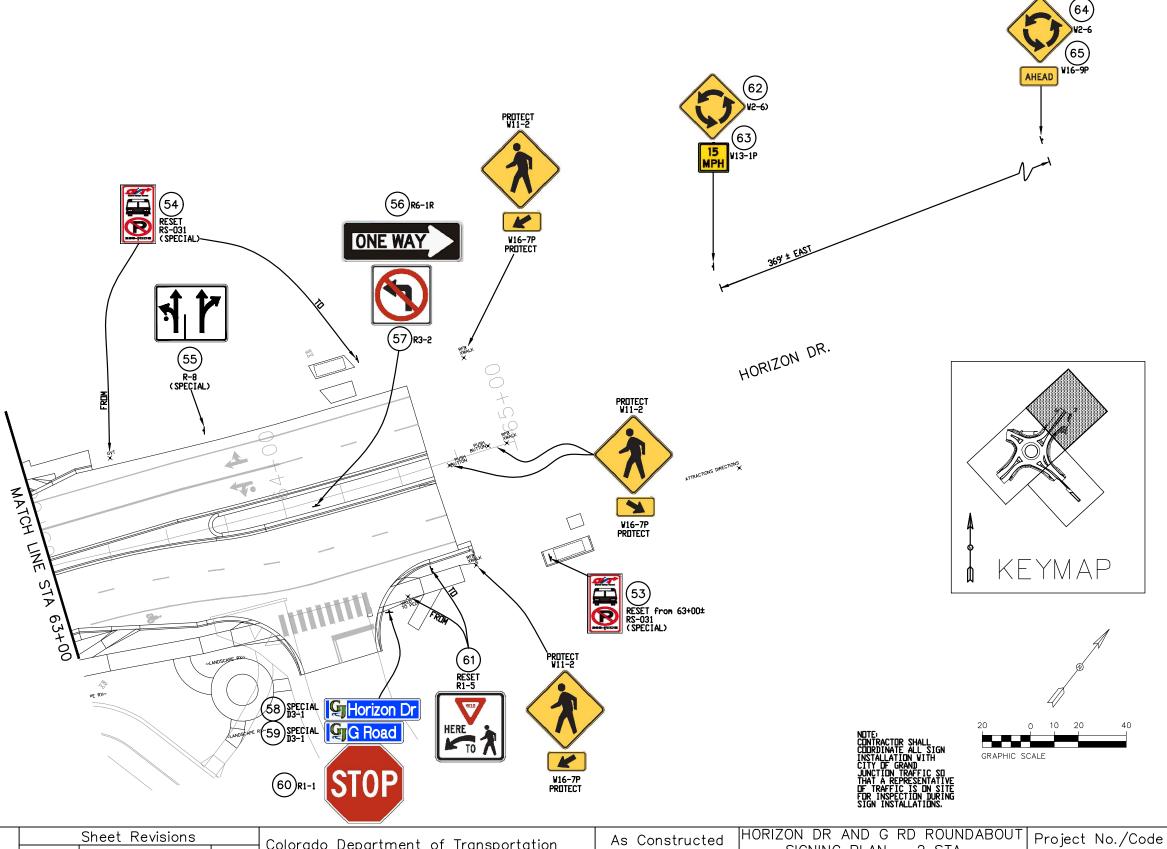


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60	606 South 9th Street Grand Junction, CO, 81501 Phone: 970-683-6351 FAX: 970-683-6369
Region 3	KC

As Constructed	HORIZON	DR AND (NING PLAN	RD R	NDUNDA	BOUT	Project No./Code				
No Revisions:		63+00 TO	SHE M555-034							
Revised:	Designer:	JCS	Structure Numbers			23652				
Void:	Detailer: Sheet Subset:	JCS SIGNING PLAN	Subset Sh		X of X	Sheet Number	73			

SOUTH SIDE OF HORIZON CORPLEX DRIVEWAY CUT



Vert. Scale: NA Unit Information: City of GJ Unit Leader Initials: LF 333 WEST AVE, BLDG C Grand Junction, CO, 81501 Phone: 970–244–1554 Grand Junction

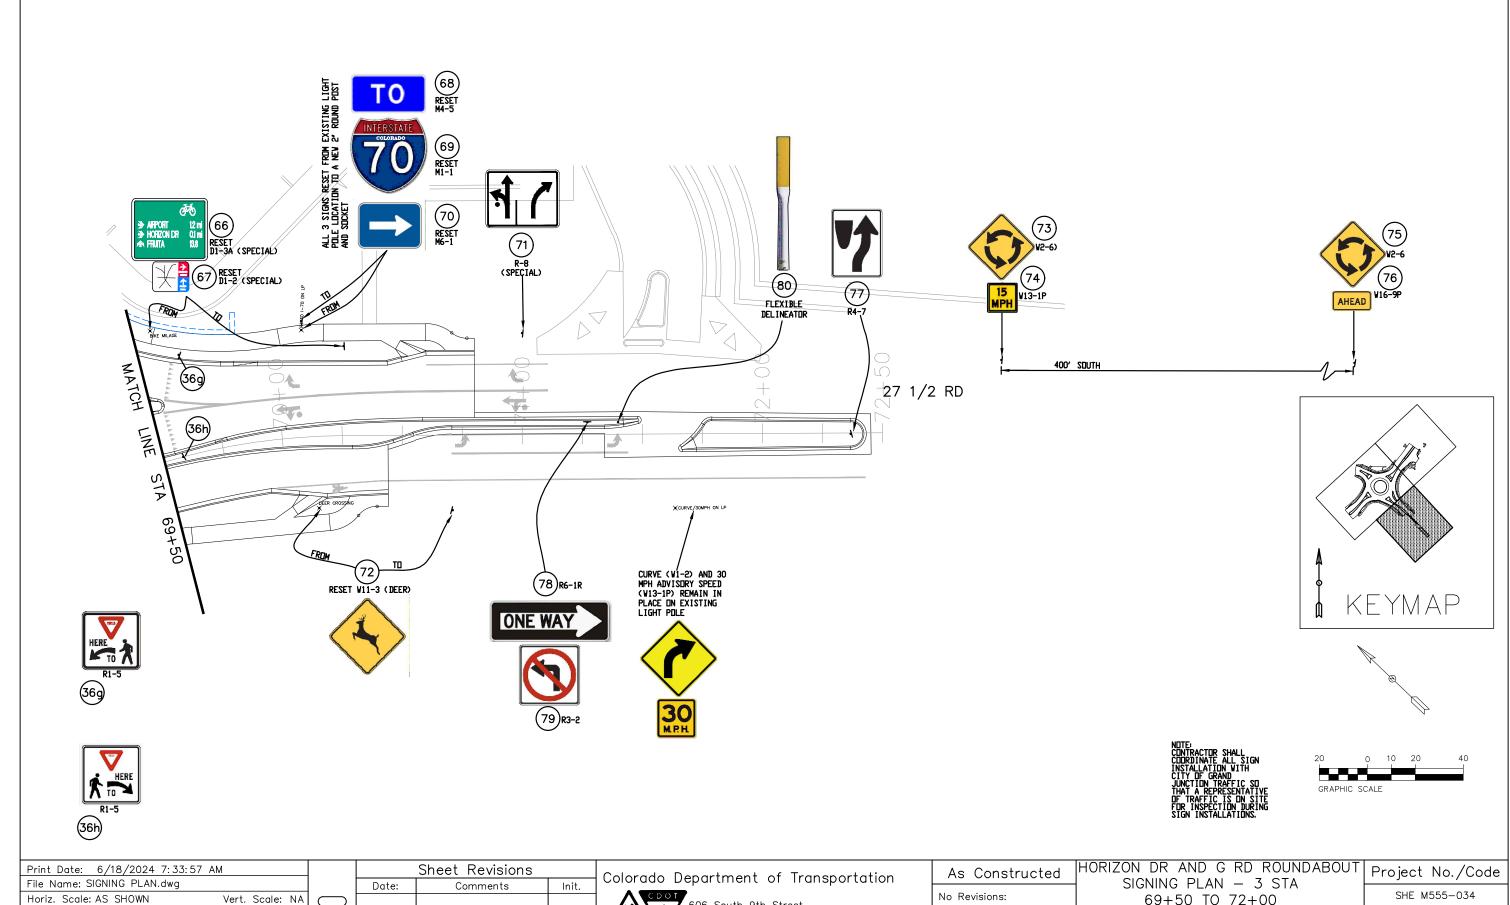CO.

Region 3

606 South 9th Street Grand Junction, CO, 81501 Phone: 970-683-6351 FAX: 970-683-6369

As Constructed	HORIZON	DR AND (GRDF	OUNDA	ABOUT	Project No./Code				
No Revisions:	SIGNING PLAN - 3 STA visions: 69+50 TO 72+00									
Revised:	Designer:	JCS	Structure			23652				
	Detailer:	JCS	Numbers							
Void:	Sheet Subset:	SIGNING PLAN	Subset Sh	leets:	X of X	Sheet Number	74			

TABULATION OF FINAL STRIPING

() MODIFIED											(627-02010) PREFORMED PLASTIC PAVEMENT MARKING (TYPE II) (INLAID)																
1	(627-00013)	TAVE	HEIT IMARKI								С	ONCRET	TE AND A	SPHALT						(627 - PREF	30411) ORMED	(QUANTITIES BELOW INCLUDE BLACK BACKGROUND PAINT))(
LOCATION	PAVE MENT MARKING PAINT (HIGH BUILD)	DOUBLE YELLOW SOLID	WHITE SOLID	WHITE		ARROW .5 SF)	RIGHT A (15.5		STRAIGHT ARROW (12.5 SF)	LEFT	AIGHT / ARROW .5 SF)	STRAK RIGHT AI (27.5	RROW	DROP LANE ARROW (58 SF)		SYMBOL 2 SF)	12 X 18 SHARK TEETH YIELD SYMBOL (0.75 SF)		RCLE 1 SF)	PAVEMEN (XWALK-	OPLASTIC IT MARKING STOP LINE) ECIAL)	WHITE SOLID	WHITE	BROKEN	WHIT	E SOLID	DOUBLE YELLOW SOLID	WHITE DOTTED LINE (2' SEGMENT, 3' GAP)	COMMENTS
		4 INCH	4 INCH																1			4 INCH		INCH		NCH	4 INCH	8 INCH	_
	GAL	LF	LF	LF	EA	SF	EA	SF	EA SF	EA	SF	EA	SF	EA SF	EA	SF	EA SF	EA	SF	LF	SF	LF SF	LF	SF	LF	SF	LF SF	LF SF	
HORIZON DRIVE																													
57+19 TO 58+78		250																											DBL YELLOW BOTH SIDES
58+78, 33' LT TO 59+60, 29' LT																						78							EDGE LINE WEST BOUND LEG OUT
59+10, 35' LT															1														BIKE W BOUND LEG OUT
59+20, 25' LT														1															DROP LANE W. BOUND LEG OUT
58+78, 20' LT TO 59+60, 17' LT					_																							80	WEST BOUND LEG OUT
58+85, 14' RT										1								1							407				EAST BOUND LEG IN
58+80, 20' RT TO 60+65, 36' RT 58+85, 25' RT												4													187				CHANNEL LINE EAST BOUND LEG IN
58+85, 25' RT 58+79, 32' RT TO 59+39, 29' RT		+		+	1	+ +					+		_	_	1				1		-	63	_	_		1		+ + -	EAST BOUND LEG IN EDGE LINE EAST BOUND LEG IN
59+60, 17' LT TO 60+65, 40' LT																						03	115						LANE LINE WEST BOUND LEG OUT
59+95, 5' RT TO 59+95, 29' RT																	12						110						SHARK TEETH YIELD BAR EAST BOUND LEG IN
60+35																				108									CROSSWALK SW QUADRANT
60+52, 23' RT										1								1											EAST BOUND LEG IN
60+58, 40' RT												1																	EAST BOUND LEG IN
60+58, 20' RT TO 60+80, 59' RT																												46	EAST BOUND LEG IN
60+65									1																				SOUTHWEST QUADRANT
60+77					1																								SOUTHWEST QUADRANT
60+72																									50			10	CHANNEL LINE SOUTHWEST QUADRANT
60+65, 40' LT TO 60+99, 60' LT 60+75, 18' LT TO 60+97, 44' LT																												40 35	WEST SIDE ROUNDABOUT WEST SIDE ROUNDABOUT
60+80, 30' RT TO 61+16, 84' RT																												65	SOUTH SIDE ROUNDABOUT
61+25, 75' LT					+				1				_															03	NORTHWEST QUADRANT
60+99, 60' LT TO 61+61, 62' LT					+																				56				CHANNEL LINE NORTHWEST QUADRANT
61+28, 60' LT										1																			NORTHWEST QUADRANT
61+31, 60' RT										1																			SOUTHEAST QUADRANT
61+04, 57' RT TO 61+55, 64' RT																									59				CHANNEL LINE SOUTHEAST QUADRANT
61+30, 72' RT									1																				SOUTHEAST QUADRANT
61+61, 62' LT TO 61+78, 37' LT																												30	NORTH SIDE ROUNDABOUT
61+55, 64' RT TO 61+83, 50' RT																												33	EAST SIDE ROUNDABOUT
61+82, 125' LT TO 62+70, 68' LT	100																												ALL STRIPING AZTECA'S PARKING
61+83, 65' LT TO 62+06, 19' LT					_																							53	WEST BOUND LEG IN
61+99, 50' LT					_							1													405				WEST BOUND LEG IN
61+97, 43' LT TO 63+00, 16' LT 62+10, 30' LT		_		+	+	+ +		\vdash		1	+ -	-	-		1			1	-					+	105			+ + + -	WEST BOUND LEG IN WEST BOUND LEG IN
61+84, 50' RT TO 63+00, 16' RT		+		+		+ +				1	+				1			1	+				127					+ + +	LANE LINE EAST BOUND LEG OUT
62+00, 8' RT										1													121						NORTHEAST QUADRANT
62+22															1					108									CROSSWALK NE QUADRANT
62+60, 6' LT TO 62+60, 29' LT																	12												SHARK TEETH YIELD BAR WEST BOUND LEG IN
G ROAD																													
65+57, 14' LT TO 66+21, 22' LT			70																										EDGE LINE N SIDE OF G ROAD
66+15, 24' LT															1														BIKE N SIDE OF G ROAD
65+57 TO 66+22		133				1					+																		DBL YELLOW BOTH SIDES G ROAD
65+57, 13' RT TO 66+22, 16' RT		-		63	-	1		\vdash			+	-			1			1	-							-		+	CHANNEL LINE S BOUND G ROAD
65+66, 6' RT 65+66, 19' RT		-		-	1	+					+	1			+			1										+	SOUTH BOUND G ROAD SOUTH BOUND G ROAD
65+57, 25' RT TO 66+22, 29' RT			60	+	+	+ +		\vdash			+		-		+				-					_				+ + + -	EDGE LINE S SIDE OF G ROAD
66+22 TO 66+50		+	00	+	-	+ +					+ -				1				+								60	+ + + + + + + + + + + + + + + + + + + +	DBL YELLOW BOTH SIDES G ROAD ON CONC PAV
66+22, 16' RT TO 67+32, 32' RT				1	1							-			1									_	102				CHANNEL LINE S BOUND G ROAD
SHEET 1 SUBTOTAL (LF) =		1532	260	126	2		0		3	6		4		1	2		24	4		216		141	242		559		120	382	
SHEET 1 SUBTOTAL (SF) =	100	510	87	84		31.0		0.0	37.	.5	165.0		110.0	58.0		24.0	18.0		12.4		432	47	2	26		375	40	102	

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Horiz. Scale: AS SHOWN	Vert. Scale: NA	Г
Unit Information: City of GJ		Γ
Grand Junction	333 WEST AVE, BLDG C Grand Junction, CO, 81501	

	Sheet Revisions	
Date:	Comments	Init.

Colorado Department of Transportation

606 South 9th Street
Grand Junction, CO, 81501
Phone: 970-683-6351 FAX: 970-683-6369

Region 3 KC

As Constructed	HORIZON DR AND		ABOUT	Project No./Co	de				
No Revisions:	TABULATION OF FINAL STRIPING - 1								
Revised:	Designer: JCS	Structure Numbers		23652					
Void: TABUL	Detailer: JCS ATION OF FINAL STRIPING	Subset Sheets:	X of X	Sheet Number 75	5				

TABULATION OF FINAL STRIPING

		(627 00000	TABULATION OF FINAL STRIPING											G	(627-02010) PREFORMED PLASTIC PAVEMENT MARKING													
		PAVEN	(627-00008) MODIFIED EPOXY PAVEMENT MARKING (WORD-SYMBOL) (SPECIAL)										(627-30411) (TYPE II) (INLAID)															
	(627-00013)		1							CON	ICRETE ANI	A SPHAL	Т					PREF	ORMED IOPLA STIC		(1	QUANTITIES B	ELOW INCLUI	DE BLACI	K BACKGROU	IND PAINT)		
LOCATION	PAVEMENT MARKING PAINT (HIGH BUILD)	DOUBLE YELLOW SOLID	WHITE	WHITE	LEFT AR (15.5	RROW RIG	HT ARR(15.5 SF)		LEFT ARE	ROW RIG	STRAIGHT/ GHT ARROW (27.5 SF)		PLANE ROW (SF)	BIKE SYMBOL (12 SF)	SYMBOL	X18 SHARK PAVEMENT MARKING		WHITE DOTTED LINE (2' SEGMENT, 3' GAP)	COMMENTS									
		4 INCH	4 INCH																1	4 IN		4 INCH		INCH		INCH	8 INCH	
	GAL	LF	LF	LF	EA	SF E	A S	F EA S	SF EA	SF E	EA SE	EA	SF	EA SF	EA :	SF E	A SF	LF	SF	LF	SF	LF SI	F LF	SF	LF	SF	LF SF	
G ROAD																												
66+58, 5' RT TO 66+58, 29' RT															12													SHARK TEETH YIELD BAR SOUTH BOUND LEG IN
66+22, 29' RT TO 66+55, 29' RT 67+06					-		_			_							_	90		28							-	EDGE LINE S SIDE OF G ROAD CROSSWALK NORTH WEST LEG
67+21, 21' RT					1					_	_					1	_	90										SOUTH BOUND LEG IN
67+27, 36' RT		1			- ' -						1																	SOUTH BOUND LEG IN
67+28, 17' RT TO 67+40, 50' RT																											34	SOUTH BOUND LEG IN
51 25, 11 11 15 51 15, 55 11																			1									00 0111 20 0110 22 0 111
27 1/2 ROAD																												
68+77, 51' LT TO 68+41, 97' LT																											60	NORTH BOUND LEG IN
68+94, 11' LT TO 68+82, 44' LT																											35	NORTH BOUND LEG IN
68+80, 62' LT							l l																					NORTH BOUND LEG IN
69+02, 21' LT									1							1												NORTH BOUND LEG IN
69+15																		108										CROSSWALK AT NORTH BOUND LEG IN
HORIZON DRIVE					\vdash		_																					
63+00, 28' LT TO 64+64 31' LT					-		_													180								EDGE LINE NORTH SIDE OF HORIZON
63+85, 24' LT					\vdash		_		1		1					1		_								+		NORTH SIDE OF HORIZON DRIVE NORTH SIDE OF HORIZON DRIVE
63+85, 13' LT 63+00, 16' LT TO 64+02, 18' LT					-				1														102			_		CHANNEL LINE NORTH SIDE OF HORIZON
64+02, 18' LT TO 64+64, 18' LT					 																	60	102					LANE LINE NORTH SIDE OF HORIZON DR
63+00, 16' RT TO 64+64, 21' RT					1												_					165						LANE LINE SOUTH SIDE OF HORIZON DR
63+10, 28' RT TO 64+64, 32' RT																				160		100						EDGE LINE SOUTH SIDE OF HORIZON
63+37, 31' RT														1														SOUTH SIDE OF HORIZON
63+86, 46' RT TO 64+22, 46' RT																		90										CROSSWALK AT G RD AND HORIZON DR
64+04, 57' RT TO 64+22, 57' RT																		20										STOP LINE AT G RD AND HORIZON DR
64+04, 57' RT TO 64+04, 68' RT																									11			DOUBLE YELLOW G ROAD
27 1/2 ROAD																											+ + +	
69+55, 4' LT TO 69+60, 39' LT															16													SHARK TEETH YIELD BAR NORTH BOUND LEG IN
69+55, 22' LT TO 70+80, 18' LT																							155					CHANNEL LINE EAST SIDE OF 27 1/2 ROAD
70+05, 12' LT									1							1												EAST SIDE OF 27 1/2 ROAD
70+05, 21' LT						1	II.																					EAST SIDE OF 27 1/2 ROAD
70+60, 29' LT TO 70+80 29' LT																				20								EDGE LINE EAST SIDE OF 27 1/2 ROAD
69+93, 20' RT TO 70+44, 19' RT																				50								EDGE LINE WEST SIDE OF 27 1/2 ROAD
70+23, 22' RT			0.0		\vdash									1														WEST SIDE OF 27 1/2 ROAD
70+80 29' LT TO 71+11, 29' LT			30																									EDGE LINE EAST SIDE OF 27 1/2 ROAD
71+00, 24' LT 70+80 18' LT TO 71+11, 18' LT		-		30	+	- 1						1					-	1						-		1		EAST SIDE OF 27 1/2 ROAD CHANNEL LINE EAST SIDE OF 27 1/2 ROAD
71+00, 13' LT		-		30	-				1	-						1	-	-	+									EAST SIDE OF 27 1/2 ROAD
71+00, 13 L1 70+75, 4' RT		+			1		_		1			1	-			1	+	+	+							1	+ + -	LEFT TURN LANE EAST OFF OF 27 1/2 SOUTH
71+40. 4' RD		+			1												_	1								1	+ + +	LEFT TURN LANE EAST OFF OF 27 1/2 SOUTH
70+70, 8' LT TO 71+44, 8' LT				75	1																							LEFT TURN LANE EAST OFF OF 27 1/2 SOUTH
70+44, 19' RT TO 72+43, 19' RT		1	200	1	1 1													1	1							1		EDGE LINE WEST SIDE OF 27 1/2 ROAD
	1			-	-							-														-	 	
SHEET 2 SUBTOTAL (LF)		0	460	210	3			0	4		2	0		2	28	5		308		438		225	257		22		129	SHEET 2 SUBTOTAL (LF) =
SHEET 2 SUBTOTAL (SF)		0	153	140	_	46.5	46	Contract of the Contract of th		10.0	55.0		0.0	24.0		1.0	15.5		616		145	25		172		7		SHEET 2 SUBTOTAL (SF) =
SHEET 1 SUBTOTAL (LF)		1532	260	126	2)	3	6		4	1		2	24	4		216		141		242	559		120		382	SHEET 1 SUBTOTAL (LF) =
SHEET 1 SUBTOTAL (SF)		510	87	84		31				165	110	_	58	24		18	12		432		47	26		378		40		SHEET 1 SUBTOTAL (SF) =
TOTAL (LF)		1532 510	720 240	336	5	70	_	3	10		6	1	50	4	52	9		524	4040	579		467	816		142		511	TOTAL (LF) =
TOTAL (SF) TOTAL (GAL) WHERE APPLICABLE		6	3	224		78	4	7 ;	38 2	275	165		58	48		39	28		1048		191	5		547	<i>'</i>	47	137	TOTAL (SF) = TOTAL (GAL) WHERE APPLICABLE =
TO TAL (GAL) WHERE AFFLICABLE	-		J																									TOTAL (GAL) WHERE AFFLICABLE -

Print Date: 6/18/2024 8:07:39 AM		Sheet Revisions		Colorado Department of Transportation	As Const
File Name: TABULATION OF FINAL STRIPING.dwg	Date:	Comments	Init.	· ·	
Horiz. Scale: AS SHOWN Vert. Scale: NA				606 South 9th Street	No Revisions:
Unit Information: City of GJ Unit Leader Initials: LF				Grand Junction, CO, 81501	Revised:
Grand Junction 333 WEST AVE, BLDG C Grand Junction, CO, 81501				THOTIC: 070 000 0001 17000 000 0000	
C O L O R A D O Phone: 970–244–1554				Region 3 KC	Void:


As Constructed	I .	G RD ROUNDABOUT	Project No./Code							
No Revisions:	17.15027.1110	TABULATION OF FINAL STRIPING — 2								
Revised:	Designer: JCS	Structure	23652							
Void: TABU	Detailer: JCS _ATION OF FINAL STRIPING	Numbers Subset Sheets: X of X	Sheet Number 76							

NOTES


MATCH PROPOSED NEW


- 1 EPDXY PAVEMENT MARKING (PAINT) SHALL DNLY BE APPLIED TO ASPHALT PAVEMENT.
 2 ALL WORD-SYMBOL & XWALK-STOP LINE PAVEMENT MARKINGS SHALL BE
- PREFORMED THERMOPLASTIC ON BOTH ASPHALT PAVEMENT AND CONCRETE PAVEMENT.

 3 PREFORMED PLASTIC PAVEMENT MARKINGS (TYPE II) (INLAID) SHALL BE APPLIED TO CONCRETE PAVEMENT. NO EPOXY PAVEMENT MARKING (PAINT) SHALL BE APPLIED TO CONCRETE PAVEMENT.
- 4 ALL STENCILS ARE TO BE INLAID TO A DEPTH OF 90 MILS.

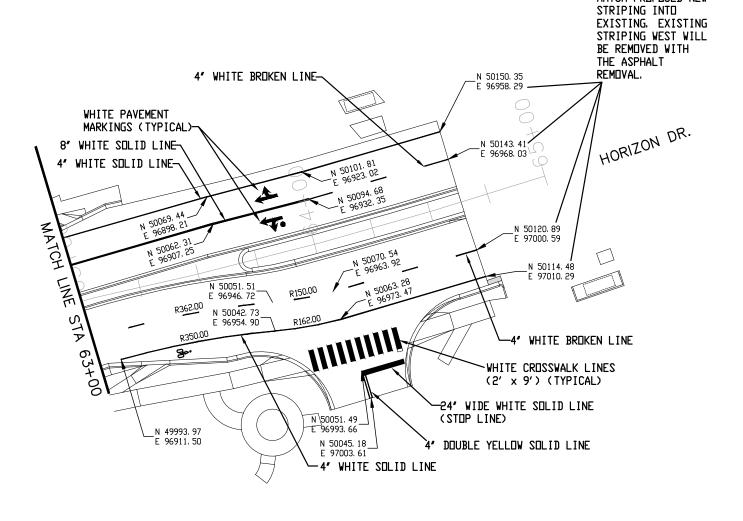

Region 3

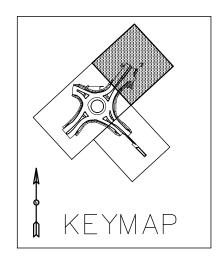

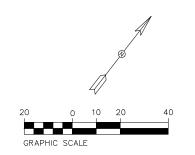

NOTE: SEE STAKING PLANS FOR STAKING DATA AND ELEVATIONS.

Print Date: 6/18/2024 7:	36: 46 AM
File Name: STRIPING PLAN.D)WG
Horiz. Scale: AS SHOWN	Vert. Scale: NA
Unit Information: City of GJ	Unit Leader Initials: LF
Grand Junction	333 WEST AVE, BLDG C Grand Junction, CO, 81501 Phone: 970–244–1554

	Sheet Revisions	
Date:	Comments	Init.


Colorado D	epartment of Transportation
CO	606 South 9th Street Grand Junction, CO, 81501 Phone: 970–683–6351 FAX: 970–683–6369


KC


As Constructed	HORIZON	DR AND (G RD F	ADNDO	BOUT	Project No./	'Code
No Revisions:	- STRIPING PLAN — 2 STA 63+00 TO 65+00		SHE M555-0	34			
Revised:	Designer:	JCS	Structure			23652	
	Detailer:	JCS	Numbers				
Void:	Sheet Subset:	STRIPING PLAN	Subset Sh	eets:	X of X	Sheet Number	78

NOTES:

- 1 EPOXY PAVEMENT MARKING (PAINT) SHALL ONLY BE APPLIED TO ASPHALT PAVEMENT.
- 2 ALL WORD-SYMBOL & XWALK-STOP LINE PAVEMENT MARKINGS SHALL BE PREFORMED THERMOPLASTIC ON BOTH ASPHALT PAVEMENT AND CONCRETE PAVEMENT.
- 3 PREFORMED PLASTIC PAVEMENT MARKINGS (TYPE II) (INLAID) SHALL BE APPLIED TO CONCRETE PAVEMENT. NO EPOXY PAVEMENT MARKING (PAINT) SHALL BE APPLIED TO CONCRETE PAVEMENT.
- 4 ALL STENCILS ARE TO BE INLAID TO A DEPTH OF 90 MILS.

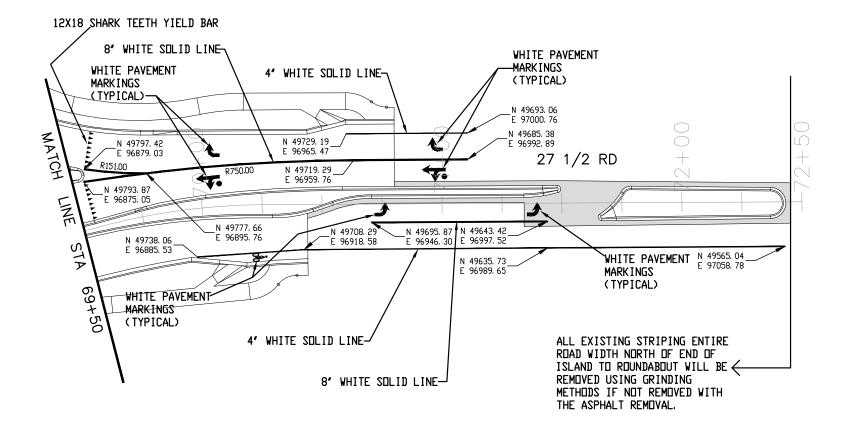

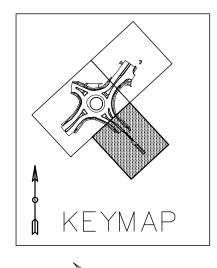

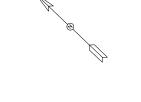




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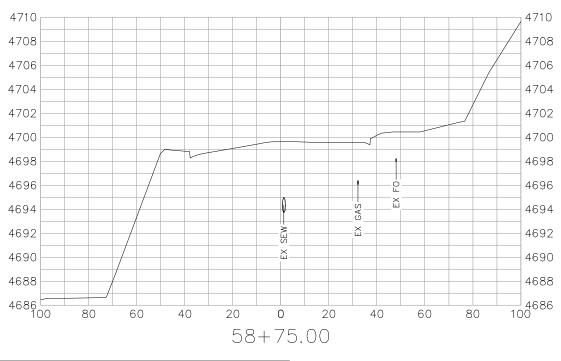
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Grand Junction	333 WEST AVE, BLDG C Grand Junction, CO, 81501 Phone: 970–244–1554


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Date:	Comments	Init.

Colorado D	epartment of Transportation
CO	606 South 9th Street Grand Junction, CO, 81501 Phone: 970-683-6351 FAX: 970-683-6369

As Constructed	HORIZON DR AND G RD ROUNDABOUT - STRIPING PLAN - 3 STA 69+50 TO 72+00		Project No./Code	
No Revisions:			SHE M555-034	
Revised:	Designer: JCS	Structure Numbers	23652	
Void:	Detailer: JCS Sheet Subset: STRIPING PLAN	Subset Sheets: X of X	Sheet Number 79	



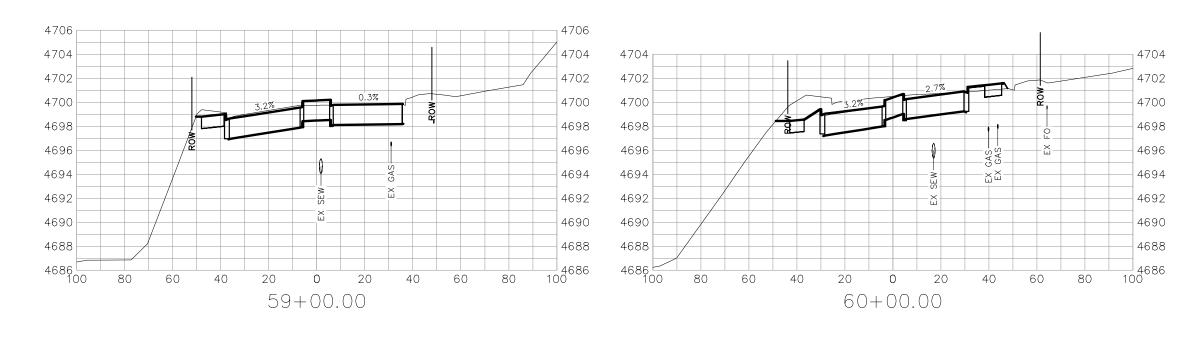

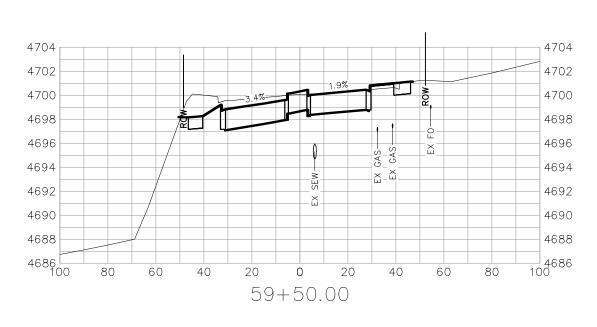

'FOR INFORMATION ONLY' SEE STAKING PLAN FOR PROPOSED GRADES


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Grand Junction	333 WEST AVE, BLDG C Grand Junction, CO, 81501	


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Date:	Comments	Init.


Colorado	Department of Transportation
co	606 South 9th Street Grand Junction, CO, 81501 Phone: 970-683-6351 FAX: 970-683-6


South 9th Street	
and Junction, CO, 81501	
one: 970-683-6351 FAX: 970-683-6369	
KC	


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Revised:	Designer: JCS	Structure	23652
	Detailer: JCS	Numbers	
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l void.	Sheet Subset: CROSS SECTION	Subset Sheets: X of X	Silect Number 80

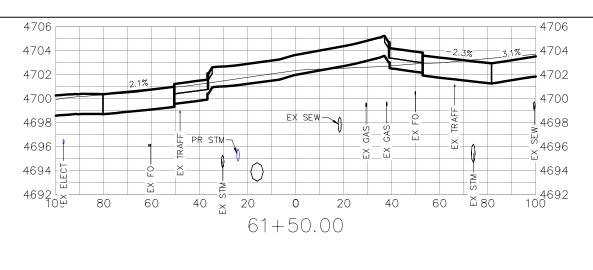


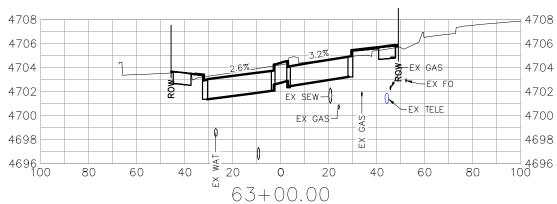

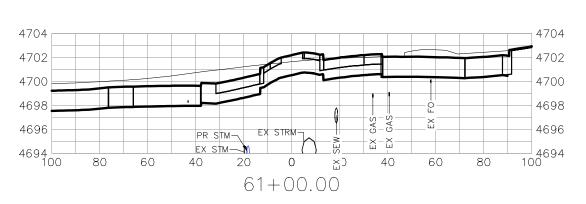

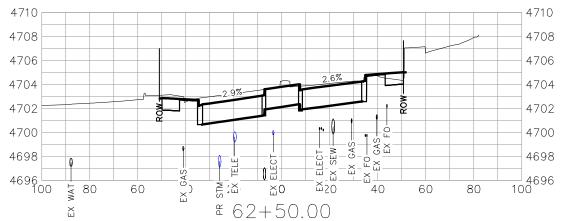

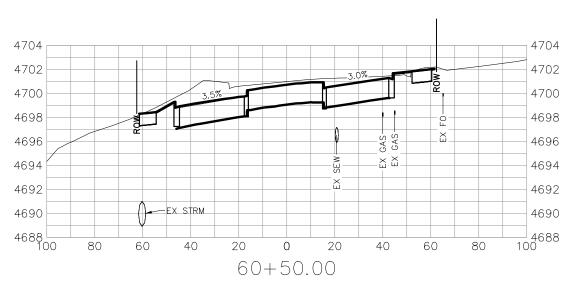

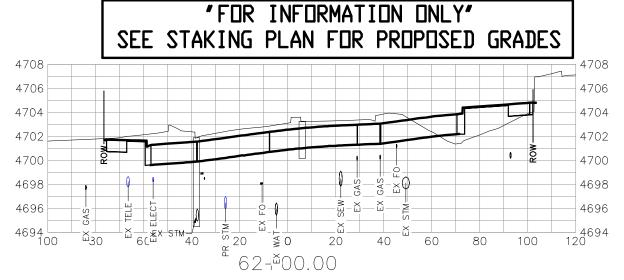


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Unit Information: City of GJ	Unit Leader Initials: LF	
Grand Junction	333 WEST AVE, BLDG C Grand Junction, CO, 81501	(
COLORADO	Phone: 970-244-1554	. (

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Date:	Comments	Init.

Colorado	Department	of	Transportation
CDC	606 South Oth	, C+,	-oot

CO	606 South 9th Street Grand Junction, CO, 81501 Phone: 970–683–6351 FAX: 970–683–6369
Region 3	KC

As Constructed	HORIZON DR AND (CROSS SEC	G RD ROUNDABOUT	Project No./Code
No Revisions:	STA 60+50		SHE M555-034
Revised:	Designer: JCS	Structure	23652
Void:	Detailer: JCS Sheet Subset: CROSS SECTION	Numbers Subset Sheets: X of X	Sheet Number 81

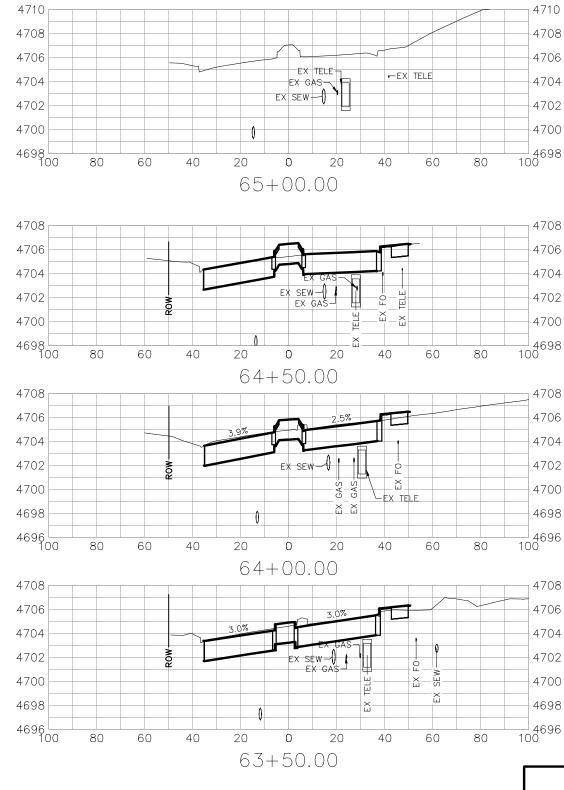


"FOR INFORMATION ONLY" SEE STAKING PLAN FOR PROPOSED GRADES

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Unit Information: City of GJ Unit Leader Initials: I	F 💮			
Grand Junction 333 WEST AVE, BLDG Grand Junction, CO, B. Phone 370 344 1554				

Colorado Department of Transportation


606 South 9th Street
Grand Junction, CO, 81501
Phone: 970-683-6351 FAX: 970-683-6369


As Constructed	HORIZON DR AND G RD ROUNDABOUT 					Project No./Code		
No Revisions:						SHE M555-0	34	
Revised:	Designer:	JCS	Structure Numbers			23652		
Void:	Detailer: Sheet Subset:	003	Subset Sh		X of X	Sheet Number	82	

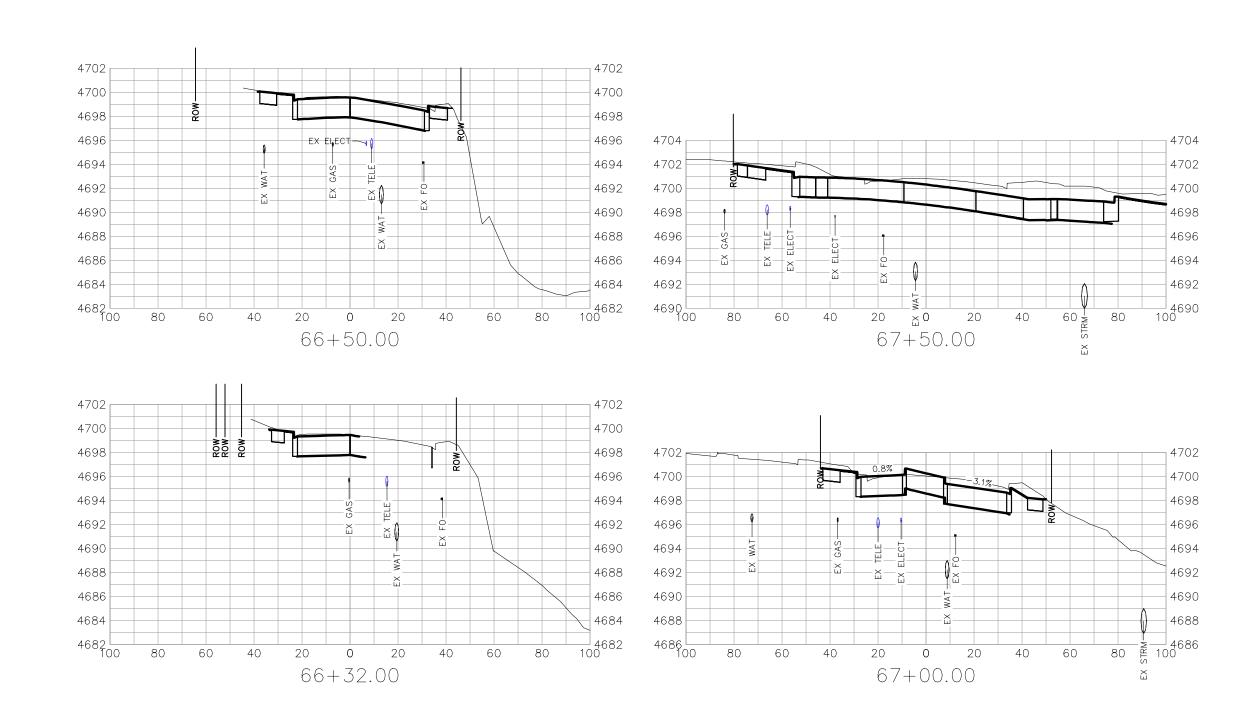


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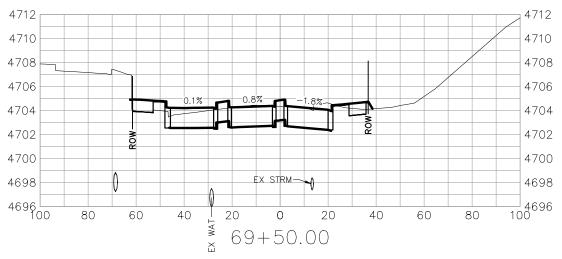
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File Name: CROSS SECTION.dwg Horiz. Scale: AS SHOWN Vert. Scale: NA	Date:	Comments	Init.	_ ∧ Tcbo	· ·	No Revisions:	1	ROSS SEC	IION - 4 TO 67+50		SHE M555-034
Unit Information: City of GJ Unit Leader Initials: LF				(c) (s)	606 South 9th Street Grand Junction, CO, 81501 Phone: 970-683-6351 FAX: 970-683-6369	Revised:	Designer:	JCS	Structure		23652
Grand Junction 333 WEST AVE, BLDG C Grand Junction, CO, 81501 Phone: 970–244–1554				Region 3	Phone: 9/0–683–6351 FAX: 9/0–683–6369		Detailer:	JCS CROSS SECTION	Numbers		Sheet Number 83



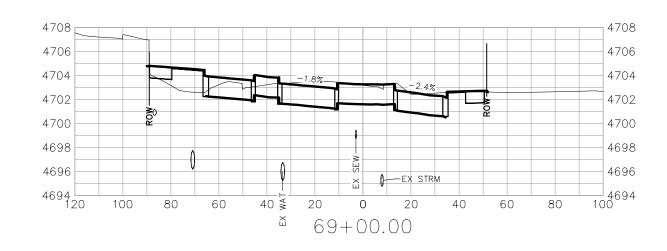

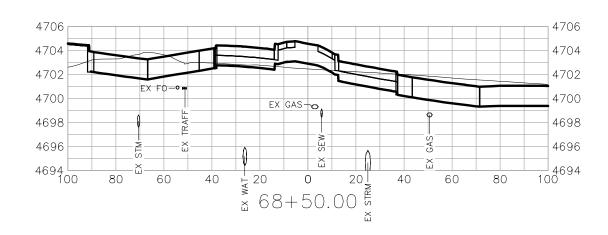'FOR INFORMATION ONLY' SEE STAKING PLAN FOR PROPOSED GRADES



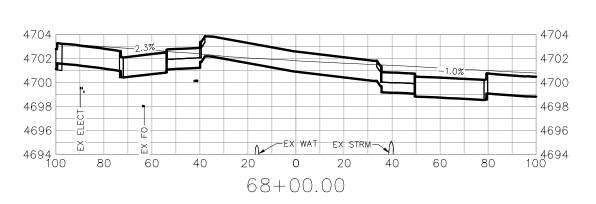


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Unit Information: City of GJ		
Grand Junction	333 WEST AVE, BLDG C Grand Junction, CO, 81501 Phone: 970–244–1554	


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Date:	Comments	Init.

Colorado Department of Transportation CO

7	606 South 9th Grand Junction, Phone: 970—683	CO, 81	970-683-63	369
			KC	

As Constructed	HORIZON DR AND G RD ROUNDABOUT - CROSS SECTION — 5 STA 68+00 TO 69+50			Project No./Code			
No Revisions:				SHE M555-034			
Revised:	Designer:	JCS	Structure		23652	23652	
	Detailer:	JCS	Numbers				
Void:	Sheet Subset:	CROSS SECTION	Subset Sh	neets:	X of X	Sheet Number	84

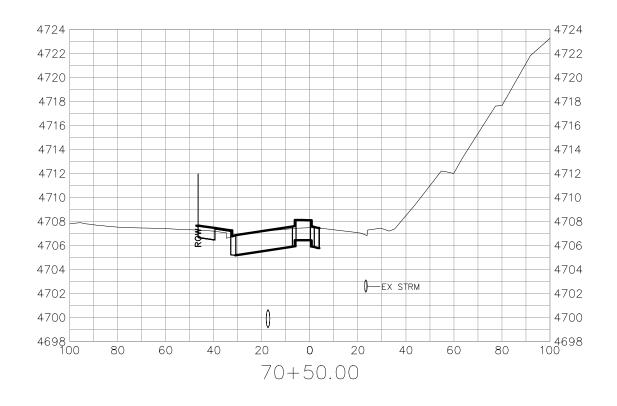

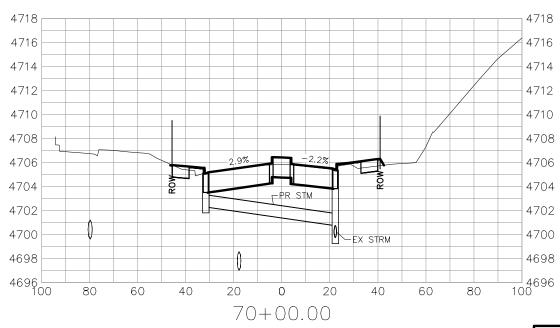

"FOR INFORMATION ONLY" SEE STAKING PLAN FOR PROPOSED GRADES

	Print Date: 6/18/2024 7:37:04 AM			Sheet Revisions			
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	Unit Information: City of GJ Unit Leader Initials:	LF					
	Grand Junction 333 WEST AVE, BLDG Grand Junction, CO. Debage 970-244-155	C 31501					
	COLORADO Phone: 970-244-155	1					

Colorado D	epartment	of I	ransport	atioi	n
COOL	606 South 9th Grand Junction	n Stree	et 81501	607	6

As Constructed	HORIZON DR AND (CROSS SEC	Project No./Code		
No Revisions:	STA 70+00	SHE M555-034		
Revised:	Designer: JCS	Structure	23652	
	Detailer: JCS	Numbers		
Void:	Sheet Subset: CROSS SECTION	Subset Sheets: X of X	Sheet Number 85	

SCHEDULE OF CONSTRUCTION TRAFFIC CONTROL SIGNS

		DIMENSION	PANEL SIZE		E	CDECIAL	AS
SIGN CODE	LEGEND	DIMENSION	Α	В	С	SPECIAL	CON
		WxH	EA	EA	EA	SF	
G20-5P	-5P WORK ZONE		8				
G20-10	XYZ/CONSTRUCTION/THANKS YOU/555-555-5555			4			
G20-11	ROAD WORK/MMM YY-MMM-YY/FOR INFORMATION	48 x 48		4			
M4-9a	PEDESTRIAN AND BICYCLE DETOUR W/ ARROW	30 x 24	6				
R2-1(30)	SPEED LIMIT (30)	36 x 48		4			
R2-1 (35)	SPEED LIMIT (35)	36 x 48		4			
R2-1 (40)	SPEED LIMIT (40)	36 x 48		3			
R2-1 (45)	SPEED LIMIT (45)	36 x 48		3			
R2-6p	FINES DOUBLE	36 x 24	10				
R9-8	PEDESTRIAN CROSSWALK	36 x 18	4				
R9-9	SIDEWALK CLOSED	24 x 12	4				
R9-11(L)	SIDEWALK CLOSED AHEAD CROSS HERE LEFT ARROW	24 x 18	4				
R9-11 (R)	SIDEWALK CLOSED AHEAD CROSS HERE RIGHT ARROW	24 x 18	4				
R11-2	ROAD CLOSED	48 x 30		12			
R52-6a	BEGIN/FINES/DOUBLE/IN WORK/ZONE	48 x 60			4		
R52-6b END/FINES/DOUBLE/IN WORK/ZONE		48 x 60			4		
W1-4(L) REVERSE CURVE (LEFT)		36 x 36	4				
W1-4(R) REVERSE CURVE (RIGHT)		36 x 36	4				
W1-6L			2				
W1-6R	LARGE ARROW RIGHT	48 x 24	2				
W3-4	BE PREPARED TO STOP	36 x 36	2				
W4-2L	LEFT LANE ENDS	36 x 36	4				
W4-2R	RIGHT LANE ENDS	36 x 36	4				
W8-1	ВИМР	36 x 36	6				
W8-11	UNEVEN LANES	36 x 36	2				
W8-17	SHOULDER DROP OFF (SYMBOL)	36 x 36	2				
W20-1 (AHEAD)	ROAD/WORK/AHEAD	36 x 36	20				
W20-4	ONE LANE ROAD AHEAD	36 x 36	2				
W20-7a	FLAGGER SYMBOL	36 x 36	8				
W21-5	SHOULDER WORK	36 x 36	4				
W21-5a	SHOULDER CLOSED	36 x 36	2				
W24-1L	DOUBLE REVERSE CURVE (LEFT)	36 x 36	4				
W24-1R	Extraction in Option 10 Security Securi		4				
SPECIAL	BUSINESS ACCESS W/ARROW	48 x 36	100			48	
SPECIAL	BUSINESSES OPEN CURING CONSTRUCTION	48 x 48				64	
CONTINGENCY	CONTINGENCY SIGN PANELS	VARY	10	10			
ROJECT TOTALS			126	44	8	112	

Ref. No.	Item	Quantity	Unit
321-00450	Detour Pavement	1700.00	SY
630-00000	Flagging	1400.00	HOUR
630-00007	Traffic Control Inspection	30.00	DAYS
630-00012	Traffic Control Management	80.00	DAYS
630-80336	Barricade (Type 3 M-B) (Temporary)	12.00	EA
630-80341	Construction Traffic Sign (Panel Size A)	126.00	EA
630-80342	Construction Traffic Sign (Panel Size B)	44.00	EA
630-80343	Construction Traffic Sign (Panel Size C)	8.00	EA
630-80344	Construction Sign Panel (Special)	112.00	SF
630-80355	Portable Message Sign Panel	4.00	EA
630-80357	Advance Warning Flashing or Sequencing Arrow Panel (B Type)	5.00	EA
630-80360	Drum Channelizing Device	140.00	EA
630-80364	Drum Channelizing Device (With Light) (Steady)	20.00	EA
630-80370	Barrier (Temporary)	200.00	LF
630-80380	Traffic Cone	20.00	EA
630-80390	Channelizing Device (Special)	90.00	EA
630-85010	Impact Attenuator (Temporary)	2.00	EA
630-86810	Traffic Signal (Temporary)	1.00	EA
632-00000	Night Work Lighting	1.00	LS

Print Date: 6/18/2024 7:	37: 05 AM					
File Name: TABULATION OF CONSTRUCTION TRAFFIC CONTROL DEVISES.dwg						
Horiz. Scale: AS SHOWN	Vert. Scale: NA	(
Unit Information: City of GJ		(
Grand Junction	333 WEST AVE, BLDG C Grand Junction, CO, 81501 Phone: 970–244–1554	(

	Sheet Revisions	
Date:	Comments	Init.

Colorado Department of Transportation
606 South 9th Street

7	606 South 9th Street Grand Junction, CO, 81501
	Phone: 970-683-6351 FAX: 970-683-6369
	KC

As Constructed	HORIZON DR AND TABULATION OF	Project No./Code		
No Revisions:	TRAFFIC CONTR	SHE M555-034		
Revised:	Designer: JCS	Structure	23652	
	Detailer: JCS	Numbers		
Void:	Sheet Subset: WOUND OF CONSTICION TO THE CONTROL DE	Subset Sheets: X of X	Sheet Number 86	