



A. IT IS THE RESPONSIBILITY OF THE CONTRACTOR TO VISIT THE SITE PRIOR TO BID TO VERIFY DIMENSIONS AND BECOME FAMILIAR WITH THE EXISTING CONDITIONS. NO EXTRAS WILL BE GIVEN FOR ADDITIONAL WORK WHICH IS REQUIRED RESULTING FROM CONTRACTOR'S

> B. COORDINATE EXACT LOCATIONS OF ALL OUTLETS WITH ARCHITECTURAL ELEVATIONS, REFLECTED CEILING PLANS (WHERE SHOWN), CASEWORK SHOP DRAWINGS, AND EQUIPMENT INSTALLATION DRAWINGS PRIOR TO BEGINNING ROUGH-IN.

C. PROVIDE A SET OF CONSTRUCTION DOCUMENTS TO THE OWNER AND SCHEDULE A MEETING WITH THE OWNER FOR VERIFICATION OF ALL ENGRAVED NAMEPLATES, ROOM

💄 E. COORDINATE ELECTRICAL DEVICE LOCATIONS WITH CHAIR RAILS, CORNER GUARDS, DOOR TRIMS, ETC. NOTIFY ARCHITECT OF CONFLICTING LOCATIONS.

F. THE SYSTEM BACKBOARD SHALL CONSIST OF 3/4 INCH FIRE-RETARDANT TREATED PLYWOOD INSTALLED FLOOR TO CEILING FOR THE LENGTH AS SHOWN ON THE DRAWING. ALL OUTLETS IN THE BACKBOARD SHALL BE FLUSH-MOUNTED, UON.

G. REFER TO ARCHITECTURAL FINISH SCHEDULE FOR ROOMS REQUIRING FACEPLATES AND OTHER FINISH ITEMS TO BE SPECIFIC COLORS.

ARCHITECTURE

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Project Numb	er:	2023.042
Issue:	CONFORMAN	NCE SET
Date:	11	/26/2024
Drawn By:		R.H.
Checked By:		R.H.
Revisions:		
Rev.	Description	Date:
1	ADDENDUM #1	2024.08.1

Sheet title: TECHNOLOGY LEGEND AND GENERA

SELECTION CONTROL OF THE PROPERTY OF THE PROPE	EXECUTION CONTROL CONT			SYSTEMS RESPONSIBILITIES (D = DESIGN TEAM, C = CONTRACTOR, OWN = OWNER OUTSIDE OF THE CONSTRUCTION SCOPE)				
BEST STORY OF THE PROPERTY OF	Part			DESIGN			FURNISH/INSTALL SYSTEM	DAD
Big	SECURIOR CONTROL CONTR	TELECOMMI	JNICATIONS CABLE INFRASTRUCTURE	D	D	C/OWN	C/OWN	RINI
A	Section Comment Comm	THIS INCLUE	DES, BUT NOT LIMITED TO, CONDUIT PATHWAY, 120 VOLT POWER, PLYWOOD BACKBOARDS, TELECOMMUNICATIONS					SEAG
MINISTRATION OF THE PROPERTY O	TO STATE OF THE ST	VENDOR'S F PROVIDE TH	REPRESENTATIVE AND INFORMING THEM OF SCHEDULE AND PROVIDING ACCESS TO THE SITE. THE OWNER/CITY SHALL HE CABLING, RACKS/CABLE TRAY, TERMINATING HARDWARE, TESTING AND FINAL TERMINATIONS OF THE					ARCHITE
A	The comment of the co	SITE RESPO	ONSIBILITIES ARE OUTLINED ON THE SITE PLAN.					brsarch
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A	Company Comp	POINTS, INT	ERCOM STATIONS REQUIRING AN ETHERNET PROTOCOL CONNECTION TO THE NETWORK SHALL BE BY THE					Tachr
THE PROPERTY OF THE PROPERTY O	Comparison Com	THE CONTR	ACTOR IS REQUIRED TO PROVIDE COORDINATION WITH THE OWNER'S VENDOR/CITY IN THE FORM OF CONTACTING					engineering/techn reesehackr
Home content in the second content and content in the content in t	Compared properties of the compared properties		TROL SYSTEM	D	D	С	С	
DO NOT THE STATE OF THE STATE O	Section Comparison Compar	LOCAL/WIDE TECHNOLOG PROVIDED L PROVIDED E	E AREA NETWORK. THE OWNER HAS AN EXCLUSIVE VENDOR FOR THIS SYSTEM (TOM LOGSDON, DMI GIES, PROJECT MANAGER COLORADO, 469-995-9244, TLOGSDON@DMITECHINC.COM). ALL WORK SHALL BE JNDER THE CONTRACTORS' SCOPE OF WORK. ALL UPGRADES TO THE HEAD END SERVER/APPLIANCE SHALL BE BY THE CONTRACTOR. THE CONTRACTOR SHALL PROVIDE ALL ELECTRIC LOCKING FOR A COMPLETE SYSTEM					
MANUAL CONTROL AND A PROSECULAR CONTROL OF THE RECOGNIC CONTROL OF THE PROSECULAR CONTROL OF THE	SOUTH CONTROL OF THE PROPERTY	THE CONTR. DRAWINGS. CEILING TO	ACTOR SHALL PROVIDE BATTERY-RUN ACCESS CONTROL DOOR HARDWARE AT EACH DOOR AS INDICATED ON THE THESE BATTERY-RUN DOORS SHALL BE INSTALLED IN AN 'ON-LINE' MODE WITH GATEWAYS MOUNTED IN THE ALLOW THEM TO COMMUNICATE WITH THE HEAD END SYSTEM. THE EXACT SYSTEM HAS YET TO BE DETERMINED,					
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ALL WORK SHALL BE PROVIDED UNDER THE CONTRACTOR SHALL PROVIDE ALL REQUIRED EQUIPMENT AND ACCESSORIES WIRELESS LOCAL AREA NETWORK WIRELESS LOCAL AREA NETWORK THE CONTRACTOR SHALL PROVIDE ALL WORK TO SUPPORT AN OWNERCITY PROVIDE MI-FE SYSTEM. THIS INCLUDES, BUT NOT LIMITED TO, CONDUIT PRHYMAY AND 150 VIOL TO FOWER (AS SHOWN) ON THE DRAWINGS). THE OWNERCITY PROVIDE MI-FE SYSTEM. THIS INCLUDES, BUT NOT LIMITED TO, CONDUIT PRHYMAY AND 150 VIOL TO FOWER SHALL PROVIDE THE ACCESS POINT HARDWARE AND PROGRAMMING. SEE DETAIL FOR MORE INFORMATION. THE CONTRACTOR SHALL PROVIDE ALL WORK TO SUPPORT AN OWNERCITY PROVIDED MI-FE SYSTEM. THIS INCLUDES, BUT NOT LIMITED TO, CONDUIT PRHYMAY AND 150 VIOL TO FOWER (AS SHOWN) ON THE DRAWINGS). THE OWNERCITY SHALL SE. DIESE DESCRIPTION OF THE CONTRACTOR SHALL PROVIDE THE ACCESS POINT HARDWARE AND PROGRAMMING. SEE DETAIL FOR MORE INFORMATION. RESPONSIBLE FOR CATEA WIRNIO TO FACH ACCESS POINT. THE OWNER SHALL PROVIDE THE ACCESS POINT HARDWARE AND PROGRAMMING. SEE DETAIL FOR MORE INFORMATION.	ALL WORK SHALL BE PROVIDED UNDER THE CONTRACTOR SCOPE. SEE THE SPECIFICATIONS FOR EQUIPMENT AND ACCESSORIES FOR COMPLETE AND OPERATIONAL SYSTEMS. WIRELESS LOCAL AREA NETWORK D D C OWN Project Number: Issue: THE CONTRACTOR SHALL PROVIDE ALL WORK TO SUPPORT AN OWNER/CITY PROVIDED WHIFI SYSTEM. THIS INCLUDES, BUT NOT LIMITED TO, CONDUIT PATHWAY AND 129 VOLT POWER (AS SHOWN ON THE DRAWINGS). THE OWNER/CITY SHALL BE RESPONSIBLE FOR CATAW WIRING TO EACH ACCESS POINT. THE OWNER SHALL PROVIDE THE ACCESS POINT HARDWARE AND PROGRAMMING. SEE DETAIL FOR MORE INFORMATOIN. ALL WORK SHALL BE PROVIDED UNDER THE CONTRACTOR SHALL PROVIDE ALL REQUIRED EQUIPMENT AND ACCESSORIES BY ONE OF THE CONTRACTOR SHALL PROVIDE ALL WORK TO SUPPORT AN OWNER/CITY SHALL BE RESPONSIBLE FOR CATAW WIRING TO EACH ACCESS POINT. THE OWNER SHALL PROVIDE THE ACCESS POINT HARDWARE AND PROGRAMMING. SEE DETAIL FOR MORE INFORMATOIN. Revisions: Rev.							
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WIRELESS LOCAL AREA NETWORK D C OWN Issue: Indicate the contractor shall provide all work to support an owner/city provided wi-Fi system. This includes, but not limited to, conduit parhway and 120 volt power (as shown on the drawings). The owner/city shall be responsible for carea wring to each access point. The owner shall provide the access point hardware and programming. See detail for more informatoin. Revisions: Rev. D	WIRELESS LOCAL AREA NETWORK D C C OWN Issue: Issue: Date: THE CONTRACTOR SHALL PROVIDE ALL WORK TO SUPPORT AN OWNER/CITY PROVIDED WI-FI SYSTEM. THIS INCLUDES, BUT NOT LIMITED TO, CONDUIT PATHWAY AND 120 VOLT POWER (AS SHOWN ON THE DRAWINGS). THE OWNER/CITY SHALL BE RESPONSIBLE FOR CATEA WIRING TO EACH ACCESS POINT. THE OWNER SHALL PROVIDE THE ACCESS POINT HARDWARE AND PROGRAMMING. SEE DETAIL FOR MORE INFORMATOIN. Rev. Rev.	DRAWINGS	FOR ROUGH-IN REQUIREMENTS. THE CONTRACTOR SHALL PROVIDE ALL REQUIRED EQUIPMENT AND ACCESSORIES					11/26 37 1
THE CONTRACTOR SHALL PROVIDE ALL WORK TO SUPPORT AN OWNER/CITY PROVIDED WI-FI SYSTEM. THIS INCLUDES, BUT NOT LIMITED TO, CONDUIT PATHWAY AND 120 VOLT POWER (AS SHOWN ON THE DRAWINGS). THE OWNER/CITY SHALL BE RESPONSIBLE FOR CAT6A WIRING TO EACH ACCESS POINT. THE OWNER SHALL PROVIDE THE ACCESS POINT HARDWARE AND PROGRAMMING. SEE DETAIL FOR MORE INFORMATOIN. Revisions: Rev. []	THE CONTRACTOR SHALL PROVIDE ALL WORK TO SUPPORT AN OWNER/CITY PROVIDED WI-FI SYSTEM. THIS INCLUDES, BUT NOT LIMITED TO, CONDUIT PATHWAY AND 120 VOLT POWER (AS SHOWN ON THE DRAWINGS). THE OWNER/CITY SHALL BE RESPONSIBLE FOR CATEA WIRING TO EACH ACCESS POINT. THE OWNER SHALL PROVIDE THE ACCESS POINT HARDWARE AND PROGRAMMING. SEE DETAIL FOR MORE INFORMATOIN. Revisions: Rev.	WIRELESS L	OCAL AREA NETWORK		D		OWN	
PROGRAMMING. SEE DETAIL FOR MORE INFORMATOIN. Revisions: Rev. D	PROGRAMMING. SEE DETAIL FOR MORE INFORMATOIN. Revisions: Rev.	LIMITED TO,	, CONDUIT PATHWAY AND 120 VOLT POWER (AS SHOWN ON THE DRAWINGS). THE OWNER/CITY SHALL BE					Date: Drawn By:
								Revisions:
								Rev. Desc
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GENERAL NOTES

(THIS SHEET ONLY)

ELECTRICAL DRAWINGS. . THIS PLAN DOES NOT INDICATE ALL OF THE UNDERGROUND UTILITY LINES. NO LOCATION BY EXCAVATION WAS PERFORMED FOR THIS PROJECT. UTILITIES SHOWN ARE BASED ON DRAWINGS RECEIVED FROM THE SITE/CIVIL ENGINEER. REFER TO THE CIVIL DRAWINGS FOR ADDITIONAL INFORMATION. CONTRACTOR TO FIELD VERIFY EXACT LOCATIONS OF ALL UNDERGROUND UTILITY LINES (NEW AND EXISTING) OF ALL TRADES PRIOR TO ANY

A. REFER TO T001/E001 FOR GENERAL NOTES THAT APPLY TO ALL TECHNOLOGY AND

- THE CONTRACTOR SHALL PROVIDE ALL CONDUIT, TRENCHING AND BACKFILLING. REFER TO CIVIL DRAWINGS FOR DRY UTILITY EASEMENT LOCATIONS.
- D. BURIAL DEPTH FOR CONDUITS SHALL BE PER THE BICSI OSP MANUAL AND TIA 569.

KEY NOTES

- ARCTIC CAMERA MOUNTED TO LIGHT POLE (CONFIRM EXACT HEIGHT WITH THE CITY). CAMERA AND MOUNT PROVIDED BY THE CITY, INSTALLATION BY THE CONTRACTOR. PROVIDE 12"X12"X6" WEATHERPROOF BOX WITH 120 VOLT GFCI RECEPTACLE, MEDIA CONVERTER AND 4-STRAND OS2 SINGLEMODE FIBER OPTIC CABLING BACK TO NEAREST TELECOM ROOM SHALL BE BY THE OWNER/CITY. PROVIDE ALL ACCESSORIES FOR A COMPLETE SYSTEM.
- ARCTIC CAMERA MOUNTED TO BUILDING (CONFIRM EXACT LOCATION WITH THE CITY). CAT6A CABLE RUN TO THE NEAREST TELECOM ROOM BY THE OWNER/CITY. PROVIDE JUNCTION BOX AND CONDUIT STUBBED IN THE ACCESSIBLE CEILING SPACE OF THE BUILDING. LABEL ALL CONDUITS. CAMERA AND MOUNT PROVIDED BY THE CITY, INSTALLATION BY THE CONTRACTOR.
- PROVIDE 2" UNDERGROUND PVC CONDUIT TO CREATE PATHWAY FOR CAMERA CABLING BACK TO THE TELECOM ROOMS IN THE BUILDING.
- STUB CONDUIT PER TIA 569 INTO THE IDF SPACE. LABEL ALL CONDUIT.
- STUB CONDUIT IN THE ACCESSIBLE CEILING SPACE INSIDE THE BUILDING. PREPARE TO RUN CAMERA CABLING TO THE MDF ROOM. LABEL ALL CONDUIT.
- 12X18 QUAZITE HANDHOLE. PROVIDE COVER MARKED 'COMMUNICATIONS'.
- CONNECTED BY (1) 2" PVC AND (1) 4" PVC CONDUIT FOR THE CITY'S FIBER OPTIC NETWORK. PROVIDE COVERS MARKED 'COMMUNICATIONS'. FIBER PROVIDED BY
- RATED QUAZITE HANDHOLES FOR FUTURE SERVICES. PROVIDE COVERS MARKED 'COMMUNICATIONS'.
- 9 NOT USED.
- SEE FLOOR PLANS FOR ACCESS CONTROLS TO PROVIDE AT THE EXTERIOR GATE. CONTINUED ON T102.
- PROVIDE A 30"X48" ANSI TIER 22 RATED QUAZITE HANDHOLE WITH (1) 2" PVC (CITY FIBER), (1) 4" PVC CONDUIT (CITY SPARE) AND (6) 4" PVC CONDUITS (FUTURE SERVICES) INTO THE MDF SPACE. LABEL ALL CONDUIT. PROVIDE COVER MARKED 'COMMUNICATIONS'. FIBER PROVIDED BY OWNER/CITY.



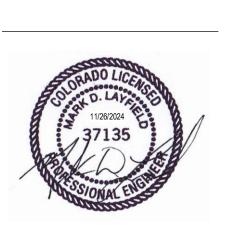
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PROVIDE A SYSTEM OF 24"X36" ANSI TIER 22 RATED QUAZITE HANDHOLES

- PROVIDE A SYSTEM OF(2) 4" PVC CONDUITS AND THE INDICATED 24"X36" ANSI TIER 22
- (10) STUB CONDUIT PER TIA-569 INTO THE MDF SPACE. LABEL ALL CONDUIT.



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SITE TECHOLOGY PLAN - NORTH



GENERAL NOTES

(THIS SHEET ONLY)

A. REFER TO T001/E001 FOR GENERAL NOTES THAT APPLY TO ALL TECHNOLOGY AND ELECTRICAL DRAWINGS. B. THIS PLAN DOES NOT INDICATE ALL OF THE UNDERGROUND UTILITY LINES. NO LOCATION BY EXCAVATION WAS PERFORMED FOR THIS PROJECT. UTILITIES SHOWN ARE BASED ON DRAWINGS RECEIVED FROM THE SITE/CIVIL ENGINEER. REFER TO THE CIVIL DRAWINGS

FOR ADDITIONAL INFORMATION. CONTRACTOR TO FIELD VERIFY EXACT LOCATIONS OF ALL UNDERGROUND UTILITY LINES (NEW AND EXISTING) OF ALL TRADES PRIOR TO ANY SITE WORK.

THE CONTRACTOR SHALL PROVIDE ALL CONDUIT, TRENCHING AND BACKFILLING. REFER TO CIVIL DRAWINGS FOR DRY UTILITY EASEMENT LOCATIONS. D. BURIAL DEPTH FOR CONDUITS SHALL BE PER THE BICSI OSP MANUAL AND TIA 569.

KEY NOTES

- EXISTING VAULT WHERE CITY WILL INTERCEPT FIBER OPTIC CABLING. PROVIDE (1) 2" CONDUIT INTO THE EXISTING VAULT. COORDINATE WITH THE OWNER/CITY. FIBER PROVIDED BY OWNER/CITY.
- PROVIDE A SYSTEM OF 24"X36" ANSI TIER 22 RATED QUAZITE HANDHOLES CONNECTED BY (1) 2" PVC AND (1) 4" PVC CONDUIT FOR THE CITY'S FIBER OPTIC NETWORK. PROVIDE COVERS MARKED 'COMMUNICATIONS'. FIBER PROVIDED BY OWNER/CITY.
- (3) CONTINUED ON T101.

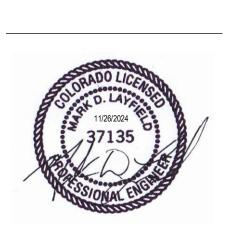
BARKER RINKER ARCHITECTURE

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JUNCTION,



Revisions:	Description	Date
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Date:	11/2	26/2024
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Project Number:	per: 2023.042	

SITE TECHOLOGY PLAN - SOUTH

SITE TECHNOLOGY PLAN - SOUTH ROAD

SCALE: 1" = 50'-0"

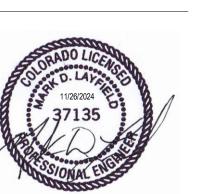
FIRST FLOOR TECHNOLOGY PLAN - AREA 'A'

SCALE: 1/8" = 1'-0"

BARKER RINKER

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FIRST FLOOR TECHNOLOGY PLAN - AREA

KEY NOTES

EXIT ONLY DOOR. NO ACCESS CONTROLS.

PROVIDE A PUSH BUTTON RELEASE FOR THE DOOR INTO CHILD WATCH BELOW THE DESK.

3 NEW TELECOM RACK (TYP. FOR 2) PROVIDED BY OWNER/CITY. ADD

3/4" PLYWOOD BACKBOARD FROM FLOOR TO 8'-0" AFF FOR THE EXTENT OF THE LINE. PAINT TO MATCH ADJACENT SURFACES.
 CABLE TRAY MOUNTED DIRECTLY ABOVE THE RACKS. SEE DIAGRAMS.

(6) TELECOM GROUNDING BUS BAR.

PROVIDE (4) 4" CONDUITS THROUGH WALL. STI #EZPATH.

SEE DETAIL ON T800 SERIES DRAWINGS FOR MORE INFORMATION ON WALL MOUNTED MONITORS/DIGITAL SIGNAGE BOARDS.

9 EXTERIOR MAINTENANCE GATE (SEE SITE PLAN FOR EXACT LOCATION). PROVIDE READER TO DISARM LOCAL SOUNDER SUCH THAT A VALID CARD READ WILL NOT ALARM DOOR. PROVIDE THE REQUIRED UNDERGROUND CONDUIT INFRASTRUCTURE TO THE IDF ROOM FOR SIGNAL CABLING.

10 SPEAKER MOUNTED TO STRUCTURE ABOVE.

PROVIDE DOOR CONTACT APPROPRIATE FOR OVERHEAD DOOR AND CONNECT TO THE ACCESS CONTROL SYSTEM. SCHLAGE #674-OH,OAE.

DOOR HARDWARE TO SECURE DOOR FROM PARTY ROOM SIDE TO PREVENT ENTRY INTO THE NATATORIUM.

SOURCE AND VOLUME CONTROL STATION FOR THE FACILITY-WIDE PAGING AND

BACKGROUND MUSIC (BGM) SYSTEM ZONE 5, 6. LABEL ACCORDINGLY.

NATATORIUM AV RACK. PROVIDE LEGRAND #PAC525 BOX TO ACCEPT AUDIO /VIDEO

CABLES/CONDUIT FROM VIDEO BOARD AND SPEAKERS IN NATATORIUM.
COORDINATE EXACT REQUIREMENTS WITH VIDEO BOARD SUPPLIER.

PROVIDE A CLEAR, FLIP-UP, LOCKABLE COVER OVER BLUETOOH PAIRING BUTTON.

ADD

GENERAL NOTES

(THIS SHEET ONLY)

A. REFER TO T001 FOR GENERAL NOTES THAT APPLY TO ALL TECHNOLOGY DRAWINGS.
 B. FOR ALL TELECOMMUNICATIONS DEVICES, PROVIDE A 1-GANG FACEPLATE IN COLOR PER THE ARCHITECT.

C. FOR ALL TELECOMMUNICATIONS DEVICES, LOCATE THE DEVICE NEXT TO THE NEAREST ELECTRICAL RECEPTACLE AND MATCH THE MOUNTING HEIGHT (SEE THE ELECTRICAL

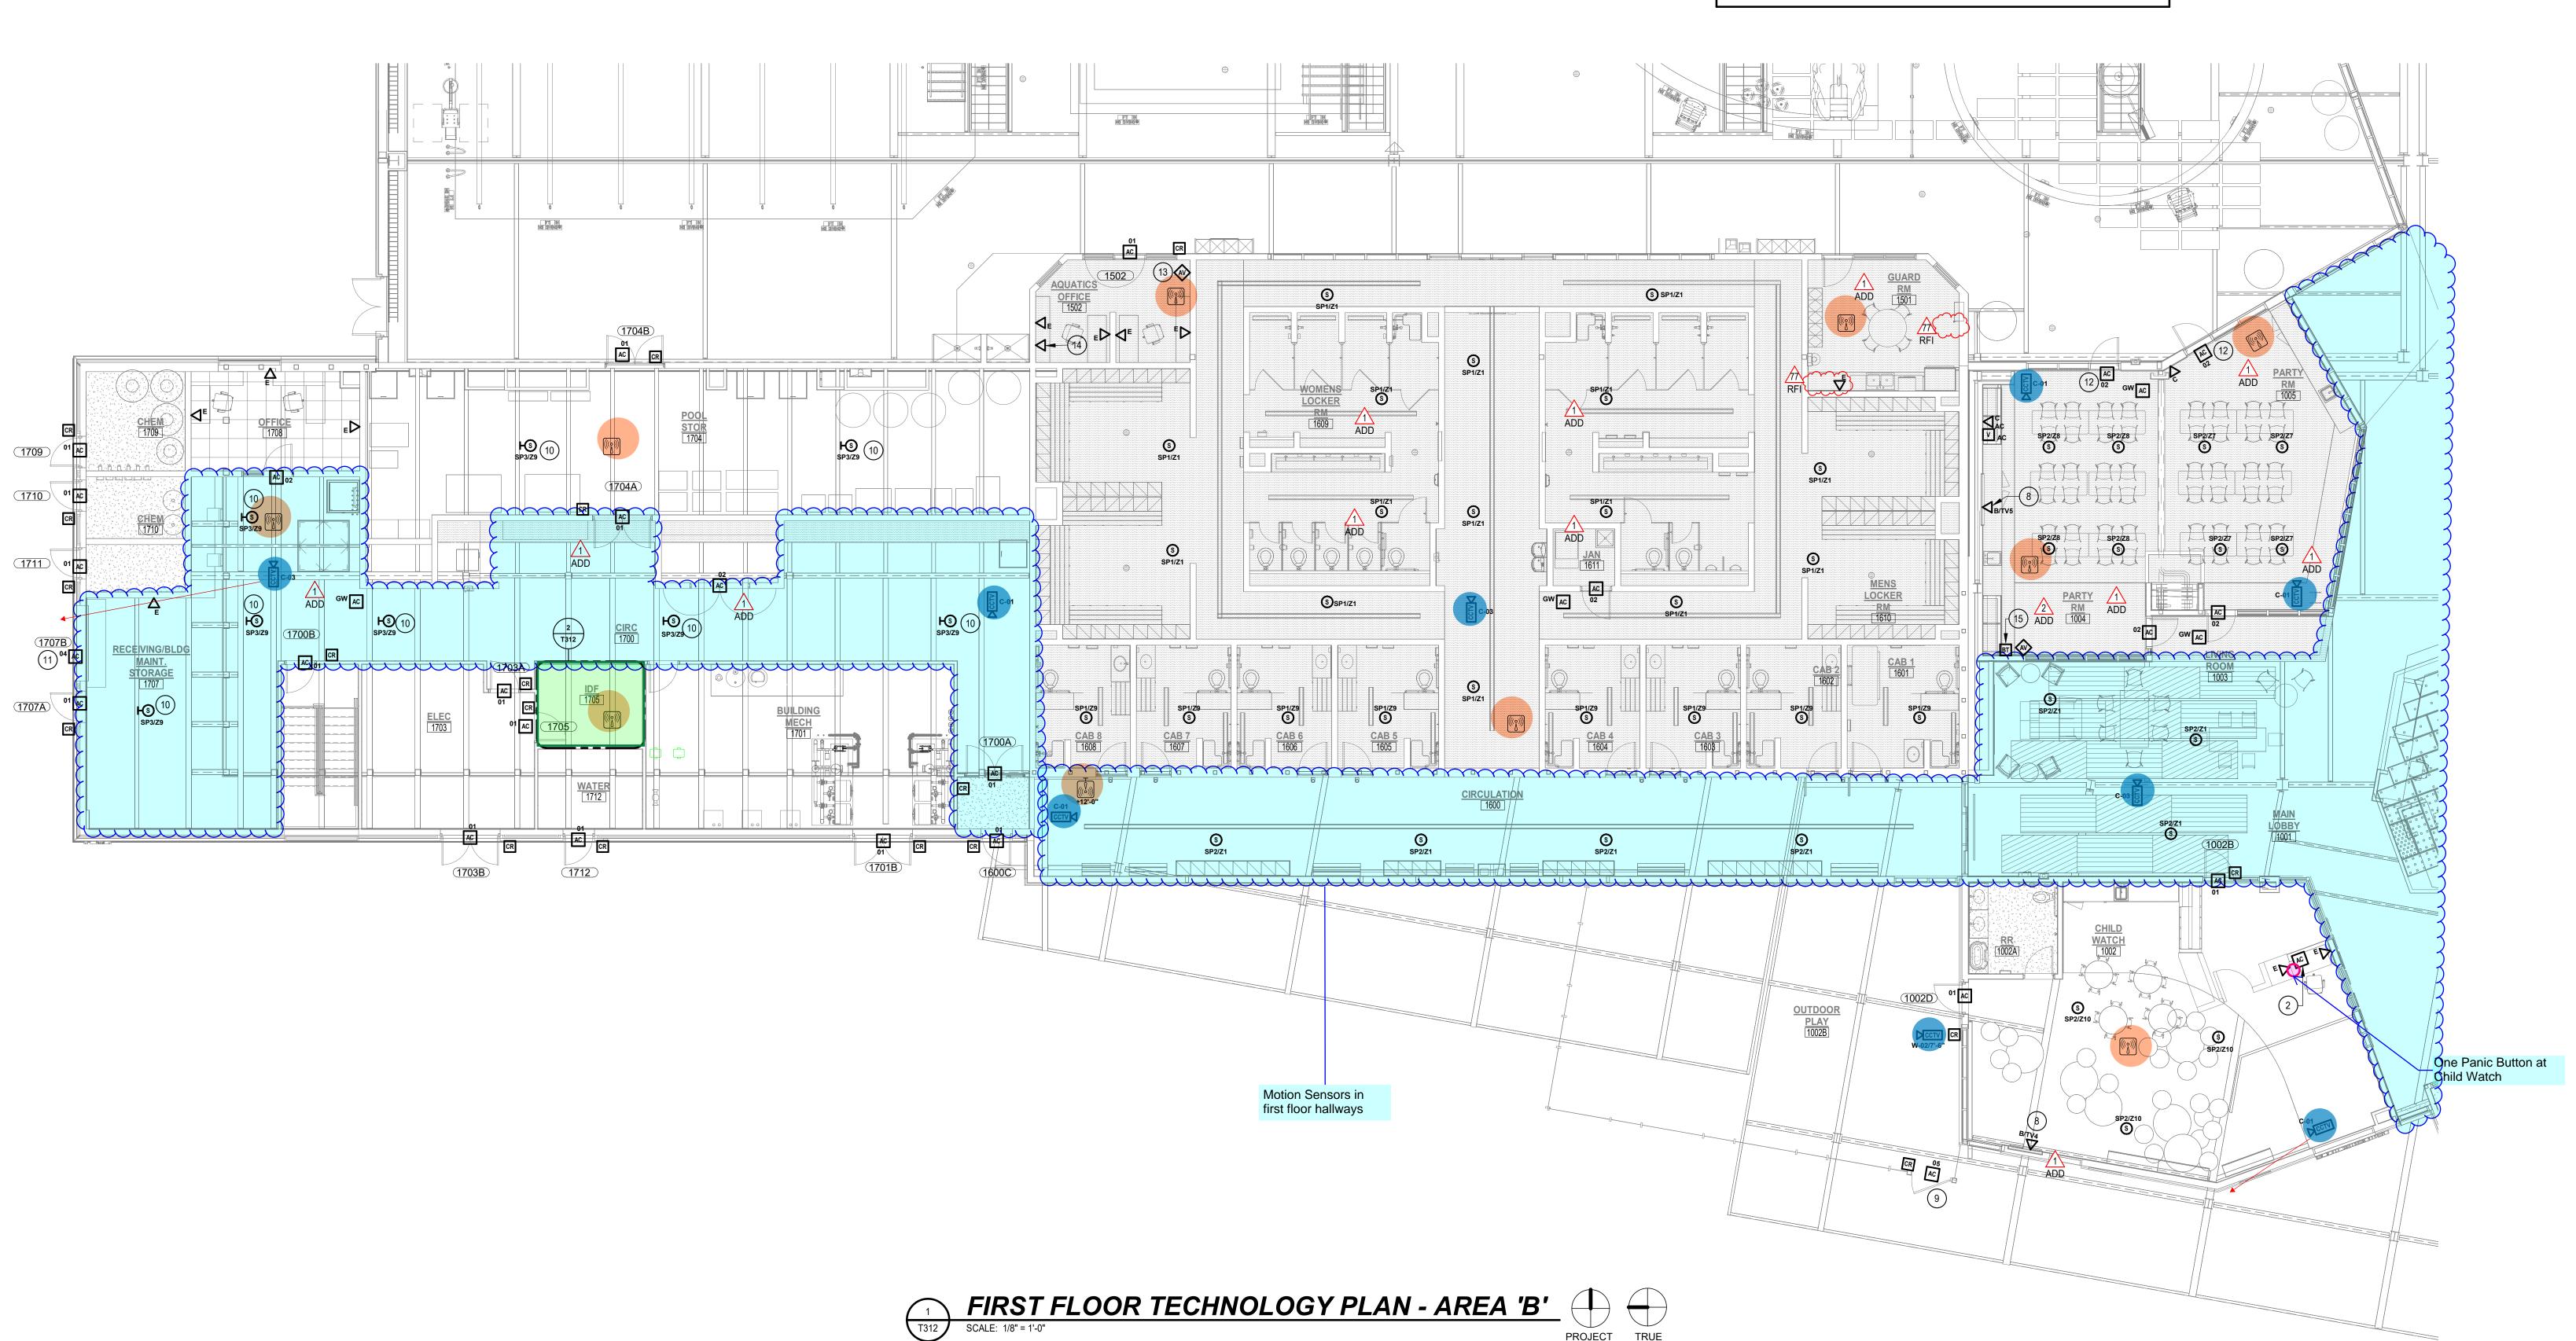
D. ALL NEW TELECOM WIRING SHOWN ON THIS PLAN SHALL BE HOMERUN TO IDF 1705.

BARKER RINKER SEACAT ARCHITECTURE

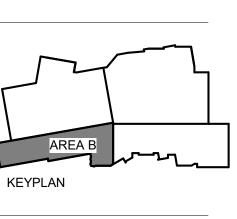
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GRAND JUNCTION RECREAT





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FIRST FLOOR TECHNOLOGY PLAN - AREA
'B'

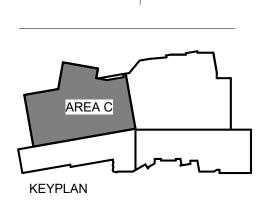
T312
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1 ADDENDUM #1 4 ADDENDUM #4

Sheet title:
FIRST FLOOR TECHNOLOGY PLAN - AREA

T313

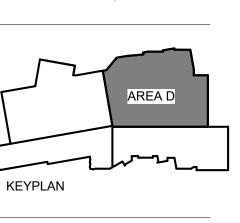


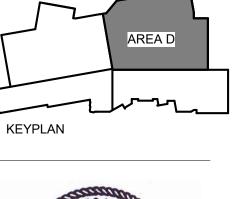
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MONITORS/DIGITAL SIGNAGE BOARDS. ALL ROUGH-IN AND AV COMPANENTS AND DEVICES 4 SHALL BE PROVIDED AS BASE BID. MONITOR SHALL BE PROVIDED UNDER ALTERNATE #40. $^\circ$





Project Number:	2023.042	
lssue:	CONFORMANCE SET	ı
Date:	11/26/2024	
Drawn By:	R.H.	
Checked By:	R.H.	
Revisions:		
Rev.	Description	Date:

ADDENDUM #2 ADDENDUM #4

FIRST FLOOR TECHNOLOGY PLAN - AREA

(THIS SHEET ONLY)

- A. REFER TO T001 FOR GENERAL NOTES THAT APPLY TO ALL TECHNOLOGY DRAWINGS. B. FOR ALL TELECOMMUNICATIONS DEVICES, PROVIDE A 1-GANG FACEPLATE IN COLOR PER THE ARCHITECT.
- C. FOR ALL TELECOMMUNICATIONS DEVICES, LOCATE THE DEVICE NEXT TO THE NEAREST ELECTRICAL RECEPTACLE AND MATCH THE MOUNTING HEIGHT (SEE THE ELECTRICAL
- D. ALL NEW TELECOM WIRING SHOWN ON THIS PLAN SHALL BE HOMERUN TO IDF 1705.

KEY NOTES

1 COORDINATE EXACT PLACEMENT OF SPEAKER WITH EQUIPMENT BEING INSTALLED. DO NOT PLACE SPEAKER BEHIND ANY EQUIPMENT THAT WOULD NOT ALLOW IT TO BE HEARD IN THE SPACE.

BARKER RINKER SEACAT

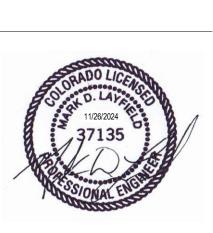
ARCHITECTURE

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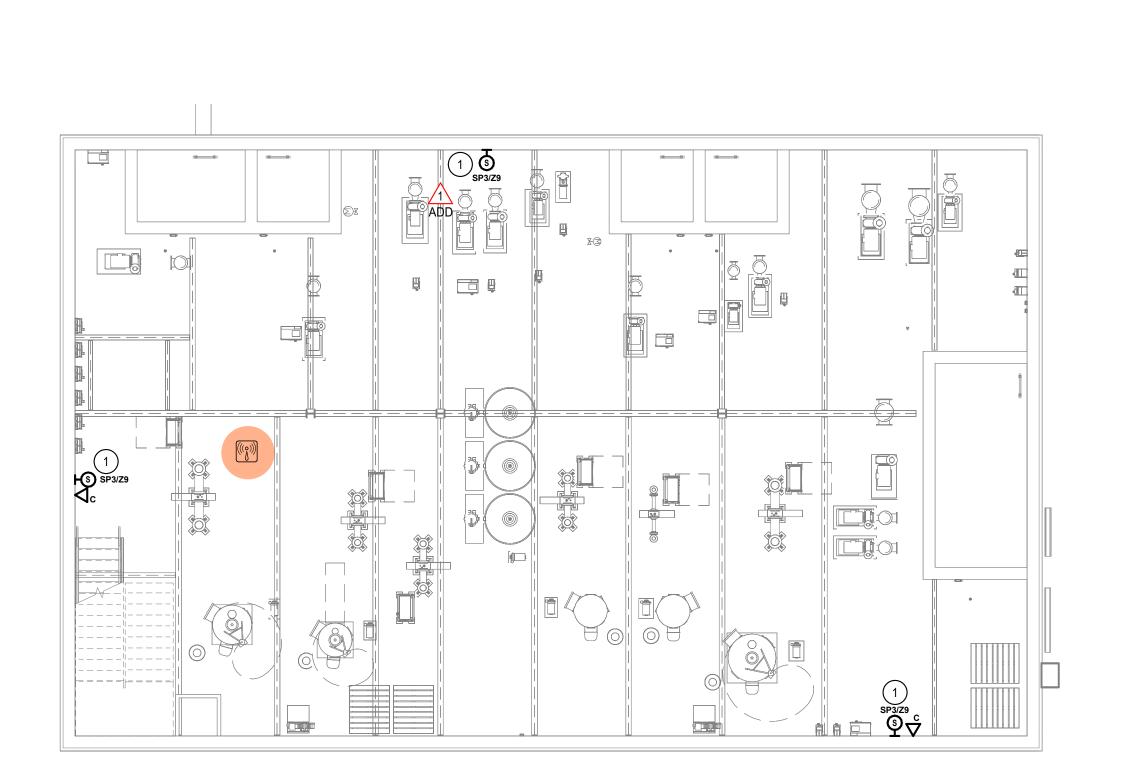
JUNCTION,

GRAND JUNCTION COMMUNITY RECREATION CENTER

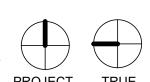


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Revisions:	
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POOL EQUIPMENT ROOM TECHNOLOGY PLAN - AREA 'B'







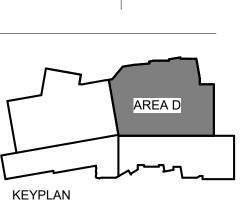


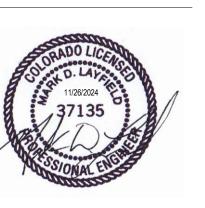


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Project Numbe	r:	2023.042
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Date:	1	1/26/2024
Drawn By:		R.H.
Checked By:		R.H.
Revisions:		
Rev.	Description	Date:
1	ADDENDUM #1	2024.08.
2	ADDENDUM #2	2024.08.2

MEZZANINE TECHNOLOGY PLAN - AREA