



#### **Purchasing Division**

## **ADDENDUM NO. 1**

**DATE:** August 16, 2016

FROM: City of Grand Junction Purchasing Division

TO: All Offerors

RE: B ½ Rd. Overpass at U.S. 50 Multimodal Conversion Project IFB-4199-16-DH

Offerors responding to the above referenced solicitation are hereby instructed that the requirements have been clarified, modified, superseded and supplemented as to this date as hereinafter described.

Please make note of the following clarifications:

- 1. The location for the mandatory Pre-Bid meeting will now take place in the City Hall Breakroom located on the first floor of City Hall just down the hall from the City Council Auditorium. Time and date remain unchanged.
- 2. The project electrical plans have been updated. Replace the electrical plans (sheets 82 94) with the attached updated electrical plans included with this addendum.

The original solicitation for the project noted above is amended as noted.

All other conditions of subject remain the same.

Respectfully,

Duane Hoff Jr., Senior Buyer City of Grand Junction, Colorado

#### STREET LIGHTING GENERAL NOTES:

- THIS PROJECT CONSISTS OF WORK TO INSTALL ALL WIRING, CONDUIT, PULL BOXES, AND POWER PANEL. REFERENCE SCHEDULE OF LIGHTING DEVICES
  AND SUMMARY OF QUANTITIES DRAWING LE2.
- 2. LIGHT STANDARD & LUMINAIRE (PEDESTRIAN), PAY ITEM 613-30005, SHALL INCLUDE THE FOLLOWING ITEMS FROM MH LIGHTING LOCATED AT 1044 SPEER BOULEVARD, DENVER, CO 80204-0222, 303.573.0222. THE ITEMS NUMBERS ARE AS FOLLOWS.
- TYPE SA IA-I527LED-R-SVI-4ARC35T2-MDL03-EZ/OAPT/450P4I4/BK
- 3. ALL PEDESTRIAN LIGHTING LUMINARIES INSTALLED ON THE PROJECT WILL BE CONTROLLED WITH A ELECTRICAL CONTRACTOR SUPPLIED PHOTO CELL TO BE LOCATED IN "PP I " NEW MILBANK POWER PEDESTAL #CP3B5 | I OA22SL | .
- 4. ELEVATIONS SHOWN IN THE SCHEDULE OF LIGHTING DEVICES ON THE PLANS SHEETS REPRESENT THE DESIGN FINISHED GRADE OR THE EXISTING GROUND FINISHED GRADE. THESE ELEVATIONS DO NOT INDICATE THE TOP ELEVATION OF THE LUMINAIRE (PEDESTRIAN) FOUNDATION. PEDESTRIAN LIGHTING FOUNDATIONS SHALL BE CONSTRUCTED PER THE MANUFACTURERS RECOMMENDATIONS.
- 5. PULL BOXES FOR LIGHT STANDARD (PEDESTRIAN) WILL BE TYPE | CDOT PULL BOXES | | "X | 8"X | 2".
- 6. PULL BOXES WILL BE INSTALLED IN GRADES WITHOUT CONCRETE WHERE POSSIBLE.
- 7. ALL ELECTRICAL CONDUIT SHALL BE SCHEDULE 80 PVC UNLESS NOTED OTHERWISE, TYPICAL.
- 8. UNLESS OTHERWISE NOTED, THE WORK DESCRIBED ON THE PLANS SHALL INCLUDE PROVIDING ALL LABOR AND MATERIALS NECESSARY FOR A COMPLETE AND OPERATIONAL ELECTRICAL SYSTEM. FURNISH ALL REQUIRED ITEMS WHETHER SUCH ARE SPECIFICALLY SHOWN OR NOT.
- 9. INFORMATION SHOWN ON DRAWINGS IS DIAGRAMMATIC ONLY AND SHALL NOT BE SCALED. OBTAIN VERIFY EXACT LOCATIONS, MEASUREMENTS, LEVELS, SPACE REQUIREMENTS, POTENTIAL CONFLICTS AMONG TRADES AND FOR ADJUSTING THE WORK REQUIRED BY THE ACTUAL CONDITIONS OF THE PROJECT. CONTRACTOR IS RESPONSIBLE FOR LOCATING ALL UNDER GROUND OBSTRUCTIONS AND MAKING ALLOWANCES FOR FIELD ADJUSTMENT OF LOCATION OF LUMINARIES TO AVOID SHUT DOWN OF ANY SERVICES OR SYSTEMS THAT ARE TO REMAIN.
- IO. BEFORE SUBMITTING THE BID ELECTRICAL CONTRACTOR SHALL VISIT AND EXAMINE THE PREMISES AND/OR JOB SITE SO AS TO ASCERTAIN THE EXISTING CONDITIONS IN WHICH THE CONTRACTOR WILL BE OBLIGED TO OPERATE IN PERFORMING HIS PART OF THE CONTRACT TO ANTICIPATE ANY POSSIBLE SPACE RESTRICTIONS OR CONSTRAINTS THAT COULD AFFECT THE TIMELY COMPLETION OF THE ELECTRICAL WORK IN ACCORDANCE WITH THE INTENT OF THE SPECIFICATIONS AND DRAWINGS. THE ELECTRICAL CONTRACTOR SHALL REPORT TO THE THE PROJECT ENGINEER OR GENERAL CONTRACTOR ANY CONDITIONS THAT MIGHT PREVENT THE SPECIFIED ELECTRICAL WORK FROM BEING PERFORMED IN THE MANNER INTENDED. NO CONSIDERATION OR ALLOWANCE WILL BE GRANTED TO THE ELECTRICAL CONTRACTOR FOR FAILURE TO VISIT THE PROJECT SITE, OR FOR ANY ALLEGED MISUNDERSTANDING OF THE MATERIALS TO BE FURNISHED OR WORK TO BE DONE.
- II. THE ELECTRICAL CONTRACTOR SHALL EXAMINE THE DRAWINGS OF ALL TRADES WHOSE WORK RELATES TO OR IS DEPENDENT ON ELECTRICAL WORK TO BECOME FULLY INFORMED OF THE EXTENT AND CHARACTER OF THEIR SPECIFIED WORK AND BE ABLE TO COORDINATE WITH OTHER TRADES WHILE AVOIDING POSSIBLE INTERFERENCE WITH THE ELECTRICAL WORK..

#### LIGHTING LEGEND


PPI-X ELECTRICAL CIRCUIT NUMBER (REFER TO PANEL SCHEDULES)

UB HEAVY DUTY, TRAFFIC RATED, FLUSH-TO-GRADE POLYMER CONCRETE SPLICE BOX WITH HEAVY DUTY, TRAFFIC RATED, BOLTED COVER. | | "X | 8"X | 2" TYPE | .

UNDER GROUND BURIED RACEWAY IN 2" PVC CONDUIT SCHEDULE 80(UNLESS NOTED OTHERWISE ON PLANS) IN 24" DEEP TRENCH, BURY AND COMPACTED BACKFILL TO PRE CONSTRUCTION CONDITION.

INSTALL SINGLE ARM PEDESTRIAN STANDARD.



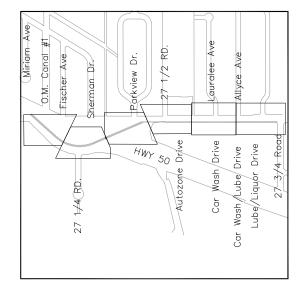

## LIGHTING PLAN KEY MAP

Print Date: 8-15-2016		Sheet Revisions		As C	As Constructed		Project No./Code		
File Name: Horiz. Scale: AS SHOWN Vert. Scale: NA	Date:	Comments	Init.	Grand	<b>Junction</b>	No Revisions:	LIGHTING GE	NERAL NOTES	TAP M555-032
Unit Information: City of GJ Unit Leader Initials: LC	5 🗀			Grand	COLORADO	Revised:	Designer: AJM	Structure	20736
PH: (970) 245-7292  CONSULTING EMAIL: JOELM@ACMENGRS.COM	3├—			"		A/. • 1	Detailer: AJM LIGHTING	Numbers  Subset Sheets: LE1 of 13	Sheet Number

	Sch	edule of Li	ghting Devi	ices			4-
	613-3	0005	613-4	10012	See i	note 2	
	LIGHT STAN	PEDESTRIAN)	LIGHT ST	ON SPECIAL		ED (66 WATT)	NOTES
	EACH(BY OTHERS)		EACH			CH	
	PLAN	AS CONST	PLAN	AS CONST	PLAN	AS CONST	
OFFSET	-						1.0
R=17.27	1		1		1		1,2
R=22.08	1		1		1		1,2
R=18.66	1		1		1		1,2
R=20.34	1		1		1		1,2
R=20.96	1		1		1		1,2
1 R=20.88	1		1		1		1,2
9 R=20.74	1		1		1		1,2
0 R=20.57	1		1		1		1,2
5 R=17.00	1		1		1		1,2
5 R=14.99	1		1		1		1,2
5 R=17.41	1		1		1		1,2
5 R=21.00	1		1		1		1,2
5 R=24.16	1		1		1		1,2
R=32.90	1		1		1		1,2
3 R=39.06	1	: :-	1		1		1,2
7 R=26.67	1		1		1		1,2
R=39.00	1		1		1		1,2
9 R=39.00	1		1		1		1,2
9 R=39.00	1		1		1		1,2
9 R=39.00	1		1		1		1,2
9 R=39.00	1		1		1		1,2
2 R=39.00	1		1		1		1,2
2 R=39.00	1		1		1		1,2
0 R=39.00	1		1		1		1,2
1 R=39.00	1		1		1		1,2
1 R=38.98	1		1		1		1,2
1 R=38.99	1		1		1		1,2
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	28		28		28		
1	R=38.99	R=38.99 1 R=39.00 1	R=38.99 1 R=39.00 1	R=38.99 1 1 1 1 1 1 1 1 1 1 1 1 1 1 1 1 1 1	R=38.99 1 1 1 1 1 1 1 1 1 1 1 1 1 1 1 1 1 1	R=38.99 1 1 1 1 1 1 1 1 1 1 1 1 1 1 1 1 1 1	R=38.99 1 1 1 1 1 1 R=39.00 1 1 1 1 1

#### SCHEDULE OF LIGHTING DEVICES NOTES:

- 1. FOUNDATION TOP HEIGHT EQUAL TO ADJACENT SIDEWALK
- 2. LUMINAIRE LED (66 WATT) IS TO BE INCLUDED IN THE COST OF PAY ITEM 613-30005 LIGHT STANDARD AND LUMINAIRE (PEDESTRIAN)
- 3. FOUNDATION TOP HEIGHT AS SHOWN IN DETAIL.

	Tabulation of Approximate Quantities(BASE PROJECT)											
Item No.	Ref. No.	Construction Note Description	Quantity	Unit	NOTES							
	613-01200	2 Inch Electrical Conduit (Plastic)	2807	LF								
	613-00207	2 Inch Electrical Conduit (RIGID STEEL CONDUIT)	236	LF	1							
	613-07001	Type One Pull Box	27	EA	3							
	613-07010	Pull Box (Surface Mounted)	1	EA	1,2							
	613-10000	Wiring	1	LS								
	613-30005	Light Standard and Luminaire (Pedestrian)	28	EA								
	613-40012	Light Standard Foundation (Special)	28	EA								
	613-50106	Lighting Control Center (Special)	1	EA								

SUMMARY NOTES:


1. INSTALLED UNDER BRIDGE DECK FOR CONNECTION TO BRIDGE MOUNTED LIGHT.


2. NEMA 3R


3. INCLUDE MINIMUM 6" OF PEA GRAVEL FOR DRAINAGE, REFERENCE DETAIL C3 DRAWING LE12





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File Name:	Date:	Comments	Init.	Crond	Lunction		'	AND TA			TAP M555-032
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Unit Information: City of GJ Unit Leader Initials: LC					COLORADO	Revised:	Designer:	AJM	Structure		20736
ACM CONSULTING AND ENGINEERING PH: (970) 245-7292							Detailer:	AJM	Numbers		
CONSULTING EMAIL: JOELM@ACMENGRS.COM						Void:	LIGHTING		Subset Sh	eets: LE2 of 13	Sheet Number

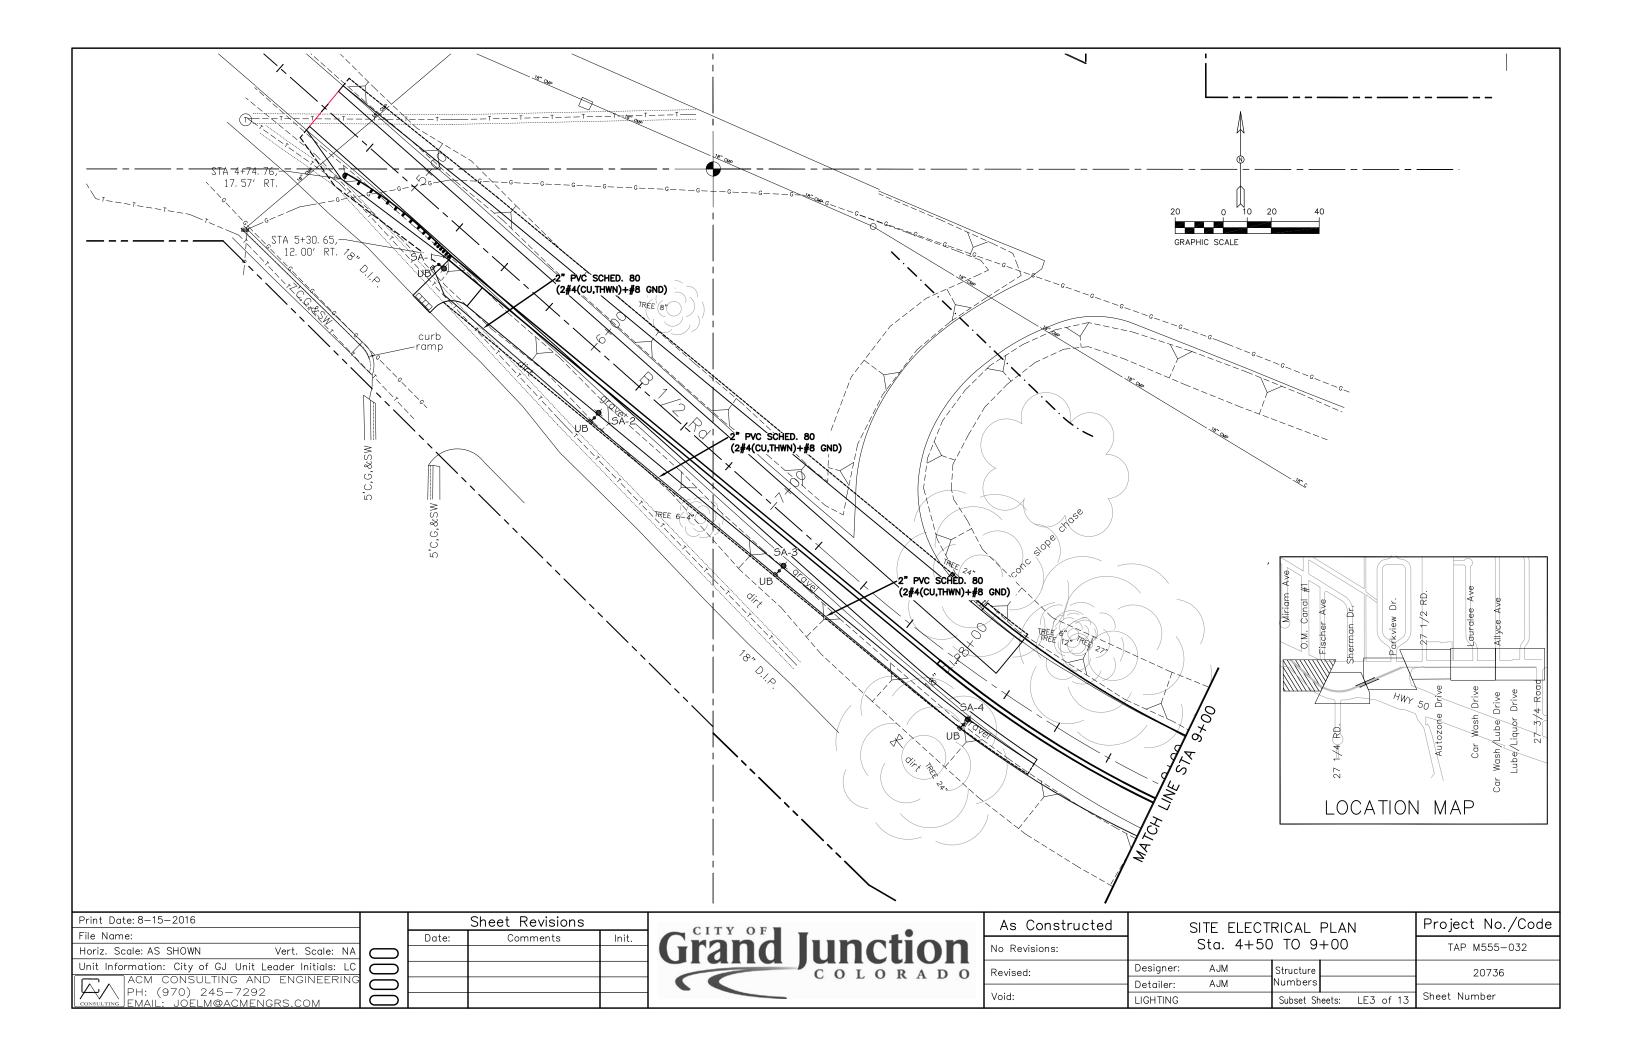


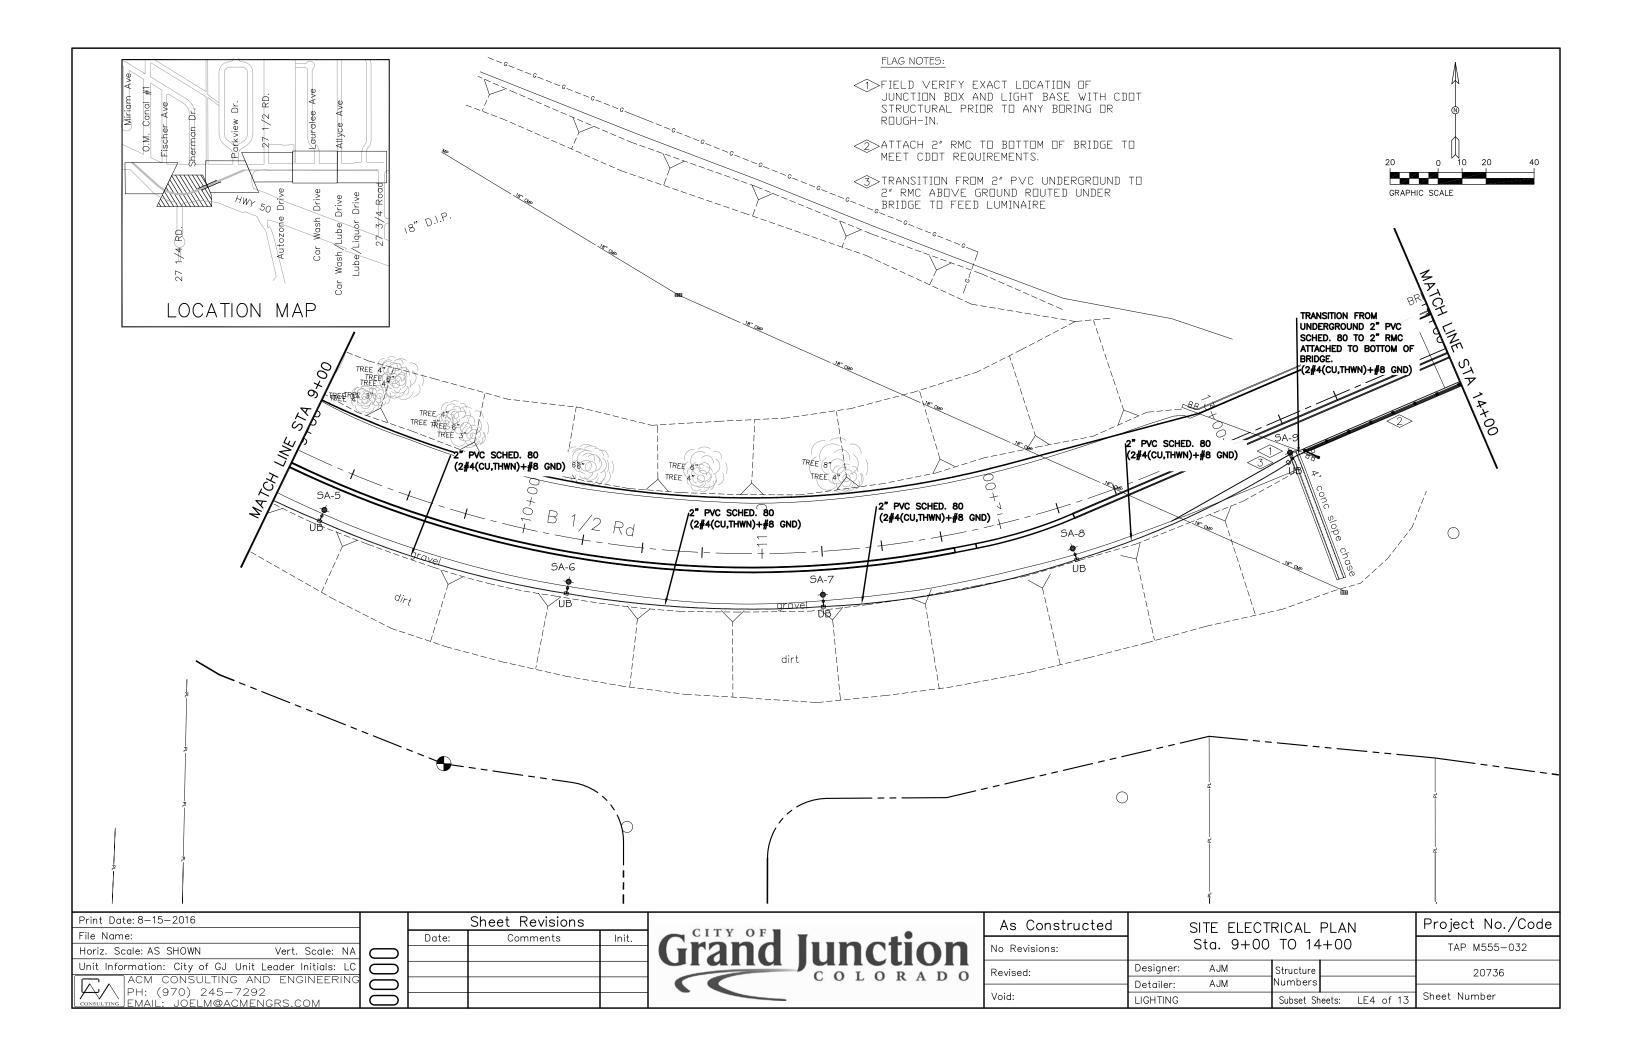


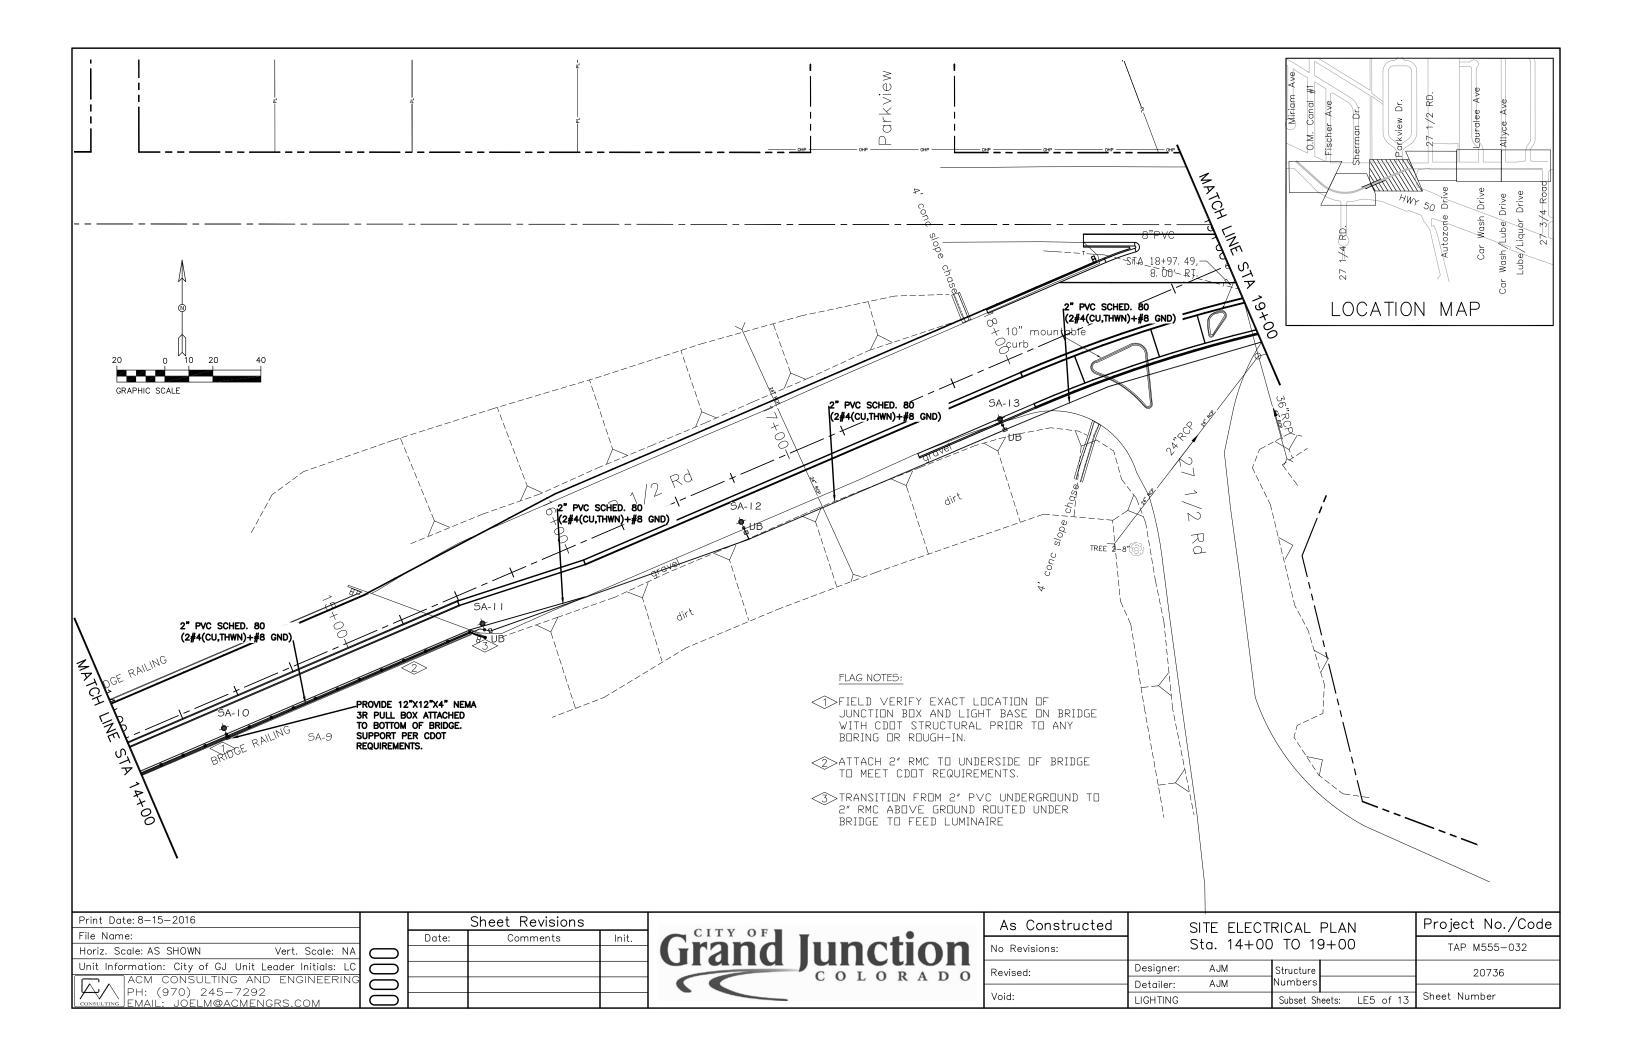

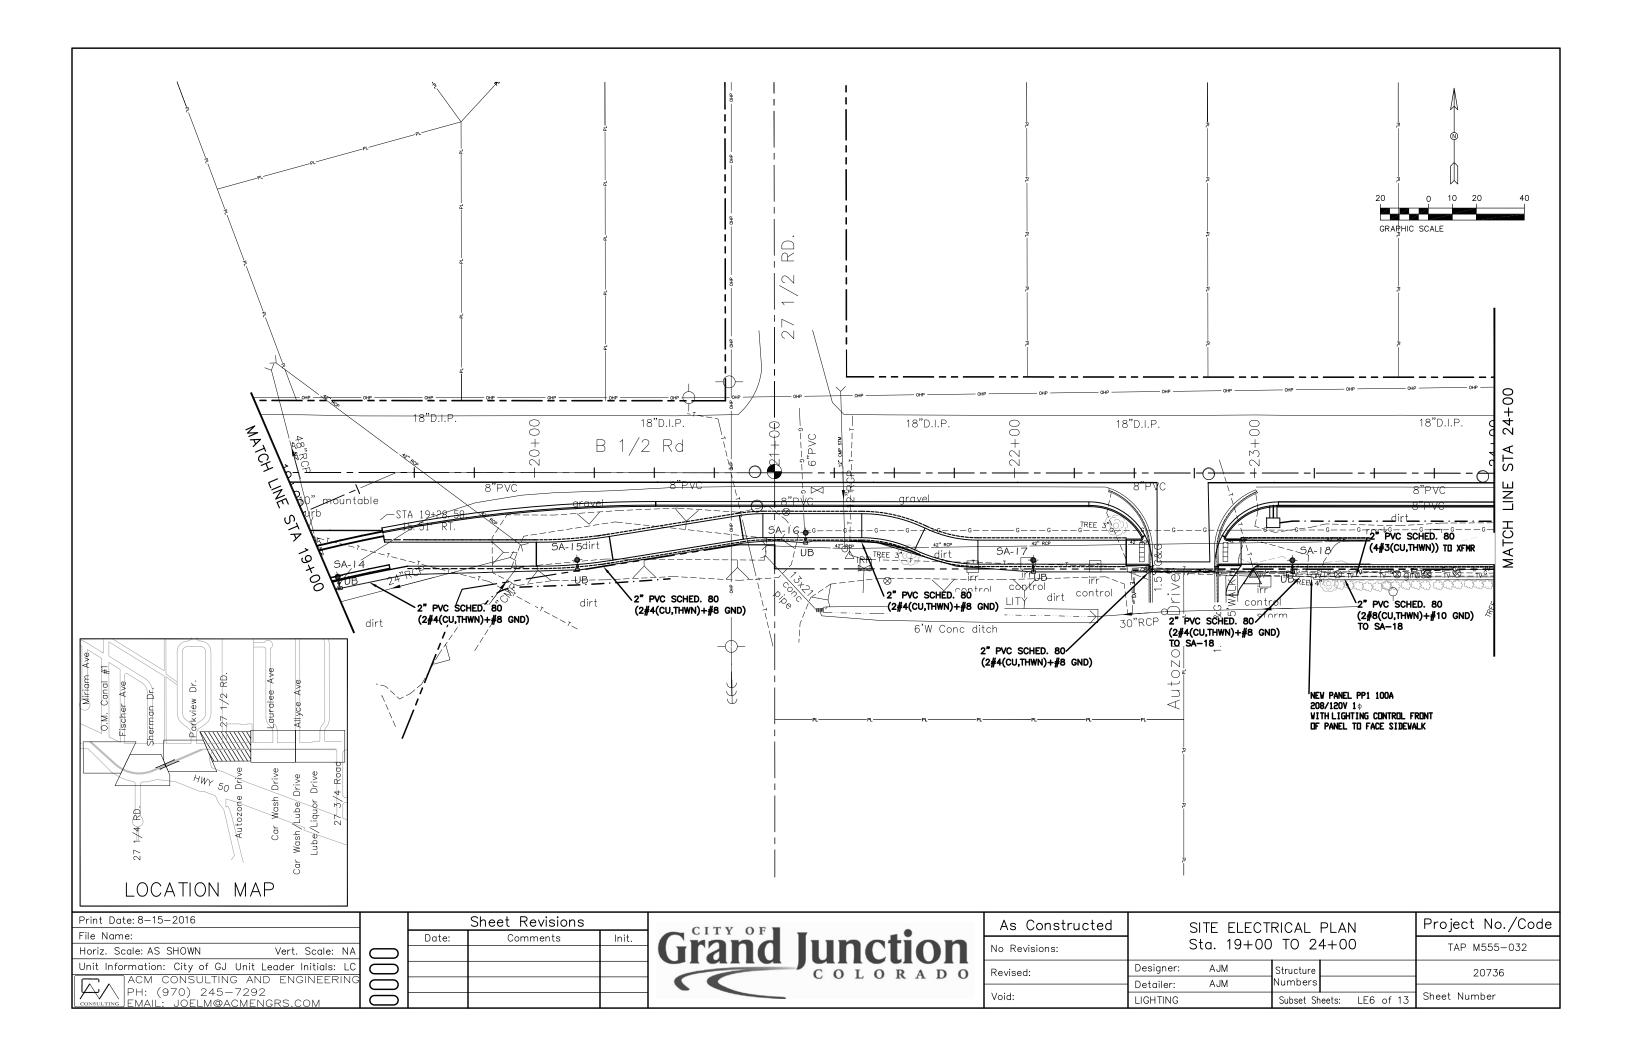

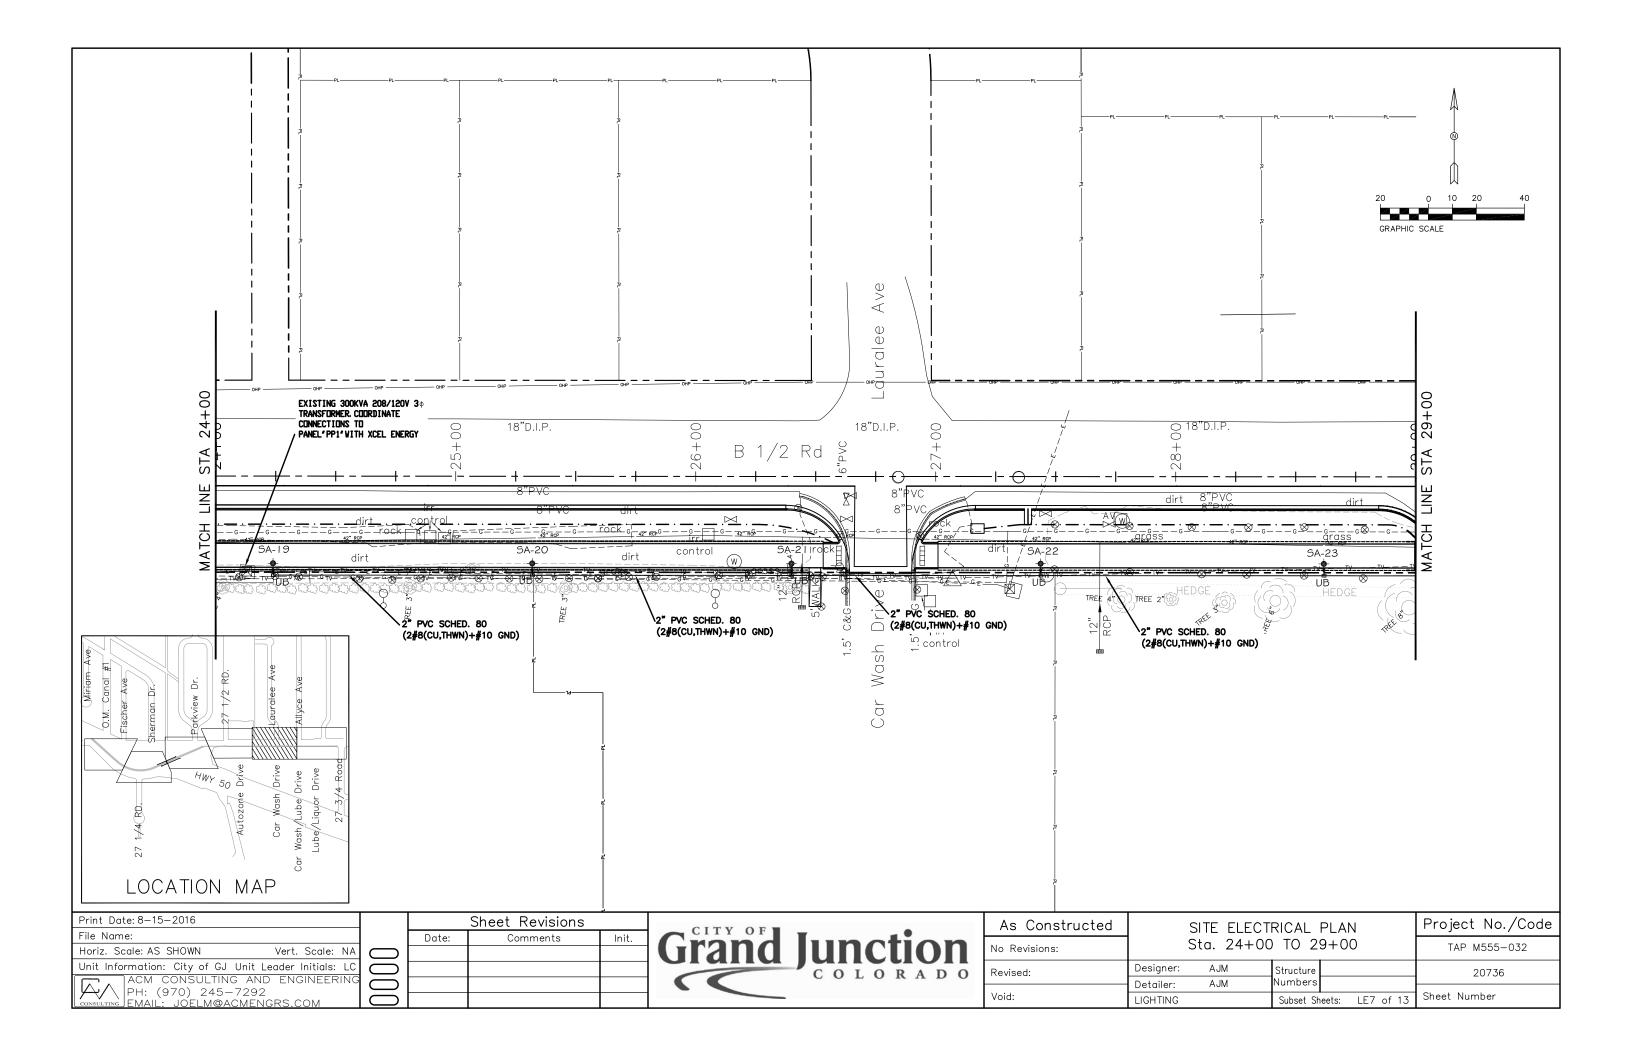

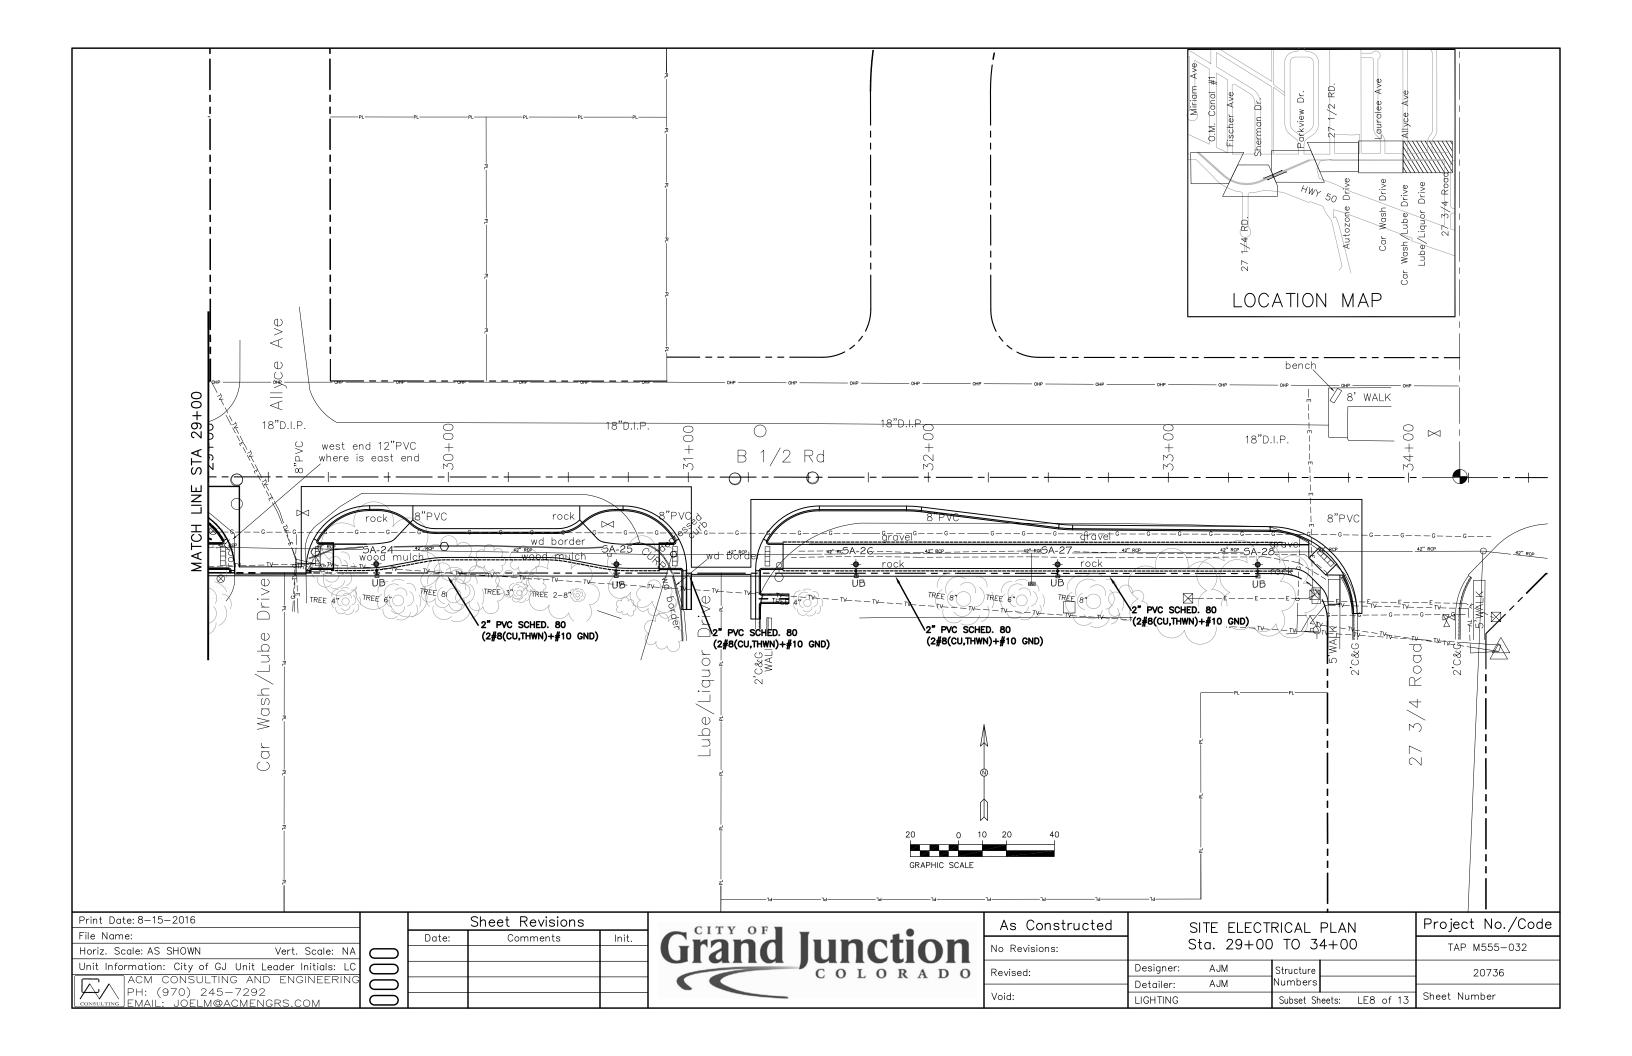

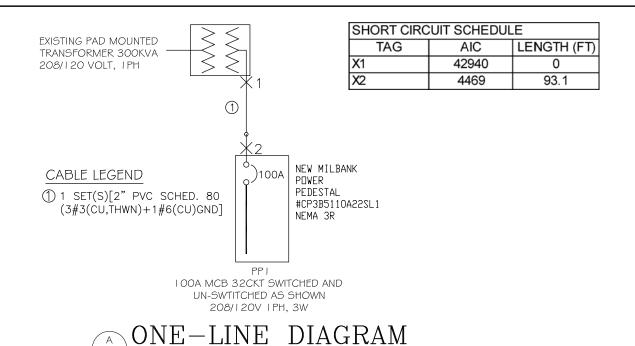


PANEL: LOCATIO FED FRO	BUS-PP1 IN: IM: BUS-XFMR	□C DEVICE DEVICE FAM		eaker lt On	M□U	LOSURE: NTING: TAGE:	NEMA 3R Surface 208/1		MAIN WIRI	NS(A): BI	ingle-Phase 3-Wire B	ONTINUOUS(A): SUS SC RATING(A) AULT CURRENT(A):	100 12000 4469
UN-SWI	TCHED CIRCUI	T DIRECTORY											
OC AMPS P	NOTES	DESCRIPTION	DEMAND CODE	VA		PHASE L A B	DADS VA	CKT	VA	DEMAND CODE	DESCRIPTION	NOTES	OC AMPS F
100 2		MAIN ,,	GENERAL		1 3 5 7 9 11 13	180 150	150	2 4 6 8 10 12 14 16			CONTROL POWER SWITCHED LC CONTROL		15 1 60 2
SWITCH	ED CIRCUIT D	IRECTORY								_			
20 2 ,,,		CBL-SW	NONE	-	17 19 21 23 25 27 29 31	924	924	18 20 22 24 26 28 30 32	660 -	NONE	CBL-NE		20 6
ALL CON TOTAL C	CONNECTED	KVA 3P AVE AMPS 2. 25 6. 2 2. 25 6. 2	Ж	* PHASE * A-N * B-N	TOTAL	120	VA 14. 4 -7. 9	AMPS 10. C 8. 7	)		TOTALS KVA ECTED 2, 25 ND 2, 25	•	,

#### GENERAL NOTES:

- I. IN AS MUCH AS DESIGN REQUIRES THAT CERTAIN ASSUMPTIONS BE MADE REGARDING EXISTING CONDITIONS, AND BECAUSE SOME OF THESE ASSUMPTIONS CANNOT BE VERIFIED. FIELD COORDINATION DURING CONSTRUCTION SERVICES IS IMPERATIVE. CONTRACTORS BIDDING THIS WORK MUST MAKE REASONABLE ALLOWANCES FOR UNFORESEEN CONTINGENCIES.
- 2. THE SERVING ELECTRICAL ASSOCIATION SHALL ADVISE THE OWNER/ENGINEER PRIOR TO SERVICE MODIFICATION REQUIRING COST TO THE OWNER.
- 3. REFERENCE CIVIL AND STRUCTURAL DRAWING PLANS FOR COORDINATION AND LOCATION OF ALL UNDER GROUND SYSTEMS.
- 4. ALL WORK SHALL BE COORDINATED WITH OTHER TRADES AS REQUIRED: REFERENCE CIVIL STRUCTURAL DRAWINGS.
- 5. ALL WIRING IS SHOWN DIAGRAMMATICALLY ON DRAWINGS, FIELD VERIFY ALL CONDITIONS PRIOR TO ROUGH-IN.
- 6. ALL ELECTRICAL WORK SHALL COMPLY WITH THE LATEST EDITION OF NATIONAL ELECTRICAL CODE AND ALL APPLICABLE LOCAL CODES.
- 7. ALL WIRE TO BE # I O UNLESS NOTED OTHERWISE.
- 8. CONDUCTOR COUNT IS SHOWN FOR REFERENCE ONLY. CONTRACTOR SHALL ENSURE THAT ANY AND ALL DEVICES AND EQUIPMENT ARE CIRCUITED PROPERLY. CONTRACTOR SHALL ENSURE THAT NO EQUIPMENT OR DEVICES ARE COMBINED OTHER THAN WHAT IS DEPICTED.
- 9. FIELD VERIFY ALL DIMENSIONS, DO NOT SCALE DRAWINGS.
- I O. COORDINATE INSTALLATION OF METER AND ELECTRICAL REQUIREMENTS WITH XCEL ENERGY.
- II. NEW PEDESTAL PPI MUST MEET ALL XCEL ENERGY REQUIREMENTS I.E. COLD SEQUENCE PADLOCK SLIP LATCH ON METER COVER, HOLD OPEN BAR ON METER HOOD.



Print Date: 8—15—2016			Sheet Revisions		CITY OF	_	As Constructed			Project No./Code
File Name:		Date:	Comments	Init.	CITY OF	Imation		ELECTRICAL DE	TAILS, ONE—LINE	
Horiz. Scale: AS SHOWN Vert. Scale: NA					Grand	lunction	No Revisions:			TAP M555-032
Unit Information: City of GJ Unit Leader Initials: LC	$\overline{}$					COLORADO		Designer: AJM	Structure	20736
ACM CONSULTING AND ENGINEERING						COLOKADO		Detailer.	Numbers	
PH: (970) 245-7292  CONSULTING EMAIL: JOELM@ACMENGRS.COM							Void:	LIGHTING	Subset Sheets: LE9 of 13	Sheet Number

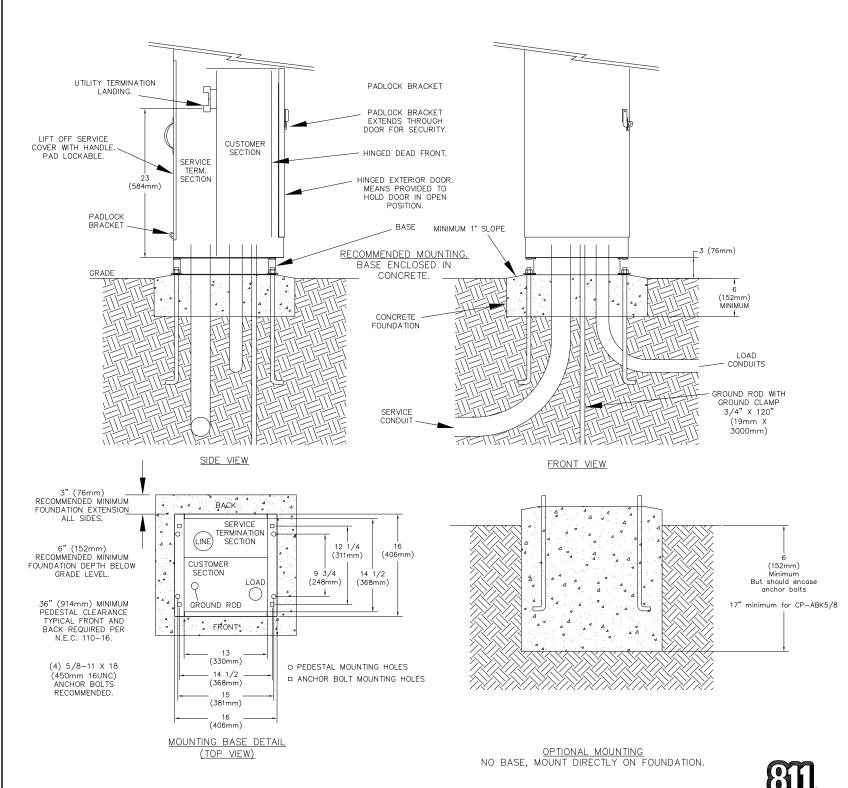


## TYPICAL POWER PEDESTAL/LIGHTING CONTROL CENTER (SPECIAL) PLAN NOT TO SCALE



#### NOTES

- 1. CONTROL CABINET SHALL BE U/L LISTED "INDUSTRIAL CONTROL PANEL" PER UL 508.
- 2. CONSTRUCTION SHALL BE NEMA 3R. 12 GA. A60 STEEL POWDER COATED MINT GREEN WITH PHOTO ELECTRIC CELL IN SERVICE CABINET. ELECTRICAL CONTRACTOR TO PROVIDE PHOTOCELL.
- 3. VOLTAGE RATINGS OF SERVICE EQUIPMENT SHALL CONFORM TO THE SERVICE VOLTAGES INDICATED ON THE PLANS.
- 4. SERVICE EQUIPMENT ENCLOSURE AND METERING EQUIPMENT SHALL MEET THE REQUIREMENTS OF THE SERVING UTILITY. WHEN THE SERVING UTILITY PROVIDES BOTH METERED AND UN-METERED CIRCUITS, A SEPARATE BUS SHALL BE PROVIDED FOR EACH CIRCUIT. THE METER AREA SHALL HAVE A SEALING, LOCKABLE, RAIN TIGHT COVER THAT CAN BE REMOVED WITHOUT THE USE OF TOOLS.
- 5. SERVICE EQUIPMENT SHALL BE FACTORY WIRED AND CONFORM TO NEMA STANDARDS.
- 6. THE EXTERIOR DOOR SHALL HAVE PROVISIONS FOR PADLOCKING. THE PADLOCK HOLE SHALL BE A MINIMUM DIAMETER OF 11mm.
- 7. ALL TERMINALS FOR INCOMING SERVICE CONDUCTORS SHALL BE COMPATIBLE WITH EITHER COPPER OR ALUMINUM CONDUCTORS SIZED TO SUIT THE CONDUCTORS SHOWN ON THE PLAN. TERMINAL LUGS SHALL BE COPPER OR TIN-PLATED ALUMINUM. SOLID NEUTRAL TERMINAL STRIP SHALL BE RATED 125A UNLESS OTHERWISE SPECIFIED AND FOR USE WITH COPPER OR ALUMINUM CONDUCTORS. THE TERMINAL SHOULD INCLUDE BUT NOT BE LIMITED TO:
- A) INCOMING TERMINALS (LANDING LUGS)
- B) NEUTRAL LUGS
- C) SOLID NEUTRAL TERMINAL STRIP.
- D) TERMINAL STRIPS FOR CONDUCTORS WITHIN THE ENCLOSURE.
- 8. AT LEAST 4 STANDARD SINGLE POLE 208V AND 1 SINGLE POLE 120 CIRCUIT BREAKER SPACES (20mm NOMINAL) SHALL BE PROVIDED FOR BRANCH CIRCUITS. CIRCUIT BREAKER INTERIORS SHALL BE COPPER. INTERIORS SHALL ACCEPT PLUG—IN OR CABLE—IN/ CABLE—OUT CIRCUIT BREAKERS.
- 9. PLUG-IN CIRCUIT BREAKERS MAY BE MOUNTED IN THE VERTICAL OR HORIZONTAL POSITION. CABLE-IN/CABLE-OUT CIRCUIT BREAKERS SHALL BE MOUNTED IN THE VERTICAL POSITION.
- 10. FASTENERS ON THE EXTERIOR OF THE ENCLOSURE SHALL BE VANDAL RESISTANT AND SHALL NOT BE REMOVABLE FROM THE EXTERIOR. ALL NUTS, BOLTS, SCREWS, WASHERS, AND HINGES SHALL BE STAINLESS STEFL.
- 11. PHENOLIC NAME PLATES SHALL BE PROVIDED AS REQUIRED.
- 12. A PLASTIC COVERED WIRING DIAGRAM SHALL BE ATTACHED TO THE INSIDE OF THE FRONT DOOR.
- 13. FOUNDATION SHALL EXTEND 50mm MINIMUM BEYOND EDGE OF ENCLOSURE.

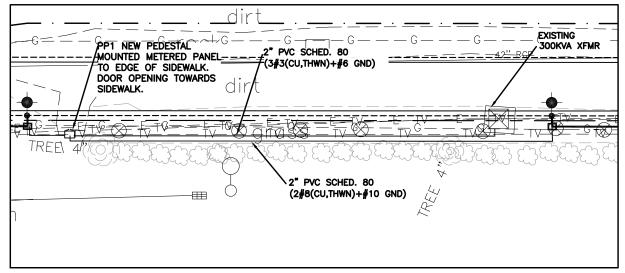


TYPICAL LIGHTING CONTROL CENTER AND POWER PEDESTAL(SPECIAL) LOCATION PLAN NOT TO SCALE

Print Date: 8-15-2016			Sheet Revisions	
File Name:		Date:	Comments	Init.
Horiz. Scale: AS SHOWN Vert. Scale: NA				
Unit Information: City of GJ Unit Leader Initials: LC				
ACM CONSULTING AND ENGINEERING PH: (970) 245-7292 EMAIL: JOELM@ACMENGRS.COM	00			




As Constructed	LIGHTING CO	ONTDOL	CENT	ED L	DETAIL C	Project No./Code
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### <u>NOTES</u>

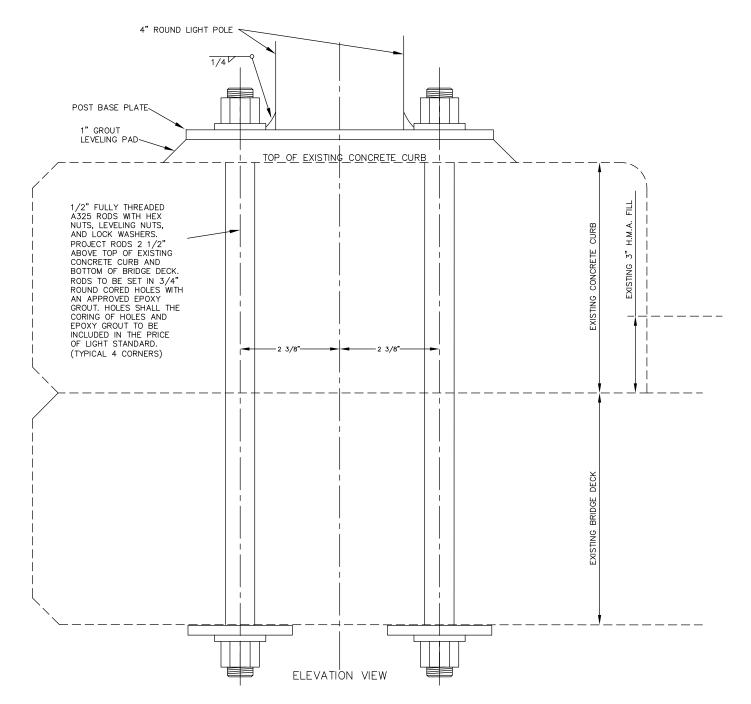
- COORDINATE INSTALLATION OF POLE AND LUMINAIRE WITH CDOT STRUCTURAL ENGINEER PRIOR TO BORING AND INSTALLATION OF LIGHT FOUNDATION AND 2" ELECTRICAL ACCESS.
- OBTAIN AND MATCH TEMPLATE OF POLE MOUNTING PATTERN FROM POLE PROVIDER PRIOR TO CASTING LIGHT FOUNDATION FOR POLE LOCATED ON OVERPASS.
- 3. POLE ON OVERPASS TO HAVE A TOTAL HEIGHT SUCH THAT BOTTOM OF LUMINAIRE IS 12' ABOVE PATH SURFACE ON OVER PASS.



C TYPICAL POLE BASE PLATE
2 NOT TO SCALE
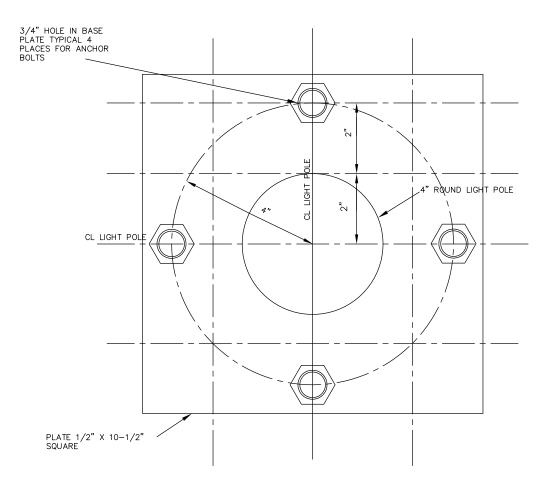
# TYPICAL LIGHT POLE CONNECTION TO EXISTING CONCRETE CURB & BRIDGE

Print Date: 8-15-2016			Sheet Revisions		CITY OF		As Constructed	LIGHT PC	LE BRIDGE	Project No./Code
File Name:		Date:	Comments	Init.	Grand	<b>Junction</b>	No Revisions:	4	ON DETAILS	TAP M555-032
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ACM CONSULTING AND ENGINEERING				1		COLORADO	Revised:	Designer: AJM  Detailer: AJM	Structure Numbers	20736
PH: (970) 245-7292 CONSULTING EMAIL: JOELM@ACMENGRS.COM	)()						Void:	2014	Subset Sheets: LE11 of 13	Sheet Number

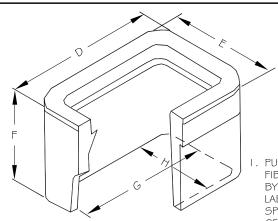

#### UTILITY BOX DIMENSIONS


A 18-1/8"
B 11-1/4"
C 1-1/4"
D 20-1/2"
E 13-3/8"
F 12"
G 15-3/4"
H 8-7/8"

1. PULL BOXES, PULL BOX COVERS AND EXTENSIONS SHALL BE MADE OF FIBERGLASS REINFORCED POLYMER CONCRETE. PULL BOXES SHALL BE VERIFIED BY A A 3RD PARTY NATIONALLY RECOGNIZED INDEPENDENT TESTING LABORATORY AS MEETING ALL TEST PROVISIONS OF THE LATEST ANSI/SCTE 77 SPECIFICATION FOR UNDERGROUND ENCLOSURE INTEGRITY, TIER 22 RATING. CERTIFICATION DOCUMENTS SHALL BE SUBMITTED WITH MATERIALS SUBMITTALS. THE PULL BOX SHALL HAVE A DETACHABLE COVER WITH A SKID RESISTANT SURFACE AND HAVE THE WORDS ELECTRICAL CAST INTO THE SURFACE. PAINTING THE WORDS SHALL NOT BE ACCEPTED. MARKINGS SHOWING THE TIER 22 RATING MUST BE LABELED OR STENCILED ON THE INSIDE AND OUTSIDE OF THE BOX AND THE ON THE UNDER SIDE OF THE COVER. THE COVER SHALL BE ATTACHED TO THE PULL BOX BODY BY MEANS OF A MINIMUM 3/8 - 7 UNIFIED NATIONAL COURSE (UNC) STAINLESS STEEL PENTA HEAD BOLTS AND SHALL HAVE TWO LIFT SLOTS TO AID IN THE REMOVAL OF THE LID.

2. PULL SLOTS SHALL BE RATED FOR A MINIMUM PULL OUT OF 3,000 POUNDS. MAGNESIUM CHLORIDE TESTS SHOULD BE PERFORMED IN ACCORDANCE WITH THE LATEST ANSI/SCTE 77 SPECIFICATION FOR UNDERGROUND ENCLOSURE INTEGRITY, TIER 22 RATING.


3. PROVIDE AT LEAST 6 INCHES OF PEA GRAVEL MEASURED FROM BOTTOM OF PULL BOX FOR DRAINAGE. PEA GRAVEL IS INCLUDED IN PULL BOX PAY ITEM.

## C UTILITY BOX DETAIL

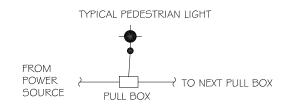

I. EACH LIGHT LOCATION TO HAVE PULL BOX



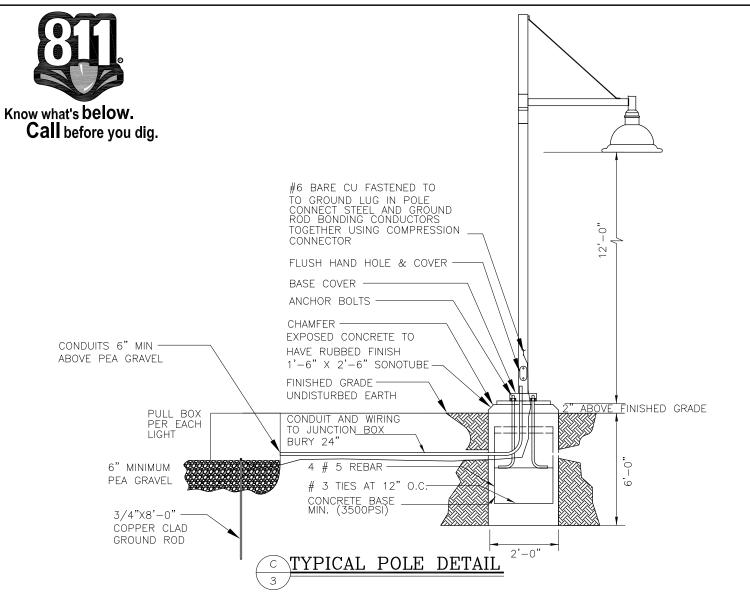


#### POLE DETAIL NOTES:

- 1. ORDER STEINBERG URBAN LINE 4" ROUND STRAIGHT STEEL POLES, #450P414/BK. OBTAIN POLE MOUNTING TEMPLATE PATTERN FROM MANUFACTURER PRIOR TO ROUGH-IN.
- 2. PROVIDE EACH PEDESTRIAN LIGHT INSTALLED IN THIS CONTRACT WITH J-BOX.
- 3. MOUNT ALL LIGHTS PERPENDICULAR TO PATHWAY TO MAXIMIZE LIGHT ON PATHWAY.
- 4. GROUND ROD TO BE LOCATED IN PULLBOX TOP OF GROUND ROD TO BE SO THAT TOP IS EVEN WITH PEA GRAVEL.
- 5. AT EACH POLE BASE HAND HOLE, PROVIDE A BREAKAWAY, WATERPROOF, IN-LINE FUSE HOLDER WITH FNQ-R 2A FUSE FOR HOT CONDUCTORS. BUSSMAN #HEY-AW-DRLC-J OR APPROVED EQUAL. COORDINATE ORDER WITH WIRE SIZES SHOWN ON DRAWING.
- 6. LIGHT STANDARD FOUNDATION EMBEDMENT DEPTH, DIMENSIONS AND REINFORCEMENT PER CDOT M-6 | 3- | STANDARD DETAIL.
- 7. DIMENSION FOR ANCHOR BOLT SPACING BY POLE MANUFACTURER.

	79	22	LUMINAIRE	SCHEDULE PED	DESTRIAN
TYPE	MANUFACTURER	APPROVAL	VOLTAGE	BALLAST	
	MODEL NUMBER		MOUNTING	LAMPE TYPE	DESCRIPTION
	TOTAL SECTION OF THE		# OF LAMPS	LAMP CAT. #	
	STERNBERG LIGHTING		208	ELECTRONIC	PEDESTRIAN LUMINAIRE, ARM MOUNTED, LED, CUTOFF, ORDER POLE SO
102500	1A-1527LED-R-SV1-4ARC35T2-	OWNER	POLE	LED	THAT LAMP HEIGHT IS 12' AFG MEASURED AT BOTTOM OF LUMINAIRE. ORDER
SA	MDL03-EZ/OAPT/450P414/BK				WITH OAPT ARM. POLE AND ARM COLOR TO MATCH . ORDER WITH 4" ROUND STRAIGHT ALUMINUM POLES.
		REQUESTED	1	66 W	STRAIGHT ALUMINUM FOLES.

Print Date: 8-15-2016			Sheet Revisions		CITY OF	_	As Constructed			Project No./Code
File Name:  Horiz. Scale: AS SHOWN  Vert. Scale: NA		Date:	Comments	Init.	Grand	Junction	No Revisions:	LIGHTING DETA	ILS, SCHEDULES	TAP M555-032
Unit Information: City of GJ Unit Leader Initials: LC					Grana	COLORADO		Designer: AJM	Structure Numbers	20736
PH: (970) 245-7292  CONSULTING EMAIL: JOELM@ACMENGRS.COM	)()						Void:	Detailer: AJM LIGHTING	Subset Sheets: LE12 of 13	Sheet Number

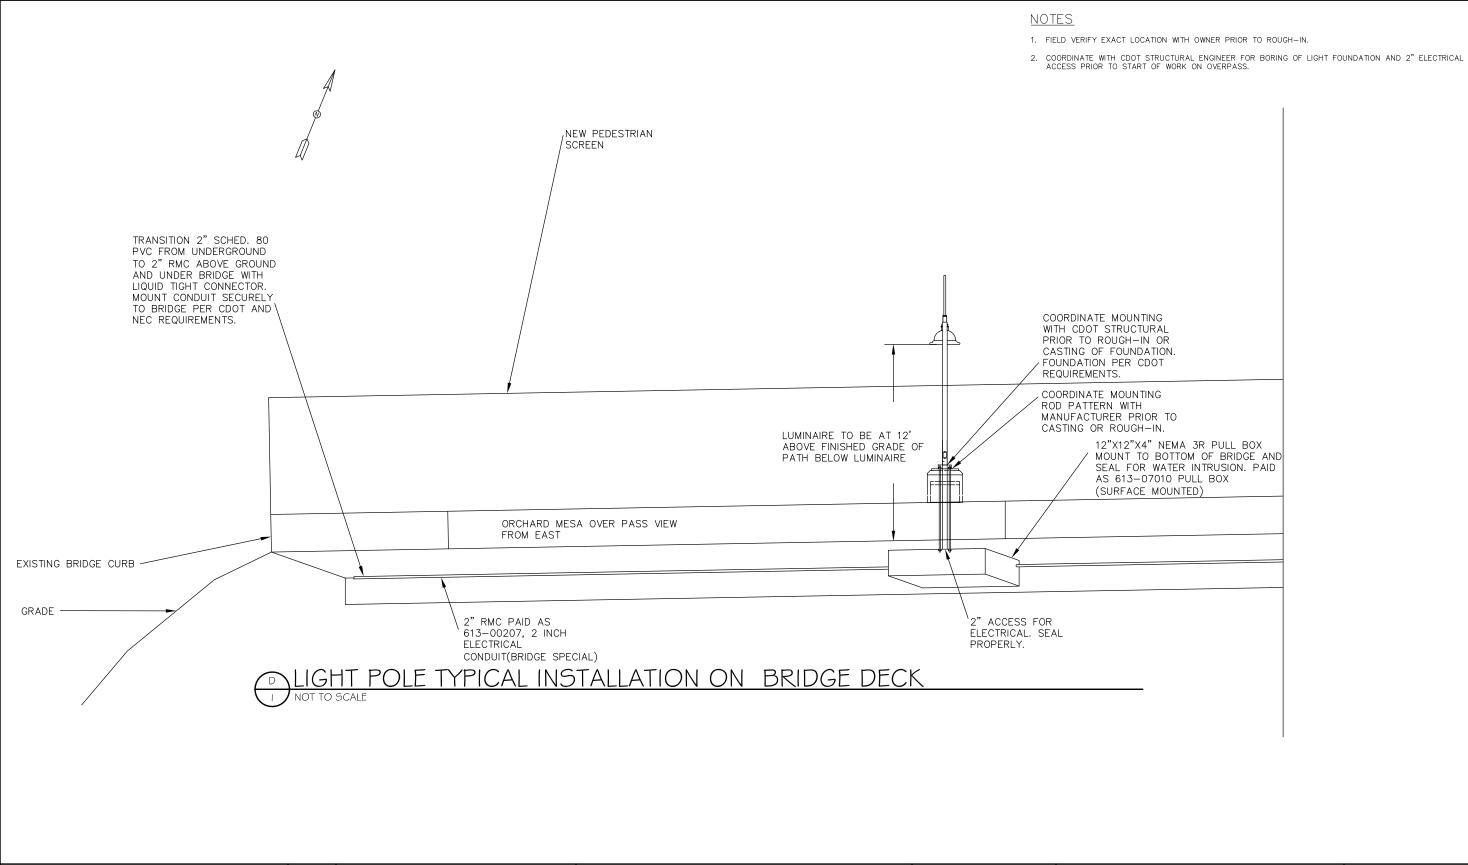

Print Date: 8-15-2016		Sheet Revisions	
File Name:	Date:	Comments	lnit.
Horiz. Scale: AS SHOWN Vert. Scale: NA			
Unit Information: City of GJ Unit Leader Initials: LC			
ACM CONSULTING AND ENGINEERING PH: (970) 245-7292			
CONSULTING EMAIL: JOELM@ACMENGRS.COM			



As Constructed	LIGHT POLE BRIDGE CONNECTION DETAILS		Project No./Code
No Revisions:			TAP M555-032
Revised:		Structure Numbers	20736
Void:	Detailer: AJM LIGHTING	Subset Sheets: LE13 of 13	Sheet Number