



Purchasing Division

ADDENDUM NO. 1

DATE: April 10, 2018
FROM: City of Grand Junction Purchasing Division
TO: All Offerors
RE: 2018 Sewer Line Replacement Project – Phase A

Offerors responding to the above referenced solicitation are hereby instructed that the requirements have been clarified, modified, superseded and supplemented as to this date as hereinafter described.

Please make note of the following clarifications:

1. Replace the original Bid Schedule with the updated Bid Schedule that is attached to this Addendum. Several pay items have had their quantities changed.
2. Replace the construction plans with the updated construction plans that are attached to this Addendum.
3. Question #1 – Will the project require the installation of sewer service stub-outs to the vacant lots along the IPE Holdings LLC properties (use to be the old Grand Junction Steel yard)?

Answer – No, the project won't require sewer service stub-outs to be installed at this location.

4. Question #2 – Will the City allow the use of fusible HDPE pipe for use with the pipe bursting segments?

Answer – No, the City will not allow the use of fusible HDPE pipe to be used with the pipe bursting operations. Per this Addendum #1, the City will allow either 8-inch Fusible PVC pipe or 8-inch Certa-Lok (CertainTeed) Restrained Joint PVC pipe for the pipe bursting segments.

Refer to the updated Special Provision section, within this Addendum #1, regarding alternative sewer pipe to be used with the pipe bursting operations.

5. Question #3 – Will the Contractor have to maintain business access along Horizon Drive during sewer installation, and what will the City allow for the sewer that crosses Horizon Drive at a 90-degree angle?

Answer – Refer to Special Condition 3.3.16 for the requirements pertaining to maintaining driveway access to both business and residential properties. Along Horizon Drive, a lot of the business properties have cross-connection flow and when a driveway access has to be temporarily closed for sewer installation, the other nearby driveway access locations will allow the public to get access to a certain business/property.

Sewer work along Horizon Drive will need to happen during the daylight hours. Due to the high density of hotels along Horizon Drive, nighttime work will not be allowed.

For the sewer installation across Horizon Drive (between manholes G1-271-043 to G1-271-041), the City wants the Contractor to install this segment of sewer pipe on a Saturday and/or Sunday when the traffic volumes along Horizon Drive are at their lowest. Typically, Sunday traffic volumes along Horizon Drive are pretty low.

The City will not allow the Contractor to detour vehicles around sewer installation work using adjacent private property on Horizon Drive.

6. Question #4 – What information is known regarding the concrete alley pavement that has radiant heat piping installed at Munro Pump along South 9th Street?

Answer – The City learned from Munro Pump that the radiant heat piping was installed by Alpine Construction Management several years ago. The concrete pavement within City right-of-way (ROW) does not have radiant heat piping in it and the concrete in the ROW is 8-inches thick. The radiant heated concrete starts at the ROW line and goes east. The radiant heated concrete is 6-inches thick, underneath the concrete there is a layer of 2-inch thick rigid Styrofoam insulation board, there is a reinforcing steel mat at mid-depth that is #4 rebar at 2-ft on center spacing each way, the radiant heat piping is 5/8” dia. flexible PVC pipe that is “burnt red” in color (exact pipe material is unknown at this time), and the radiant heat piping was installed in a looped pattern that goes north-south in direction.

From the construction plans and the sewer inspection videos, the first two westerly sewer services for Munro Pump should be in the ROW and under the 8-inch thick concrete. The third (most east) sewer service line to Munro Pump should be underneath the radiant heated concrete pavement.

Lastly, Alpine Construction Management mentioned that “Diamond Dowel Plates” were used at the cold joints instead of round dowel bars.

Pay Item #45, Concrete Pavement (Radiant Heating) (6” Thick) has been updated and shall include the Contractor exposing the ends of the cut radiant heat piping, installing industry approved pipe couplings intended for radiant heat piping in concrete pavement, providing and installing new flexible PVC piping in a north-south loop pattern, placing 2-inch thick rigid Styrofoam insulation, and #4 rebar (black) at 2-ft spacing each way.

7. Question #5 – Sheet 18, Manhole G1-271-041 is shown for replacement. Is this necessary?

Answer – This manhole G1-271-041 on Horizon Drive is to remain in-place. The construction note calls out for the Contractor to connect the new PVC sewer pipe into this existing manhole.

UPDATES TO PROJECT SPECIAL PROVISIONS

SECTION 102 – MATERIALS

Specification *Section 02710 – Plastic Sewer Main*

- Include the following sub-section 2.02.a within Part 2 – Products:

PART 2 – PRODUCTS

2.02.a Restrained Joint PVC Pipe

1. MANUFACTURER REQUIREMENTS

- i. Restrained joint PVC pipe shall be manufactured in accordance with the dimensions, materials, quality control, and marking specifications found in AWWA C900-16. The PVC pipe and PVC coupling material shall conform to a minimum cell classification of 12454 as defined by ASTM D1784. **The length of pipe segments to be used is 40 foot sections.**

Pipe joints shall meet the requirements of ASTM D3139. All products shall be supplied with isoprene/styrene-butadiene rubber blend gaskets. All gasket materials shall meet the requirements of ASTM F477.

2. SPECIFIED PIPE

- i. C-900/RJ Certa-Lok PVC Pressure Pipe, SDR-18. Diameter is 8-inch.

- In Section *3.01 – Pipe Installation*, include the following sub-section:

- G. The plastic ribs that form on the Fusible PVC pipe at the pipe joints as a result of the pipe welding/fusion process shall be removed from the inside diameter of the fused Pipe after the pipe has been successfully installed and after

the pipe relaxation period. The Contractor shall use special tooling and equipment to travel through the fused PVC pipe and remove the plastic ribs from the inside of the pipe providing a smooth pipe interior. The cost to remove the internal plastic ribs will not be paid for separately, but shall be included in the overall cost of the Project.

SECTION 104 – INSTALLATION OF PIPE AND APPURTENANCES

Update Specification *Section 02750 – Pipe Bursting* with the following information:

- Replace Sub-Section *1.02 – Contractor Qualifications* with the following:

1.02 CONTRACTOR QUALIFICATIONS:

The CONTRACTOR, or the subcontractor performing the work, shall be certified by the pipe bursting equipment manufacturer as a fully trained user of the pipe bursting equipment. Operation of the pipe bursting equipment shall be performed by trained personnel. The CONTRACTOR shall present evidence to prove to the satisfaction of the ENGINEER that he, or the subcontractor performing the work, has had previous experience in sewer pipe installation of this nature.

The pipe bursting CONTRACTOR shall have actively engaged in the installation of pipe using pipe bursting on at least two (2) pipe bursting projects in similar size and scope. The CONTRACTOR'S pipe bursting subcontractor shall keep the same supervisor on this Project until the pipe bursting installation on the project is satisfactorily completed.

Statement of Qualifications from two (2) past projects documenting pipe bursting experience shall include:

1. Project name and location, pipe sizes and lengths, Owner's name, address, telephone number, contact person, date and duration of work, additional information on the project, and contents handled by pipeline.
2. Supervisory field personnel and historical information of sewer pipe bursting experience. At least one of the field supervisors listed must be at the site when pipe bursting operations are in progress.

- Replace Sub-Section *1.04 – Submittals* with the following:

1.04 SUBMITTALS:

Submittals will be required for all qualifications, processes, and materials in accordance with this section. Submittals shall include all equipment proposed including that for both pipe bursting and butt-fusing of FPVC pipe. A detailed description of the complete process proposed for the replacement of the sewer main by pipe bursting shall also be submitted. This includes excavations, service locations and reconnections, maintaining the design sewer slope, and the process to upsize the space for the new pipe.


Specifically, submittals to be provided must include, but are not necessarily limited to the following:

- A. Statement of Qualifications from two (2) past pipe bursting project similar in size and scope.
- B. Detailed construction procedures and layout plans, including sequence of construction and how the CONTRACTOR will maintain the pipe slope between manhole locations.
- C. Method of installing pipe to the pipe slope shown in the construction plans.
- D. Method of locating and reconnecting service lines.
- E. Method of establishing and utilizing the launching and receiving pits.
- F. Method of bypassing pumping around any sewer bursting operation as necessary.
- G. Information on all equipment proposed for pipe bursting operations.
- H. Any other information required to provide a complete understanding of the proposed construction methods.

The original solicitation for the project noted above is amended as noted.

All other conditions of subject remain the same.

Respectfully,

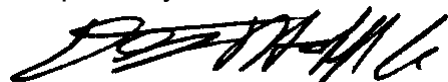

Duane Hoff Jr., Senior Buyer
City of Grand Junction, Colorado

Bid Schedule: 2018 Sewerline Replacement Project - Phase A

ADDENDUM #1

Item No.	CDOT, City Ref.	Description	Quantity	Units	Unit Price	Total Price
1	108.2	4" Sewer Pipe Service (SDR-35 PVC) (Includes cost of connection to the existing sewer service line)	910.	Lin. Ft.	\$ _____	\$ _____
2	108.2	6" Gravity Sewer Pipe (SDR-35 PVC) (Includes cost of connection to the existing sewer pipe)	60.	Lin. Ft.	\$ _____	\$ _____
3	108.2	8" Gravity Sewer Pipe (SDR-35 PVC) (Includes cost of connection to the existing sewer pipe)	3,560.	Lin. Ft.	\$ _____	\$ _____
4	108.2	8" Gravity Sewer Pipe (Fusible PVC C-900 DR-18 or Certa-Lok C-900-Restrained Joint DR-18) (Includes Pipe-Bursting Installation Method)	1,170.	Lin. Ft.	\$ _____	\$ _____
5	108.2	10" Gravity Sewer Pipe (SDR-35 PVC) (Includes cost of connection to the existing sewer pipe)	815.	Lin. Ft.	\$ _____	\$ _____
6	108.2	Imported Trench Backfill (Class 3) (Includes haul and disposal of unsuitable excavated material) (Assumed Unit Weight = 133 lbs/ft ³)	3,000.	Ton	\$ _____	\$ _____
7	108.3	8" x 4" Sewer Service Tap (Full Body Wye) (Includes Wye, clean-out and all fittings required to align and connect the sewer service pipe to the sewer tap)	38.	Each	\$ _____	\$ _____
8	108.3	8" x 4" Sewer Service Tap (Tapping Saddle) (To be used on the Fusible PVC pipe) (Includes saddle, clean-out and all fittings required to align and connect the sewer service pipe to the sewer tap)	12.	Each	\$ _____	\$ _____
9	108.3	10" x 4" Sewer Service Tap (Full Body Wye) (Includes Wye, clean-out and all fittings required to align and connect the sewer service pipe to the sewer tap)	6.	Each	\$ _____	\$ _____
10	108.3	Sewer Service Clean-out Ring and Cover (Castings Inc. CO-8030-CI or Approved Equal) (Includes concrete collar in unpaved areas per City Std. Detail SS-07)	55.	Each	\$ _____	\$ _____

Bid Schedule: 2018 Sewerline Replacement Project - Phase A

ADDENDUM #1

Item No.	CDOT, City Ref.	Description	Quantity	Units	Unit Price	Total Price
11	108.5	Sanitary Sewer Basic Manhole (48" I.D.)	4.	Each	\$ _____	\$ _____
12	108.5	Sanitary Sewer Basic Manhole (48" I.D.) (Epoxy Coated Inverts)	21.	Each	\$ _____	\$ _____
13	108.5	Manhole Barrel Section (D>5') (48" I.D.)	39.	Vert. Ft.	\$ _____	\$ _____
14	108.5	Connect to Existing Manhole (8" pipe)	2.	Each	\$ _____	\$ _____
15	108.7	Granular Stabilization Material (Type B) (Crushed Rock) (18" Thick Min.) (Includes haul and disposal of unsuitable excavated material) (Assumed Unit Weight = 138 lbs/ft ³)	550.	Ton	\$ _____	\$ _____
16	202	Removal of Existing Pipe (Size & type as shown on plans)	5,351.	Lin. Ft.	\$ _____	\$ _____
17	202	Abandon Pipe (Abandon pipe by plugging ends with concrete)	14.	Each	\$ _____	\$ _____
18	202	Removal of Asphalt Mat (Full Depth)	1,700.	Sq. Yd.	\$ _____	\$ _____
19	202	Removal of Asphalt Mat (Planing) (2" Thick for T-Top Section)	1,100.	Sq. Yd.	\$ _____	\$ _____
20	202	Removal of Concrete with Radiant Heat Tubing (Alley at Munro Pump) (Saw-Cut Concrete for Removal) (6" Thick)	20.	Sq. Yd.	\$ _____	\$ _____
21	202	Removal of Concrete (Includes, but not limited to, curb, gutter, sidewalk, driveway, slabs, V-pans, curb ramps, intersection corners, aprons, and landscape borders)	220.	Sq. Yd.	\$ _____	\$ _____
22	202	Removal of Sod	15.	Sq. Yd.	\$ _____	\$ _____
23	202	Removal of Manhole	24.	Each	\$ _____	\$ _____
24	202	Abandon Manhole (Remove cone section, ring & cover, and fill remaining barrel sections with flow-fill material)	1.	Each	\$ _____	\$ _____
25	203	Disposal of Radioactive Material (Dispose at City Shops, 333 West Ave.)	40.	Cu. Yd.	\$ _____	\$ _____

Bid Schedule: 2018 Sewerline Replacement Project - Phase A

ADDENDUM #1

Item No.	CDOT, City Ref.	Description	Quantity	Units	Unit Price	Total Price
26	206	Structure Backfill (Flow-Fill)	100.	Cu. Yd.	\$ _____	\$ _____
27	208	Storm Drain Inlet Protection (Silt-Sack) (Includes Maintenance & Removal of Debris, & Removal of Inlet Protection)	15.	Each	\$ _____	\$ _____
28	208	Concrete Washout Facility	1.	Lump Sum	---	\$ _____
29	210	Repair Damage to Unlocated Irrigation Lines (Various Sizes and Materials) (1" to 15")	3.	Each	\$ _____	\$ _____
30	210	Reset Landscape Ground Cover (Landscape Rock) (Match in Kind)	25.	Sq. Yd.	\$ _____	\$ _____
31	210	Reset Sprinkler System (Complete in Place)	2.	Each	\$ _____	\$ _____
32	210	Reset Fence (6' High Chain-Link)	32.	Lin. Ft.	\$ _____	\$ _____
33	212	Re-Sod Area as Shown (Includes 4" Thick of Topsoil placed prior to sod placement)	15.	Sq. Yd.	\$ _____	\$ _____
34	304	Aggregate Base Course (Class 6) (6" thick)	1,300.	Sq. Yd.	\$ _____	\$ _____
35	304	Aggregate Base Course (Class 6) (15" thick)	1,700.	Sq. Yd.	\$ _____	\$ _____
36	401	Hot Bituminous Pavement (Patching) (3 " Thick) (Grading SX, PG 64-22) (GYR.=75) (One 3" Lift)	1,700.	Sq. Yd.	\$ _____	\$ _____
37	401	Hot Bituminous Pavement (Patching) (2" Thick) (Grading SX, PG 64-22) (GYR.=75) (One 2" Top Mat)	1,550.	Sq. Yd.	\$ _____	\$ _____
38	401	Hot Bituminous Pavement (Patching) (2" Thick) (Grading SX, PG 64-22) (GYR.=75) (One 2" Top Mat) (T-Top)	1,200.	Sq. Yd.	\$ _____	\$ _____
39	407	Emulsified Asphalt (Tack Coat)	295.	Gallon	\$ _____	\$ _____

Bid Schedule: 2018 Sewerline Replacement Project - Phase A

ADDENDUM #1

Item No.	CDOT, City Ref.	Description	Quantity	Units	Unit Price	Total Price
40	420	Geotextile (Separator) (Non-Woven) (Wrap stabilization material with fabric) (Minimum Overlap = 24")	1,900.	Sq. Yd.	\$ _____	\$ _____
41	607	Line Post (Match in Kind) (6' High) (If Necessary)	3.	Each	\$ _____	\$ _____
42	608	Concrete Sidewalk (4" thick)	14.	Sq. Yd.	\$ _____	\$ _____
43	608	Concrete Curb and Gutter (Match in Kind)	170.	Lin. Ft.	\$ _____	\$ _____
44	608	Concrete Driveway Section (8" Thick) (Includes #5 epoxy coated rebar tie-bars @ 12" spacing) (18" long)	61.	Sq. Yd.	\$ _____	\$ _____
45	608	Concrete Pavement (Radiant Heating) (6" Thick) (Includes exposing existing flexible PVC hydronic heat tubing ends, connecting new tubing to existing tubing, installing new 2" thick insulation board, and #4 rebar @ 2' O.C. spacing each way) (Located at Munro Pump on 9th St.)	20.	Sq. Yd.	\$ _____	\$ _____
46	608	Concrete Curb, Gutter and Sidewalk (Match in Kind)	130.	Sq. Yd.	\$ _____	\$ _____
47	608	Concrete Drainage Pan (8" Thick) (See City Standard Detail C-12) (Includes #5 Rebar for Tie-Bars)	8.	Sq. Yd.	\$ _____	\$ _____
48	608	Cap Top Half of Sewer Pipe in Concrete per City Std. Detail GU-04 (20' long) (If necessary)	3.	Each	\$ _____	\$ _____
49	608	Encase Sewer Pipe in Concrete per City Std. Detail GU-04 (20' long) (If necessary)	2.	Each	\$ _____	\$ _____
50	620	Portable Sanitary Facility	1.	Each	\$ _____	\$ _____
51	625	Construction Surveying (Includes As-Built Drawings)	1.	Lump Sum	---	\$ _____
52	626	Mobilization	1.	Lump Sum	---	\$ _____
53	629	Survey Monumentation (Complete in Place) (Reference and Reset)	2.	Each	\$ _____	\$ _____
54	630	Traffic Control (Complete in Place)	1.	Lump Sum	---	\$ _____

Bid Schedule: 2018 Sewerline Replacement Project - Phase A ADDENDUM #1

Item No.	CDOT, City Ref.	Description	Quantity	Units	Unit Price	Total Price
55	630	Traffic Control Plan	1.	Lump Sum	---	\$ _____
56	630	Flagging	1,500.	Hour	\$ _____	\$ _____
57	SC 3.3.18	Quality Control Testing	1.	Lump Sum	---	\$ _____
58	Pump	Bypass Sewage Pumping (At Contractors Discretion)	1.	Lump Sum	---	\$ _____
MCR		Minor Contract Revisions	---	---	---	\$ <u>125,000.00</u>
Bid Amount:						\$ _____

Bid Amount:

_____ dollars

Contractor Name:

Contractor Address:

Contractor Phone #:


2018 SEWER LINE REPLACEMENTS PHASE A MARCH, 2018

PROJECT NO. 902-F001633

- 1 — Cover Sheet
- 2 — Standard Abbreviations, Legend, and Symbols
- 3 — Summary of Approximate Quantities
- 4 — Project Control Map
- 5 — Project Location Map
- 6 — 4TH Avenue Alley Plan and Profile
- 7 — S 10TH Street Plan and Profile
- 8 — S 8TH Street Plan and Profile
- 9-11 — 3RD Avenue Alley Plan and Profile
- 12-13 — S 7TH Street Plan and Profile
- 14 — S 7TH Street Alley Plan and Profile
- 15-16 — N 7TH Street Plan and Profile
- 17 — Center Avenue Plan and Profile
- 18-19 — Horizon Drive Plan and Profile
- 20-21 — Manhole Structure Schedule
- 22-23 — Soil Bore Log Details

- D1 — General Sewer Notes and Standard Manhole
- D2 — Standard Shallow Manhole and Drop Manhole
- D3 — Standard Manhole Ring and Cover and Typical Service "Y" Connection
- D4 — Sewer Service Cleanout Detail and Precast Manhole Base, Pipe Connections and Access Hole Location
- D5 — Pipe Bursting Details
- D6 — General Utility Details

VICINITY MAP

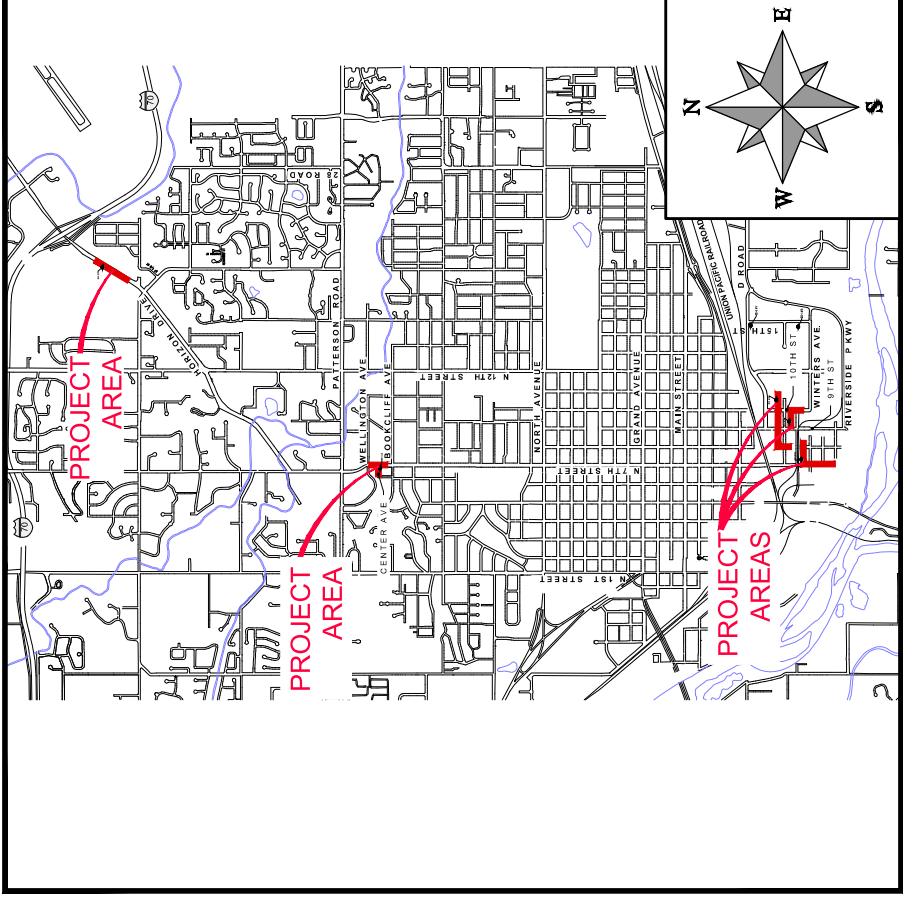

UTILITIES AND AGENCIES								
AGENCY	NAME	POSITION	ROLE	MAILING ADDRESS	STREET ADDRESS	CITY, STATE	VOICE-WK	FAX
CITY OF GRAND JUNCTION	BILL ETCHEVERRY	COLLECTIONS SUPERVISOR	SANITARY SEWER	2145 RIVER ROAD	2145 RIVER ROAD	GRAND JCT., CO 81501	(970) 256-4167	(970) 256-4022
CITY OF GRAND JUNCTION	LEE COOPER	PROJECT ENGINEER	SANITARY SEWER	333 WEST AVE BLDG C	333 WEST AVE BLDG C	GRAND JCT., CO 81501	(970) 256-4155	(970) 256-4022
UNION PACIFIC RAILROAD	JUSTIN O. CORDOVA		UPRR REVIEW				(970) 628-6019	
GRAND VALLEY IRRIGATION CO.	PHIL BERTRAND	MANAGER	IRRIGATION	688 26 RD	688 26 RD	GRAND JCT., CO 81506	(970) 242-2762	
SPECTRUM	JEFF VALDEZ	MANAGER	CABLE TV	2502 FORESIGHT CIRCLE	2502 FORESIGHT CIRCLE	GRAND JCT., CO 81504	(970) 245-8750	(970) 245-6803
CENTURYLINK	CHRIS JOHNSON	ENGINEER	TELEPHONE	2524 BLICHMANN AVE	2524 BLICHMANN AVE	GRAND JCT., CO 81504	(970) 244-4311	(970) 240-4349
UTE WATER	JUSTIN BATES	SUPERVISOR	WATER	PO BOX 460	2190 H 1/2 RD	GRAND JCT., CO 81502	(970) 242-7491	(970) 242-9189
XCEL	STEVE PIBURN	UNIT MANAGER	ELECTRIC	2538 BLICHMANN AVE	2538 BLICHMANN AVE	GRAND JCT., CO 81506	(970) 244-2664	(970) 244-2664
XCEL	SARAH BARRICAU	UNIT MANAGER	GAS	2538 BLICHMANN AVE	2538 BLICHMANN AVE	GRAND JCT., CO 81506	(970) 244-2656	(970) 244-2656



Know what's below.
Call before you dig.

DRAWING STATUS:
 PROGRESS
 FINAL CONSTRUCTION DRAWINGS
 ASBUILT

DESIGNED BY:

BRENDAN HINES, PROJECT ENGINEER 2018

REVIEWED BY:

DAN QUIGLEY, ENGINEERING MANAGER 2018

AUTHORIZED FOR CONSTRUCTION

RANDI KIM, UTILITIES DIRECTOR 2018

ACCEPTED FOR CONSTRUCTION

LEE COOPER, PROJECT ENGINEER 2018

222 South Park Avenue
Montrose, Colorado 81401
970-249-6828
WWW.DOWL.COM

CITY OF
Grand Junction
C O L O R A D O

Public Works
Engineering Division

NOTE: NOTIFY AFFECTED UTILITY VENDOR 48 HOURS PRIOR TO EXCAVATIONS THAT WILL EXPOSE UTILITY LINES. THE COVER SHEET WILL HAVE A LISTING OF UTILITY VENDORS AND TELEPHONE NUMBERS.

REVISION	DESCRIPTION	DATE
REVISION A	ADDENDUM #1 - REVISED PLANS	04/09/18
REVISION B		
REVISION C		

ABBREVIATIONS



AAASHTO	AMERICAN ASSOCIATION OF STATE HIGHWAY & TRANSPORTATION OFFICIALS
AC	AGGREGATE BASE COURSE
ABC	ASBESTOS CEMENT
AP	ANGLE POINT
ASB	ANCHORED STRAW BALES
ASTM	AMERICAN SOCIETY FOR TESTING MATERIALS
AWWA	AMERICAN WATER WORKS ASSOCIATION
BC	BACK OF CURB
BF	BUTTERFLY VALVE
BOW	BACK OF WALK
BCR	BEGIN CURB RETURN
BSWMP	BOTTOM STORM WATER MANAGEMENT PRACTICES
CC	CORRUGATED ALUMINUM PIPE
CDOT	COLORADO DEPARTMENT OF TRANSPORTATION
CI	CAST IRON
C.G.& SW	CURB, GUTTER & SIDEWALK
CLP	CLEAR COATED METAL PIPE
CP	CLEAN OUT
COB	COMBINATION (AS IN STORM SEWER AND SANITARY SEWER)
CONC	CONCRETE
CSM	CITY SURVEY MONUMENT
CSP	CORRUGATED STEEL PIPE
CU	COPPER
DI	DUCTILE IRON
DWY	DRIVEWAY
E	EDGE OF CURB RETURN
EGR	EDGE OF GUTTER
EG	ELEVATION
EL	EXISTING
EX	FULL BODY
FB	FACE OF CURB
FC	FACE OF CURB
FG	FACE OF GRADE
FL	FLANGE
FM	FORCE MAIN
FO	FAR SIDE
FS	FOOTING
FTG	FOOTING
G	GAS
GB	GAS BREAK
GM	GAS METER
GW	GATE VALVE
HBP	HIGH BITUMINOUS PAVEMENT
HDPE	HIGH DENSITY POLYETHYLENE
INV	INVERT
IRR	IRRIGATION
L	LENGTH OF ARC
LC	LONG CHORD
LF	LONG FLUET
LL	LONG ARC
LS	LONG SHORT
LT	LEFT
MB	MAILBOX
MCSM	MESA COUNTY SURVEY MONUMENT
MH	MANHOLE
MJ	MECHANICAL JOINT
NA	NOT APPLICABLE
N/A	NOT IN CONTRACT
NIC	NOT ONE PERSON
NOP	NON-REINFORMATIONRCD CONCRETE PIPE
NRCP	NON-REINFORMATIONRCD CONCRETE PIPE
NS	NEAR SIDE
NTS	NOT TO SCALE
OHP	OVERHEAD POWER
OHT	OVERHEAD TELEPHONE
OP	OPEN
PCC	POINT OF COMPOUND CURVATURE
PE	POLYETHYLENE
PERF	PERFORATED
PI	POINT OF INTERSECTION
PIP	PLASTIC IRRIGATION PIPE
POC	POINT ON CURVE
POT	POINT ON TANGENT
PRC	POINT OF REVERSE CURVATURE
PT	POINT OF TANGENCY
PVC	POLYVINYL CHLORIDE
R	RADIUS
RCP	REINFORMATIONRCD CONCRETE PIPE
REQ'D	REQUIRED
RG	RESTRAINED GLANDS
RHS	RADIUS
RIP	RADIUS POINT
RR	RAIL ROAD
RS	SHORT RADIUS
RT	RIGHT
S	SLOPE
SAN	SANITARY
SC	SHORT CHORD
SCH	SCHEDULE CONTRACT DOCUMENTS
SCH	SCHEDULE
SF	SILT FENCE
SL	SECTION LINE
SSRB	STANDARD SPECIFICATIONS FOR ROAD & BRIDGE CONSTRUCTION
SSUU	STANDARD SPECIFICATIONS FOR CONSTRUCTION OF UNDERGROUND UTILITIES
STA	STATION
STL	STEEL
T	TANGENT
TAN	TANGENT
TC	TOP OF CURB
TH	TEST HOLE
TV	TELEVISION
(TYP)	TYPICAL
UU	UNDERGROUND UTILITIES
V	VERTICAL CURVATURE
VPC	VERTICAL POINT OF CURVATURE
VPC	VERTICAL POINT OF COMPOUND CURVATURE
VPRC	VERTICAL POINT OF REVERSE CURVATURE
VPI	VERTICAL POINT OF INTERSECTION
VPT	VERTICAL POINT OF TANGENCY
W	WATER
Δ	DELTA ANGLE

LEGEND

BSWMP	AMERICAN ASSOCIATION OF STATE HIGHWAY & TRANSPORTATION OFFICIALS
DRAINAGE BASIN BOUNDARY	ASBESTOS CEMENT
BSWMP	ANCHORED STRAW BALES
BSWMP	AMERICAN WATER WORKS ASSOCIATION
SILT FENCE	BUTTERFLY VALVE
BUILDING	BOTTOM STORM WATER MANAGEMENT PRACTICES
CONCRETE CURB AND GUTTER	CORRUGATED ALUMINUM PIPE
CONCRETE CURB, GUTTER, & SIDEWALK	COLORADO DEPARTMENT OF TRANSPORTATION
CONCRETE DITCH	CAST IRON
CONCRETE SIDEWALK	CURB, GUTTER & SIDEWALK
CULVERT	DUCTILE IRON
EARTH DITCH	DRIVEWAY
EDGE OF GRAVEL	EDGE OF CURB RETURN
EDGE OF PAVEMENT	EDGE OF GUTTER
FENCE (BARBED WIRE)	ELEVATION
FENCE (CHAIN LINK)	EXISTING
FENCE (IRON)	FULL BODY
FENCE (PLASTIC)	FACE OF CURB
FENCE (TEMPORARY CONSTRUCTION)	FACE OF CURB
FENCE (WOOD)	FACE OF GRADE
FENCE (WOVEN WIRE)	FLANGE
GUARD RAIL	FORCE MAIN
HATCHING: INDICATES ASPHALT REMOVAL	FIBER OPTICS
HATCHING: INDICATES CONCRETE REMOVAL	FAR SIDE
HATCHING: INDICATES STAGING AREA	FOOTING
LINE (CENTER OF IMPROVEMENTS)	GAS
LINE (CITY LIMITS)	GAS BREAK
LINE (CONTROL)	GAS METER
LINE (EASEMENT)	GATE VALVE
LINE (MONUMENT/SECTION)	HIGH BITUMINOUS PAVEMENT
LINE (PROPERTY)	HIGH DENSITY POLYETHYLENE
LINE (RIGHT OF WAY)	INVERT
MATCH LINE	IRRIGATION
PIPE (IRRIGATION)	LENGTH OF ARC
PIPE (SIPHON)	LONG CHORD

SYMBOLS

⊙	BENCH MARK
⊞	CATCH BASIN
⊞	CLEAN OUT
⊞	CURB STOP
⊞	FIRE HYDRANT
⊞	GUY WIRE ANCHOR
⊞	HEADGATE
⊞	IRRIGATION PUMP
⊞	MAILBOX
⊞	MANHOLE (ELECTRIC)
⊞	MANHOLE (GAS)
⊞	MANHOLE (SANITARY/STORM)
⊞	MANHOLE (TELEPHONE)
⊞	MANHOLE (TV)
⊞	MANHOLE (WATER)
⊞	METER (GAS)
⊞	METER (WATER)
⊞	PEDESTAL (TELEPHONE)
⊞	PEDESTAL (TV)
⊞	PROPERTY PIN
⊞	PULL BOX
⊞	REDUCER FITTING
⊞	SIGN OR POST (SIGN TYPE NOTED)
⊞	SPRINKLER HEAD
⊞	STREET LIGHT
⊞	STREET LIGHT
⊞	SURVEY MONUMENT (CITY)
⊞	SURVEY MONUMENT (TYPE NOTED)
⊞	TEST HOLE
⊞	TRAFFIC PAINT MARKING
⊞	TRAFFIC SIGNAL POLE AND MAST ARM
⊞	UTILITY POLE
⊞	VALVE (GAS)
⊞	VALVE (IRRIGATION)
⊞	VALVE (WATER)
⊞	VEGETATION (HEDGE OR BUSH)
⊞	VEGETATION (TREE STUMP)
⊞	VEGETATION (TREE) (CALIPER SIZE NOTED)
⊞	WATER HYDRANT
⊞	WEIR
⊞	YARD LIGHT

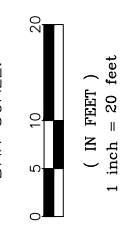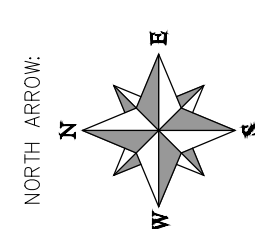

SCALES: PLAN & PROFILE

HORIZONTAL: 1" = NA	DATE 03/20/18
VERTICAL: 1" = NA	DATE 03/20/18

REVISION Δ	DESCRIPTION	DATE	DRAWN BY	BCH	DATE	03/20/18
REVISION Δ			DESIGNED BY		DATE	03/20/18
REVISION Δ			CHECKED BY	ALC	DATE	
REVISION Δ			APPROVED BY	ALC	DATE	

**Bid Schedule: 2018 Sewerline Replacement Project - Phase A**

Item No.		CDOT, City Ref.	Description	QTY.	Units
ADDENDUM #1					
1	108.2		4" Sewer Pipe Service (SDR-35 PVC) (Includes cost of connection to the existing sewer service line)	910.	Lin. Ft.
2	108.2		6" Gravity Sewer Pipe (SDR-35 PVC) (Includes cost of connection to the existing sewer pipe)	60.	Lin. Ft.
3	108.2		8" Gravity Sewer Pipe (SDR-35 PVC) (Includes cost of connection to the existing sewer pipe)	3,560.	Lin. Ft.
4	108.2		8" Gravity Sewer Pipe (Fusible PVC) (Pipe-Bursting Installation Method)	1,170.	Lin. Ft.
5	108.2		10" Gravity Sewer Pipe (SDR-35 PVC) (Includes cost of connection to the existing sewer pipe)	815.	Lin. Ft.
6	108.2		Imported Trench Backfill (Class 3) (Includes haul and disposal of unsuitable excavated material) (Assumed Unit Weight = 133 lbs/ft ³)	3,000.	Ton
7	108.3		8" x 4" Sewer Service Tap (Full Body Wye) (Includes Wye, clean-out and all fittings required to align and connect the sewer service pipe to the sewer tap)	38.	Each
8	108.3		8" x 4" Sewer Service Tap (Tapping Saddle) (To be used on the Fusible PVC pipe) (Includes saddle, clean-out and all fittings required to align and connect the sewer service pipe to the sewer Tap)	12.	Each
9	108.3		10" x 4" Sewer Service Tap (Full Body Wye) (Includes Wye, clean-out and all fittings required to align and connect the sewer service pipe to the sewer tap)	6.	Each
10	108.3		Sewer Service Clean-out Ring and Cover (Castings Inc. CO-8030-CI or Approved Equal) (Includes concrete collar in unpaved areas per City Std. Detail SS-07)	55.	Each
11	108.5		Sanitary Sewer Basic Manhole (48" I.D.)	4.	Each
12	108.5		Sanitary Sewer Basic Manhole (48" I.D.) (Epoxy Coated Inverts)	21.	Each
13	108.5		Manhole Barrel Section (D>5) (48" I.D.)	39.	Vert. Ft.
14	108.5		Connect to Existing Manhole (8" pipe)	2.	Each
15	108.7		Granular Stabilization Material (Type B) (Crushed Rock) (18" Thick Min.) (Includes haul and disposal of unsuitable excavated material) (Assumed Unit Weight = 138 lbs/ft ³)	550.	Ton
16	202		Removal of Existing Pipe (Size & type as shown on plans)	5,351.	Lin. Ft.
17	202		Abandon Pipe (Abandon pipe by plugging ends with concrete)	14.	Each
18	202		Removal of Asphalt Mat (Full Depth)	1,700.	Sq. Yd.
19	202		Removal of Asphalt Mat (Planning) (2" Thick for T-Top Section)	1,100.	Sq. Yd.


20	202	Removal of Concrete with Hydronic Heat Tubing (Alley at Munro Pump)	20.	Sq. Yd.
21	202	Removal of Concrete (Includes, but not limited to, curb, gutter, sidewalk, driveway, slabs, V-pans, curb ramps, intersection corners, aprons, and landscape borders)	220.	Sq. Yd.
22	202	Removal of Sod	15.	Sq. Yd.
23	202	Removal of Manhole	24.	Each
24	202	Abandon Manhole (Remove cone section, ring & cover, and fill remaining barrel sections with flow-fill material)	1.	Each
25	203	Disposal of Radioactive Material (Dispose at City Shops, 333 West Ave.)	40.	Cu. Yd.
26	206	Structure Backfill (Flow-Fill)	100.	Cu. Yd.
27	208	Storm Drain Inlet Protection (Silt-Sack) (Includes Maintenance & Removal of Debris, & Removal of Inlet Protection)	15.	Each
28	208	Concrete Washout Facility	1.	Lump Sum
29	210	Repair Damage to Unlocated Irrigation Lines (Various Sizes and Materials) (1" to 15")	3.	Each
30	210	Reset Landscape Ground Cover (Landscape Rock) (Match in Kind)	25.	Sq. Yd.
31	210	Reset Sprinkler System (Complete in Place)	2.	Each
32	210	Reset Fence (6' High Chain-Link)	32.	Lin. Ft.
33	212	Re-Sod Area as Shown (Includes 4" Thick of Topsoil placed prior to sod placement)	15.	Sq. Yd.
34	304	Aggregate Base Course (Class 6) (6" thick)	1,300.	Sq. Yd.
35	304	Aggregate Base Course (Class 6) (15" thick)	1,700.	Sq. Yd.
36	401	Hot Bituminous Pavement (Patching) (3" Thick) (Grading SX, PG 64-22) (GYR.=75) (One 3" Lift)	1,700.	Sq. Yd.
37	401	Hot Bituminous Pavement (Patching) (2" Thick) (Grading SX, PG 64-22) (GYR.=75) (One 2" Top Mat)	1,550.	Sq. Yd.
38	401	Hot Bituminous Pavement (Patching) (2" Thick) (Grading SX, PG 64-22) (GYR.=75) (One 2" Top Mat) (T-Top)	1,200.	Sq. Yd.
39	407	Emulsified Asphalt (Tack Coat)	295.	Gallon
40	420	Geotextile (Separator) (Non-Woven) (Wrap stabilization material with fabric) (Minimum Overlap = 24")	1,900.	Sq. Yd.
41	607	Line Post (Match in Kind) (6' High) (If Necessary)	3.	Each
42	608	Concrete Sidewalk (4" thick)	14.	Sq. Yd.
43	608	Concrete Curb and Gutter (Match in Kind)	170.	Lin. Ft.
44	608	Concrete Driveway Section (8" Thick) (Includes #5 epoxy coated rebar tie-bars @ 12" spacing) (18" long)	61.	Sq. Yd.

45	608	Concrete Pavement (Hydronic Heating) (8" Thick) (Includes exposing existing PEX hydronic heat tubing and installing new PEX tubing and connecting new tubing to the existing tubing) (Located at Munro Pump on 9th St.)	20.	Sq. Yd.
46	608	Concrete Curb, Gutter and Sidewalk (Match in Kind)	130.	Sq. Yd.
47	608	Concrete Drainage Pan (8" Thick) (See City Standard Detail C-12) (Includes #5 Rebar for Tie-Bars)	8.	Sq. Yd.
48	608	Cap Top Half of Sewer Pipe in Concrete per City Std. Detail GU-04 (20' long) (If necessary)	3.	Each
49	608	Encase Sewer Pipe in Concrete per City Std. Detail GU-04 (20' long) (If necessary)	2.	Each
50	620	Portable Sanitary Facility	1.	Each
51	625	Construction Surveying (Includes As-Built Drawings)	1.	Lump Sum
52	626	Mobilization	1.	Lump Sum
53	629	Survey Monumentation (Complete in Place) (Reference and Reset)	2.	Each
54	630	Traffic Control (Complete in Place)	1.	Lump Sum
55	630	Traffic Control Plan	1.	Lump Sum
56	630	Flagging	1,500.	Hour
57	SC 3.3.18	Quality Control Testing	1.	Lump Sum
58	Pump	Bypass Sewage Pumping (At Contractors Discretion)	1.	Lump Sum
MCR		Minor Contract Revisions	---	---



PROJECT CONTROL TABLE

POINT #	EASTING	NORTHING	ELEVATION	DESCRIPTION
10	92296.8610	44026.653	4644.22	CP /PK-W 2352/
11	92208.8840	43797.128	4639.97	CP /PK-W CENTER/
12	92227.3340	43628.175	4638.82	CP /PK-W 2335/
13	97288.0100	50718.990	4713.06	CP /PK CORPLEX/
14	97647.3600	51135.320	4718.27	CP /PK LOCO/
15	93704.9190	32906.056	4576.49	CP /PK/
20	92236.7670	32543.653	4568.63	CP PK /WINT/
40	96013.6840	32870.506	4581.20	CP /PK AT16THCOR/
41	96012.0220	33194.554	4582.47	CP /PK 4TH/
42	96008.9050	33693.391	4584.31	CP /PK PARKY/
43	95950.2510	34131.306	4587.50	CP /PK D RD/
50	92700.2290	32707.940	4570.10	CP /60D/
51	92292.7850	32698.942	4569.69	CP /6PK/
80	93702.5340	33377.715	4578.10	CP /PK/
81	93704.6520	33482.374	4578.26	CP /PK/
82	92758.1400	33037.764	4573.30	CP
83	93175.8630	33046.465	4575.08	CP
84	93176.0500	33387.564	4576.16	CP /PK/
85	92745.6220	33369.555	4574.75	CP /PK/
11054	92247.7190	32222.056	4567.14	CSM
11239	92246.9930	32551.257	4568.50	CSM

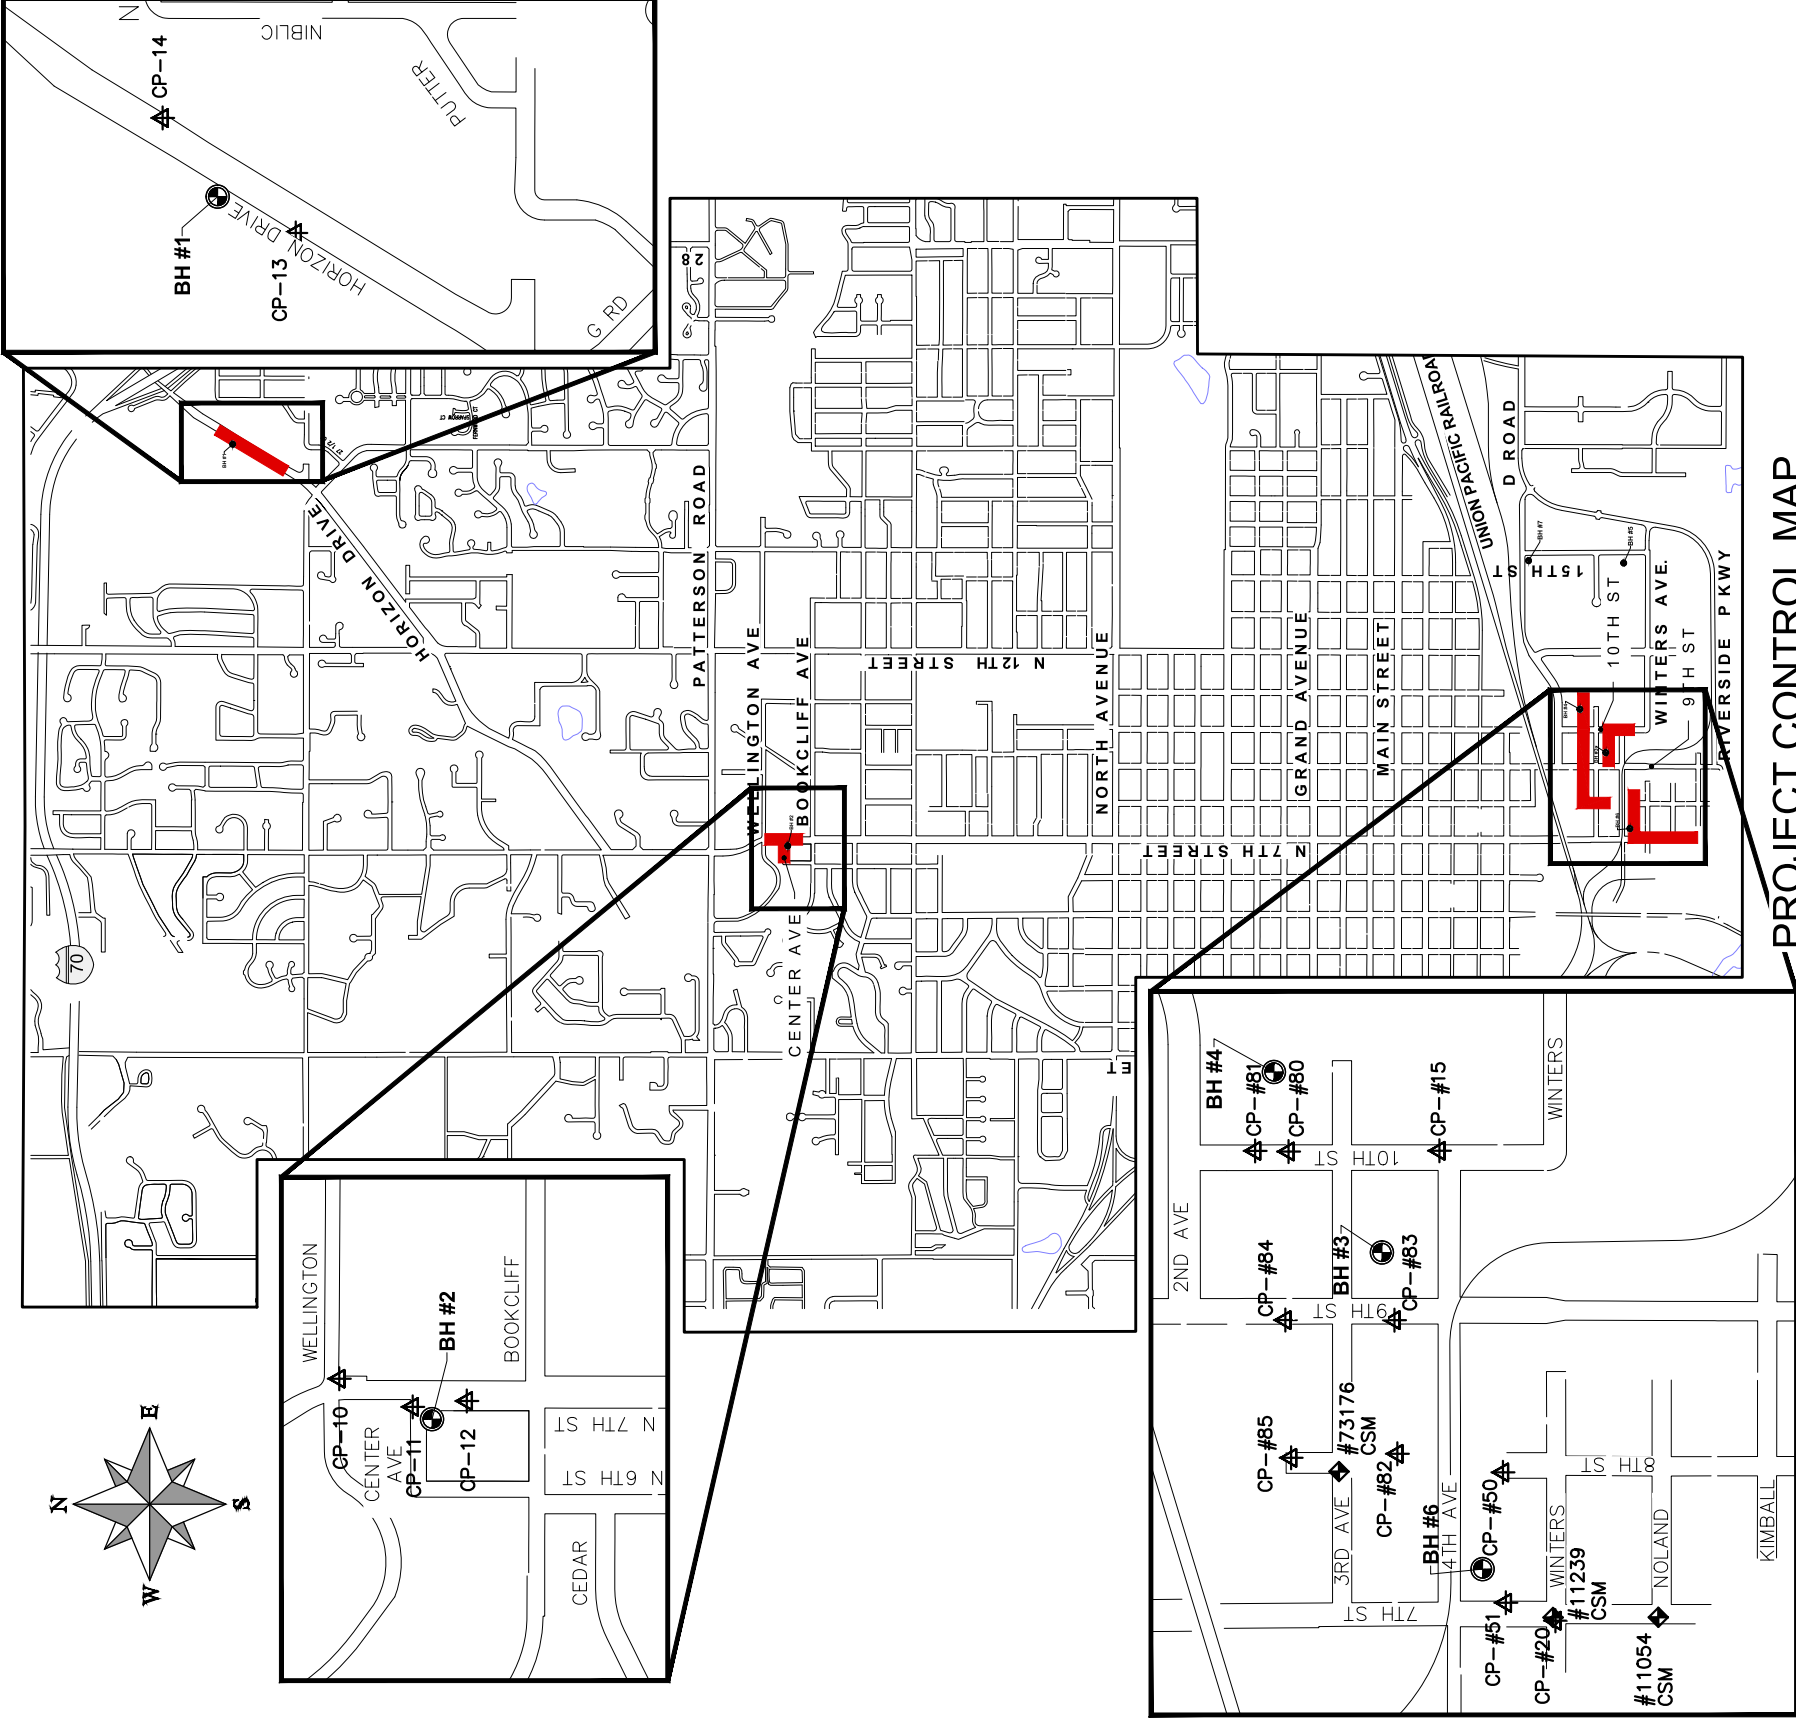

PROJECT CONTROL MAP

REVISION	DATE	DESCRIPTION	DATE

DRAWN BY	BCH	DATE	03/20/18
DESIGNED BY	BCH	DATE	03/20/18
CHECKED BY	ALC	DATE	
APPROVED BY	ALC	DATE	



INDIVIDUAL CONTROL MAPS	
HORIZONTAL: 1" = 600'	
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VERTICAL: 1" = NA'	
0 NA NA NA	



PUBLIC WORKS
ENGINEERING DIVISION

2018 SEWER LINE REPLACEMENTS - PHASE A
PROJECT CONTROL MAP

- Horizon Drive Sewer Replacement
- From 723 Horizon Drive to 708 Horizon Drive (Sheet 18 to Sheet 19)

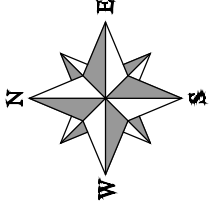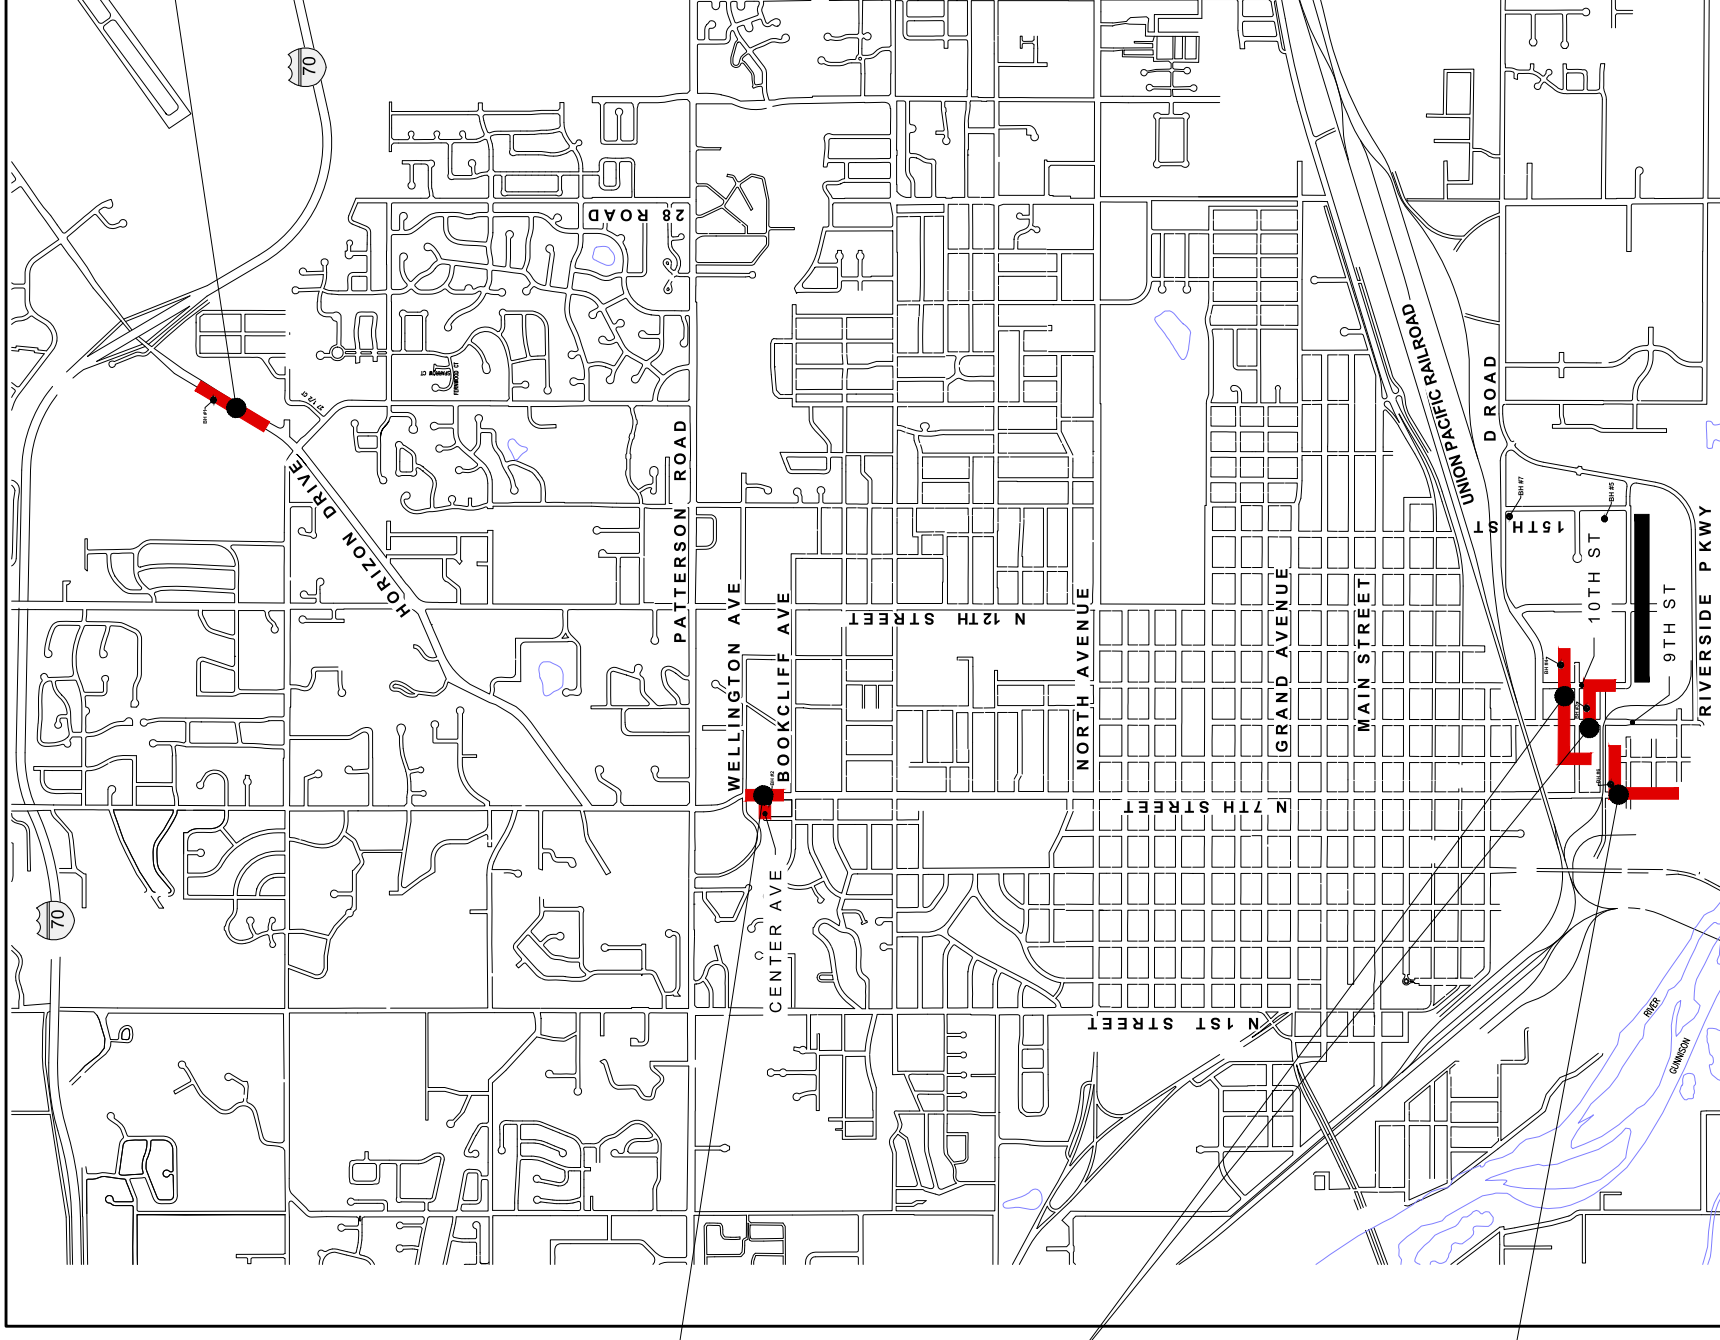

- 7th Street Sewer Replacement (North)**
- From Wellington Avenue to North of Bookcliff Avenue
 - West along Center Avenue (Sheet 15 to Sheet 17)

- 10th Street Sewer Replacement**
- Alley north of 3rd Avenue and east of 9th Street
 - Alley north of 4th Avenue and east of 9th Street to 10th Street and along 10th Street to alley north of Winters Avenue (Sheet 6 to Sheet 11)

- 7th Street Sewer Replacement (South)**
- Alley north of Winters Avenue and south along S. 7th Street (Sheet 12 to Sheet 14)

REVISION Δ	DESCRIPTION	DATE	DRAWN BY	DDC	DATE	2018
REVISION Δ			DESIGNED BY	BOH	DATE	2018
REVISION Δ			CHECKED BY	ALC	DATE	
REVISION Δ			APPROVED BY	ALC	DATE	



PROJECT CONTROL MAP	
HORIZONTAL: 1" = 2500'	0 2500 5000
VERTICAL: 1" = NA	0 NA NA



PUBLIC WORKS
ENGINEERING DIVISION

2018 SEWER LINE REPLACEMENTS – PHASE A
PROJECT LOCATION MAP

PROJECT LOCATION MAP

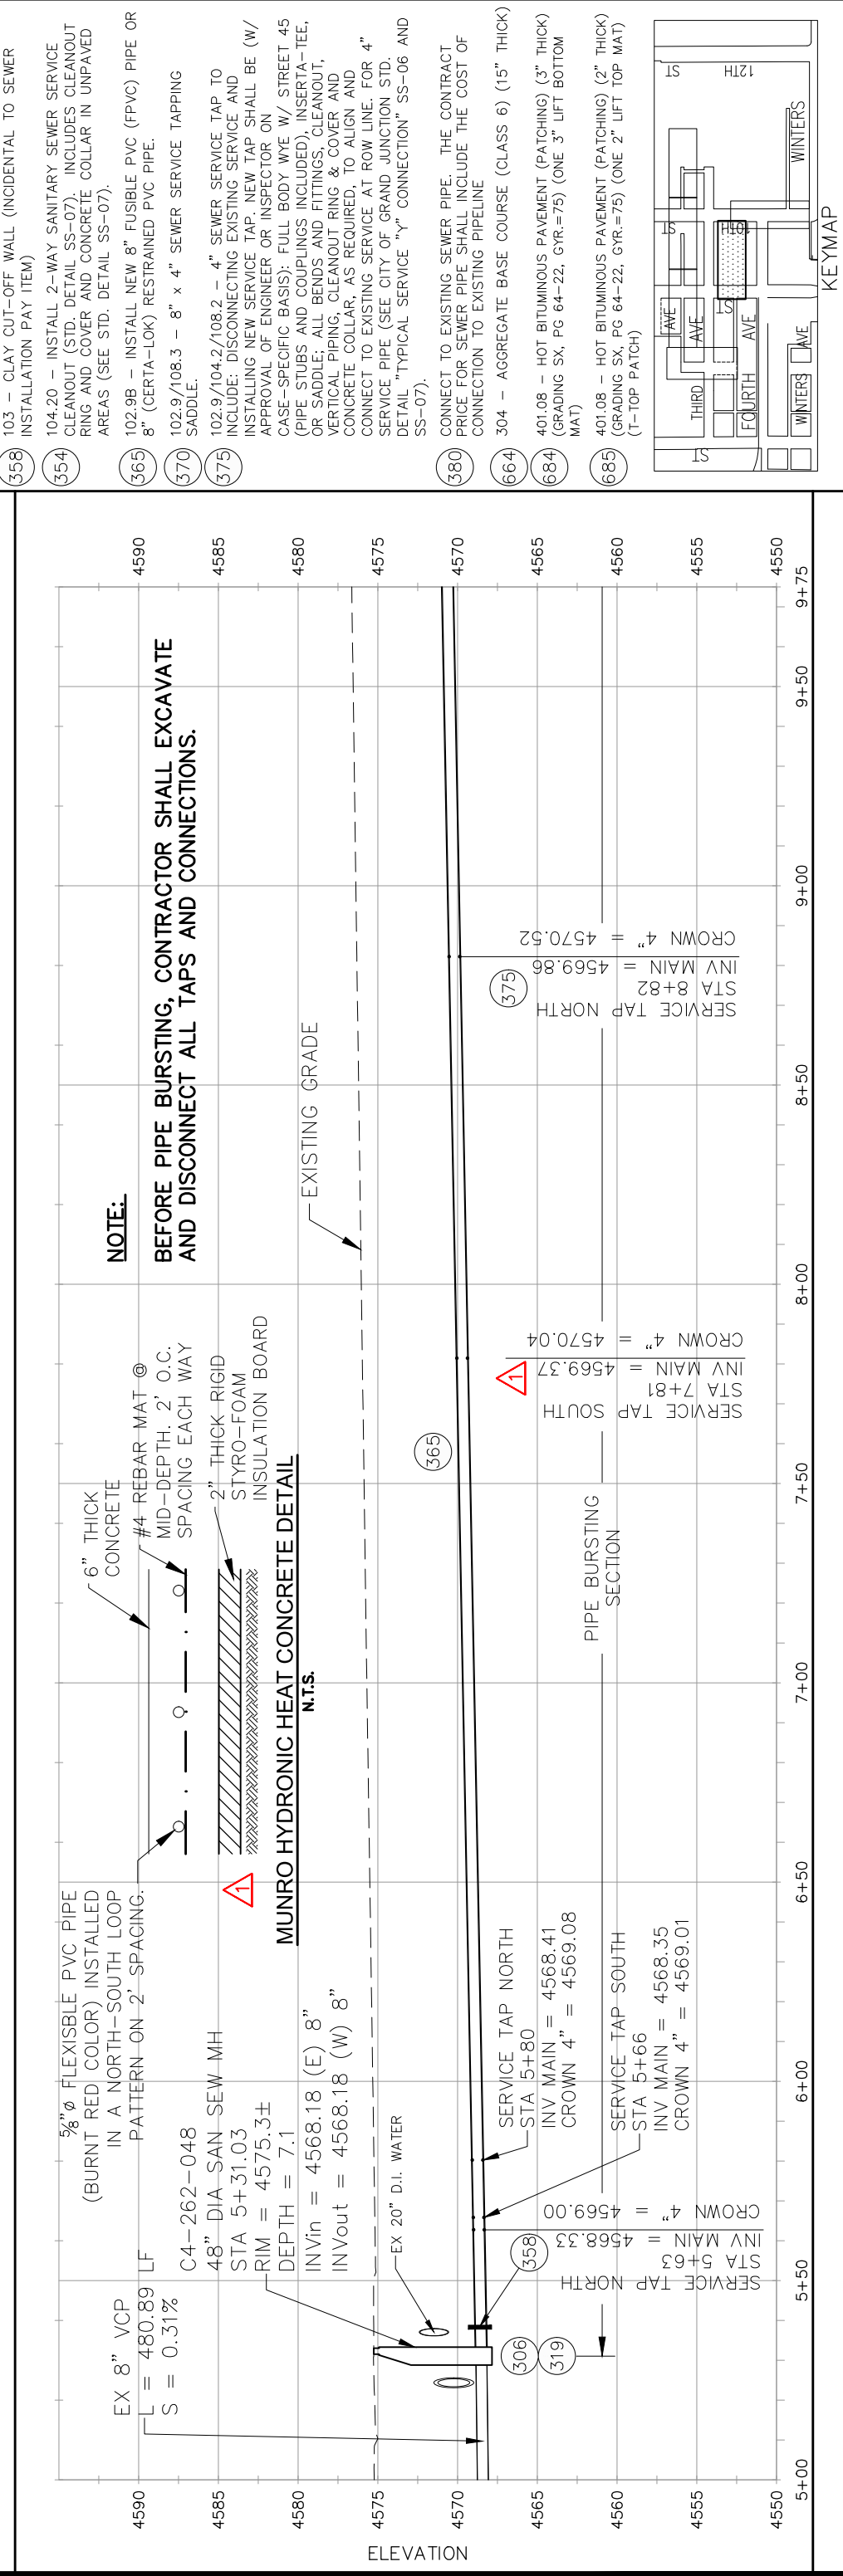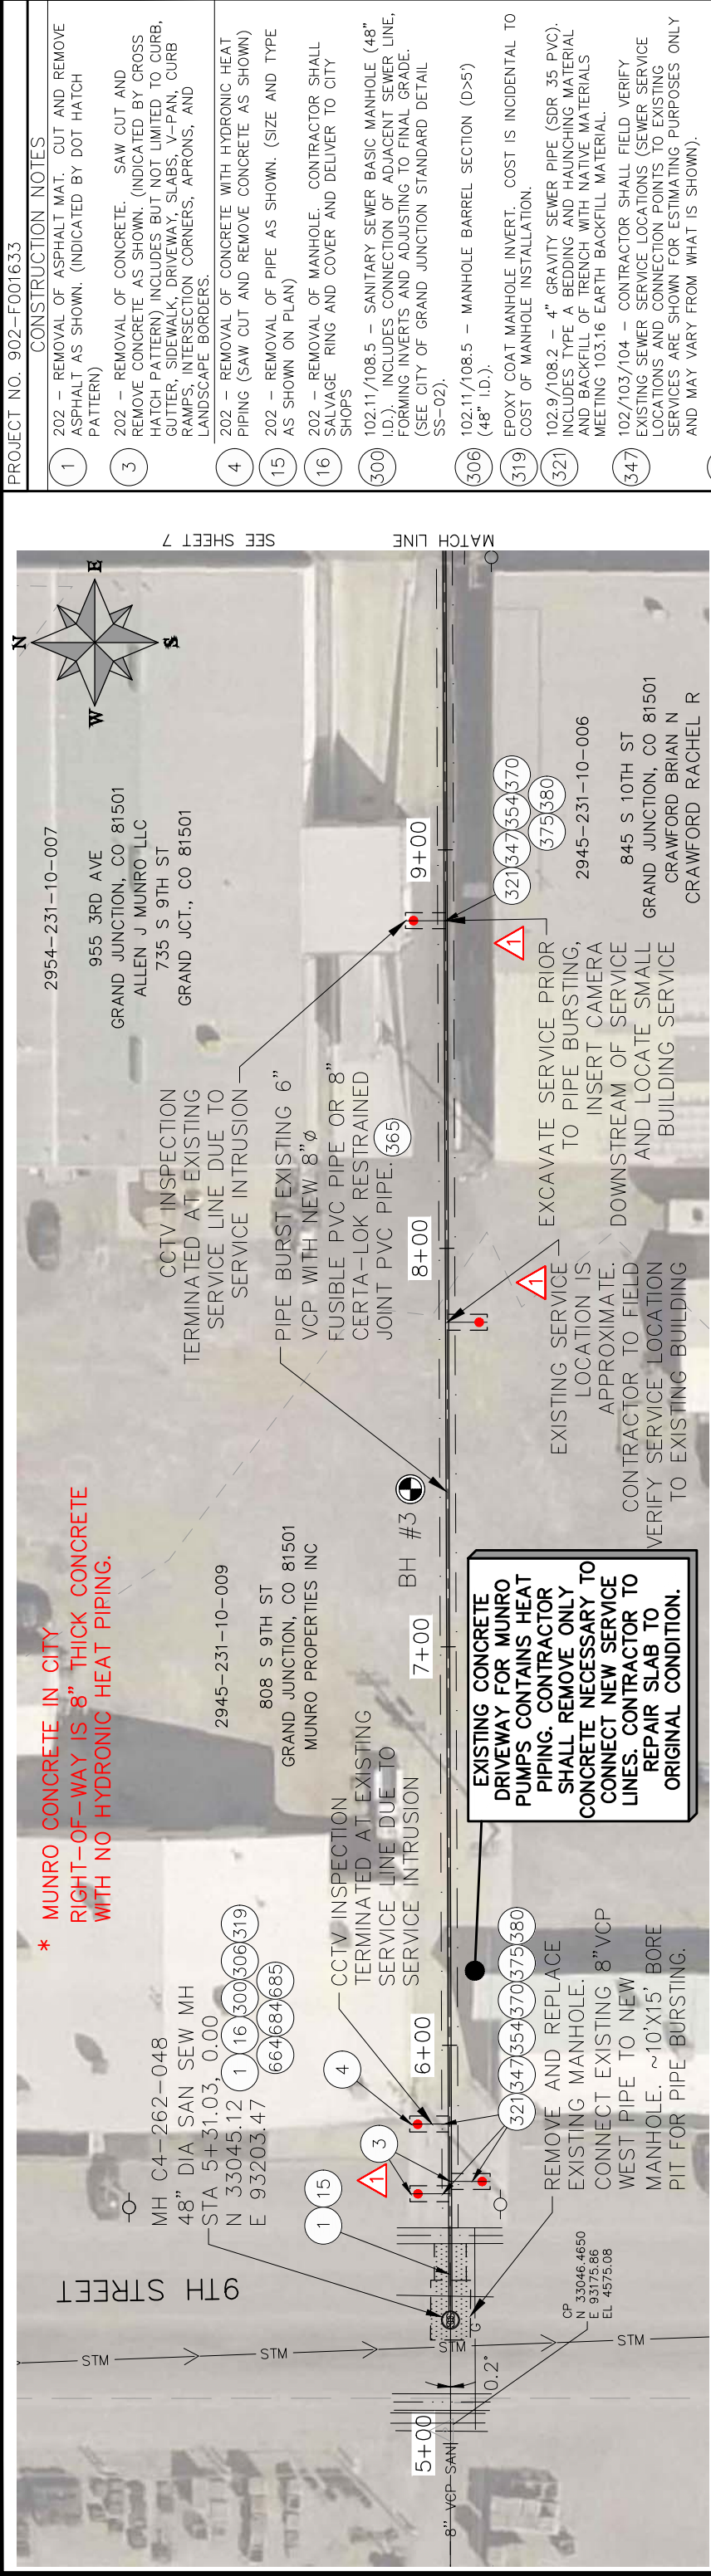


PROJECT NO. 902-F001633

- CONSTRUCTION NOTES**
- 1 202 - REMOVAL OF ASPHALT MAT. CUT AND REMOVE ASPHALT AS SHOWN. (INDICATED BY DOT HATCH PATTERN)
 - 3 202 - REMOVAL OF CONCRETE. SAW CUT AND REMOVE CONCRETE AS SHOWN. (INDICATED BY CROSS HATCH PATTERN) INCLUDES BUT NOT LIMITED TO CURB, GUTTER, SIDEWALK, DRIVEWAY, SLABS, V-PAN, CURB RAMPS, INTERSECTION CORNERS, APRONS, AND LANDSCAPE BORDERS.
 - 4 202 - REMOVAL OF CONCRETE WITH HYDRONIC HEAT PIPING (SAW CUT AND REMOVE CONCRETE AS SHOWN)
 - 15 202 - REMOVAL OF PIPE AS SHOWN. (SIZE AND TYPE AS SHOWN ON PLAN)
 - 16 202 - REMOVAL OF MANHOLE. CONTRACTOR SHALL SALVAGE RING AND COVER AND DELIVER TO CITY SHOPS
 - 300 102.11/108.5 - SANITARY SEWER BASIC MANHOLE (48\"/>

- 306 102.11/108.5 - MANHOLE BARREL SECTION (D>5) (48\"/>

- 319 EPOXY COAT MANHOLE INVERT. COST IS INCIDENTAL TO COST OF MANHOLE INSTALLATION.
- 321 102.9/108.2 - 4\"/>

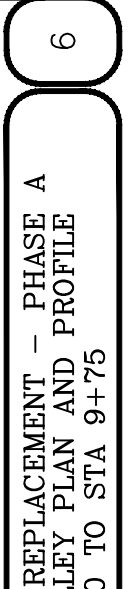

SEE SHEET 7

MATCH LINE

2954-231-10-007

955 3RD AVE

GRAND JUNCTION, CO 81501

ALLEN J MUNRO LLC

735 S 9TH ST

GRAND JCT., CO 81501

2945-231-10-009

808 S 9TH ST

GRAND JUNCTION, CO 81501

MUNRO PROPERTIES INC

2945-231-10-009

845 S 10TH ST

GRAND JUNCTION, CO 81501

CRAWFORD BRIAN N

CRAWFORD RACHEL R

2945-231-10-006

845 S 10TH ST

GRAND JUNCTION, CO 81501

CRAWFORD BRIAN N

CRAWFORD RACHEL R

2945-231-10-006

845 S 10TH ST

GRAND JUNCTION, CO 81501

CRAWFORD BRIAN N

CRAWFORD RACHEL R

2945-231-10-006

845 S 10TH ST

GRAND JUNCTION, CO 81501

CRAWFORD BRIAN N

CRAWFORD RACHEL R

2945-231-10-006

845 S 10TH ST

GRAND JUNCTION, CO 81501

CRAWFORD BRIAN N

CRAWFORD RACHEL R

2945-231-10-006

2018 SEWER LINE REPLACEMENT - PHASE A
4TH AVENUE ALLEY PLAN AND PROFILE
STA 5+00 TO STA 9+75

PUBLIC WORKS
ENGINEERING DIVISION

CITY OF
Grand Junction
COLORADO


REVISION Δ ADDENDUM #1 - REVISED PLANS - 04/09/18
DATE 03/20/18
DRAWN BY BCH
DESIGNED BY BCH
CHECKED BY ALC
APPROVED BY ALC

SCALES: PLAN & PROFILE
HORIZONTAL: 1" = 40'
VERTICAL: 1" = 10'


DATE 03/20/18
DATE 03/20/18
DATE
DATE

6

- 1 202 - REMOVAL OF ASPHALT MAT. CUT AND REMOVE ASPHALT AS SHOWN. (INDICATED BY DOT HATCH PATTERN)
- 3 202 - REMOVAL OF CONCRETE. SAW CUT AND REMOVE CONCRETE AS SHOWN. (INDICATED BY CROSS HATCH PATTERN) INCLUDES BUT NOT LIMITED TO CURB, GUTTER, SIDEWALK, DRIVEWAY, SLABS, V-PAN, CURB RAMPS, INTERSECTION CORNERS, APRONS, AND LANDSCAPE BORDERS.
- 15 202 - REMOVAL OF PIPE AS SHOWN. (SIZE AND TYPE AS SHOWN ON PLAN)
- 16 202 - REMOVAL OF MANHOLE. CONTRACTOR SHALL SALVAGE RING AND COVER AND DELIVER TO CITY SHOPS
- 300 102.11/108.5 - SANITARY SEWER BASIC MANHOLE (48" I.D.). INCLUDES CONNECTION OF ADJACENT SEWER LINE, FORMING INVERTS AND ADJUSTING TO FINAL GRADE. (SEE CITY OF GRAND JUNCTION STANDARD DETAIL SS-02).
- 306 102.11/108.5 - MANHOLE BARREL SECTION (D>S) (48" I.D.).
- 319 EPOXY COAT MANHOLE INVERT. COST IS INCIDENTAL TO COST OF MANHOLE INSTALLATION.
- 321 102.9/108.2 - 4" GRAVITY SEWER PIPE (SDR 35 PVC). INCLUDES TYPE A BEDDING AND HAUNCHING MATERIAL AND BACKFILL OF TRENCH WITH NATIVE MATERIALS MEETING 103.16 EARTH BACKFILL MATERIAL.
- 323 102.9/108.2 - 8" GRAVITY SEWER PIPE (SDR 35 PVC). INCLUDES TYPE A BEDDING AND HAUNCHING MATERIAL AND BACKFILL OF TRENCH WITH NATIVE MATERIALS MEETING 103.16 EARTH BACKFILL MATERIAL.
- 347 102/103/104 - CONTRACTOR SHALL FIELD VERIFY EXISTING SEWER SERVICE LOCATIONS (SEWER SERVICE LOCATIONS AND CONNECTION POINTS TO EXISTING SERVICES ARE SHOWN FOR ESTIMATING PURPOSES ONLY AND MAY VARY FROM WHAT IS SHOWN).
- 354 104.20 - INSTALL 2-WAY SANITARY SEWER SERVICE CLEANOUT (STD. DETAIL SS-07). INCLUDES CLEANOUT RING AND COVER AND CONCRETE COLLAR IN UNPAVED AREAS (SEE STD. DETAIL SS-07).
- 358 103 - CLAY CUT-OFF WALL (INCIDENTAL TO SEWER INSTALLATION PAY ITEM)
- 365 102.9B - INSTALL NEW 8" FUSIBLE PVC (FPVC) PIPE OR 8" (CERTA-LOK) RESTRAINED PVC PIPE.
- 369 102.9/108.3 - 8" x 4" SEWER SERVICE TAP. FULL BODY WYE (SEE STD. DETAIL SS-06).
- 370 102.9/108.3 - 8" x 4" SEWER SERVICE TAPPING SADDLE.
- 375 102.9/104.2/108.2 - 4" SEWER SERVICE TAP TO INCLUDE: DISCONNECTING EXISTING SERVICE AND INSTALLING NEW SERVICE TAP. NEW TAP SHALL BE (W/ APPROVAL OF ENGINEER OR INSPECTOR ON CASE-SPECIFIC BASIS); FULL BODY WYE W/ STREET 45 (PIPE STUBS AND COUPLINGS INCLUDED), INSERTA-TEE, OR SADDLE; ALL BENDS AND FITTINGS, CLEANOUT, VERTICAL PIPING, CLEANOUT RING & COVER AND CONCRETE COLLAR, AS REQUIRED, TO ALIGN AND CONNECT TO EXISTING SERVICE AT ROW LINE. FOR 4" SERVICE PIPE (SEE CITY OF GRAND JUNCTION STD. DETAIL "TYPICAL SERVICE "Y" CONNECTION" SS-06 AND SS-07).
- 380 CONNECT TO EXISTING SEWER PIPE. THE CONTRACT PRICE FOR SEWER PIPE SHALL INCLUDE THE COST OF CONNECTION TO EXISTING PIPELINE
- 577 608.06 - CONCRETE DRIVEWAY SECTION (MATCH IN KIND) (INCLUDES #5 REBAR TIE-BARS @ 12" O.C.) (EPOXY COATED TIE-BARS) (18" LONG)
- 582 608.06 - CONCRETE DRAINAGE PAN (MATCH IN KIND)
- 664 304 - AGGREGATE BASE COURSE (CLASS 6) (15" THICK)
- 667 304 - AGGREGATE BASE COURSE (CLASS 6) (6" THICK)
- 683 401.08 - HOT BITUMINOUS PAVEMENT (PATCHING) (5" THICK) (GRADING SX, PG 64-22, GYR.=75) (TWO LIFTS)
- 780 208 - STORM DRAIN INLET PROTECTION (SILT-SACK) (INCLUDES MAINTENANCE AND REMOVAL OF DIRT AND DEBRIS)
- 846 POTHOLE EXISTING UTILITY AHEAD OF CONSTRUCTION. COORDINATE ANY NEEDED DESIGN CHANGES WITH PROJECT ENGINEER SO AS TO AVOID UTILITY CONFLICTS.

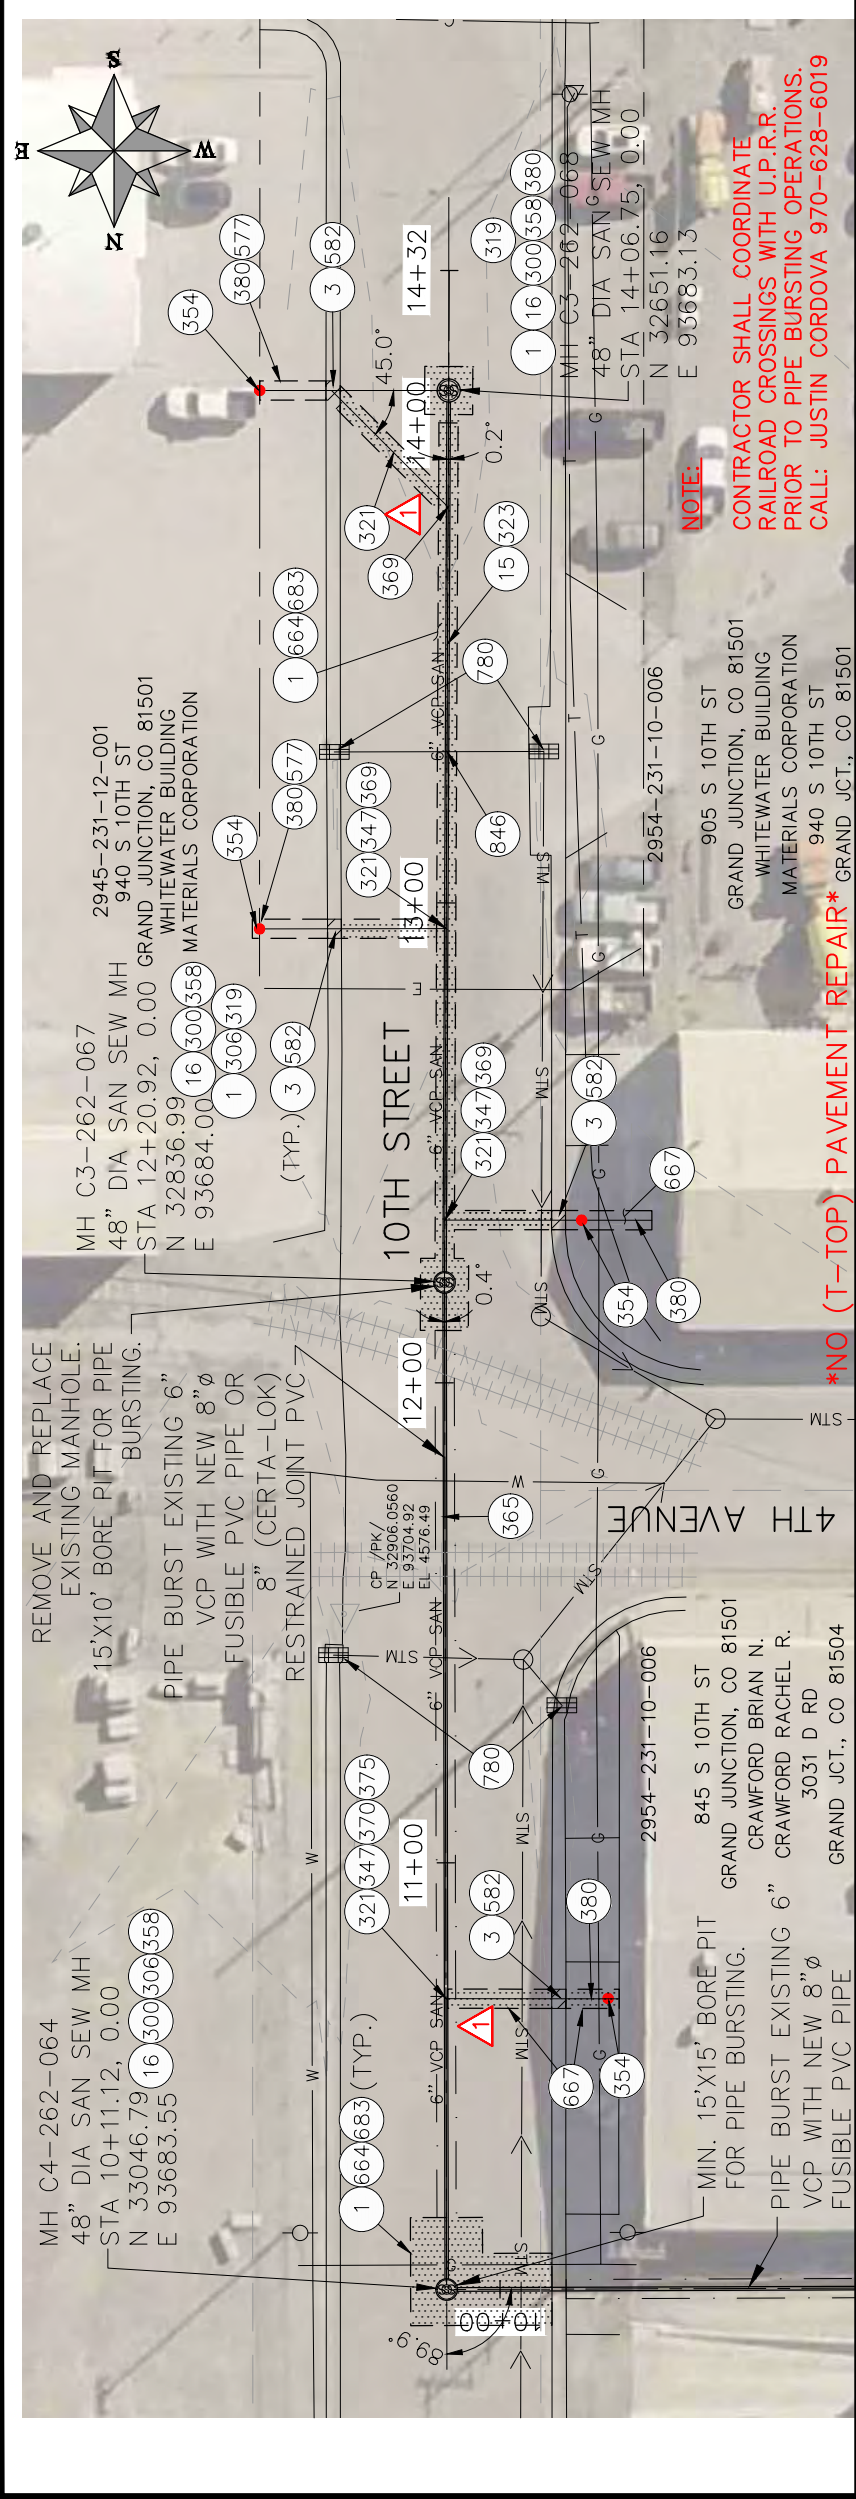

REMOVE AND REPLACE EXISTING MANHOLE. 15'X10' BORE PIT FOR PIPE BURSTING. PIPE BURST EXISTING 6" VCP WITH NEW 8" FUSIBLE PVC PIPE OR 8" (CERTA-LOK) RESTRAINED JOINT PVC. CP /PK/ 0560 N 32906.0560 E 93704.92 EL. 4576.45. MIN. 15'X15' BORE PIT FOR PIPE BURSTING. PIPE BURST EXISTING 6" VCP WITH NEW 8" FUSIBLE PVC PIPE. 2954-231-10-006 845 S 10TH ST GRAND JUNCTION, CO 81501 CRAWFORD BRIAN N. CRAWFORD RACHEL R. 3031 D RD GRAND JCT., CO 81504 SEE SHEET 6

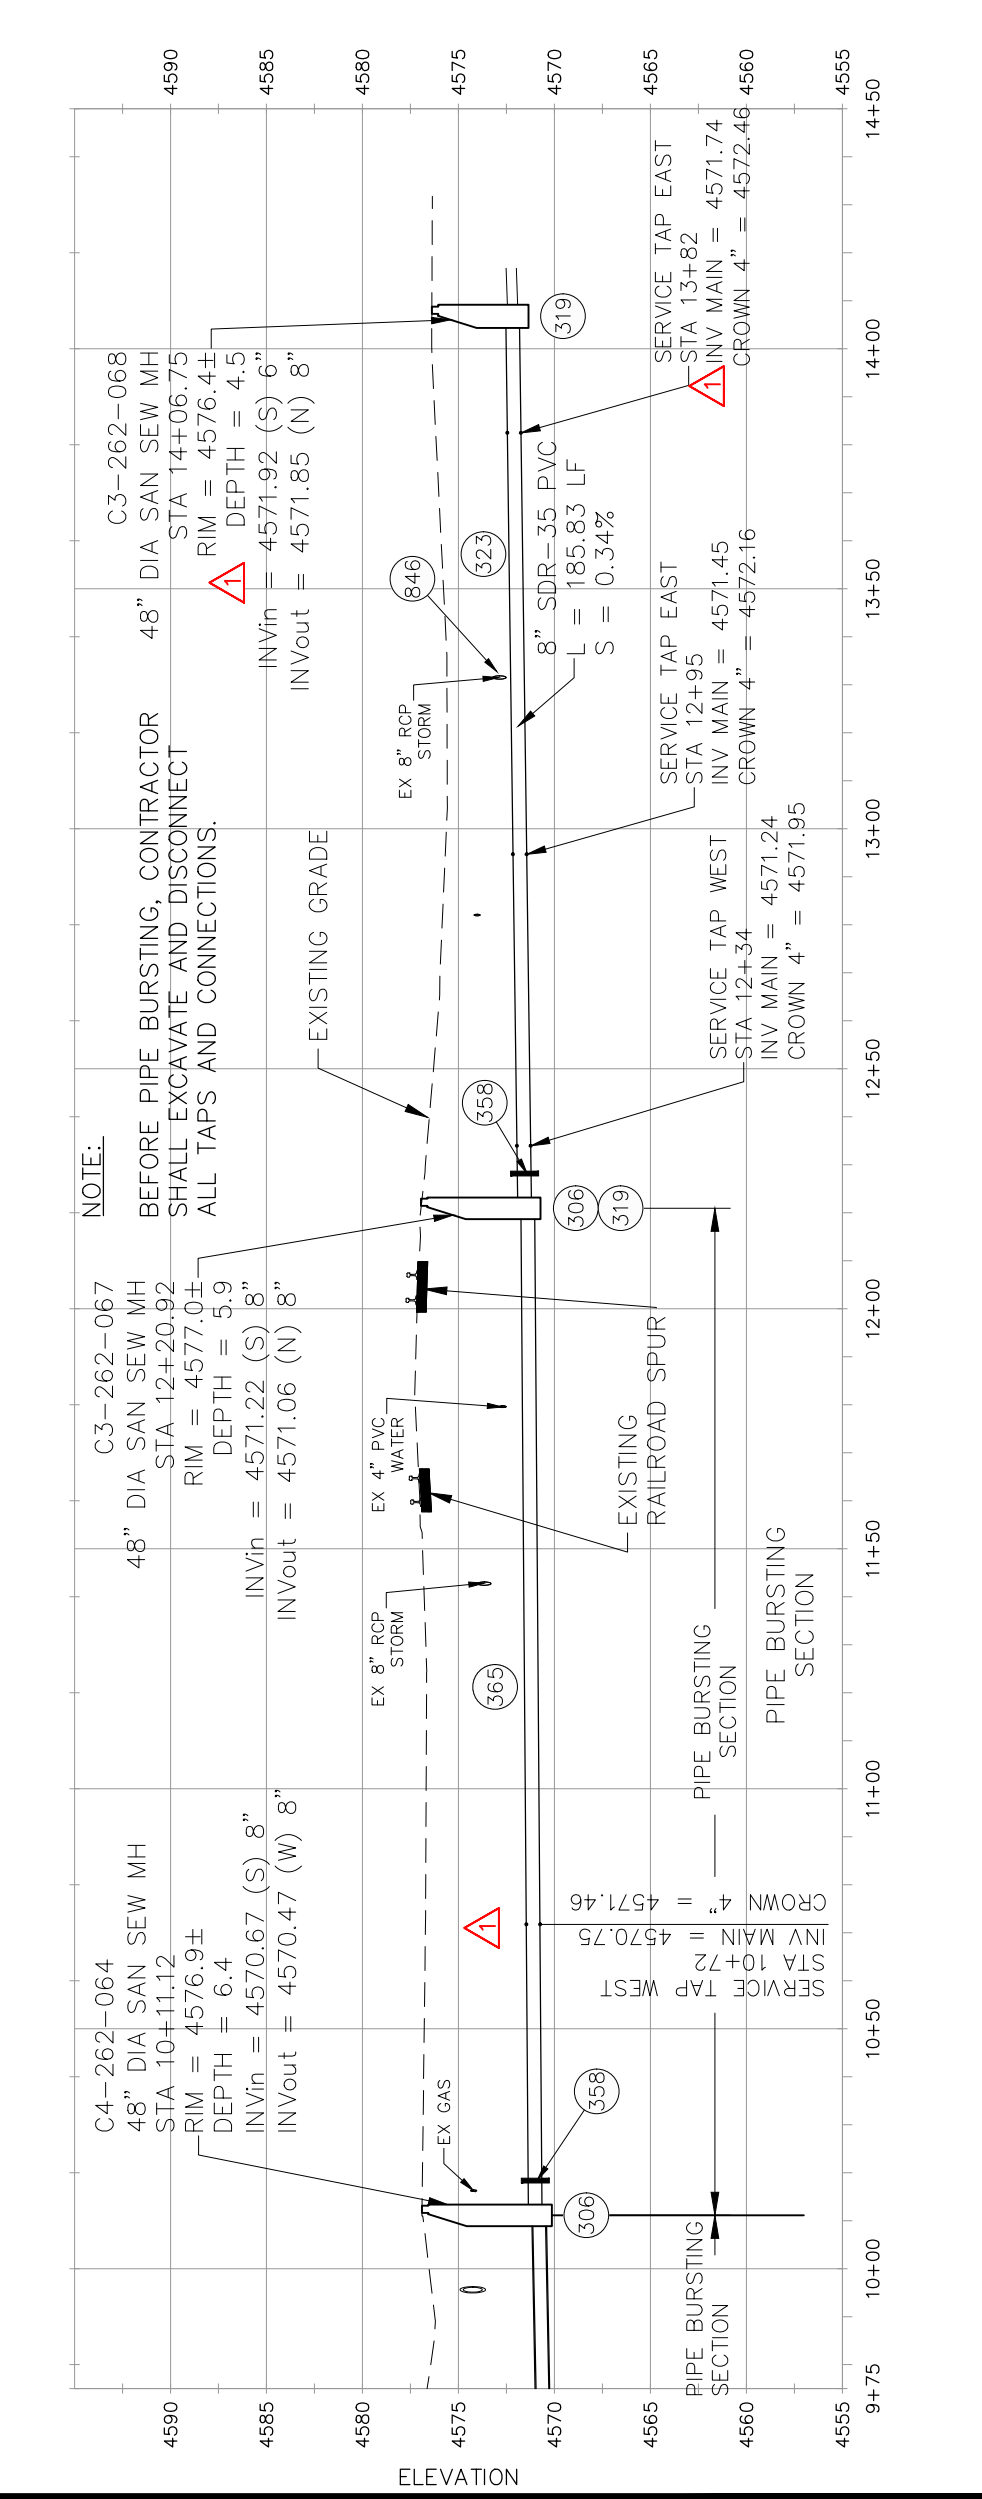

CONTRACTOR SHALL COORDINATE RAILROAD CROSSINGS WITH U.P.R.R. PRIOR TO PIPE BURSTING OPERATIONS. CALL: JUSTIN CORDOVA 970-628-6019

BEFORE PIPE BURSTING, CONTRACTOR SHALL EXCAVATE AND DISCONNECT ALL TAPS AND CONNECTIONS.

CONTRACTOR SHALL COORDINATE RAILROAD CROSSINGS WITH U.P.R.R. PRIOR TO PIPE BURSTING OPERATIONS. CALL: JUSTIN CORDOVA 970-628-6019

NO (T-TOP) PAVEMENT REPAIR* GRAND JCT., CO 81501

REVISION **A** ADDENDUM #1 - REVISED PLANS - DATE 04/09/18

DRAWN BY: BCH DATE: 03/20/18

DESIGNED BY: BCH DATE: 03/20/18

CHECKED BY: ALC DATE: _____

APPROVED BY: ALC DATE: _____

SCALES: PLAN & PROFILE

HORIZONTAL: 1" = 40'

VERTICAL: 1" = 10'

DESCRIPTION

2018 SEWER LINE REPLACEMENT - PHASE A

S 10TH STREET PLAN AND PROFILE

STA 9+75 TO STA 14+50





PUBLIC WORKS ENGINEERING DIVISION

CITY OF Grand Junction COLORADO

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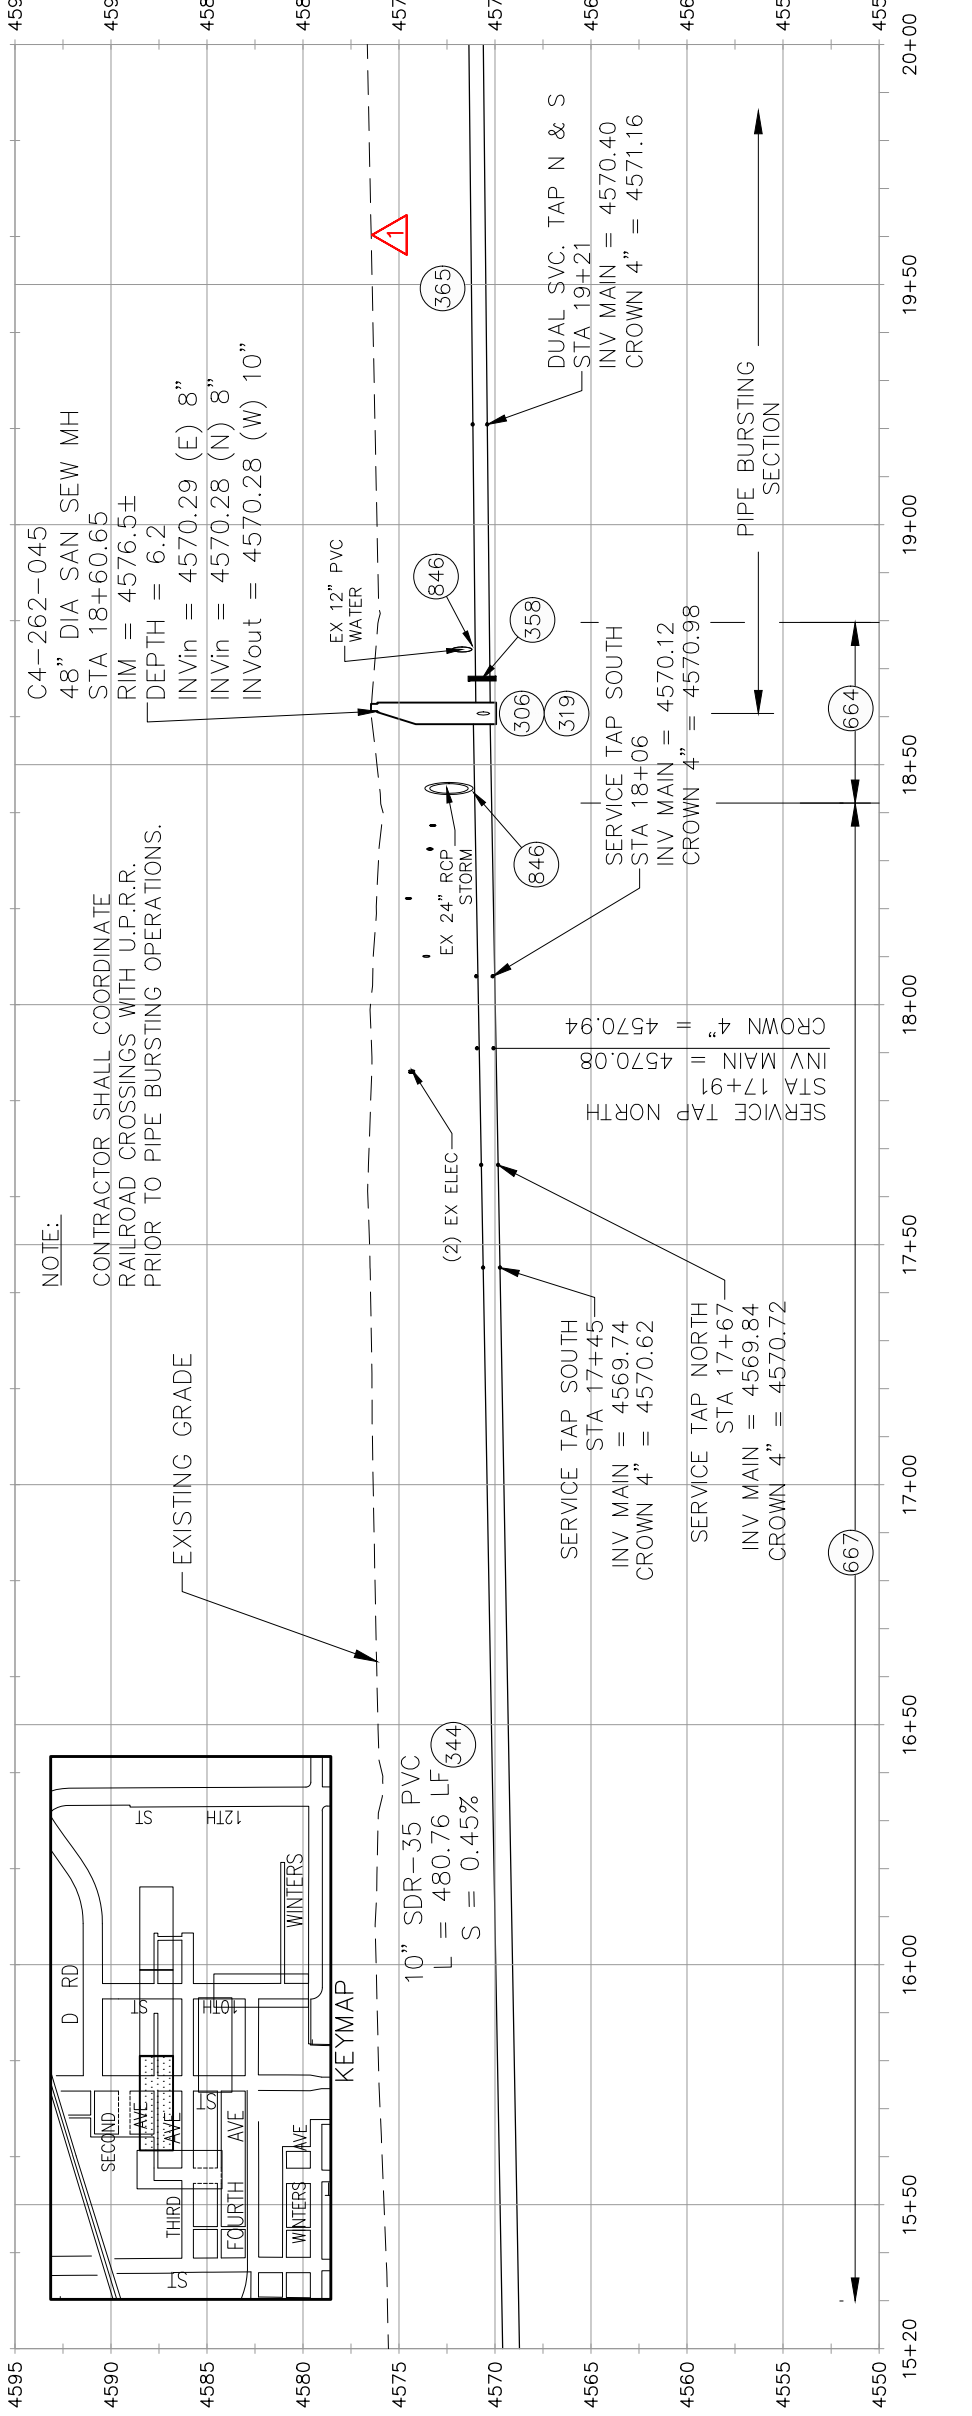
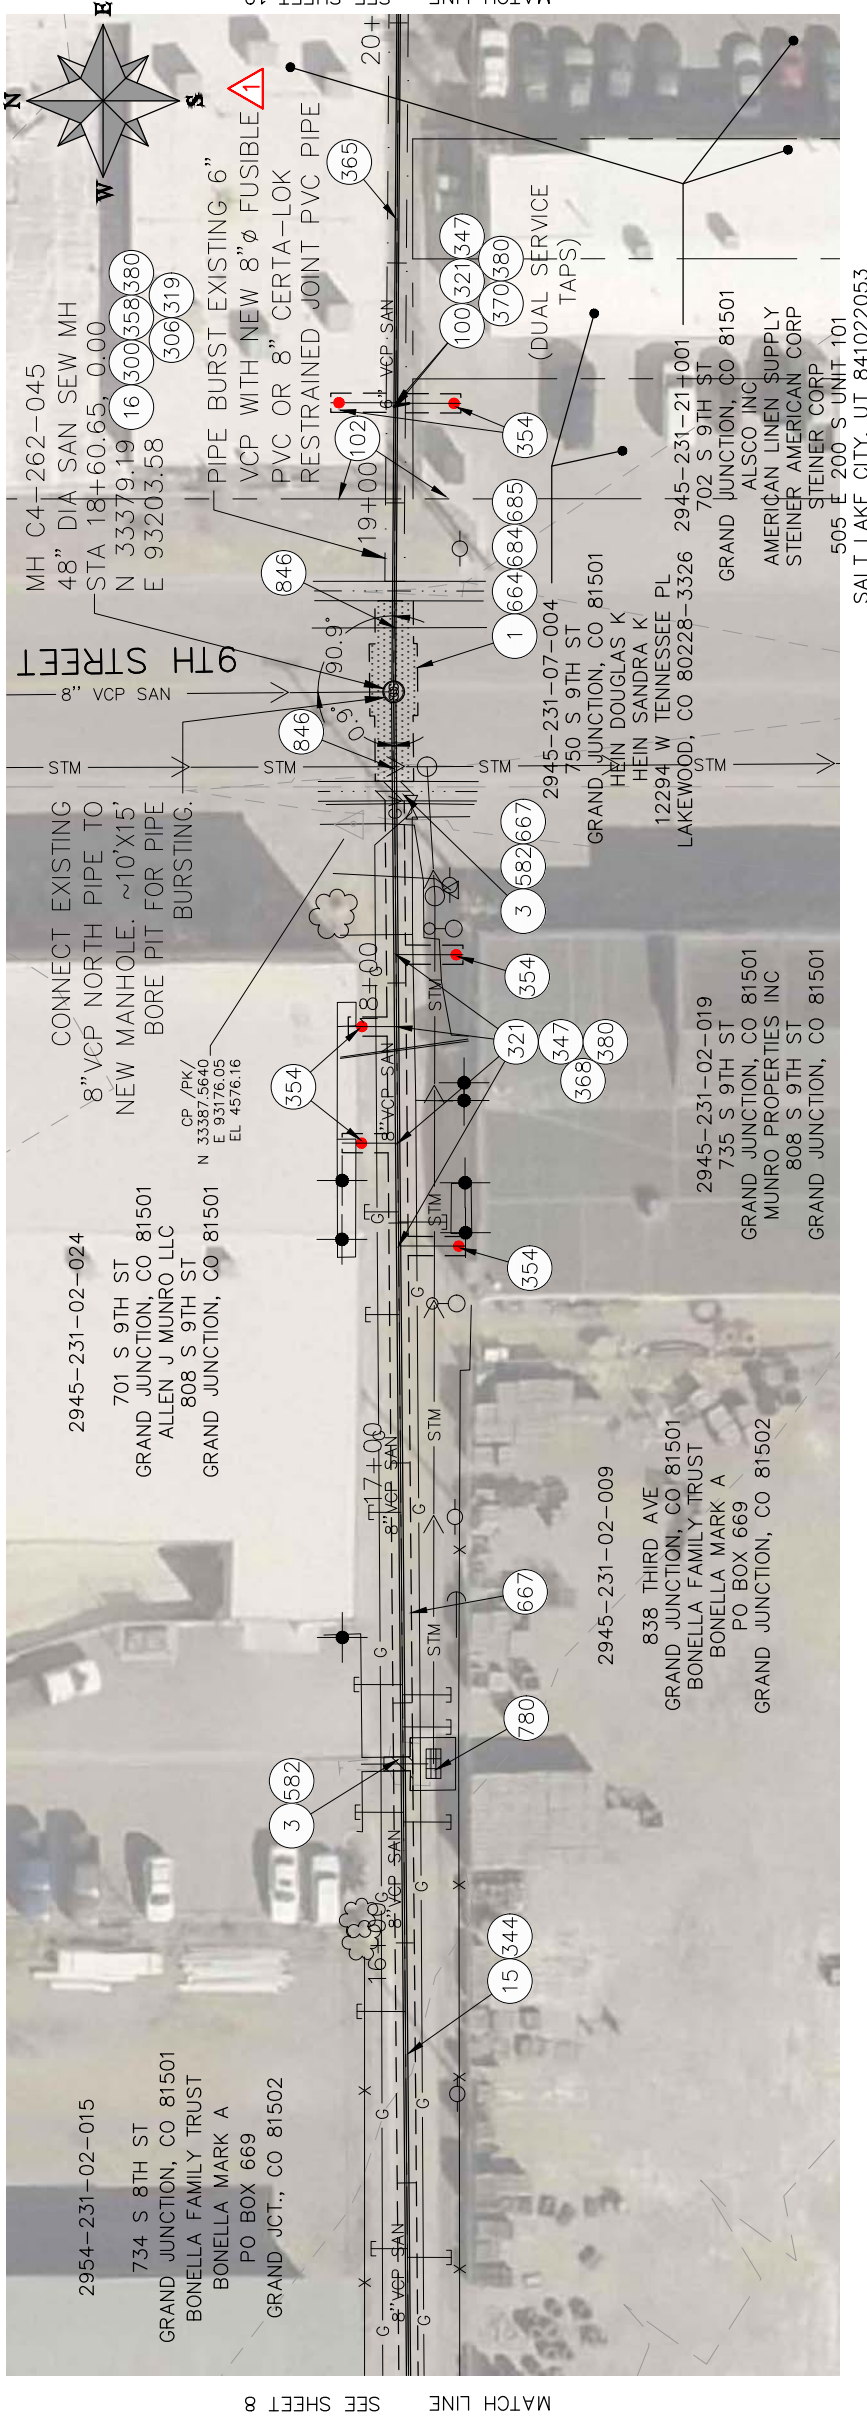
CONSTRUCTION NOTES

- 1 202 - REMOVAL OF ASPHALT MAT. CUT AND REMOVE ASPHALT AS SHOWN. (INDICATED BY DOT HATCH PATTERN)
- 15 202 - REMOVAL OF PIPE AS SHOWN. (SIZE AND TYPE AS SHOWN ON PLAN)
- 16 202 - REMOVAL OF MANHOLE. CONTRACTOR SHALL SALVAGE RING AND COVER AND DELIVER TO CITY SHOPS
- 300 102.11/108.5 - SANITARY SEWER BASIC MANHOLE (48" I.D.). INCLUDES CONNECTION OF ADJACENT SEWER LINE, FORMING INVERTS AND ADJUSTING TO FINAL GRADE. (SEE CITY OF GRAND JUNCTION STANDARD DETAIL SS-02).
- 306 102.11/108.5 - MANHOLE BARREL SECTION (D>5) (48" I.D.).
- 319 EPOXY COAT MANHOLE INVERT. COST IS INCIDENTAL TO COST OF MANHOLE INSTALLATION.
- 321 102.9/108.2 - 4" GRAVITY SEWER PIPE (SDR 35 PVC). INCLUDES TYPE A BEDDING AND HAUNCHING MATERIAL AND BACKFILL OF TRENCH WITH NATIVE MATERIALS MEETING 103.16 EARTH BACKFILL MATERIAL.
- 344 102.9/108.2 - 10" GRAVITY SEWER PIPE (SDR 35 PVC). INCLUDES TYPE A BEDDING AND HAUNCHING MATERIAL AND BACKFILL OF TRENCH WITH NATIVE MATERIALS MEETING 103.16 EARTH BACKFILL MATERIAL.
- 347 102/103/104 - CONTRACTOR SHALL FIELD VERIFY EXISTING SEWER SERVICE LOCATIONS (SEWER SERVICE LOCATIONS AND CONNECTION POINTS TO EXISTING SERVICES ARE SHOWN FOR ESTIMATING PURPOSES ONLY AND MAY VARY FROM WHAT IS SHOWN).
- 354 104.20 - INSTALL 2-WAY SANITARY SEWER SERVICE CLEANOUT (STD. DETAIL SS-07). INCLUDES CLEANOUT RING AND COVER AND CONCRETE COLLAR IN UNPAVED AREAS (SEE STD. DETAIL SS-07).
- 358 103 - CLAY CUT-OFF WALL (INCIDENTAL TO SEWER INSTALLATION PAY ITEM)
- 368 102.9/108.3 - 10" x 4" SEWER SERVICE TAP. FULL BODY WYE (SEE STD. DETAIL SS-06).
- 380 CONNECT TO EXISTING SEWER PIPE. THE CONTRACT PRICE FOR SEWER PIPE SHALL INCLUDE THE COST OF CONNECTION TO EXISTING PIPELINE
- 664 304 - AGGREGATE BASE COURSE (CLASS 6) (15" THICK)
- 667 304 - AGGREGATE BASE COURSE (CLASS 6) (6" THICK)
- 684 401.08 - HOT BITUMINOUS PAVEMENT (PATCHING) (3" THICK) (GRADING SX, PG 64-22, GYR.=75) (ONE 3" LIFT BOTTOM MAT)
- 685 401.08 - HOT BITUMINOUS PAVEMENT (PATCHING) (2" THICK) (GRADING SX, PG 64-22, GYR.=75) (ONE 2" LIFT TOP MAT) (1-TOP PATCH)
- 780 208 - STORM DRAIN INLET PROTECTION (SILT-SACK) (INCLUDES MAINTENANCE AND REMOVAL OF DIRT AND DEBRIS)
- 846 POT-HOLE EXISTING UTILITY AHEAD OF CONSTRUCTION. COORDINATE ANY NEEDED DESIGN CHANGES WITH PROJECT ENGINEER SO AS TO AVOID UTILITY CONFLICTS.

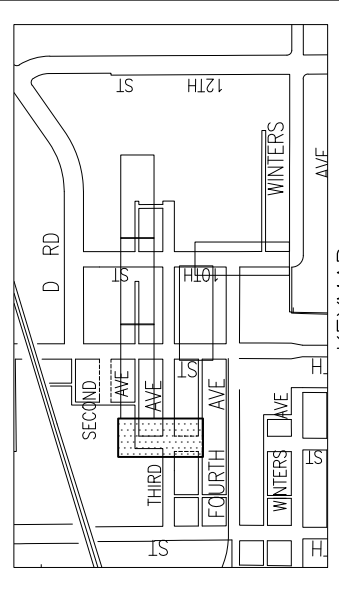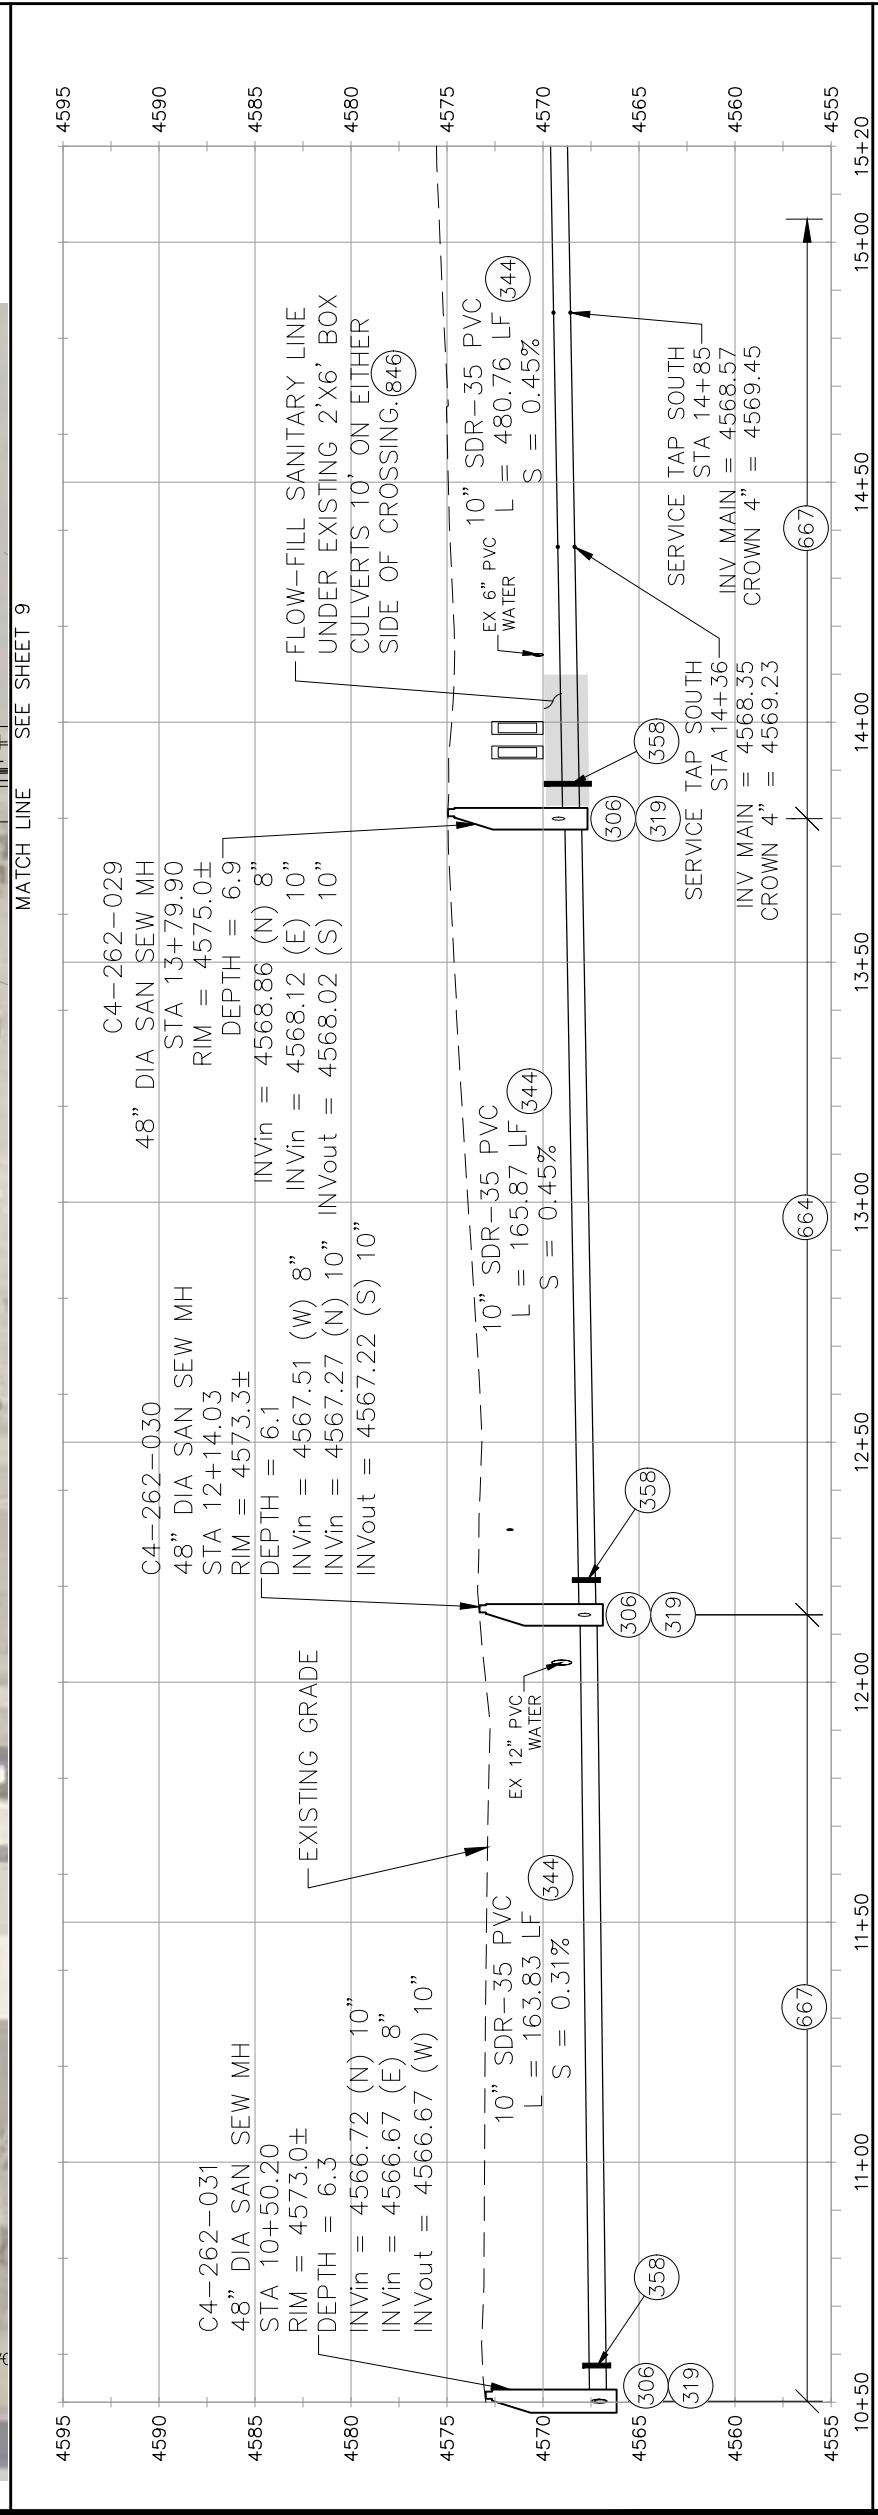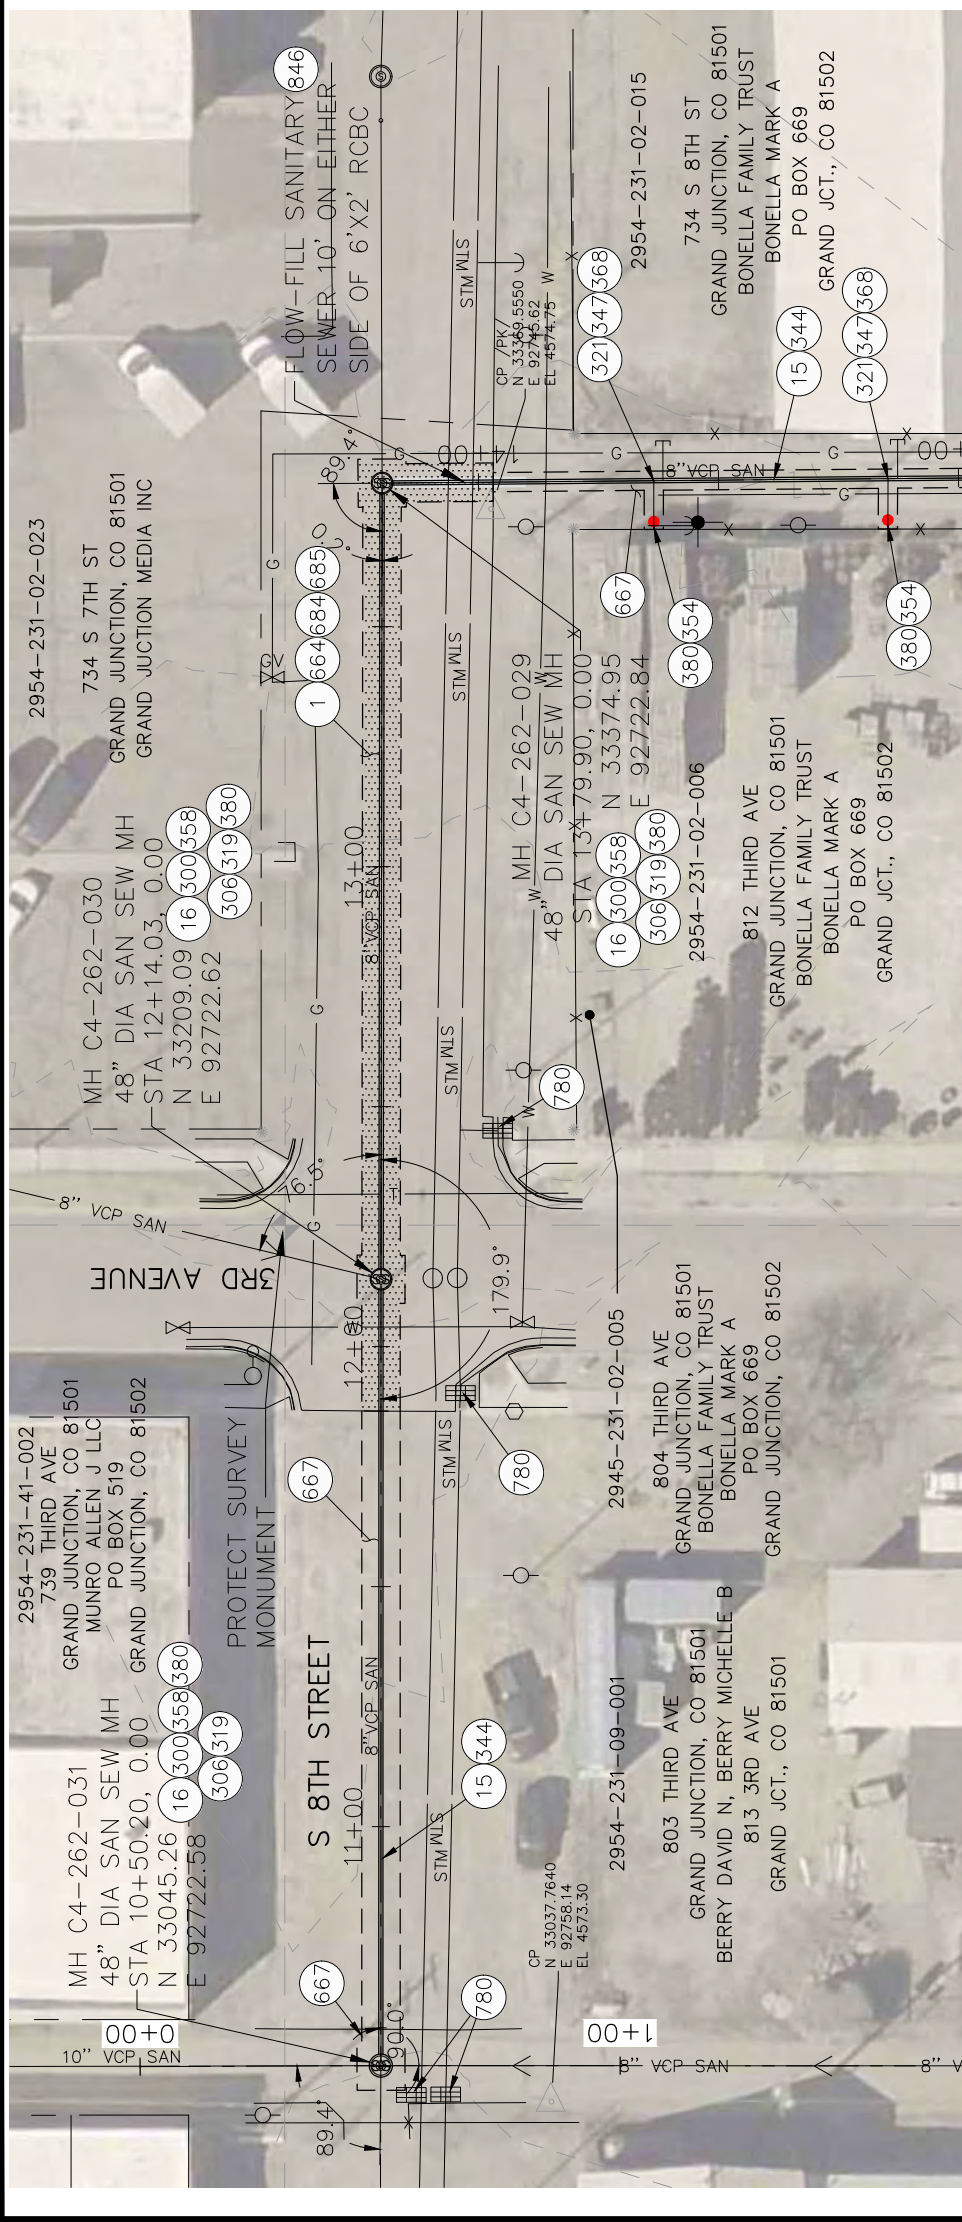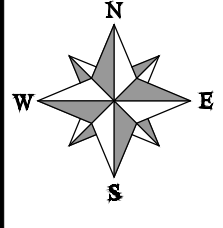

REVISION Δ _____ DATE _____ REVISION Δ _____ DATE _____ REVISION Δ _____ DATE _____ REVISION Δ _____ DATE _____	DRAWN BY _____ DATE _____ DESIGNED BY _____ DATE _____ CHECKED BY _____ DATE _____ APPROVED BY _____ DATE _____	SCALES: PLAN & PROFILE HORIZONTAL: 1" = 40' 10' = 20' 20' = 40' VERTICAL: 1" = 10' 0' = 2.5' 5' = 10'	Grand Junction COLORADO	PUBLIC WORKS ENGINEERING DIVISION	2018 SEWER LINE REPLACEMENT - PHASE A S 8TH STREET PLAN AND PROFILE STA 10+50 TO STA 15+20
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- CONSTRUCTION NOTES**
- 1 202 - REMOVAL OF ASPHALT MAT, CUT AND REMOVE ASPHALT AS SHOWN. (INDICATED BY DOT HATCH PATTERN)
 - 3 202 - REMOVAL OF CONCRETE. SAW CUT AND REMOVE CONCRETE AS SHOWN. (INDICATED BY CROSS HATCH PATTERN) INCLUDES BUT NOT LIMITED TO CURB, GUTTER, SIDEWALK, DRIVEWAY, SLABS, V-PAN, CURB RAMPS, INTERSECTION CORNERS, APRONS, AND LANDSCAPE BORDERS.
 - 15 202 - REMOVAL OF PIPE AS SHOWN. (SIZE AND TYPE AS SHOWN ON PLAN)
 - 16 202 - REMOVAL OF MANHOLE. CONTRACTOR SHALL SALVAGE RING AND COVER AND DELIVER TO CITY SHOPS
 - 100 210 - RESET LANDSCAPE GROUND COVER (ROCK)
 - 102 210 - RESET FENCE. CONTRACTOR TO SUPPLY AND INSTALL ANY NEW MATERIALS REQUIRED TO RESTORE THE FENCE TO ACCEPTABLE CONDITION EXCEPT FOR NEW POSTS. (HEIGHT AND MATERIAL AS SHOWN ON PLAN)
 - 300 102.11/108.5 - SANITARY SEWER BASIC MANHOLE (48" I.D.). INCLUDES CONNECTION OF ADJACENT SEWER LINE, FORMING INVERTS AND ADJUSTING TO FINAL GRADE. (SEE CITY OF GRAND JUNCTION STANDARD DETAIL SS-02).
 - 306 102.11/108.5 - MANHOLE BARREL SECTION (D>S) (48" I.D.).
 - 319 EPOXY COAT MANHOLE INVERT. COST IS INCIDENTAL TO COST OF MANHOLE INSTALLATION.
 - 321 102.9/108.2 - 4" GRAVITY SEWER PIPE (SDR 35 PVC). INCLUDES TYPE A BEDDING AND HAUNCHING MATERIAL AND BACKFILL OF TRENCH WITH NATIVE MATERIALS MEETING 103.16 EARTH BACKFILL MATERIAL.
 - 344 102.9/108.2 - 10" GRAVITY SEWER PIPE (SDR 35 PVC). INCLUDES TYPE A BEDDING AND HAUNCHING MATERIAL AND BACKFILL OF TRENCH WITH NATIVE MATERIALS MEETING 103.16 EARTH BACKFILL MATERIAL.
 - 347 102/103/104 - CONTRACTOR SHALL FIELD VERIFY EXISTING SEWER SERVICE LOCATIONS (SEWER SERVICE LOCATIONS AND CONNECTION POINTS TO EXISTING SERVICES ARE SHOWN FOR ESTIMATING PURPOSES ONLY AND MAY VARY FROM WHAT IS SHOWN).
 - 354 104.20 - INSTALL 2-WAY SANITARY SEWER SERVICE CLEANOUT (STD. DETAIL SS-07). INCLUDES CLEANOUT RING AND COVER AND CONCRETE COLLAR IN UNPAVED AREAS (SEE STD. DETAIL SS-07).
 - 358 103 - CLAY CUT-OFF WALL (INCIDENTAL TO SEWER INSTALLATION PAY ITEM)
 - 365 102.9B - INSTALL NEW 8" FUSIBLE PVC (FPVC) PIPE OR 8" (CERTA-LOK) RESTRAINED PVC PIPE.
 - 368 102.9/108.3 - 10" x 4" SEWER SERVICE TAP. FULL BODY WYE (SEE STD. DETAIL SS-06).
 - 370 102.9/108.3 - 8" x 4" SEWER SERVICE TAPPING SADDLE.
 - 380 CONNECT TO EXISTING SEWER PIPE. THE CONTRACT PRICE FOR SEWER PIPE SHALL INCLUDE THE COST OF CONNECTION TO EXISTING PIPELINE
 - 582 608.06 - CONCRETE DRAINAGE PAN (MATCH IN KIND)
 - 664 304 - AGGREGATE BASE COURSE (CLASS 6) (15" THICK)
 - 667 304 - AGGREGATE BASE COURSE (CLASS 6) (6" THICK)
 - 684 401.08 - HOT BITUMINOUS PAVEMENT (PATCHING) (3" THICK) (GRADING SX, PG 64-22, GYR.=75) (ONE 3" LIFT BOTTOM MAT)
 - 685 401.08 - HOT BITUMINOUS PAVEMENT (PATCHING) (2" THICK) (GRADING SX, PG 64-22, GYR.=75) (ONE 2" LIFT TOP MAT) (T-TOP PATCH)
 - 780 208 - STORM DRAIN INLET PROTECTION (SILT-SACK) (INCLUDES MAINTENANCE AND REMOVAL OF DIRT AND DEBRIS) (POTHOLE EXISTING UTILITY AHEAD OF CONSTRUCTION. COORDINATE ANY NEEDED DESIGN CHANGES WITH PROJECT ENGINEER SO AS TO AVOID UTILITY CONFLICTS).
 - 846



4595
4590
4585
4580
4575
4570
4565
4560
4555
4550

15+20 16+00 17+00 18+00 19+00 20+00

REVISION Δ ADDENDUM # - REVISED PLANS - DATE 03/20/18
 REVISION Δ DESIGN BY BCH - DATE 03/20/18
 REVISION Δ CHECKED BY ALC
 REVISION Δ APPROVED BY ALC

DESCRIPTION: 2018 SEWER LINE REPLACEMENT - PHASE A
 3RD AVENUE ALLEY PLAN AND PROFILE
 STA 15+20 TO STA 20+00

SCALES: PLAN & PROFILE
 HORIZONTAL: 1" = 40'
 VERTICAL: 1" = 10'

DRAWN BY: DATE: 04/09/18
 DESIGNED BY: BCH
 CHECKED BY: ALC
 APPROVED BY: ALC

CITY OF
Grand Junction
 COLORADO



PUBLIC WORKS
 ENGINEERING DIVISION

9

PROJECT NO. 902-F001633



CONSTRUCTION NOTES

- 1 202 - REMOVAL OF ASPHALT MAT. CUT AND REMOVE ASPHALT AS SHOWN. (INDICATED BY DOT HATCH PATTERN)
- 15 202 - REMOVAL OF PIPE AS SHOWN. (SIZE AND TYPE AS SHOWN ON PLAN)
- 16 202 - REMOVAL OF MANHOLE. CONTRACTOR SHALL SALVAGE RING AND COVER AND DELIVER TO CITY SHOPS
- 102 210 - RESET FENCE. CONTRACTOR TO SUPPLY AND INSTALL ANY NEW MATERIALS REQUIRED TO RESTORE THE FENCE TO ACCEPTABLE CONDITION EXCEPT FOR NEW POSTS. (HEIGHT AND MATERIAL AS SHOWN ON PLAN)
- 300 102.11/108.5 - SANITARY SEWER BASIC MANHOLE (48" I.D.). INCLUDES CONNECTION OF ADJACENT SEWER LINE, FORMING INVERTS AND ADJUSTING TO FINAL GRADE. (SEE CITY OF GRAND JUNCTION STANDARD DETAIL SS-02).
- 319 EPOXY COAT MANHOLE INVERTS. COST IS INCIDENTAL TO COST OF MANHOLE INSTALLATION.
- 321 102.9/108.2 - 4" GRAVITY SEWER PIPE (SDR 35 PVC). INCLUDES TYPE A BEDDING AND HAUNCHING MATERIAL AND BACKFILL OF TRENCH WITH NATIVE MATERIALS MEETING 103.16 EARTH BACKFILL MATERIAL.
- 323 102.9/108.2 - 8" GRAVITY SEWER PIPE (SDR 35 PVC). INCLUDES TYPE A BEDDING AND HAUNCHING MATERIAL AND BACKFILL OF TRENCH WITH NATIVE MATERIALS MEETING 103.16 EARTH BACKFILL MATERIAL.
- 347 102/103/104 - CONTRACTOR SHALL FIELD VERIFY EXISTING SEWER SERVICE LOCATIONS (SEWER SERVICE LOCATIONS AND CONNECTION POINTS TO EXISTING SERVICES ARE SHOWN FOR ESTIMATING PURPOSES ONLY AND MAY VARY FROM WHAT IS SHOWN).
- 354 104.20 - INSTALL 2-WAY SANITARY SEWER SERVICE CLEANOUT (STD. DETAIL SS-07). INCLUDES CLEANOUT RING AND COVER AND CONCRETE COLLAR IN UNPAVED AREAS (SEE STD. DETAIL SS-07).
- 358 103 - CLAY CUT-OFF WALL (INCIDENTAL TO SEWER INSTALLATION PAY ITEM)
- 369 102.9/108.3 - 8" x 4" SEWER SERVICE TAP. FULL BODY WYE (SEE STD. DETAIL SS-06).
- 375 102.9/104.2/108.2 - 4" SEWER SERVICE TAP TO INCLUDE: DISCONNECTING EXISTING SERVICE AND INSTALLING NEW SERVICE TAP. NEW TAP SHALL BE (W/ APPROVAL OF ENGINEER OR INSPECTOR ON CASE-SPECIFIC BASIS): FULL BODY WYE W/ STREET 45 (PIPE STUBS AND COUPLINGS INCLUDED), INSERTA-TEE, OR SADDLE; ALL BENDS AND FITTINGS, CLEANOUT, VERTICAL PIPING, CLEANOUT RING & COVER AND CONCRETE COLLAR, AS REQUIRED, TO ALIGN AND CONNECT TO EXISTING SERVICE AT ROW LINE. FOR 4" SERVICE PIPE (SEE CITY OF GRAND JUNCTION STD. DETAIL "TYPICAL SERVICE "Y" CONNECTION" SS-06 AND SS-07).
- 380 CONNECT TO EXISTING SEWER PIPE. THE CONTRACT PRICE FOR SEWER PIPE SHALL INCLUDE THE COST OF CONNECTION TO EXISTING PIPELINE
- 664 304 - AGGREGATE BASE COURSE (CLASS 6) (15" THICK)
- 667 304 - AGGREGATE BASE COURSE (CLASS 6) (6" THICK)
- 682 401.08 - HOT BITUMINOUS PAVEMENT (PATCHING) (3" THICK) (GRADING SX, PG 64-22, GYR.=75) (ONE 3" LIFT)
- 748 607 - LINE POST (MATCH IN KIND)(IF NECESSARY)

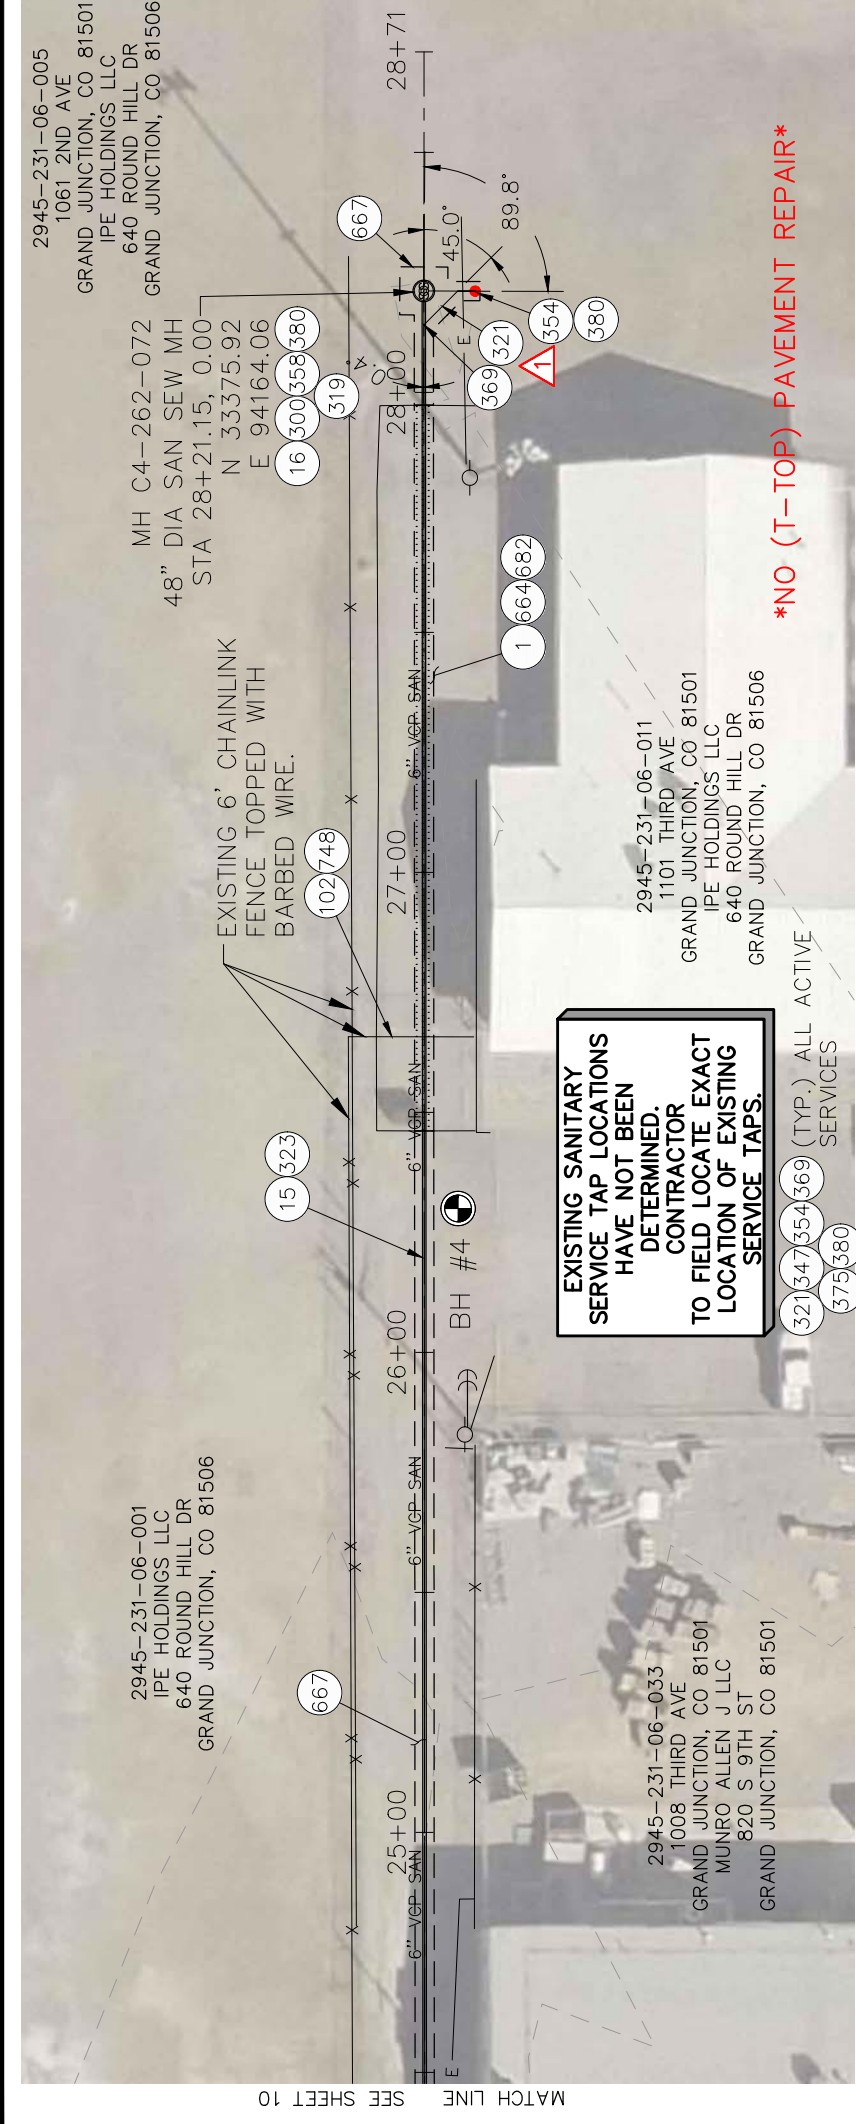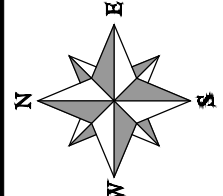

EXISTING SANITARY SERVICE TAP LOCATIONS HAVE NOT BEEN DETERMINED. CONTRACTOR TO FIELD LOCATE EXACT LOCATION OF EXISTING SERVICE TAPS.

NO (T-TOP) PAVEMENT REPAIR

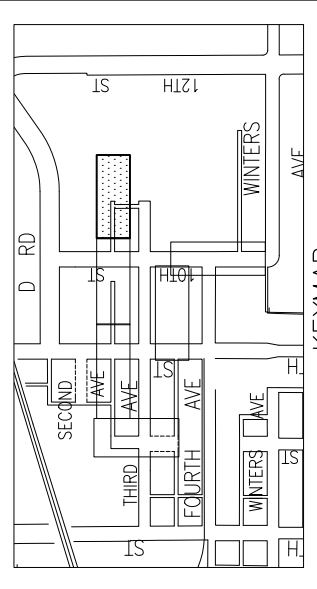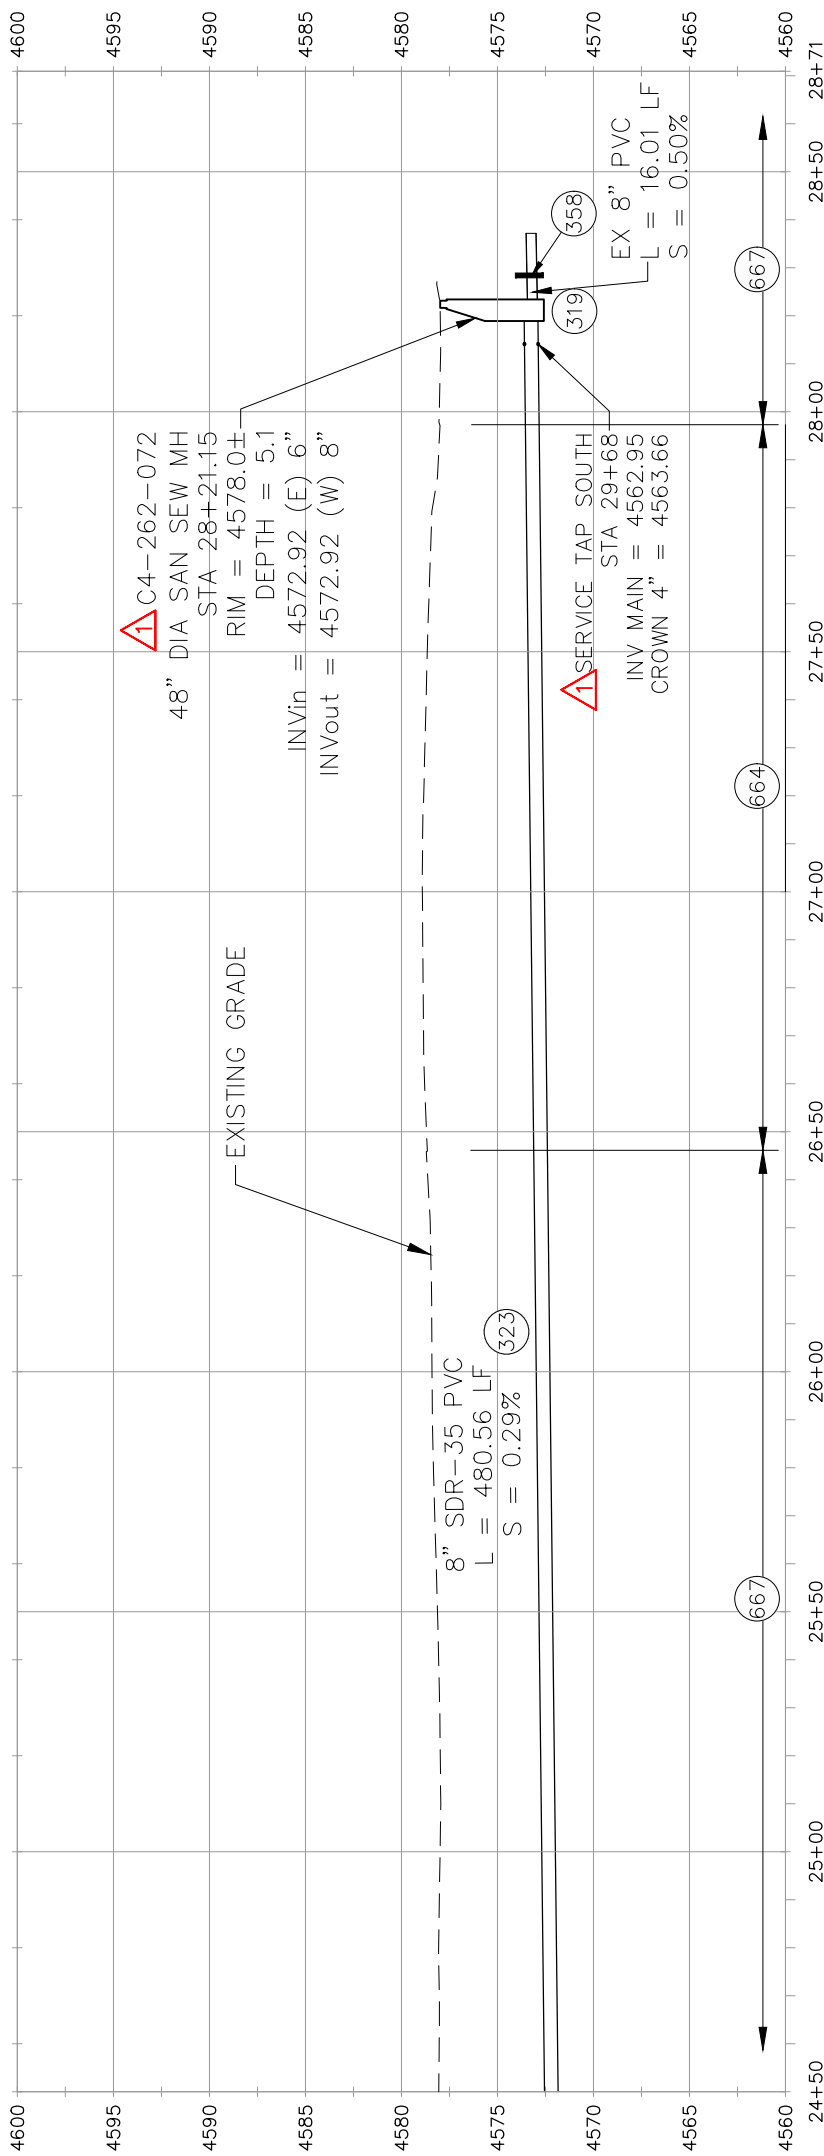

KEYMAP

REVISION Δ ADDENDUM #1 - REVISED PLANS - DATE 04/09/18

REVISION Δ - DATE

REVISION Δ - DATE

REVISION Δ - DATE

DRAWN BY BCH DATE 03/20/18

DESIGNED BY BCH DATE 03/20/18

CHECKED BY ALC DATE

APPROVED BY ALC DATE

SCALES: PLAN & PROFILE

HORIZONTAL: 1" = 40'

VERTICAL: 1" = 10'



PUBLIC WORKS ENGINEERING DIVISION

2018 SEWER LINE REPLACEMENT - PHASE A


3RD AVENUE ALLEY PLAN AND PROFILE

STA 24+50 TO STA 28+71

11

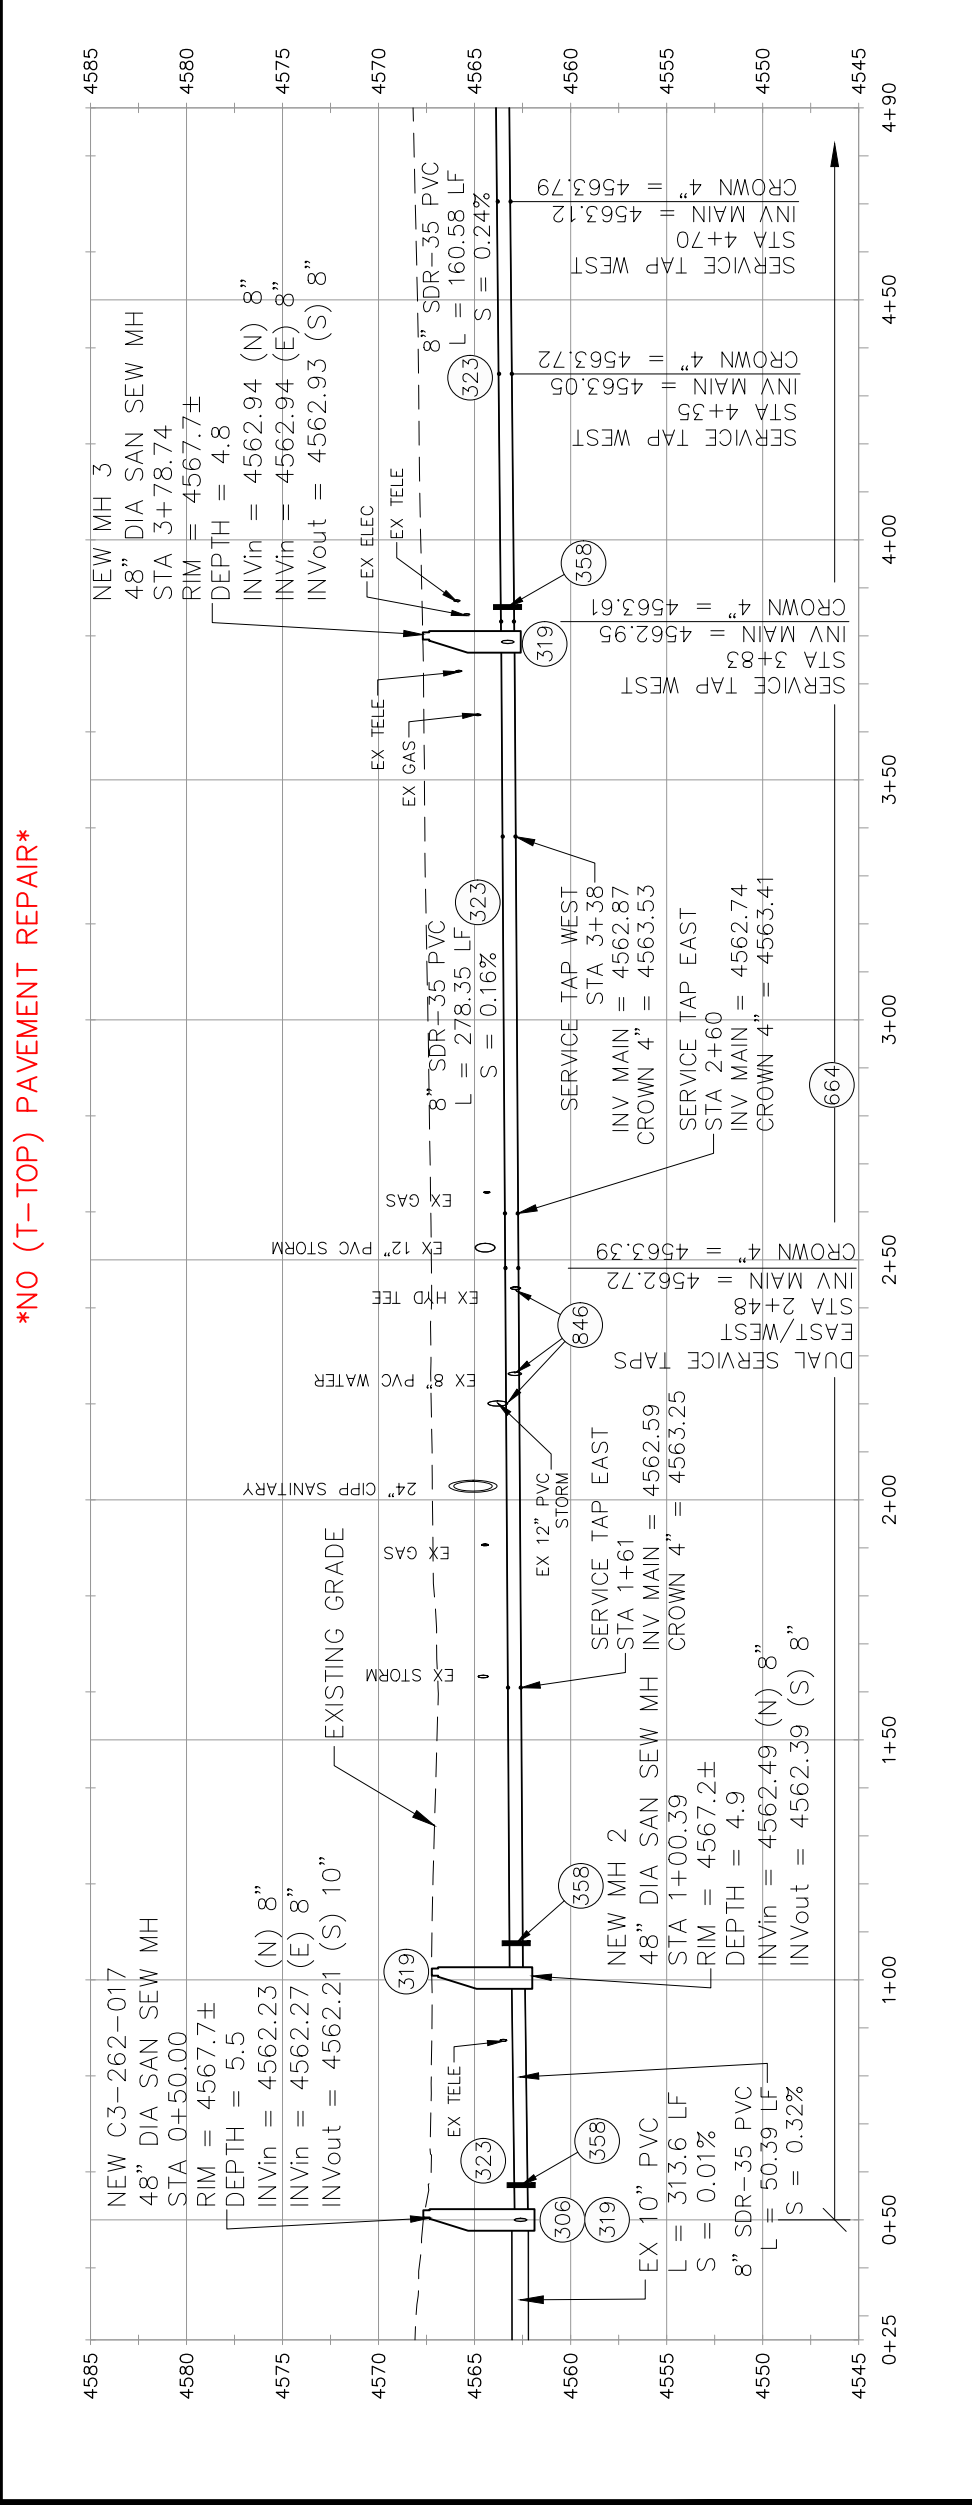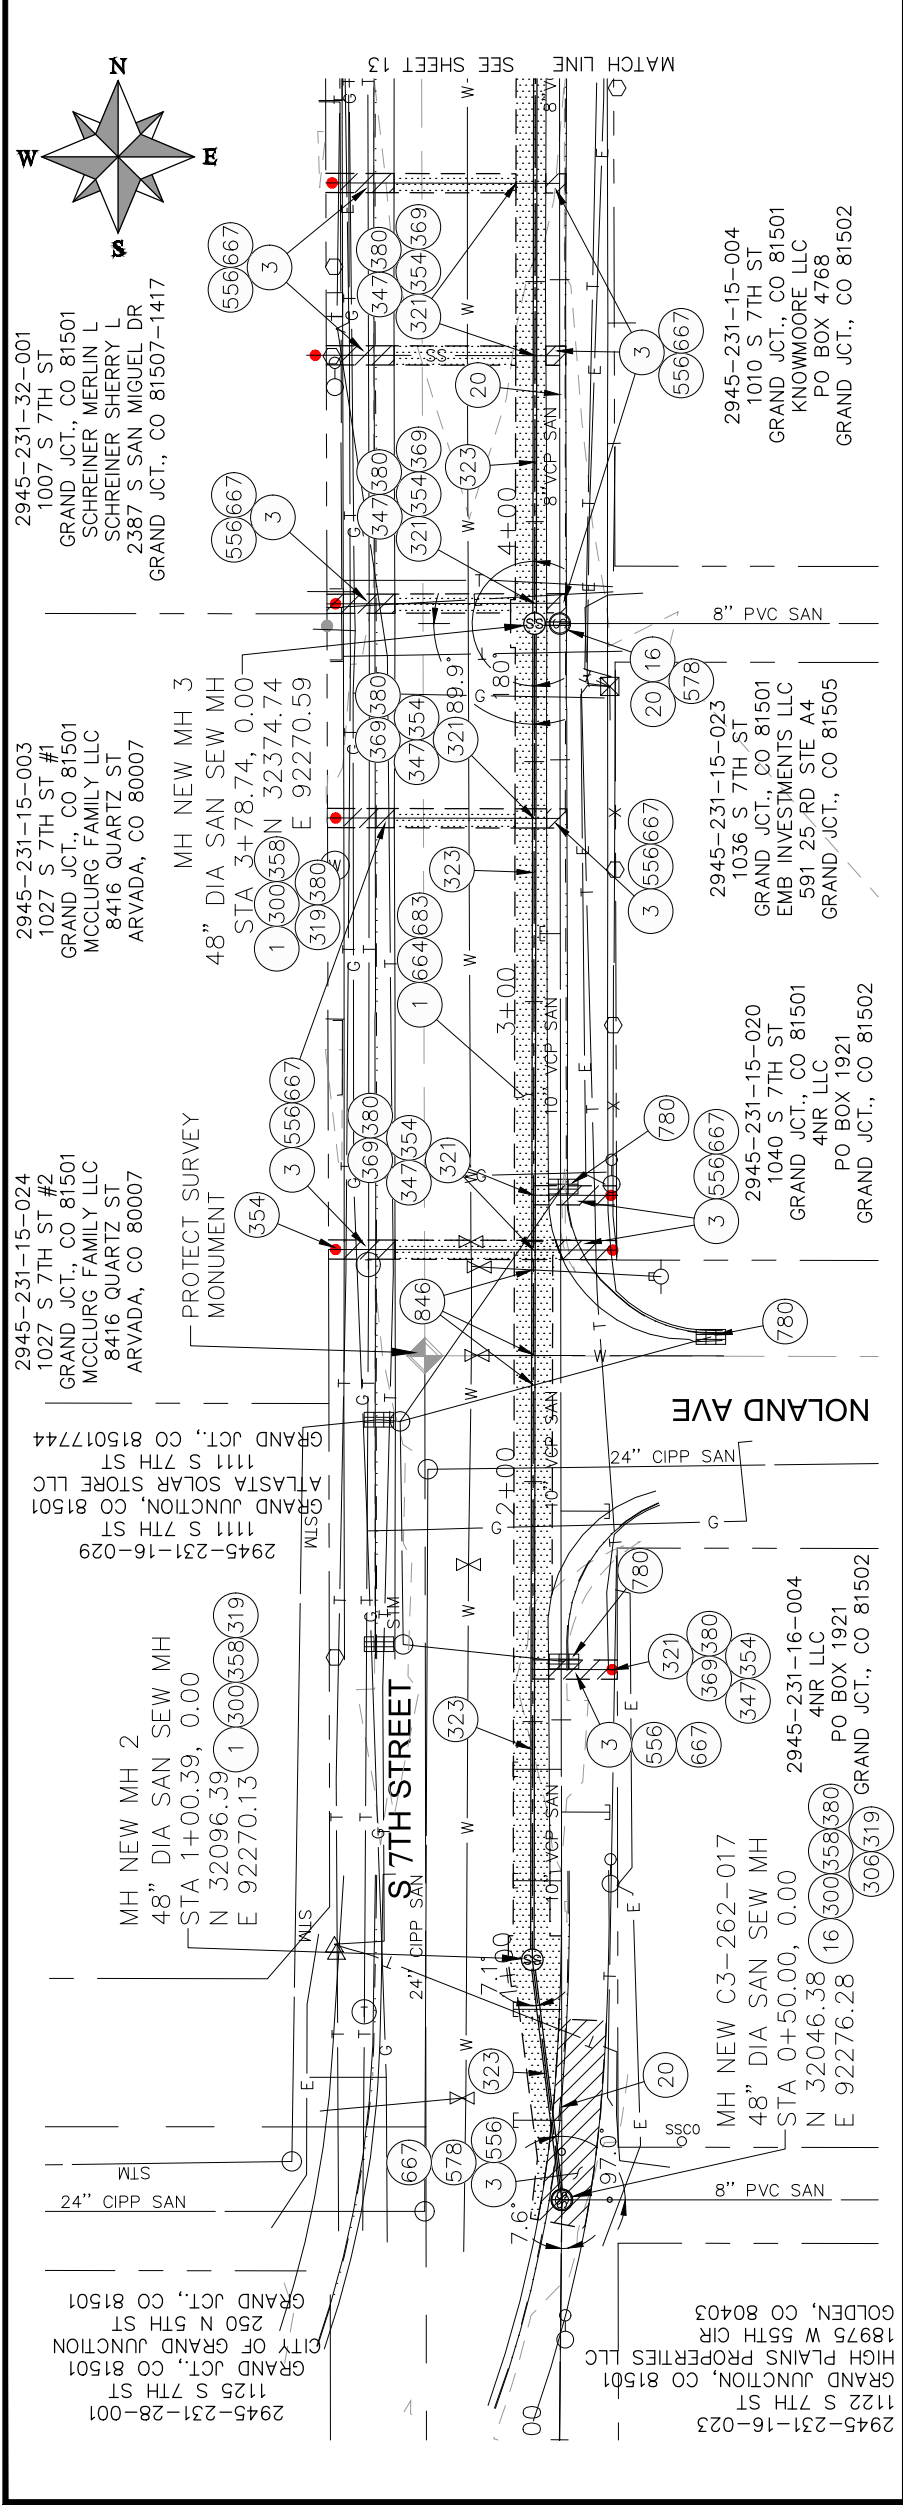

- PROJECT NO. 902-F001633
- CONSTRUCTION NOTES
- REMOVAL OF ASPHALT MAT. CUT AND REMOVE ASPHALT AS SHOWN. (INDICATED BY DOT HATCH PATTERN)
 - REMOVAL OF CONCRETE. SAW CUT AND REMOVE CONCRETE AS SHOWN. (INDICATED BY CROSS HATCH PATTERN) INCLUDES BUT NOT LIMITED TO CURB, GUTTER, SIDEWALK, DRIVEWAY, SLABS, V-PAN, CURB RAMPS, INTERSECTION CORNERS, APRONS, AND LANDSCAPE BORDERS.
 - REMOVAL OF MANHOLE. CONTRACTOR SHALL SALVAGE RING AND COVER AND DELIVER TO CITY SHOPS
 - ABANDON PIPE. ABANDON BY PLUGGING REMAINING ENDS WITH CONCRETE.
 - 102.11/108.5 - SANITARY SEWER BASIC MANHOLE (48" I.D.). INCLUDES CONNECTION OF ADJACENT SEWER LINE, FORMING INVERTS AND ADJUSTING TO FINAL GRADE. (SEE CITY OF GRAND JUNCTION STANDARD DETAIL SS-02).
 - 102.11/108.5 - MANHOLE BARREL SECTION (D>5) (48" I.D.).
 - EPOXY COAT MANHOLE INVERT. COST IS INCIDENTAL TO COST OF MANHOLE INSTALLATION.
 - 102.9/108.2 - 4" GRAVITY SEWER PIPE (SDR 35 PVC). INCLUDES TYPE A BEDDING AND HAUNCHING MATERIAL AND BACKFILL OF TRENCH WITH NATIVE MATERIALS MEETING 103.16 EARTH BACKFILL MATERIAL.
 - 102.9/108.2 - 8" GRAVITY SEWER PIPE (SDR 35 PVC). INCLUDES TYPE A BEDDING AND HAUNCHING MATERIAL AND BACKFILL OF TRENCH WITH NATIVE MATERIALS MEETING 103.16 EARTH BACKFILL MATERIAL.
 - 102/103/104 - CONTRACTOR SHALL FIELD VERIFY EXISTING SEWER SERVICE LOCATIONS (SEWER SERVICE LOCATIONS AND CONNECTION POINTS TO EXISTING SERVICES ARE SHOWN FOR ESTIMATING PURPOSES ONLY AND MAY VARY FROM WHAT IS SHOWN).
 - 104.20 - INSTALL 2-WAY SANITARY SEWER SERVICE CLEANOUT (STD. DETAIL SS-07). INCLUDES CLEANOUT RING AND COVER AND CONCRETE COLLAR IN UNPAVED AREAS (SEE STD. DETAIL SS-07).
 - 103 - CLAY CUT-OFF WALL (INCIDENTAL TO SEWER INSTALLATION PAY ITEM)
 - 102.9/108.3 - 8" x 4" SEWER SERVICE TAP. FULL BODY WYE (SEE STD. DETAIL SS-06).
 - CONNECT TO EXISTING SEWER PIPE. THE CONTRACT PRICE FOR SEWER PIPE SHALL INCLUDE THE COST OF CONNECTION TO EXISTING PIPELINE
 - 608.06 - CONCRETE CURB, GUTTER, AND SIDEWALK (MATCH IN KIND)
 - 608.06 - CONCRETE DRIVEWAY SECTION (8" SECTION)
 - 304 - AGGREGATE BASE COURSE (CLASS 6) (15" THICK)
 - 304 - AGGREGATE BASE COURSE (CLASS 6) (6" THICK)
 - 401.08 - HOT BITUMINOUS PAVEMENT (PATCHING) (5" THICK) (GRADING SX, PG 64-22, GYR.=75) (TWO LIFTS)
 - 208 - STORM DRAIN INLET PROTECTION (SILT-SACK) (INCLUDES MAINTENANCE AND REMOVAL OF DIRT AND DEBRIS)
 - POTHOLE EXISTING UTILITY AHEAD OF CONSTRUCTION. COORDINATE ANY NEEDED DESIGN CHANGES WITH PROJECT ENGINEER SO AS TO AVOID UTILITY CONFLICTS.

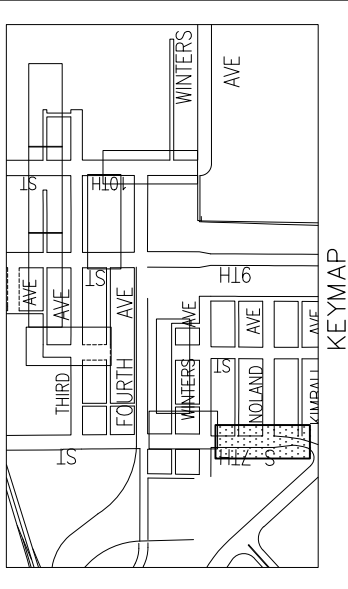

2945-231-15-003
1027 S 7TH ST #1
GRAND JCT., CO 81501
MCCLURG FAMILY LLC
8416 QUARTZ ST
ARVADA, CO 80007

2945-231-15-004
1007 S 7TH ST
GRAND JCT., CO 81501
SCHREINER MERLIN L
SCHREINER SHERRY L
2387 S SAN MIGUEL DR
GRAND JCT., CO 81507-1417

2945-231-15-020
1040 S 7TH ST
GRAND JCT., CO 81501
4NR LLC
PO BOX 1921
GRAND JCT., CO 81502

2945-231-16-004
1010 S 7TH ST
GRAND JCT., CO 81501
KNOWMOORE LLC
PO BOX 4768
GRAND JCT., CO 81502

2945-231-16-023
18975 W 55TH CIR
GOLDEN, CO 80403
HIGH PLAINS PROPERTIES LLC
CITY OF GRAND JUNCTION
1125 S 7TH ST
GRAND JCT., CO 81501

2945-231-16-029
1111 S 7TH ST
ATLANTA SOLAR STORE LLC
GRAND JUNCTION, CO 81501
1111 S 7TH ST
GRAND JCT., CO 815017744

2945-231-15-024
1027 S 7TH ST #2
GRAND JCT., CO 81501
MCCLURG FAMILY LLC
8416 QUARTZ ST
ARVADA, CO 80007

2945-231-15-001
1007 S 7TH ST
GRAND JCT., CO 81501
SCHREINER MERLIN L
SCHREINER SHERRY L
2387 S SAN MIGUEL DR
GRAND JCT., CO 81507-1417

2018 SEWER LINE REPLACEMENT - PHASE A
S 7TH STREET PLAN AND PROFILE
STA 0+00 TO STA 4+90





PUBLIC WORKS
ENGINEERING DIVISION

CITY OF
Grand Junction
COLORADO

REVISION # ADDENDUM # - REVISED PLANS - DATE 03/2/18
DESIGNED BY BCH DATE 03/2/18
CHECKED BY ALC DATE
APPROVED BY ALC DATE

SCALES: PLAN & PROFILE
HORIZONTAL: 1" = 40'
VERTICAL: 1" = 10'

12

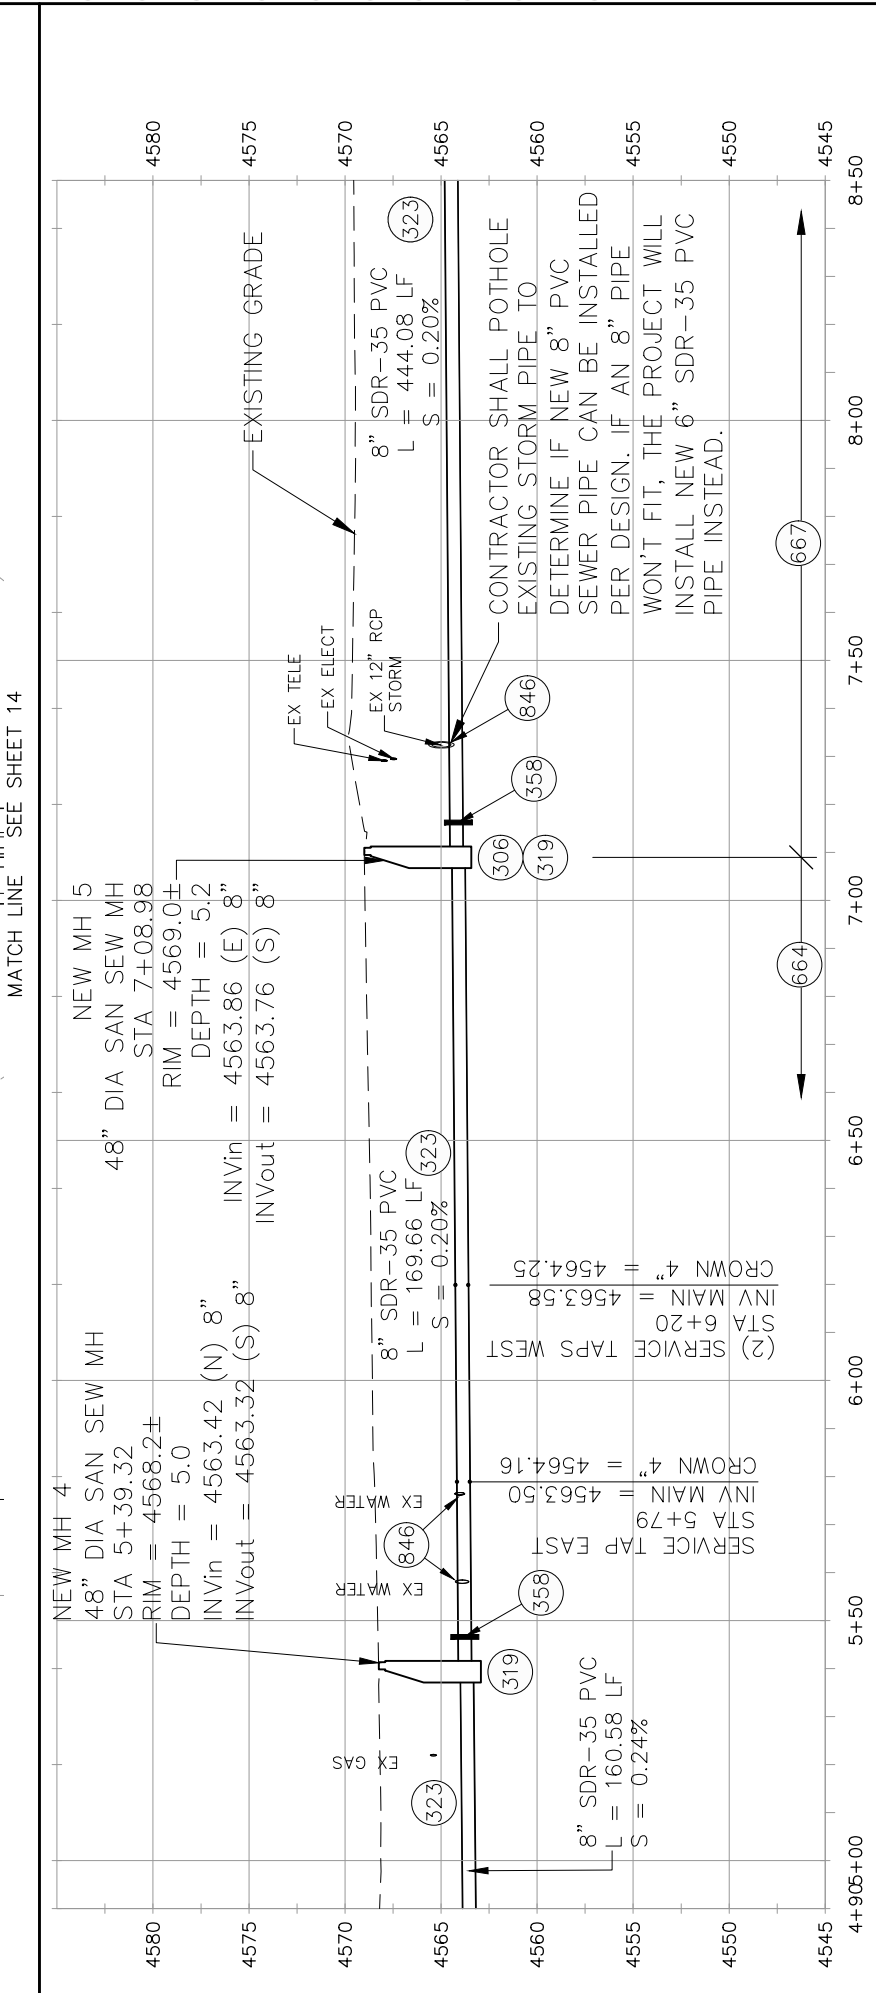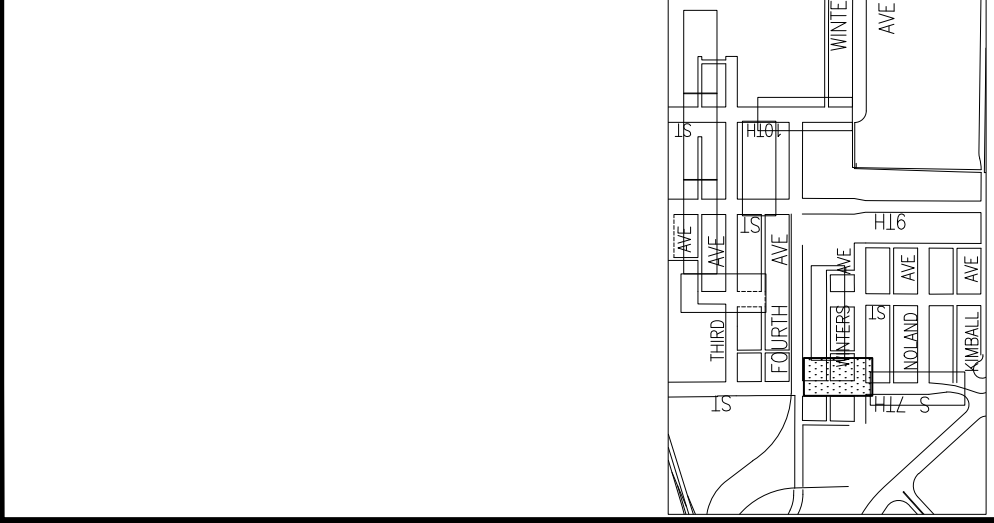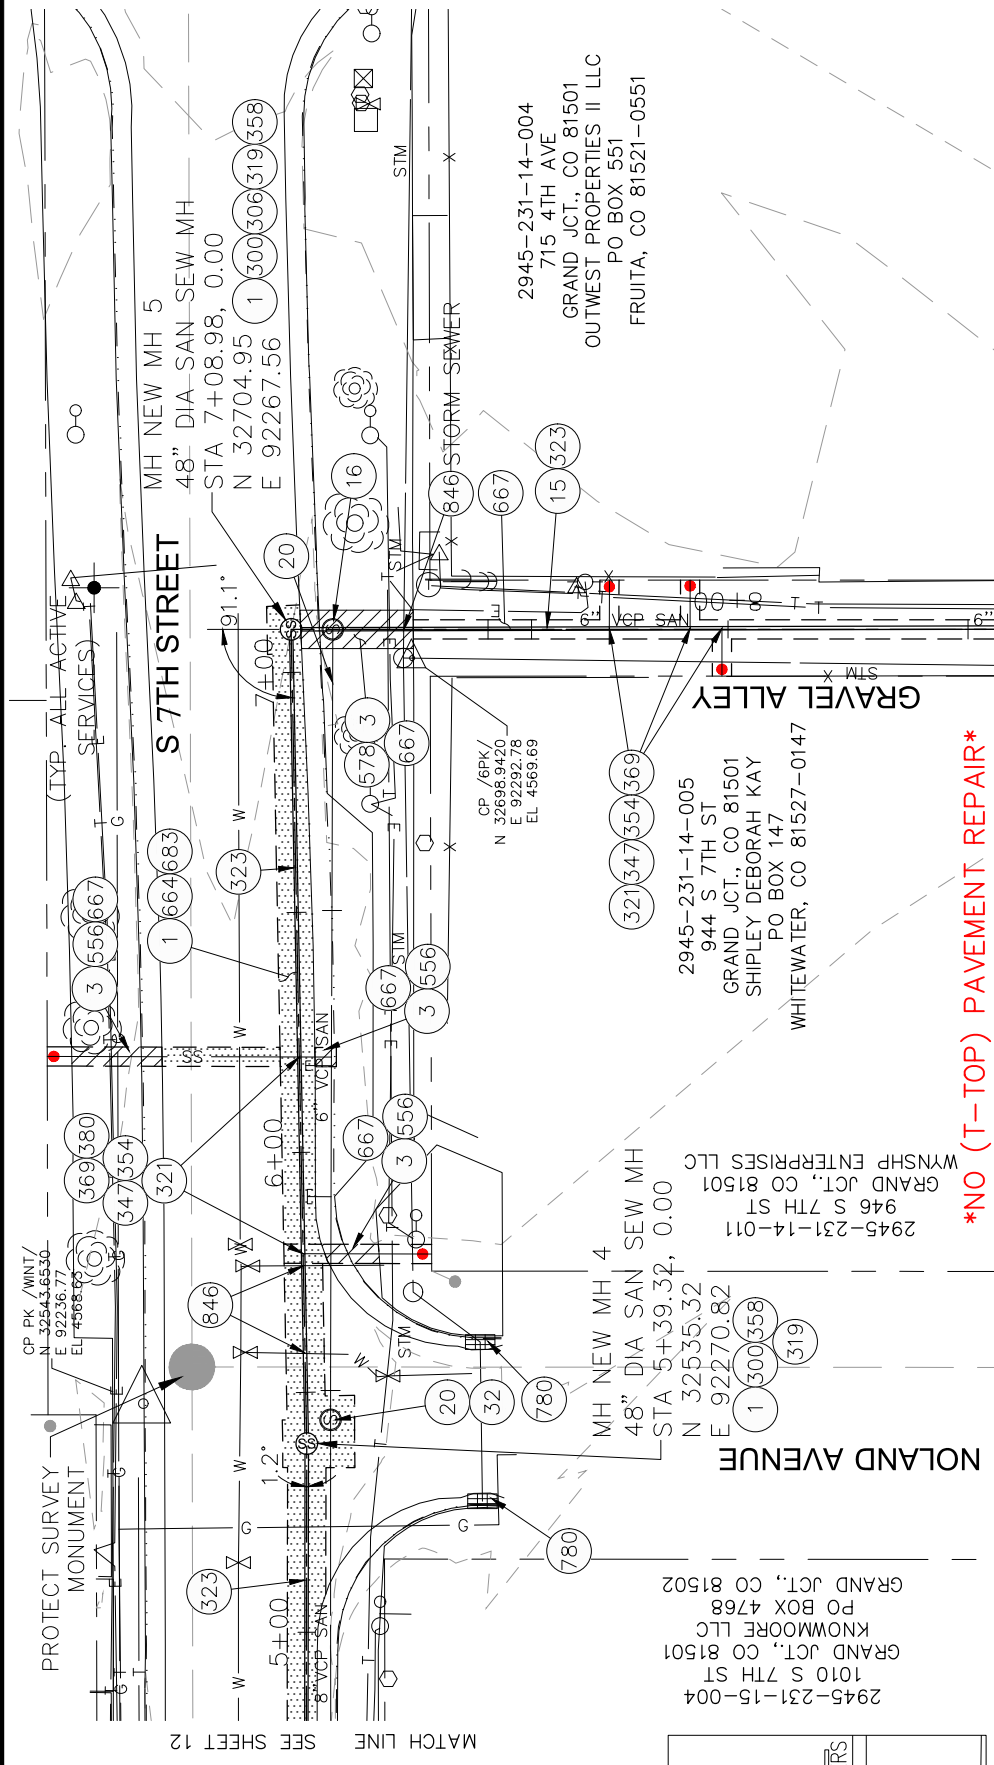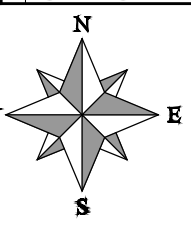





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- 1 202 - REMOVAL OF ASPHALT MAT. CUT AND REMOVE ASPHALT AS SHOWN. (INDICATED BY DOT HATCH PATTERN)
 - 3 202 - REMOVAL OF CONCRETE. SAW CUT AND REMOVE CONCRETE AS SHOWN. (INDICATED BY CROSS HATCH PATTERN) INCLUDES BUT NOT LIMITED TO CURB, GUTTER, SIDEWALK, DRIVEWAY, SLABS, V-PAN, CURB RAMPS, INTERSECTION CORNERS, APRONS, AND LANDSCAPE BORDERS.
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 - 20 202 - ABANDON PIPE. ABANDON BY PLUGGING REMAINING ENDS WITH CONCRETE.
 - 32 202 - ABANDON MANHOLE. REMOVE RING COVER AND CONE SECTION. BACKFILL WITH IMPORTED PIT RUN.
 - 300 102.11/108.5 - SANITARY SEWER BASIC MANHOLE (48" I.D.). INCLUDES CONNECTION OF ADJACENT SEWER LINE, FORMING INVERTS AND ADJUSTING TO FINAL GRADE. (SEE CITY OF GRAND JUNCTION STANDARD DETAIL SS-02).
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 - 578 608.06 - CONCRETE DRIVEWAY SECTION (8" SECTION)
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 - 780 208 - STORM DRAIN INLET PROTECTION (SILT-SACK) (INCLUDES MAINTENANCE AND REMOVAL OF DIRT AND DEBRIS)
 - 846 POT HOLE EXISTING UTILITY AHEAD OF CONSTRUCTION. COORDINATE ANY NEEDED DESIGN CHANGES WITH PROJECT ENGINEER SO AS TO AVOID UTILITY CONFLICTS.

NO (T-TOP) PAVEMENT REPAIR

<p>REVISION Δ ADDENDUM #1 - REVISED PLANS - 04/09/18</p> <p>REVISION Δ _____ DATE _____</p> <p>REVISION Δ _____ DATE _____</p> <p>REVISION Δ _____ DATE _____</p>	<p>DESCRIPTION _____</p> <p>DATE _____</p>	<p>DRAWN BY _____ DATE 03/20/18</p> <p>DESIGNED BY BCH DATE 03/20/18</p> <p>CHECKED BY ALC DATE _____</p> <p>APPROVED BY _____ DATE _____</p>	<p>SCALES: PLAN & PROFILE</p> <p>HORIZONTAL: 1" = 40'</p> <p>VERTICAL: 1" = 10'</p>	<p>CITY OF Grand Junction COLORADO</p>	<p>PUBLIC WORKS ENGINEERING DIVISION</p>	<p>2018 SEWER LINE REPLACEMENT - PHASE A S 7TH STREET PLAN AND PROFILE STA 4+90 TO STA 8+50</p>	<p>13</p>
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CONSTRUCTION NOTES

- 15 202 - REMOVAL OF PIPE AS SHOWN. (SIZE AND TYPE AS SHOWN ON PLAN)
- 16 202 - REMOVAL OF MANHOLE. CONTRACTOR SHALL SALVAGE RING AND COVER AND DELIVER TO CITY SHOPS
- 300 102.11/108.5 - SANITARY SEWER BASIC MANHOLE (48" I.D.). INCLUDES CONNECTION OF ADJACENT SEWER LINE, FORMING INVERTS AND ADJUSTING TO FINAL GRADE. (SEE CITY OF GRAND JUNCTION STANDARD DETAIL SS-02).
- 306 102.11/108.5 - MANHOLE BARREL SECTION (D>5) (48" I.D.).
- 319 EPOXY COAT MANHOLE INVERT. COST IS INCIDENTAL TO COST OF MANHOLE INSTALLATION.
- 321 102.9/108.2 - 4" GRAVITY SEWER PIPE (SDR 35 PVC). INCLUDES TYPE A BEDDING AND HAUNCHING MATERIAL AND BACKFILL OF TRENCH WITH NATIVE MATERIALS MEETING 103.16 EARTH BACKFILL MATERIAL.
- 323 102.9/108.2 - 8" GRAVITY SEWER PIPE (SDR 35 PVC). INCLUDES TYPE A BEDDING AND HAUNCHING MATERIAL AND BACKFILL OF TRENCH WITH NATIVE MATERIALS MEETING 103.16 EARTH BACKFILL MATERIAL.
- 347 102/103/104 - CONTRACTOR SHALL FIELD VERIFY EXISTING SEWER SERVICE LOCATIONS (SEWER SERVICE LOCATIONS AND CONNECTION POINTS TO EXISTING SERVICES ARE SHOWN FOR ESTIMATING PURPOSES ONLY AND MAY VARY FROM WHAT IS SHOWN).
- 354 104.20 - INSTALL 2-WAY SANITARY SEWER SERVICE CLEANOUT (STD. DETAIL SS-07). INCLUDES CLEANOUT RING AND COVER AND CONCRETE COLLAR IN UNPAVED AREAS (SEE STD. DETAIL SS-07).
- 358 103 - CLAY CUT-OFF WALL (INCIDENTAL TO SEWER INSTALLATION PAY ITEM)
- 369 102.9/108.3 - 8" x 4" SEWER SERVICE TAP. FULL BODY WYE (SEE STD. DETAIL SS-06).
- 380 CONNECT TO EXISTING SEWER PIPE. THE CONTRACT PRICE FOR SEWER PIPE SHALL INCLUDE THE COST OF CONNECTION TO EXISTING PIPELINE
- 667 304 - AGGREGATE BASE COURSE (CLASS 6) (6" THICK)
- 780 208 - STORM DRAIN INLET PROTECTION (SILT-SACK) (INCLUDES MAINTENANCE AND REMOVAL OF DIRT AND DEBRIS)
- 846 POTHOLE EXISTING UTILITY AHEAD OF CONSTRUCTION. COORDINATE ANY NEEDED DESIGN CHANGES WITH PROJECT ENGINEER SO AS TO AVOID UTILITY CONFLICTS.

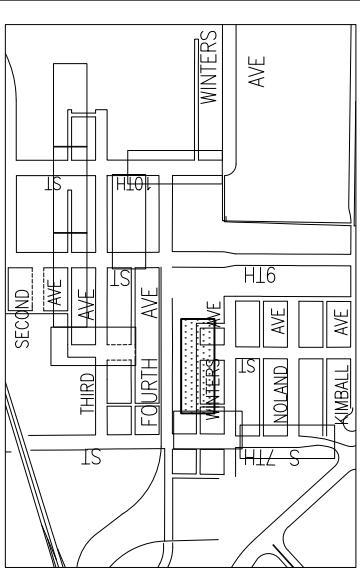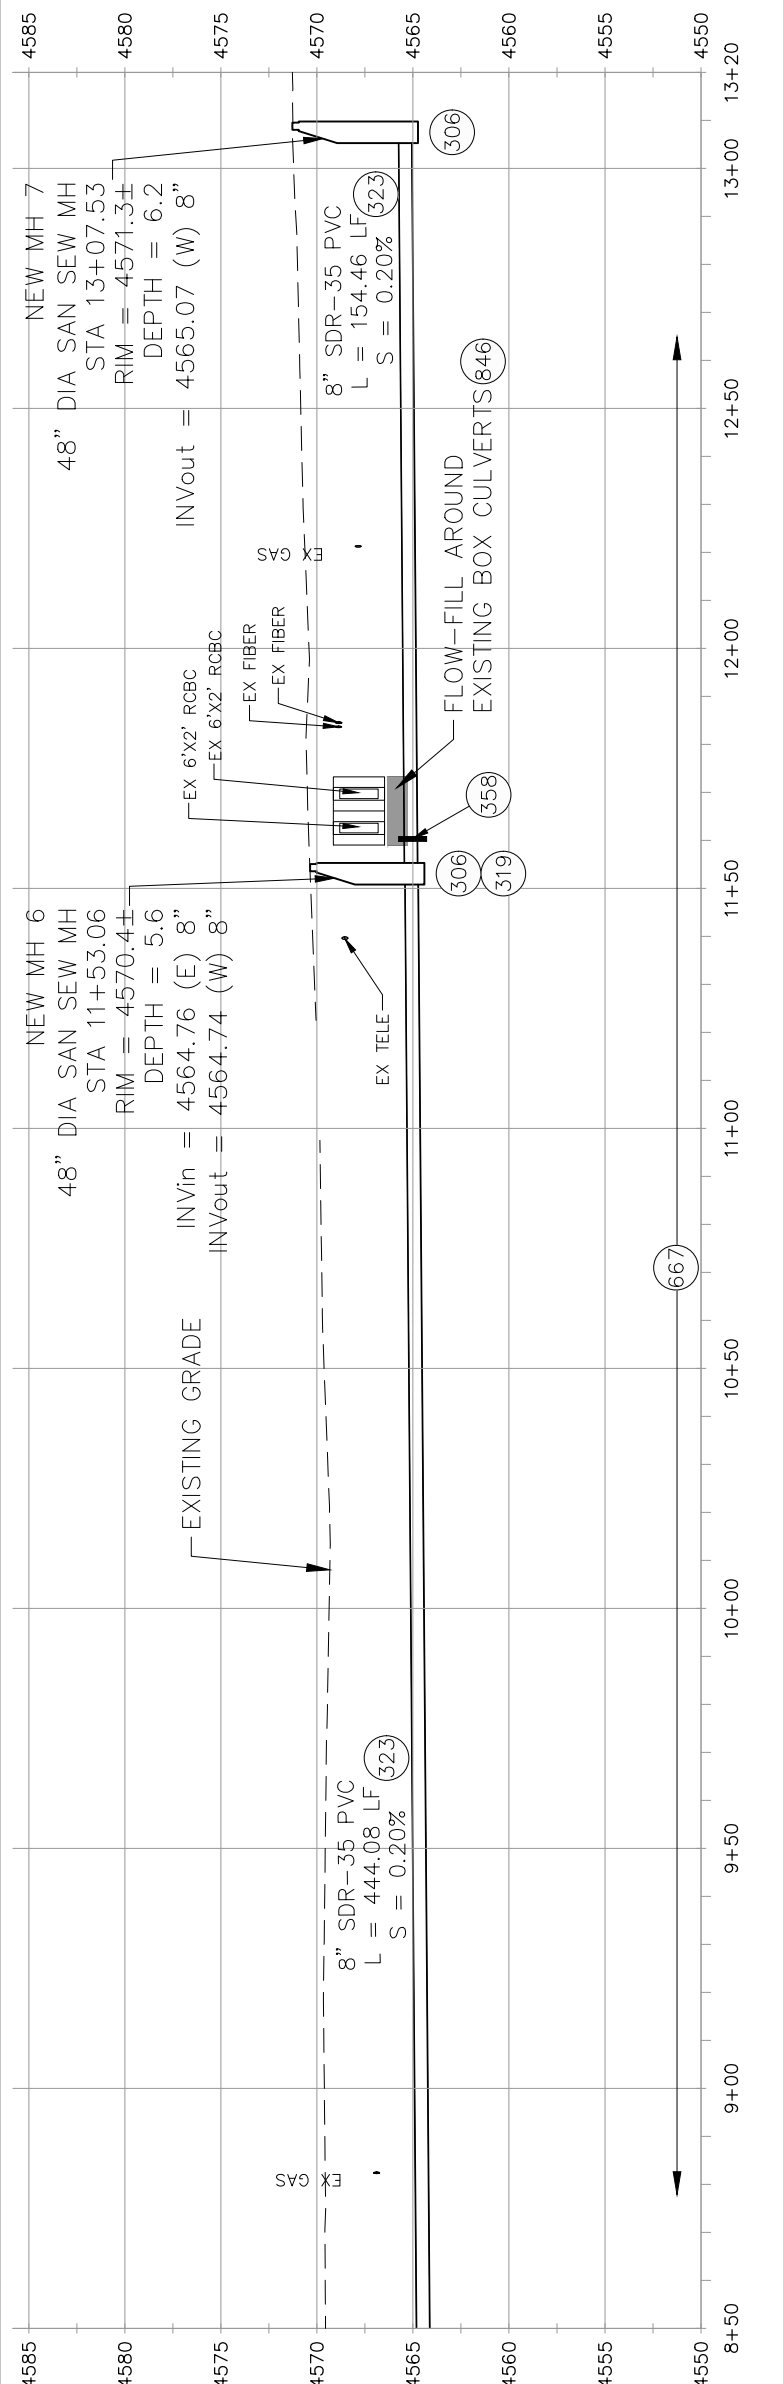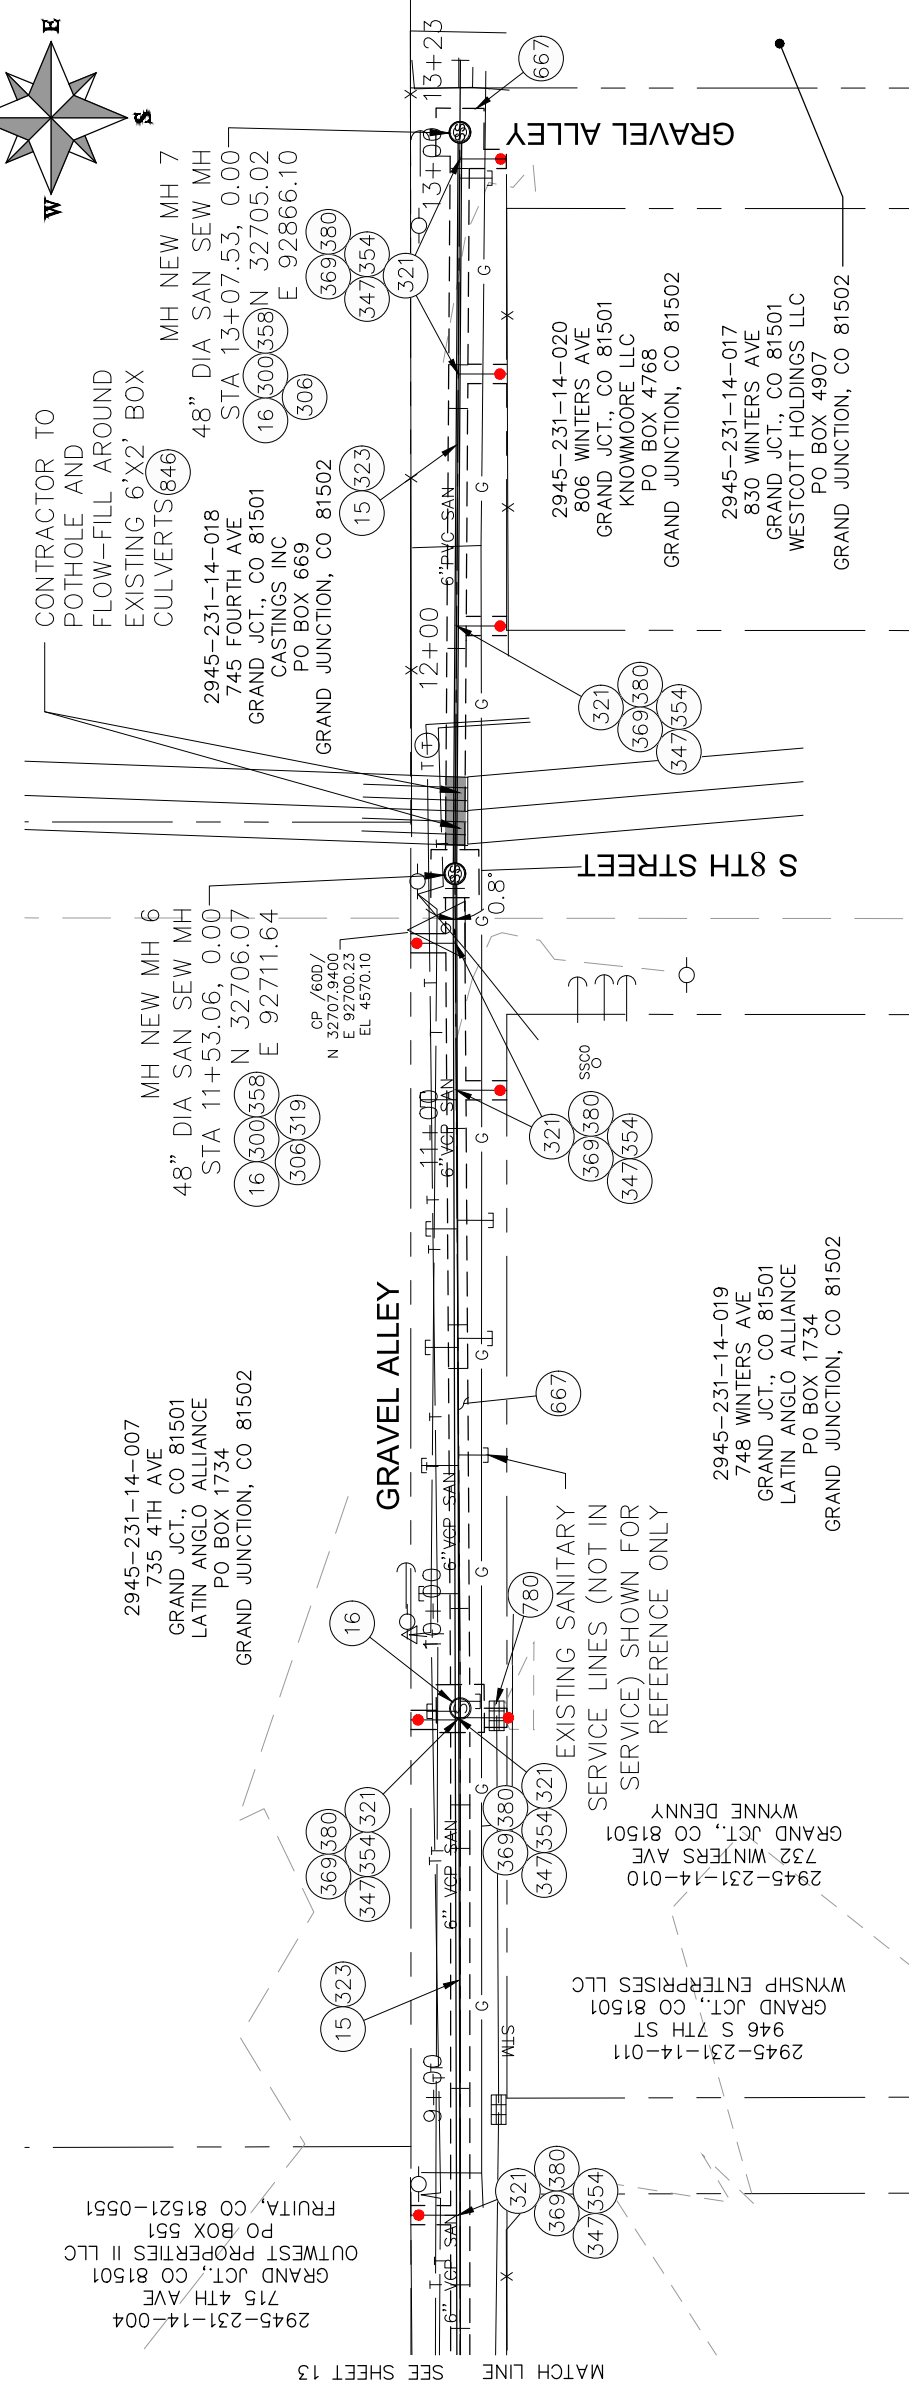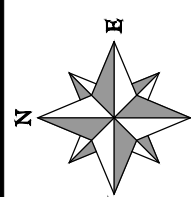

CITY OF
Grand Junction
COLORADO

PUBLIC WORKS
ENGINEERING DIVISION

2018 SEWER LINE REPLACEMENT - PHASE A
S 7TH STREET/ALLEY PLAN AND PROFILE
STA 8+50 TO STA 13+20

KEYMAP

14

REVISION	DESCRIPTION	DATE	DRAWN BY	DATE
REVISION 1	ADDENDUM #1 - REVISED PLANS	04/09/18	BCH	03/20/18
REVISION 2			DESIGNED BY	03/20/18
REVISION 3			CHECKED BY	
REVISION 4			APPROVED BY	




SCALES: PLAN & PROFILE
 HORIZONTAL: 1" = 40'
 1" = 20'
 1" = 10'
 VERTICAL: 1" = 10'
 1" = 5'
 1" = 2.5'

2945-112-28-001
2623 N 7TH ST
GRAND JCT., CO 81501

SISTERS OF CHARITY OF
LEAVENWORTH HEALTH
SYSTEM INC

2945-111-02-000
CITY OF GRAND JUNCTION
250 N 5TH ST
GRAND JCT., CO 81501


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GRAND JCT., CO 81501
SISTERS CHARITY LEAVENWORTH
HEALTH SYSTEM INC
PO BOX 1628
GRAND JUNCTION, CO 81502

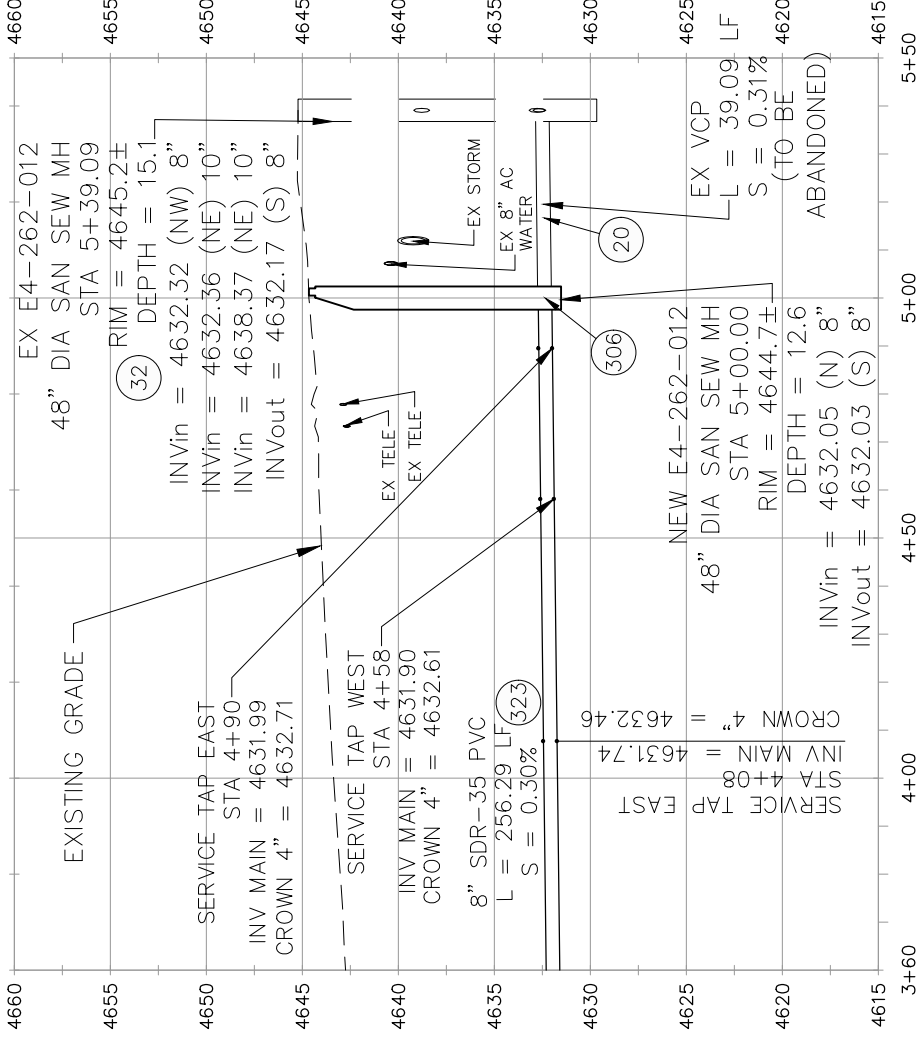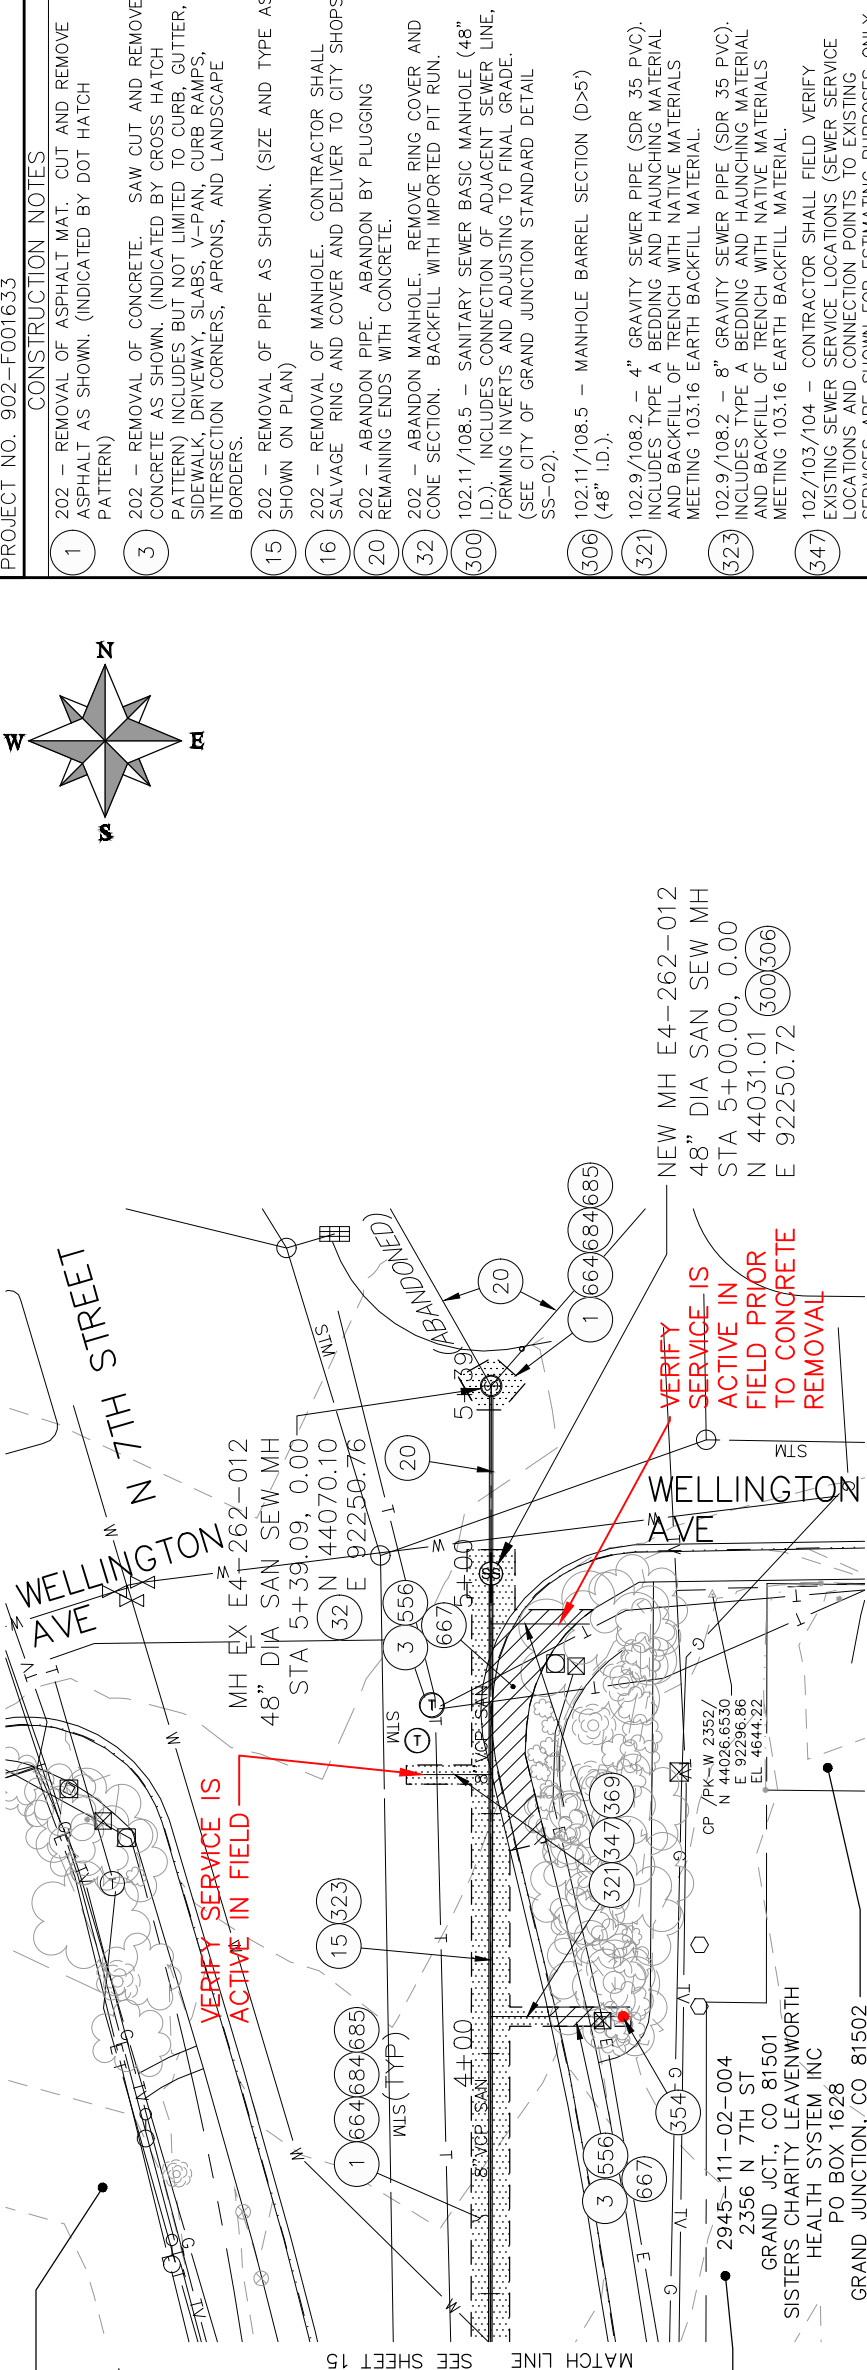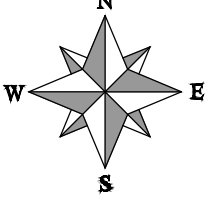

PROJECT NO. 902-F001633

CONSTRUCTION NOTES

- 1 202 - REMOVAL OF ASPHALT MAT. CUT AND REMOVE ASPHALT AS SHOWN. (INDICATED BY DOT HATCH PATTERN)
- 3 202 - REMOVAL OF CONCRETE. SAW CUT AND REMOVE CONCRETE AS SHOWN. (INDICATED BY CROSS HATCH PATTERN) INCLUDES BUT NOT LIMITED TO CURB, GUTTER, SIDEWALK, DRIVEWAY, SLABS, V-PAN, CURB RAMPS, INTERSECTION CORNERS, APRONS, AND LANDSCAPE BORDERS.
- 15 202 - REMOVAL OF PIPE AS SHOWN. (SIZE AND TYPE AS SHOWN ON PLAN)
- 16 202 - REMOVAL OF MANHOLE. CONTRACTOR SHALL SALVAGE RING AND COVER AND DELIVER TO CITY SHOPS
- 20 202 - ABANDON PIPE. ABANDON BY PLUGGING REMAINING ENDS WITH CONCRETE.
- 32 202 - ABANDON MANHOLE. REMOVE RING COVER AND CONE SECTION. BACKFILL WITH IMPORTED PIT RUN.
- 300 102.11/108.5 - SANITARY SEWER BASIC MANHOLE (48" I.D.). INCLUDES CONNECTION OF ADJACENT SEWER LINE, FORMING INVERTS AND ADJUSTING TO FINAL GRADE. (SEE CITY OF GRAND JUNCTION STANDARD DETAIL SS-02).
- 306 102.11/108.5 - MANHOLE BARREL SECTION (D>5) (48" I.D.).
- 321 102.9/108.2 - 4" GRAVITY SEWER PIPE (SDR 35 PVC). INCLUDES TYPE A BEDDING AND HAUNCHING MATERIAL AND BACKFILL OF TRENCH WITH NATIVE MATERIALS MEETING 103.16 EARTH BACKFILL MATERIAL.
- 323 102.9/108.2 - 8" GRAVITY SEWER PIPE (SDR 35 PVC). INCLUDES TYPE A BEDDING AND HAUNCHING MATERIAL AND BACKFILL OF TRENCH WITH NATIVE MATERIALS MEETING 103.16 EARTH BACKFILL MATERIAL.
- 347 102/103/104 - CONTRACTOR SHALL FIELD VERIFY EXISTING SEWER SERVICE LOCATIONS (SEWER SERVICE LOCATIONS AND CONNECTION POINTS TO EXISTING SERVICES ARE SHOWN FOR ESTIMATING PURPOSES ONLY AND MAY VARY FROM WHAT IS SHOWN).
- 354 104.20 - INSTALL 2-WAY SANITARY SEWER SERVICE CLEANOUT (STD. DETAIL SS-07). INCLUDES CLEANOUT RING AND COVER AND CONCRETE COLLAR IN UNPAVED AREAS (SEE STD. DETAIL SS-07).
- 369 102.9/108.3 - 8" x 4" SEWER SERVICE TAP. FULL BODY WYE (SEE STD. DETAIL SS-06).
- 556 608.06 - CONCRETE CURB, GUTTER, AND WALK (MATCH IN KIND)
- 664 304 - AGGREGATE BASE COURSE (CLASS 6) (15" THICK)
- 667 304 - AGGREGATE BASE COURSE (CLASS 6) (6" THICK)
- 684 401.08 - HOT BITUMINOUS PAVEMENT (PATCHING) (3" THICK) (GRADING SX, PG 64-22, GYR.=75) (ONE 3" LIFT BOTTOM MAT)
- 685 401.08 - HOT BITUMINOUS PAVEMENT (PATCHING) (2" THICK) (GRADING SX, PG 64-22, GYR.=75) (ONE 2" LIFT TOP MAT) (T-TOP PATCH)

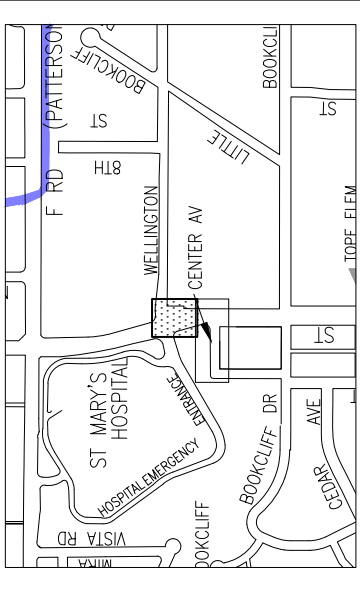

REVISION	ADDENDUM #	DESCRIPTION	DATE

DRAWN BY: BCH
DESIGNED BY: BCH
CHECKED BY: ALC
APPROVED BY: ALC

DATE: 03/20/18
DATE: 03/20/18
DATE: _____
DATE: _____





SCALES: PLAN & PROFILE
HORIZONTAL: 1" = 40'
VERTICAL: 1" = 10'



PUBLIC WORKS
ENGINEERING DIVISION

2018 SEWER LINE REPLACEMENT - PHASE A
N 7TH STREET PLAN AND PROFILE
STA 3+60 TO STA 5+60

- CONSTRUCTION NOTES**
- 1 202 - REMOVAL OF ASPHALT MAT. CUT AND REMOVE ASPHALT AS SHOWN. (INDICATED BY DOT HATCH PATTERN)
 - 3 202 - REMOVAL OF CONCRETE. SAW CUT AND REMOVE CONCRETE AS SHOWN. (INDICATED BY CROSS HATCH PATTERN) INCLUDES BUT NOT LIMITED TO CURB, GUTTER, SIDEWALK, DRIVEWAY, SLABS, V-PAN, CURB RAMPS, INTERSECTION CORNERS, APRONS, AND LANDSCAPE BORDERS.
 - 15 202 - REMOVAL OF PIPE AS SHOWN. (SIZE AND TYPE AS SHOWN ON PLAN)
 - 16 202 - REMOVAL OF MANHOLE. CONTRACTOR SHALL SALVAGE RING AND COVER AND DELIVER TO CITY SHOPS
 - 300 102.11/108.5 - SANITARY SEWER BASIC MANHOLE (48" I.D.). INCLUDES CONNECTION OF ADJACENT SEWER LINE, FORMING INVERTS AND ADJUSTING TO FINAL GRADE. (SEE CITY OF GRAND JUNCTION STANDARD DETAIL SS-02).
 - 306 102.11/108.5 - MANHOLE BARREL SECTION (D>5) (48" I.D.).
 - 319 EPOXY COAT MANHOLE INVERT. COST IS INCIDENTAL TO COST OF MANHOLE INSTALLATION.
 - 321 102.9/108.2 - 4" GRAVITY SEWER PIPE (SDR 35 PVC). INCLUDES TYPE A BEDDING AND HAUNCHING MATERIAL AND BACKFILL OF TRENCH WITH NATIVE MATERIALS MEETING 103.16 EARTH BACKFILL MATERIAL.
 - 323 102.9/108.2 - 8" GRAVITY SEWER PIPE (SDR 35 PVC). INCLUDES TYPE A BEDDING AND HAUNCHING MATERIAL AND BACKFILL OF TRENCH WITH NATIVE MATERIALS MEETING 103.16 EARTH BACKFILL MATERIAL.
 - 347 102/103/104 - CONTRACTOR SHALL FIELD VERIFY EXISTING SEWER SERVICE LOCATIONS (SEWER SERVICE LOCATIONS AND CONNECTION POINTS TO EXISTING SERVICES ARE SHOWN FOR ESTIMATING PURPOSES ONLY AND MAY VARY FROM WHAT IS SHOWN).
 - 354 104.20 - INSTALL 2-WAY SANITARY SEWER SERVICE CLEANOUT (STD. DETAIL SS-07). INCLUDES CLEANOUT RING AND COVER AND CONCRETE COLLAR IN UNPAVED AREAS (SEE STD. DETAIL SS-07).
 - 358 103 - CLAY CUT-OFF WALL (INCIDENTAL TO SEWER INSTALLATION PAY ITEM)
 - 369 102.9/108.3 - 8" x 4" SEWER SERVICE TAP. FULL BODY WYE (SEE STD. DETAIL SS-06).
 - 380 CONNECT TO EXISTING SEWER PIPE. THE CONTRACT PRICE FOR SEWER PIPE SHALL INCLUDE THE COST OF CONNECTION TO EXISTING PIPELINE
 - 556 608.06 - CONCRETE CURB, GUTTER, AND WALK (MATCH IN KIND)
 - 664 304 - AGGREGATE BASE COURSE (CLASS 6) (15" THICK)
 - 667 304 - AGGREGATE BASE COURSE (CLASS 6) (6" THICK)
 - 684 401.08 - HOT BITUMINOUS PAVEMENT (PATCHING) (3" THICK) (GRADING SX, PG 64-22, GYR.=75) (ONE 3" LIFT BOTTOM MAT)
 - 685 401.08 - HOT BITUMINOUS PAVEMENT (PATCHING) (2" THICK) (GRADING SX, PG 64-22, GYR.=75) (ONE 2" LIFT TOP MAT) (1-TOP PATCH)
 - 780 208 - STORM DRAIN INLET PROTECTION (SILT-SACK) (INCLUDES MAINTENANCE AND REMOVAL OF DIRT AND DEBRIS)

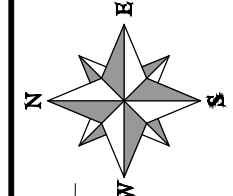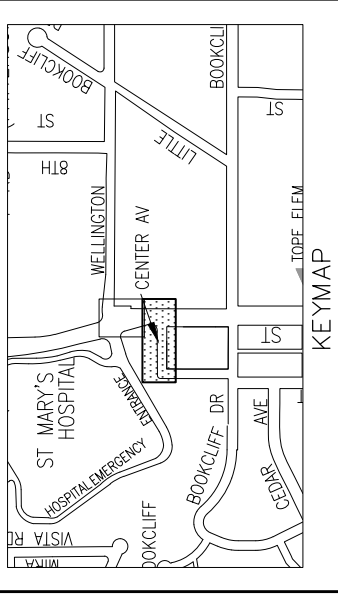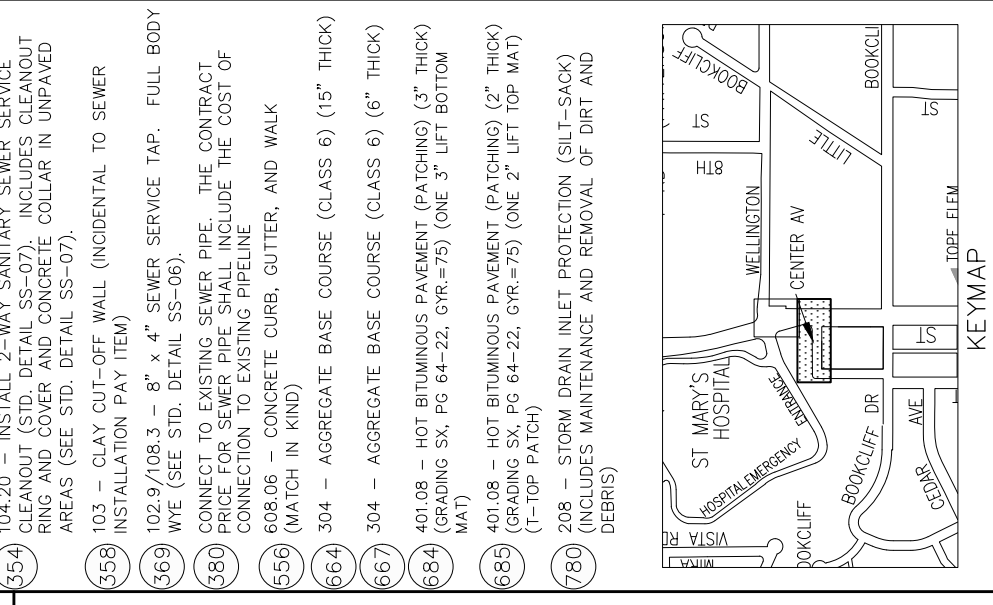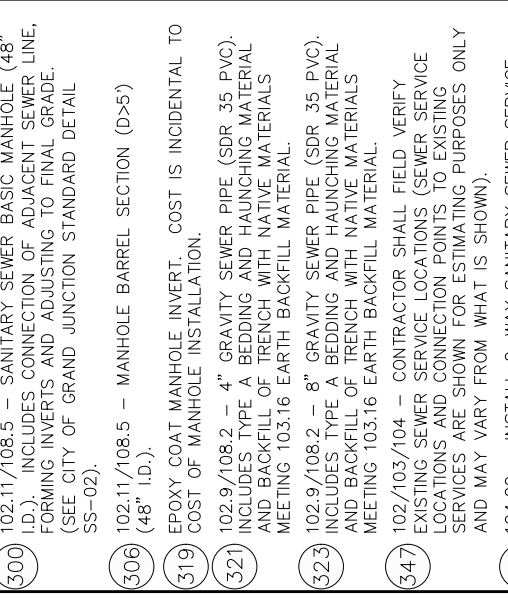

MATCH LINE SEE SHEET 16

SEE SHEET 15 MATCH LINE

MH E4-261-013
48" DIA SAN SEW MH
STA 3+29.25, 0+00
N 43774.72
E 92250.50

CP /PK-W CENTER/
N 43797.1280
E 92208.88
EL 4639.97

2945-111-01-005
601 CENTER AVE
GRAND JCT., CO 81501
ALKE'S IVAN S

2945-111-28-001
2635 N 7TH ST
GRAND JCT., CO 81501
VINCENT SCOTT

2945-112-01-003
601 CENTER AVE
GRAND JCT., CO 81501
SISTERS OF CHARITY OF
LEAVENWORTH HEALTH SYSTEM INC

2635 N 7TH ST
GRAND JCT., CO 81501-8209

2635 N 7TH ST
GRAND JCT., CO 81501-8209




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GRAND JCT., CO 81501-8209

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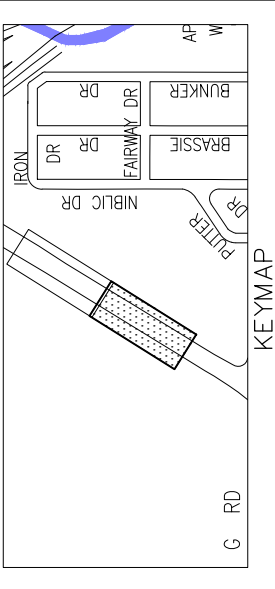
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2635 N 7TH ST
GRAND JCT., CO 81501-8209

2635 N 7TH ST
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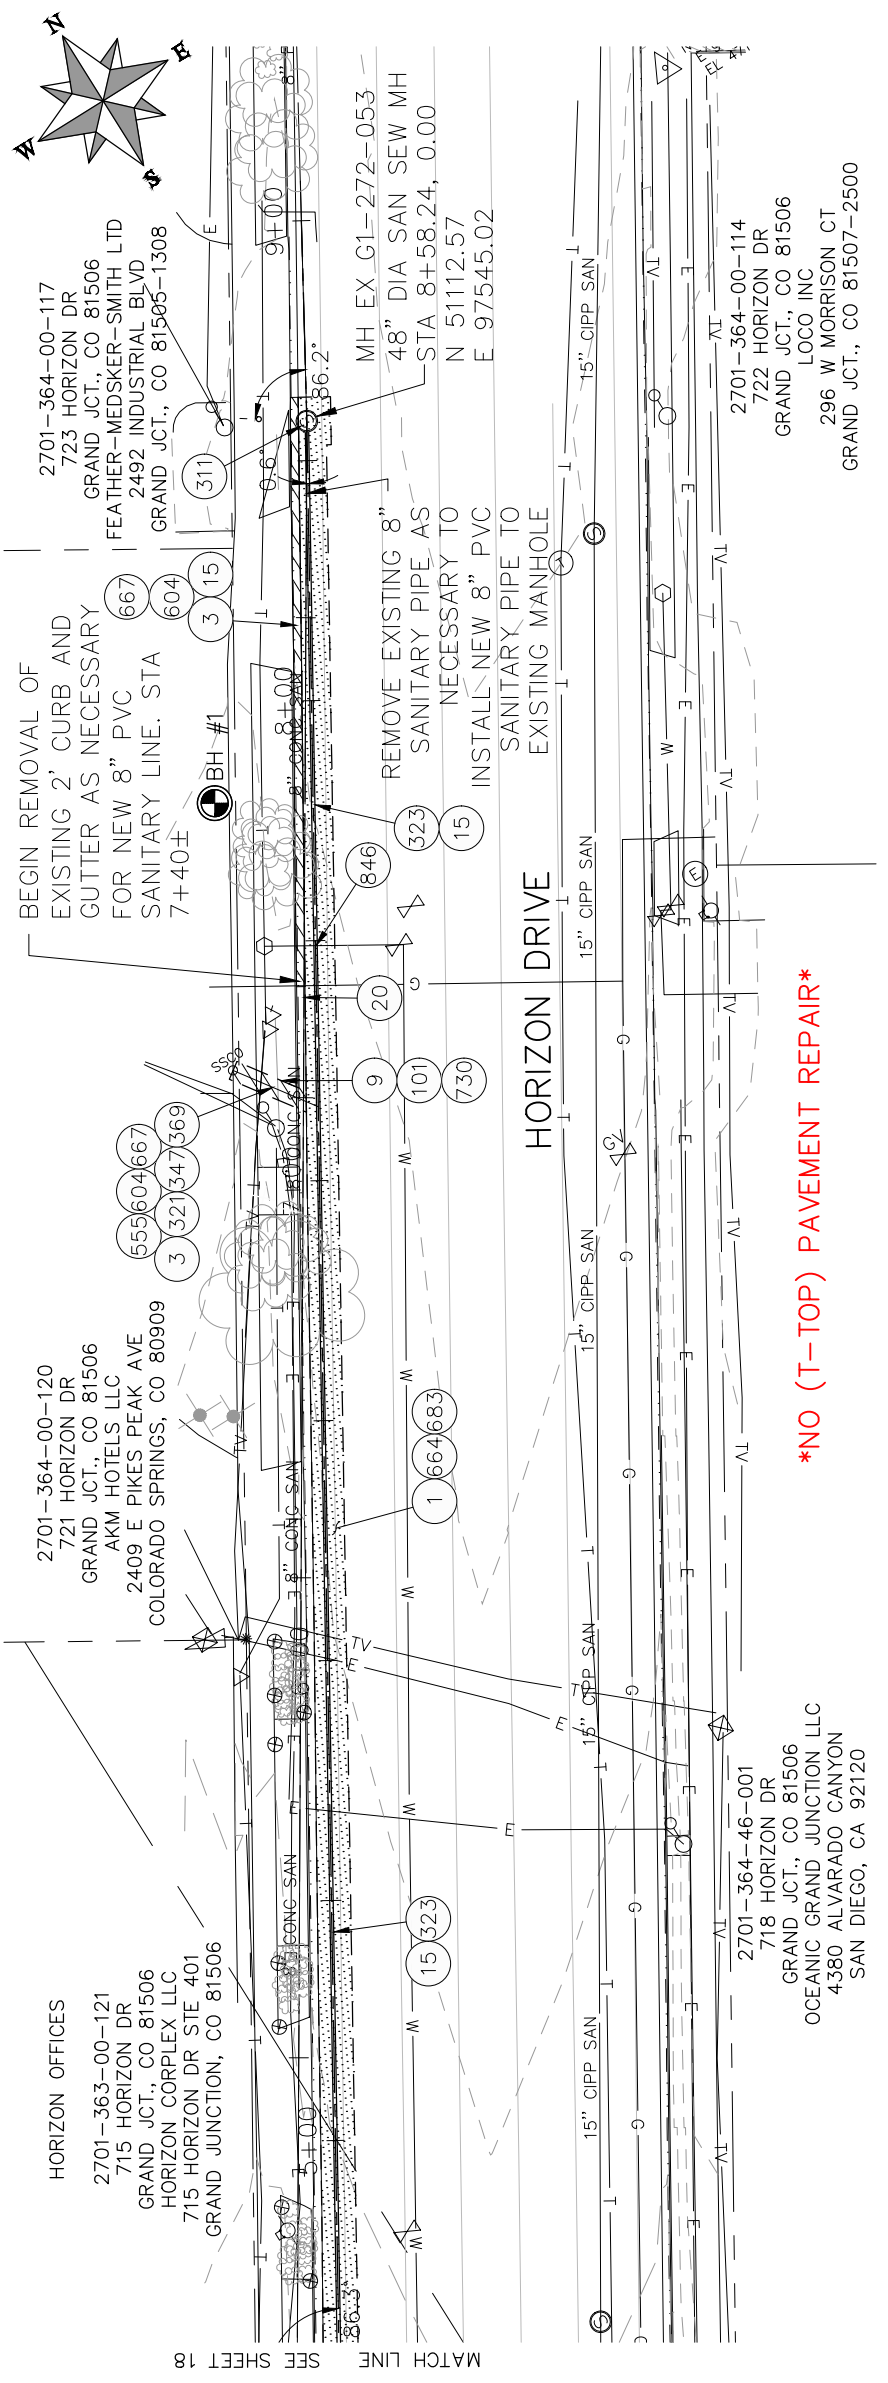
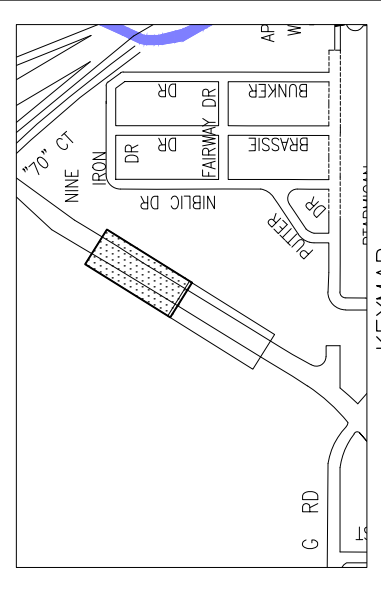
- CONSTRUCTION NOTES**
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 - 9 202 - REMOVAL OF SOD
 - 15 202 - REMOVAL OF PIPE AS SHOWN. (SIZE AND TYPE AS SHOWN ON PLAN)
 - 16 202 - REMOVAL OF MANHOLE. CONTRACTOR SHALL SALVAGE RING AND COVER AND DELIVER TO CITY SHOPS
 - 20 202 - ABANDON PIPE. ABANDON BY PLUGGING REMAINING ENDS WITH CONCRETE.
 - 101 210 - RESET SPRINKLER SYSTEM (COMPLETE IN PLACE)
 - 300 102.11/108.5 - SANITARY SEWER BASIC MANHOLE (48" I.D.). INCLUDES CONNECTION OF ADJACENT SEWER LINE, FORMING INVERTS AND ADJUSTING TO FINAL GRADE. (SEE CITY OF GRAND JUNCTION STANDARD DETAIL SS-02).
 - 306 102.11/108.5 - MANHOLE BARREL SECTION (D>S) (48" I.D.)
 - 311 102.11/108.5 - CONNECT TO EXISTING MANHOLE (SEE CITY OF GRAND JUNCTION STD. DETAIL SS-08)
 - 319 EPOXY COAT MANHOLE INVERT. COST IS INCIDENTAL TO COST OF MANHOLE INSTALLATION.
 - 321 102.9/108.2 - 4" GRAVITY SEWER PIPE (SDR 35 PVC). INCLUDES TYPE A BEDDING AND HAUNCHING MATERIAL AND BACKFILL OF TRENCH WITH NATIVE MATERIALS MEETING 103.16 EARTH BACKFILL MATERIAL.
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 - 358 103 - CLAY CUT-OFF WALL (INCIDENTAL TO SEWER INSTALLATION PAY ITEM)
 - 369 102.9/108.3 - 8" x 4" SEWER SERVICE TAP. FULL BODY WYE (SEE STD. DETAIL SS-06).
 - 380 CONNECT TO EXISTING SEWER PIPE. THE CONTRACT PRICE FOR SEWER PIPE SHALL INCLUDE THE COST OF CONNECTION TO EXISTING PIPELINE
 - 578 608.06 - CONCRETE DRIVEWAY SECTION (8" SECTION)
 - 604 608.06 - CONCRETE CURB AND GUTTER (MATCH IN KIND)
 - 664 304 - AGGREGATE BASE COURSE (GLASS 6) (15" THICK)
 - 667 304 - AGGREGATE BASE COURSE (GLASS 6) (6" THICK)
 - 683 401.08 - HOT BITUMINOUS PAVEMENT (PATCHING) (5" THICK) (GRADING SX, PG 64-22, GYR.=75) (TWO LIFTS)
 - 730 212 - RESOD AREA AS SHOWN (INCLUDES 4" THICK OF TOPSOIL)
 - 846 POTHOLE EXISTING UTILITY AHEAD OF CONSTRUCTION. COORDINATE ANY NEEDED DESIGN CHANGES WITH PROJECT ENGINEER SO AS TO AVOID UTILITY CONFLICTS.




PROJECT NO. 902-F001633

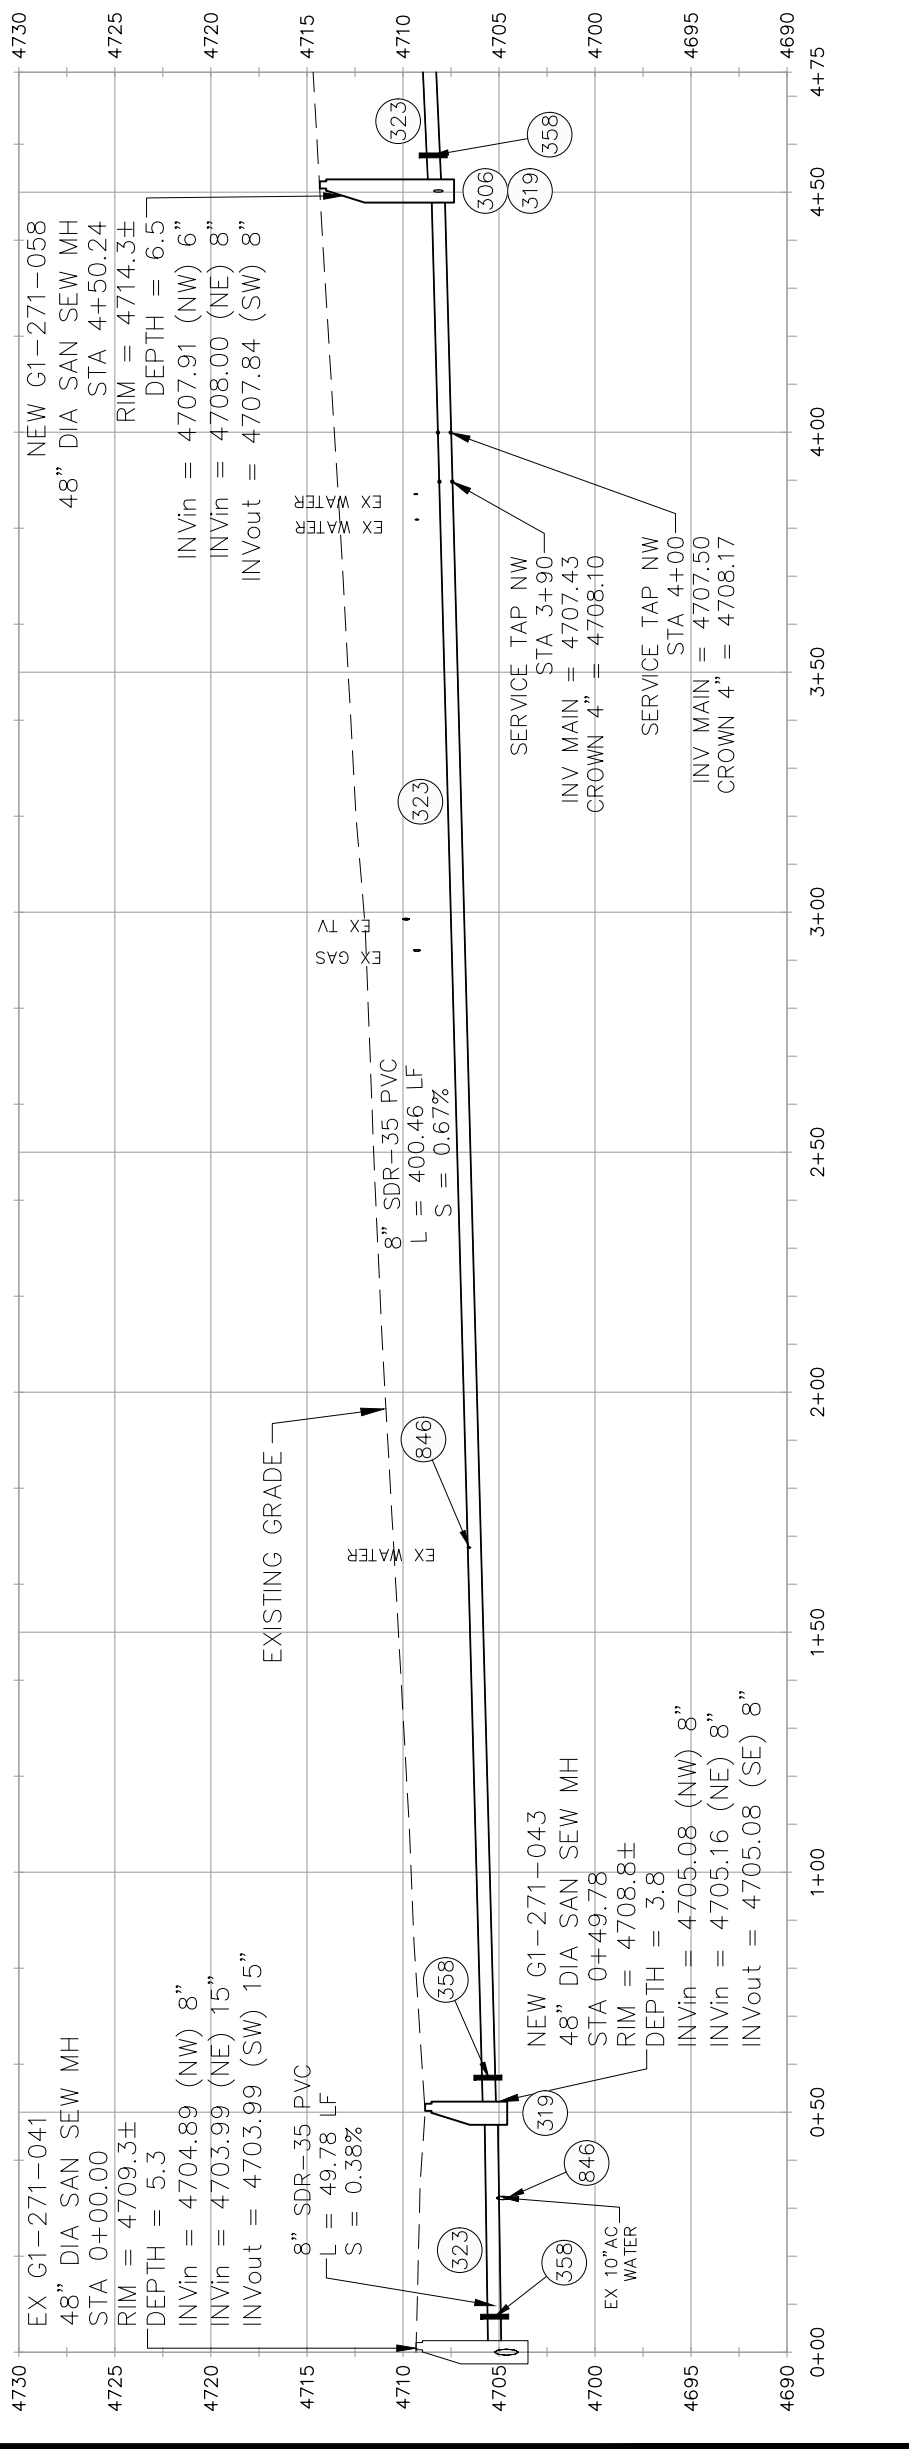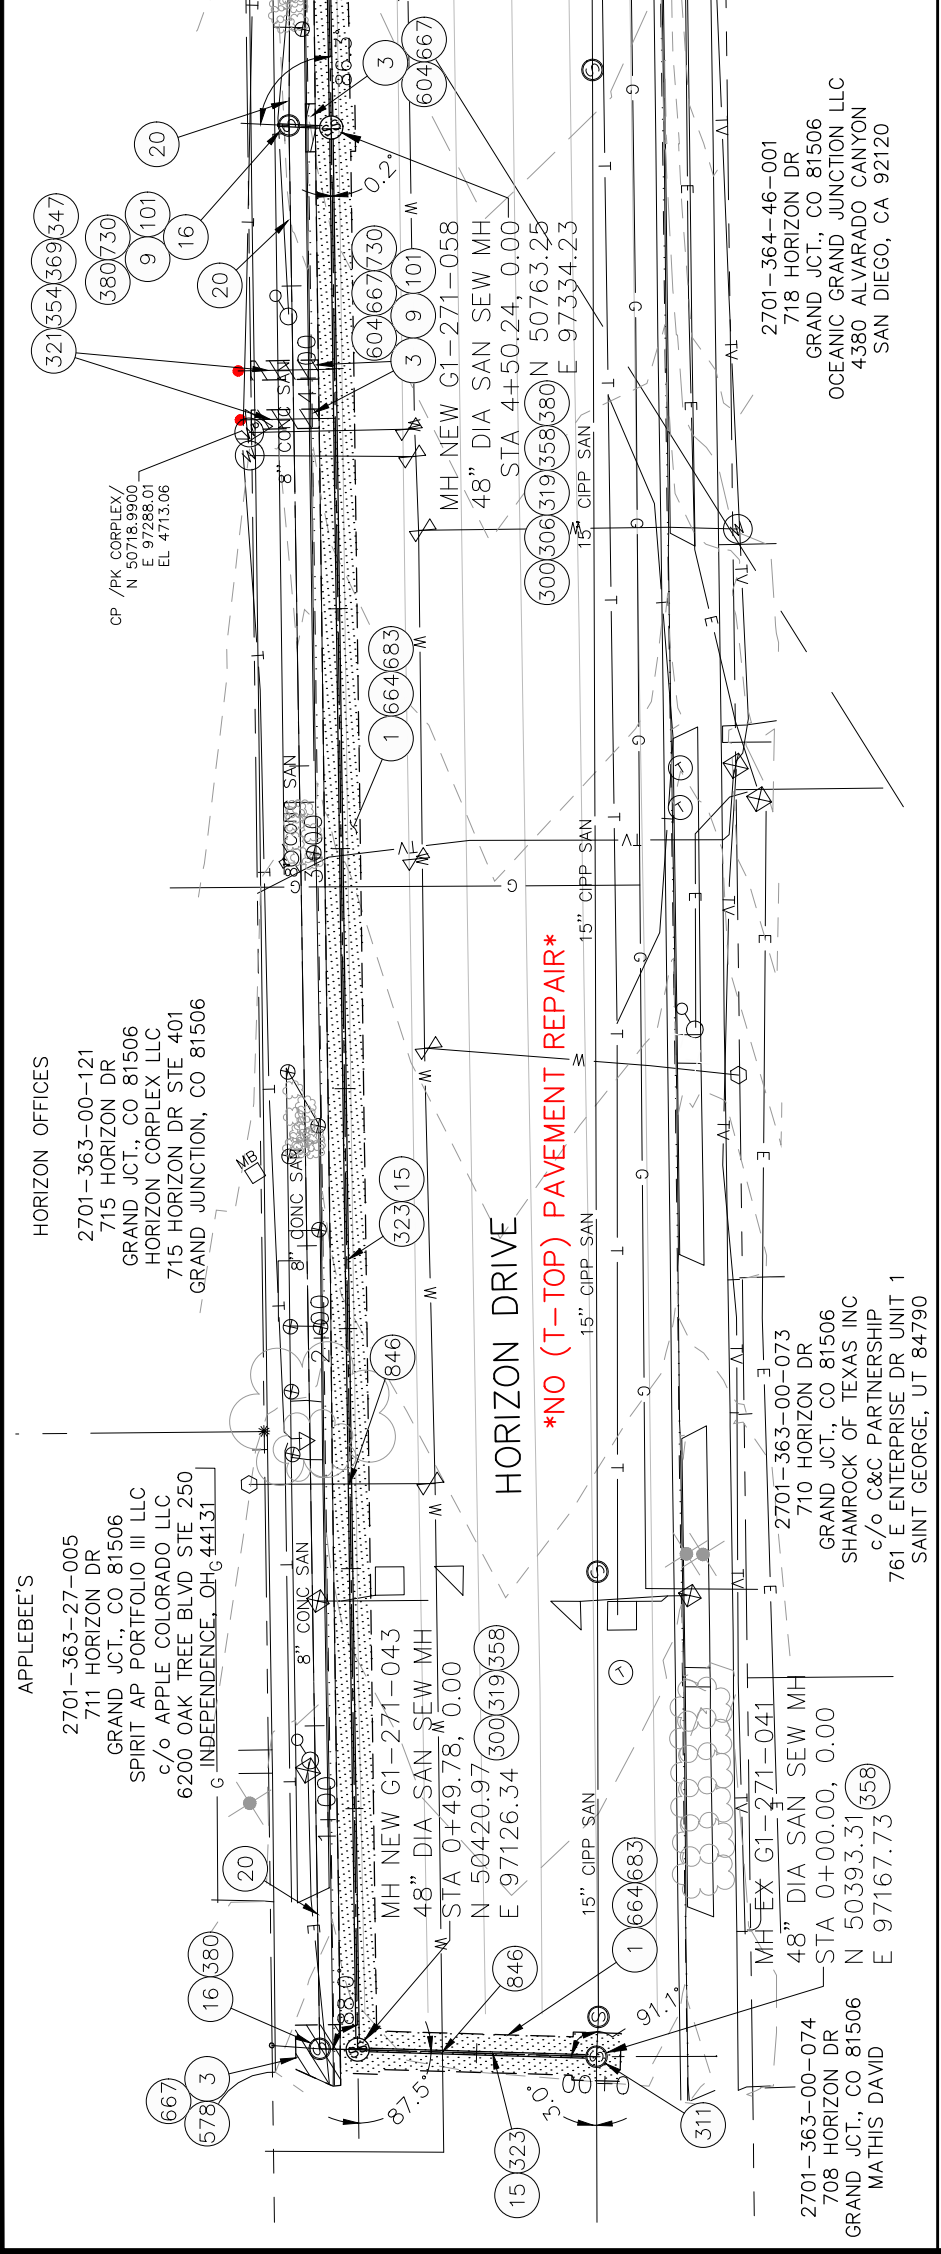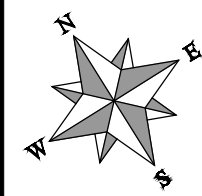CONSTRUCTION NOTES

- 1 202 - REMOVAL OF ASPHALT MAT. CUT AND REMOVE ASPHALT AS SHOWN. (INDICATED BY DOT HATCH PATTERN)
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- 101 210 - RESET SPRINKLER SYSTEM (COMPLETE IN PLACE)
- 311 102.11/108.5 - CONNECT TO EXISTING MANHOLE (SEE CITY OF GRAND JUNCTION STD. DETAIL SS-08)
- 321 102.9/108.2 - 4" GRAVITY SEWER PIPE (SDR 35 PVC). INCLUDES TYPE A BEDDING AND HAUNCHING MATERIAL AND BACKFILL OF TRENCH WITH NATIVE MATERIALS MEETING 103.16 EARTH BACKFILL MATERIAL.
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- 369 102.9/108.3 - 8" x 4" SEWER SERVICE TAP. FULL BODY WYE (SEE STD. DETAIL SS-06).
- 555 608.06 - CONCRETE SIDEWALK (4" THICK) (MATCH IN KIND)
- 604 608.06 - CONCRETE CURB AND GUTTER (MATCH IN KIND)
- 664 304 - AGGREGATE BASE COURSE (CLASS 6) (15" THICK)
- 667 304 - AGGREGATE BASE COURSE (CLASS 6) (6" THICK)
- 683 401.08 - HOT BITUMINOUS PAVEMENT (PATCHING) (5" THICK) (GRADING SX, PG 64-22, GYR.=75) (TWO LIFTS)
- 730 212 - RESOD AREA AS SHOWN (INCLUDES 4" THICK OF TOPSOIL)
- 846 POTHOLE EXISTING UTILITY AHEAD OF CONSTRUCTION. COORDINATE ANY NEEDED DESIGN CHANGES WITH PROJECT ENGINEER SO AS TO AVOID UTILITY CONFLICTS.



NO (T-TOP) PAVEMENT REPAIR

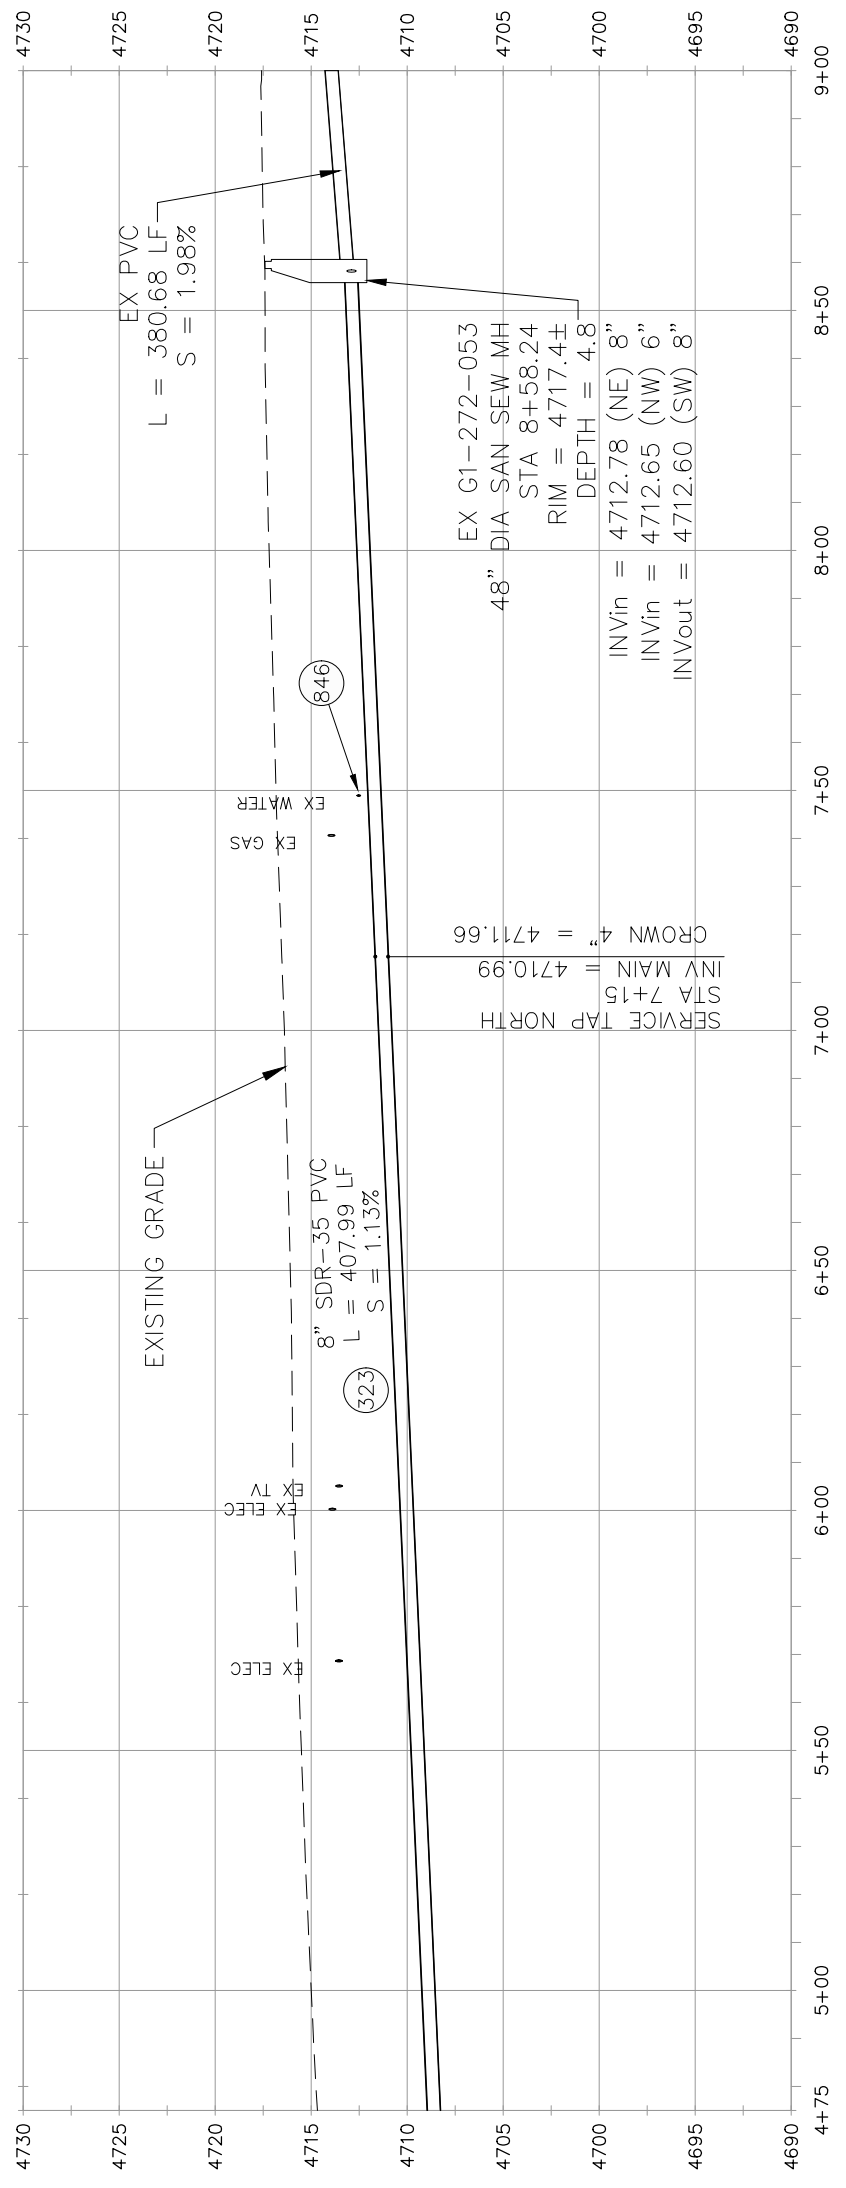

<p>REVISION Δ ADDENDUM #1 - REVISED PLANS</p> <p>REVISION Δ</p> <p>REVISION Δ</p> <p>REVISION Δ</p>	<p>DATE 04/09/18</p> <p>DATE 03/20/18</p> <p>DATE 03/20/18</p> <p>DATE</p>	<p>DRAWN BY BCH</p> <p>DESIGNED BY BCH</p> <p>CHECKED BY ALC</p> <p>APPROVED BY ALC</p>	<p>SCALES: PLAN & PROFILE</p> <p>HORIZONTAL: 1" = 40'</p> <p>10' 20' 40'</p> <p>VERTICAL: 1" = 10'</p> <p>0 2.5 5 10'</p>	<p>CITY OF Grand Junction COLORADO</p>	<p>PUBLIC WORKS ENGINEERING DIVISION</p>	<p>2018 SEWER LINE REPLACEMENT - PHASE A HORIZON DRIVE PLAN AND PROFILE STA 4+75 TO STA 9+00</p>	<p>19</p>
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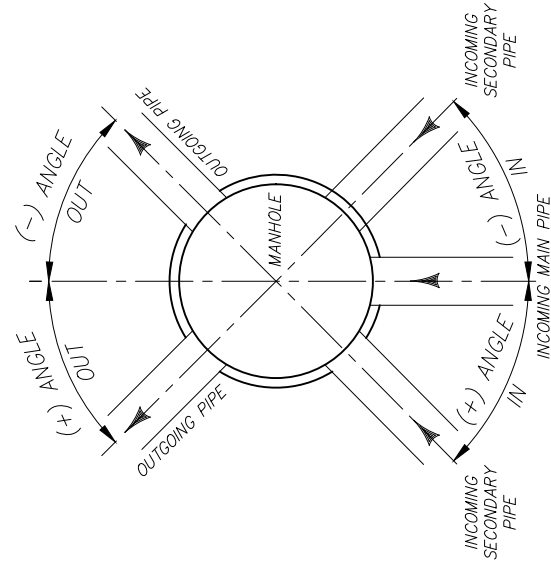
S 10TH ST AREA SANITARY MANHOLE SCHEDULE

SANITARY SEWER			
NAME	DETAILS	DEPTH	ANGLE
C3-262-067	STA = 12+20.92 DIA = 48" RIM = 4576.95 INV. OUT = 4571.06 (N), PIPE DIA = 8" FPVC INV. IN = 4571.22 (S), PIPE DIA = 8" PVC	5.89'	0.4° OUT
C3-262-068	STA = 14+06.75 DIA = 48" RIM = 4576.39 INV. OUT = 4571.85 (N), PIPE DIA = 8" PVC INV. IN = 4571.92 (S), PIPE DIA = 6" PVC (EXISTING)	4.54'	-0.2° OUT
C4-262-029	STA = 13+79.90 DIA = 48" RIM = 4574.95 INV. OUT = 4568.02 (S), PIPE DIA = 10" PVC INV. IN = 4568.86 (N), PIPE DIA = 8" VCP (EXISTING) INV. IN = 4568.12 (E), PIPE DIA = 10" PVC	6.94'	89.4° OUT -0.2° IN
C4-262-030	STA = 12+14.03 DIA = 48" RIM = 4573.31 INV. OUT = 4567.22 (S), PIPE DIA = 10" PVC INV. IN = 4567.51 (W), PIPE DIA = 8" VCP (EXISTING) INV. IN = 4567.27 (N), PIPE DIA = 10" PVC	6.09'	0.1° OUT -76.5° IN
C4-262-045	STA = 10+50.20 DIA = 48" RIM = 4572.98 INV. OUT = 4566.67 (W), PIPE DIA = 10" VCP (EXISTING) INV. IN = 4566.72 (N), PIPE DIA = 10" PVC INV. IN = 4566.67 (E), PIPE DIA = 8" VCP (EXISTING)	6.31'	-89.4° OUT 90.0° IN
C4-262-048	STA = 18+60.65 DIA = 48" RIM = 4576.46 INV. OUT = 4570.28 (W), PIPE DIA = 10" PVC INV. IN = 4570.29 (E), PIPE DIA = 8" FPVC INV. IN = 4570.28 (N), PIPE DIA = 8" VCP (EXISTING)	6.18'	0.9° OUT -90.9° IN
C4-262-063	STA = 5+31.03 DIA = 48" RIM = 4575.26 INV. IN = 4568.18 (E), PIPE DIA = 8" FPVC INV. OUT = 4568.18 (W), PIPE DIA = 8" VCP (EXISTING)	7.08'	-0.2° OUT
C4-262-064	STA = 23+40.59 DIA = 48" RIM = 4578.34 INV. OUT = 4571.55 (W), PIPE DIA = 8" FPVC INV. IN = 4571.55 (E), PIPE DIA = 8" PVC	6.79'	-0.4° OUT
C4-262-072	STA = 10+11.12 DIA = 48" RIM = 4576.90 INV. OUT = 4570.47 (W), PIPE DIA = 8" FPVC INV. IN = 4570.67 (S), PIPE DIA = 8" FPVC	6.43'	89.9° OUT
C4-262-072	STA = 28+21.15 DIA = 48" RIM = 4577.98 INV. OUT = 4572.92 (W), PIPE DIA = 8" PVC INV. IN = 4572.92 (E), PIPE DIA = 6" PVC (EXISTING)	5.06'	0.4° OUT



S 7TH STREET SANITARY MANHOLE SCHEDULE

SANITARY SEWER			
NAME	DETAILS	DEPTH	ANGLE
NEW C3-262-017	STA = 0+50 DIA = 48" RIM = 4567.67 INV. IN = 4562.23 (N), PIPE DIA = 8" PVC INV. OUT = 4562.21 (S), PIPE DIA = 10" PVC INV. IN = 4562.27 (E), PIPE DIA = 8" PVC	5.46'	-7.6° OUT 97.0° IN
NEW MH 2	STA = 1+00.39 DIA = 48" RIM = 4567.23 INV. OUT = 4562.39 (S), PIPE DIA = 8" PVC INV. IN = 4562.49 (N), PIPE DIA = 8" PVC	4.84'	7.1° OUT
NEW MH 3	STA = 3+78.74 DIA = 48" RIM = 4567.69 INV. OUT = 4562.93 (S), PIPE DIA = 8" PVC INV. IN = 4562.94 (N), PIPE DIA = 8" PVC INV. IN = 4562.94 (E), PIPE DIA = 8" PVC (EXISTING)	4.76'	0.0° OUT 90.0° IN
NEW MH 4	STA = 5+39.32 DIA = 48" RIM = 4568.24 INV. OUT = 4563.32 (S), PIPE DIA = 8" PVC INV. IN = 4563.42 (N), PIPE DIA = 8" PVC	4.98'	-1.2° OUT
NEW MH 5	STA = 7+08.98 DIA = 48" RIM = 4569.00 INV. OUT = 4563.76 (S), PIPE DIA = 8" PVC INV. IN = 4563.86 (E), PIPE DIA = 8" PVC	5.24'	91.0° OUT
NEW MH 6	STA = 11+53.06 DIA = 48" RIM = 4570.35 INV. OUT = 4564.74 (W), PIPE DIA = 8" PVC INV. IN = 4564.76 (E), PIPE DIA = 8" PVC	5.62'	0.8° OUT
NEW MH 7	STA = 13+07.53 DIA = 48" RIM = 4571.28 INV. OUT = 4565.07 (W), PIPE DIA = 8" PVC	6.20'	OUT ONLY



MANHOLE PIPE ANGLE DETAIL

REVISION **A** ADDENDUM #1 - REVISED PLANS - DATE 04/09/18
 REVISION **B** _____
 REVISION **C** _____
 REVISION **D** _____

DRAWN BY: BCH DATE: 03/20/18
 DESIGNED BY: BCH DATE: 03/20/18
 CHECKED BY: ALC DATE: _____
 APPROVED BY: ALC DATE: _____

SCALES: PLAN & PROFILE
 HORIZONTAL: 1" = NA
 VERTICAL: 1" = NA

Grand Junction
 CITY OF
 COLORADO

PUBLIC WORKS
 ENGINEERING DIVISION

2018 SEWER LINE REPLACEMENT - PHASE A
 SEWER MANHOLE STRUCTURE SCHEDULE 1


1 N 7TH ST SANITARY MANHOLE SCHEDULE

SANITARY SEWER			
NAME	DETAILS	DEPTH	ANGLE
E4-261-079	STA = 0+25 DIA = 48" RIM = 4636.17 INV. IN = 4629.64 (E), PIPE DIA = 8" PVC INV. OUT = 4629.63 (W), PIPE DIA = 8" VCP INV. IN = 4629.73 (N), PIPE DIA = 6" RCP INV. IN = 4629.99 (S), PIPE DIA = 8" VCP <i>(EXISTING)</i> <i>(EXISTING)</i> <i>(EXISTING)</i>	6.54'	0.6° OUT -87.5° IN 92.0° IN
E4-261-083	STA = 1+60.81 DIA = 48" RIM = 4638.29 INV. IN = 4630.47 (E), PIPE DIA = 8" PVC INV. OUT = 4630.47 (W), PIPE DIA = 8" PVC	7.82'	0.8° OUT
E4-262-013	STA = 2+43.71 DIA = 48" RIM = 4640.46 INV. IN = 4631.27 (N), PIPE DIA = 8" PVC INV. OUT = 4631.21 (W), PIPE DIA = 8" PVC INV. IN = 4631.34 (S), PIPE DIA = 8" PVC	9.25'	-89.6° IN 90.3° IN
E4-262-014	STA = 1+40.43 DIA = 48" RIM = 4639.37 INV. IN = 4631.62 (S), PIPE DIA = 8" PVC INV. OUT = 4631.48 (N), PIPE DIA = 8" PVC INV. IN = 4631.62 (E), PIPE DIA = 8" VCP <i>(EXISTING)</i>	7.89'	0.6° OUT -91.4° IN
E4-262-017	STA = 0+25 DIA = 48" RIM = 4638.37 INV. OUT = 4631.93 (N), PIPE DIA = 8" PVC INV. IN = 4631.98 (S), PIPE DIA = 8" VCP <i>(EXISTING STUB)</i>	6.44'	-1.0° OUT
NEW E4-262-012	STA = 5+00 DIA = 48" RIM = 4644.66 INV. IN = 4632.05 (N), PIPE DIA = 8" VCP INV. OUT = 4632.03 (S), PIPE DIA = 8" PVC	12.63'	OUT ONLY



HORIZON DRIVE SANITARY MANHOLE SCHEDULE

SANITARY SEWER			
NAME	DETAILS	DEPTH	ANGLE
EX G1-271-041	STA = 0+00 DIA = 48" RIM = 4709.32 INV. IN = 4704.89 (NW), PIPE DIA = 8" PVC INV. OUT = 4703.99 (SW), PIPE DIA = 15" CIPP <i>(EXISTING)</i> INV. IN = 4703.99 (NE), PIPE DIA = 15" CIPP <i>(EXISTING)</i>	5.33'	-91.1° IN 3.0° OUT
EX G1-272-053	STA = 8+58.24 DIA = 48" RIM = 4717.41 INV. IN = 4712.78 (NE), PIPE DIA = 8" PVC <i>(EXISTING)</i> INV. IN = 4712.65 (NW), PIPE DIA = 6" PVC <i>(EXISTING)</i> INV. OUT = 4712.60 (SW), PIPE DIA = 8" PVC	4.81'	-86.2° IN -0.6° OUT
NEW G1-271-043	STA = 0+49.78 DIA = 48" RIM = 4708.85 INV. OUT = 4705.08 (SE), PIPE DIA = 8" PVC INV. IN = 4705.08 (NW), PIPE DIA = 8" RCP <i>(EXISTING)</i> INV. IN = 4705.16 (NE), PIPE DIA = 8" PVC	3.77'	87.5° OUT -88.0° IN
NEW G1-271-058	STA = 4+50.24 DIA = 48" RIM = 4714.33 INV. IN = 4707.91 (NW), PIPE DIA = 6" PVC <i>(EXISTING)</i> INV. OUT = 4707.84 (SW), PIPE DIA = 8" PVC INV. IN = 4708.00 (NE), PIPE DIA = 8" PVC	6.49'	-86.3° IN -0.2° OUT

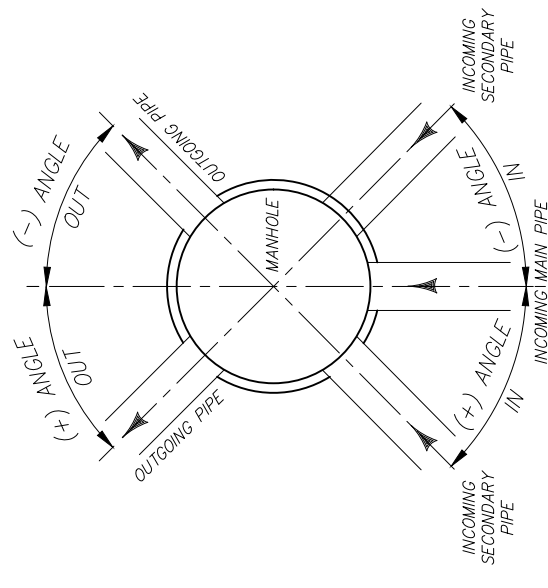

MANHOLE PIPE ANGLE DETAIL

REVISION Δ ADDENDUM #1 - REVISED PLANS - 04/09/18	DATE	DRAWN BY	DATE	DESIGNED BY	DATE	CHECKED BY	DATE	APPROVED BY	DATE
REVISION Δ									
REVISION Δ									
REVISION Δ									



PUBLIC WORKS
ENGINEERING DIVISION

2018 SEWER LINE REPLACEMENT - PHASE A
SEWER MANHOLE STRUCTURE SCHEDULE 2

BOREHOLE LOG KEY

BOREHOLE LOCATION: Horizon Drive at Rowday Inn by Shell Station (in grassy area by sidewalk)
DRILLING COMPANY: HRL / Chaney
DRILL RIG: CHE 55
DRILL STEM: 4" SSA
SAMPLER: Standard SSS

DEPTH (ft)	GRAPHIC	SAMPLE #	SAMPLE #	FIELD BLOW COUNTS	FIELD "N" VALUE (BPF)	SPT "N" VALUE (BPF)	SUBSURFACE DESCRIPTION	FIELD & LABORATORY TEST RESULTS
5	CA	ST	DS1	4, 4, 3	7	7	reddish-brown, dry, firm to stiff, silty/sandy CLAY (0-6.5') harder drilling at 5' (possibly weathered shale)	DS1 @ 3-4.5' (CL) MC=13.9%
10				13, 13, 16	29	29		DS2 @ 6-7.5' (CL) LL=41 PI=21 PF=20 gravel=0.1% sand=19.7% silt=35.5% clay=44.7% MC=13.9%
15				23, 28, 50	78	78		DS3 @ 9-10.5' (CL) water soluble sulfates=0.70% chlorides=0.021% Electro-conductivity=320 µS/cm pH=6.9 MC=12.8%
20				16, 24, 29	53	53		DS4 @ 12-13.5' (CL) MC=11.9%
25				24, 24, 30	54	54		DS5 @ 15-16.5' (CL) MC=10.9%

Notes in this column indicate tests performed and test results:
 DD: dry density,pcf
 MC: moisture content, %
 LL: liquid limit
 PL: plastic limit
 PI: plasticity index
 GF: gravel fraction, %
 SF: sand fraction, %
 Fines: silt/clay, %
 Sh: Shear resistance
 P: Penetration resistance
 CBR: California Bearing Ratio
 SP: swelling pressure
 TH: total movement
 UCS: unconfined compressive strength
 psf: pounds per square foot
 pcf: pounds per cubic foot
 psi: pounds per square inch

Unified Soil Classification System (ASTM D-2487)
 CL = lean clay to sandy/gravelly lean clay
 ML = silt to sandy/gravelly silt
 CH = high plasticity clay to sandy/gravelly high plasticity clay
 MH = high plasticity silt to sandy/gravelly high plasticity silt
 SW = well-graded sand or well-graded sand with gravel
 SP = poorly graded sand or poorly graded sand with gravel
 SH = silt/sand to silty sand with gravel
 SC = clayey sand to clayey sand with gravel
 GW = well-graded gravel or well-graded gravel with sand
 GP = poorly graded gravel or poorly graded gravel with sand
 GM = silty gravel or silty gravel with sand
 GC = clayey gravel or clayey gravel with sand

Rock Weathering Classification
 W1 = Fresh
 W2 = Slightly weathered
 W3 = Moderately weathered
 W4 = Highly weathered
 W5 = Completely weathered
 W6 = Residual soil, no structure
 RQD = Rock Quality Designation

Intact Rock Strength Classification
 R0 = Extremely weak rock, 35-150 psi
 R1 = Very weak rock, 150-725 psi
 R2 = Weak rock, 725-3,625 psi
 R3 = Medium strong rock, 3,625-7,250 psi
 R4 = Strong rock, 7,250-14,500 psi
 R5 = Very strong rock, 14,500-36,000 psi
 R6 = Extremely strong rock, >36,000 psi

Log of Borehole #1 (BH#1)

BOREHOLE LOCATION: southwest corner of N. 7th & Center Ave.
DRILLING COMPANY: HRL / Chaney
DRILL RIG: CHE 55
DRILL STEM: 4" SSA
SAMPLER: Standard SSS

DEPTH (ft)	GRAPHIC	SAMPLE #	SAMPLE #	FIELD BLOW COUNTS	FIELD "N" VALUE (BPF)	SPT "N" VALUE (BPF)	SUBSURFACE DESCRIPTION	FIELD & LABORATORY TEST RESULTS
2							~3" asphalt ~6" road base	
4							reddish brown CLAY, some gravel, possible fill above 2' (0.75-2')	
6							brown, soft to very soft, moist to very damp, CLAY (2-6) wet seam @ 4' (~2" thick)	DS6 @ 3-4.5' (CL) MC=22.4%
8								DS7 @ 6-7.5' (SC) water soluble sulfates=0.03% chlorides=0.001% Electro-conductivity=50µS/cm pH=7.4 MC=13.6%
10							brown, soft, moist, soft to firm, sandy/clayey SILT (6-12.25')	DS8 @ 9-10.5' (SM/CL) LL=24 PI=16 PF=8 gravel=0.0% sand=15.2% silt=54.0% clay=30.8% MC=18.2%
12							brown, very soft, very moist, brown CLAY with silt (12.25-13.5')	
14							end of hole @ 13.5' no groundwater or bedrock encountered	DS9 @ 12-13.5' (CL) MC=18.6%

Log of Borehole #2 (BH#2)

BOREHOLE LOCATION: southwest corner of N. 7th & Center Ave.
DRILLING COMPANY: HRL / Chaney
DRILL RIG: CHE 55
DRILL STEM: 4" SSA
SAMPLER: Standard SSS

DEPTH (ft)	GRAPHIC	SAMPLE #	SAMPLE #	FIELD BLOW COUNTS	FIELD "N" VALUE (BPF)	SPT "N" VALUE (BPF)	SUBSURFACE DESCRIPTION	FIELD & LABORATORY TEST RESULTS
2							~3" asphalt ~6" road base	
4							reddish brown CLAY, some gravel, possible fill above 2' (0.75-2')	
6							brown, soft to very soft, moist to very damp, CLAY (2-6) wet seam @ 4' (~2" thick)	DS6 @ 3-4.5' (CL) MC=22.4%
8								DS7 @ 6-7.5' (SC) water soluble sulfates=0.03% chlorides=0.001% Electro-conductivity=50µS/cm pH=7.4 MC=13.6%
10							brown, soft, moist, soft to firm, sandy/clayey SILT (6-12.25')	DS8 @ 9-10.5' (SM/CL) LL=24 PI=16 PF=8 gravel=0.0% sand=15.2% silt=54.0% clay=30.8% MC=18.2%
12							brown, very soft, very moist, brown CLAY with silt (12.25-13.5')	
14							end of hole @ 13.5' no groundwater or bedrock encountered	DS9 @ 12-13.5' (CL) MC=18.6%

REVISION Δ

REVISION Δ

REVISION Δ

REVISION Δ

DESCRIPTION

DATE

DRAWN BY BCH DATE 03/20/18

DESIGNED BY BCH DATE 03/20/18

CHECKED BY ALC DATE

APPROVED BY ALC DATE

SCALES: PLAN & PROFILE

HORIZONTAL: 1" = NA




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Grand Junction
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PUBLIC WORKS
ENGINEERING DIVISION

2018 SEWER LINE REPLACEMENT - PHASE A
SOIL BORING LOG DETAIL 1

22



REVISION	DESCRIPTION	DATE	DRAWN BY	DATE
REVISION			DESIGNED BY	DATE
REVISION			CHECKED BY	DATE
REVISION			APPROVED BY	DATE

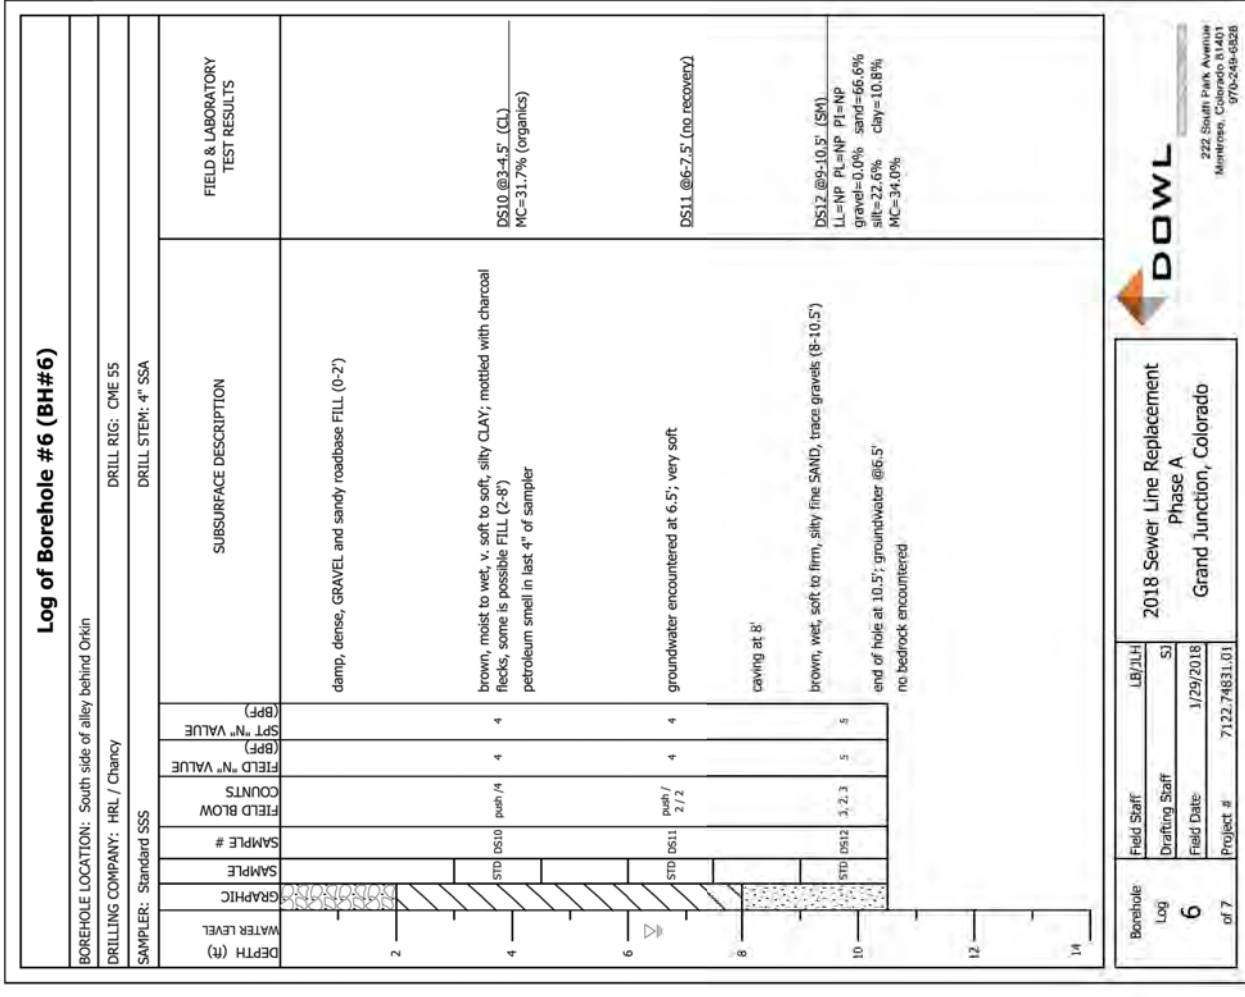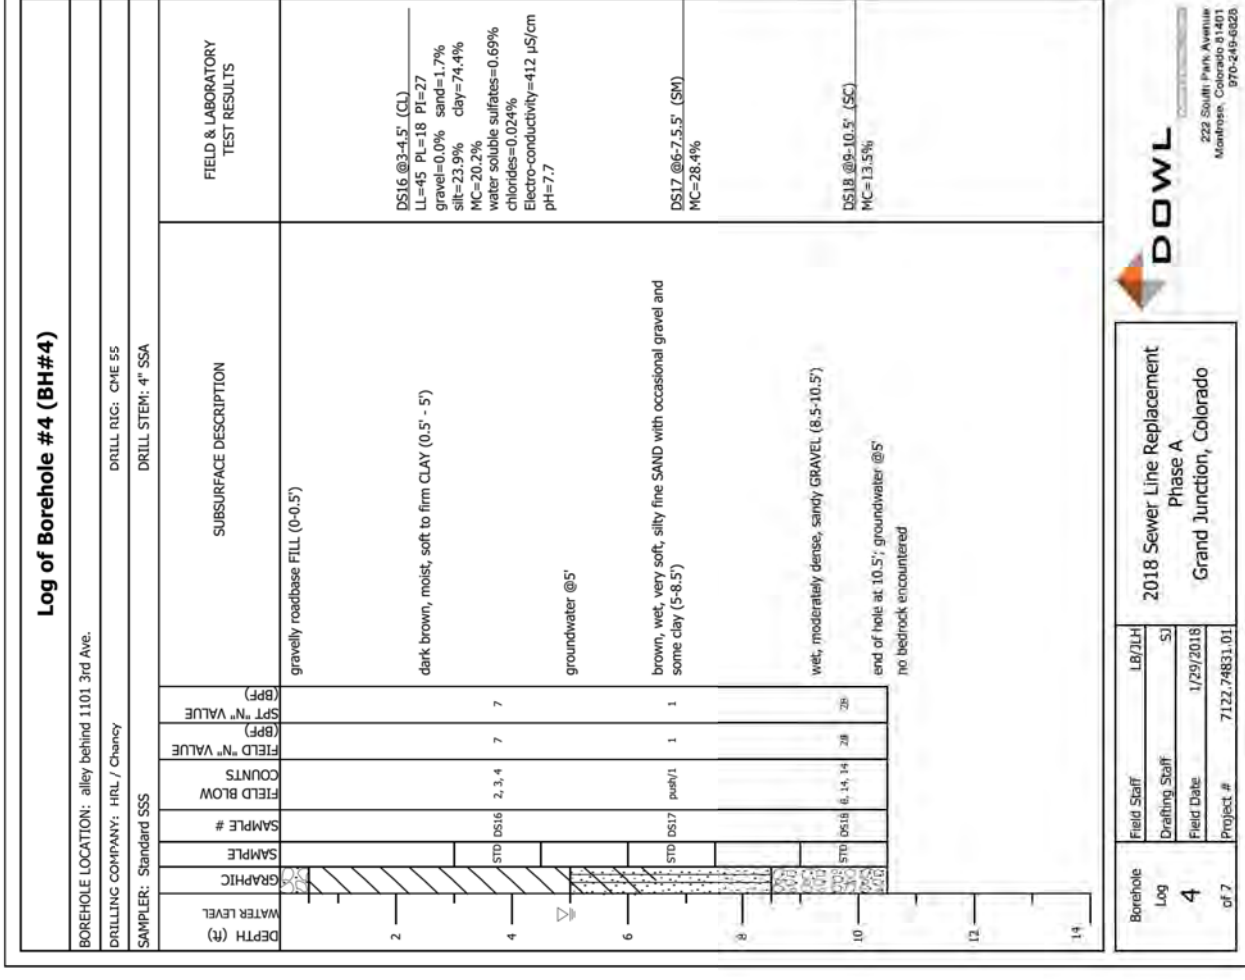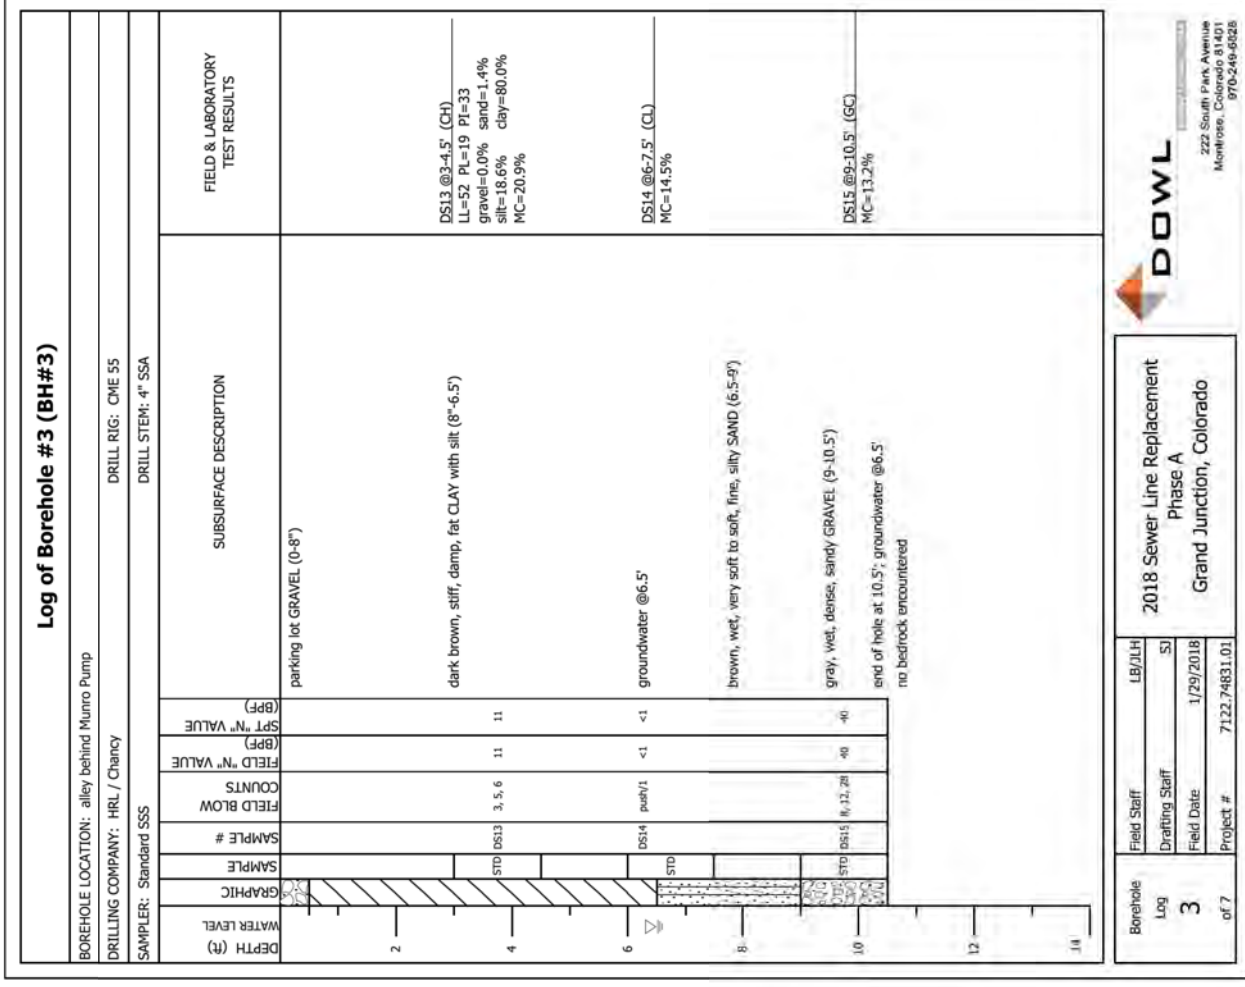

PUBLIC WORKS
ENGINEERING DIVISION

2018 SEWER LINE REPLACEMENT - PHASE A
SOIL BORING LOG DETAIL 2

GENERAL NOTES


- A. CONTRACTOR SHALL HAVE ONE SIGNED COPY OF PLANS AND A COPY OF THE CITY OF GRAND JUNCTION'S STANDARD SPECIFICATIONS AT THE JOB SITE AT ALL TIMES.
- B. ALL SEWER MAINS SHALL BE PVC SDR 35 (ASTM 3034) UNLESS OTHERWISE NOTED.
- C. ALL SEWER MAINS SHALL BE LAID TO GRADE UTILIZING A PIPE LASER.
- D. ALL SERVICE LINE CONNECTIONS TO NEW MAINS SHALL BE ACCOMPLISHED WITH FULL BODY WYES OR TEES. TAPPING SADDLES WILL NOT BE ALLOWED.
- E. SERVICE LINE CONNECTIONS TO EXISTING NON-PVC MAINS SHALL BE ACCOMPLISHED USING "INSERTA TEES" MANUFACTURED BY FOWLER MANUFACTURING COMPANY OF HILLSBORO, OREGON. FOR EXISTING PVC MAINS, TAPPING SADDLES SHALL BE USED.
- F. 4-INCH SERVICES SHALL NOT BE CONNECTED DIRECTLY INTO MANHOLES. ALL 6 INCH SERVICES SHALL BE CONNECTED TO THE MAIN AT A MANHOLE.
- G. THE CONTRACTOR SHALL NOTIFY THE CITY INSPECTOR 48 HOURS PRIOR TO COMMENCEMENT OF CONSTRUCTION.
- H. THE CONTRACTOR IS RESPONSIBLE FOR ALL REQUIRED SEWER LINE TESTING TO BE COMPLETED IN THE PRESENCE OF THE ENGINEER OR HIS REPRESENTATIVE. PRESSURE TESTING WILL BE PERFORMED AFTER INSTALLATION OF DRY UTILITIES, AFTER ALL COMPACTION OF STREET SUBGRADE AND PRIOR TO STREET PAVING. FINAL LAMPING WILL ALSO BE ACCOMPLISHED AFTER PAVING IS COMPLETED. THESE TESTS SHALL BE THE MINIMUM BASIS OF ACCEPTANCE OF THE SEWER LINE EXTENSION.
- I. THE CONTRACTOR SHALL OBTAIN CITY OF GRAND JUNCTION STREET CUT PERMIT FOR ALL WORK WITHIN EXISTING CITY RIGHT-OF-WAY PRIOR TO CONSTRUCTION.
- J. A CLAY CUT-OFF WALL SHALL BE PLACED 10 FEET UPSTREAM FROM ALL NEW MANHOLES UNLESS OTHERWISE NOTED. THE CUT-OFF WALL SHALL EXTEND FROM 6 INCHES BELOW TO 6 INCHES ABOVE GRANULAR BACKFILL MATERIAL AND SHALL BE 2 FEET WIDE. IF NATIVE MATERIAL IS NOT SUITABLE, THE CONTRACTOR SHALL IMPORT MATERIAL APPROVED BY THE ENGINEER.
- K. SEWER SERVICE STUB OUTS SHALL BE CAPPED AND PLUGGED. STUB OUT SHALL BE MARKED WITH A 4X4 INCH POST PAINTED GREEN BURIED WITH 3 FEET ABOVE GRADE. AS-BUILT SURVEYING FOR VERTICAL GRADE OF STUB OUT REQUIRED PRIOR TO BACKFILL.
- L. RED LINE AS-BUILTS SHALL BE SUBMITTED TO THE CITY UTILITY ENGINEER AT LEAST 72 HOURS PRIOR TO PAVING FOR REVIEW.

MANHOLE NOTES

1. ALL PROPOSED MANHOLES SHALL BE PRE-CAST CONCRETE.
2. CONCRETE SHALL BE COLORADO DEPARTMENT OF TRANSPORTATION CLASS "B" (SECTION 601.02).
3. ALL CEMENT USED IN MORTAR, CONCRETE BASES, GRADE RINGS, RISER SECTIONS AND CONES FOR SANITARY SEWER MANHOLES, SHALL BE TYPE V OR MODIFIED TYPE II PORTLAND CEMENT WITH LESS THAN 5% TRICALCIUM ALUMINATE.
4. MANHOLE RISER SECTIONS, CONES AND GRADE RINGS SHALL BE PRECAST REINFORCED CONCRETE CONFORMING TO ASTM C-478 OR AASHTO M-199.
5. BACKFILL AROUND MAHOLES AND OTHER PIPELINE STRUCTURES SHALL BE PLACED IN 8" MAX. LIFTS AND COMPACTED TO 95% AASHTO T-99 WITH HAND OPERATED MECHANICAL EQUIPMENT.
6. ALL WORK SHALL BE IN ACCORDANCE WITH APPROVED PLANS AND CITY SPECIFICATION.
7. THE MANHOLE CONE AND BARREL SECTIONS SHALL BE POSITIONED SUCH THAT THE MANHOLE RING AND STEPS ARE AT A 45° ANGLE FROM THE INLET PIPE (SEE SHEET D4).
8. MANHOLE RING AND COVER SHALL BE SET TO FINISH GRADE USING NON-SHRINK GROUT TO ADJUST RIM ELEVATION. GROUT SHALL NOT EXCEED 2" THICKNESS. GROUT SHALL BE PLACED BETWEEN TOP OF CONCRETE GRADE RING AND RING AND COVER. STEEL GRADE ADJUSTMENT RINGS MAY BE USED FOR ADJUSTMENT OF MANHOLE COVERS ONLY WHEN STREETS ARE OVERLAID.
9. INVERTED MANHOLE RINGS WILL NOT BE ALLOWED UNLESS APPROVED BY THE ENGINEER.
10. WHERE REQUIRED, EPOXY SHALL BE APPLIED AT THE FACTORY.

ALL PRECAST MANHOLE SECTIONS SHALL CONFORM TO ASTM C-478 OR AASHTO M-199

PROJECT NO. 902-F001633

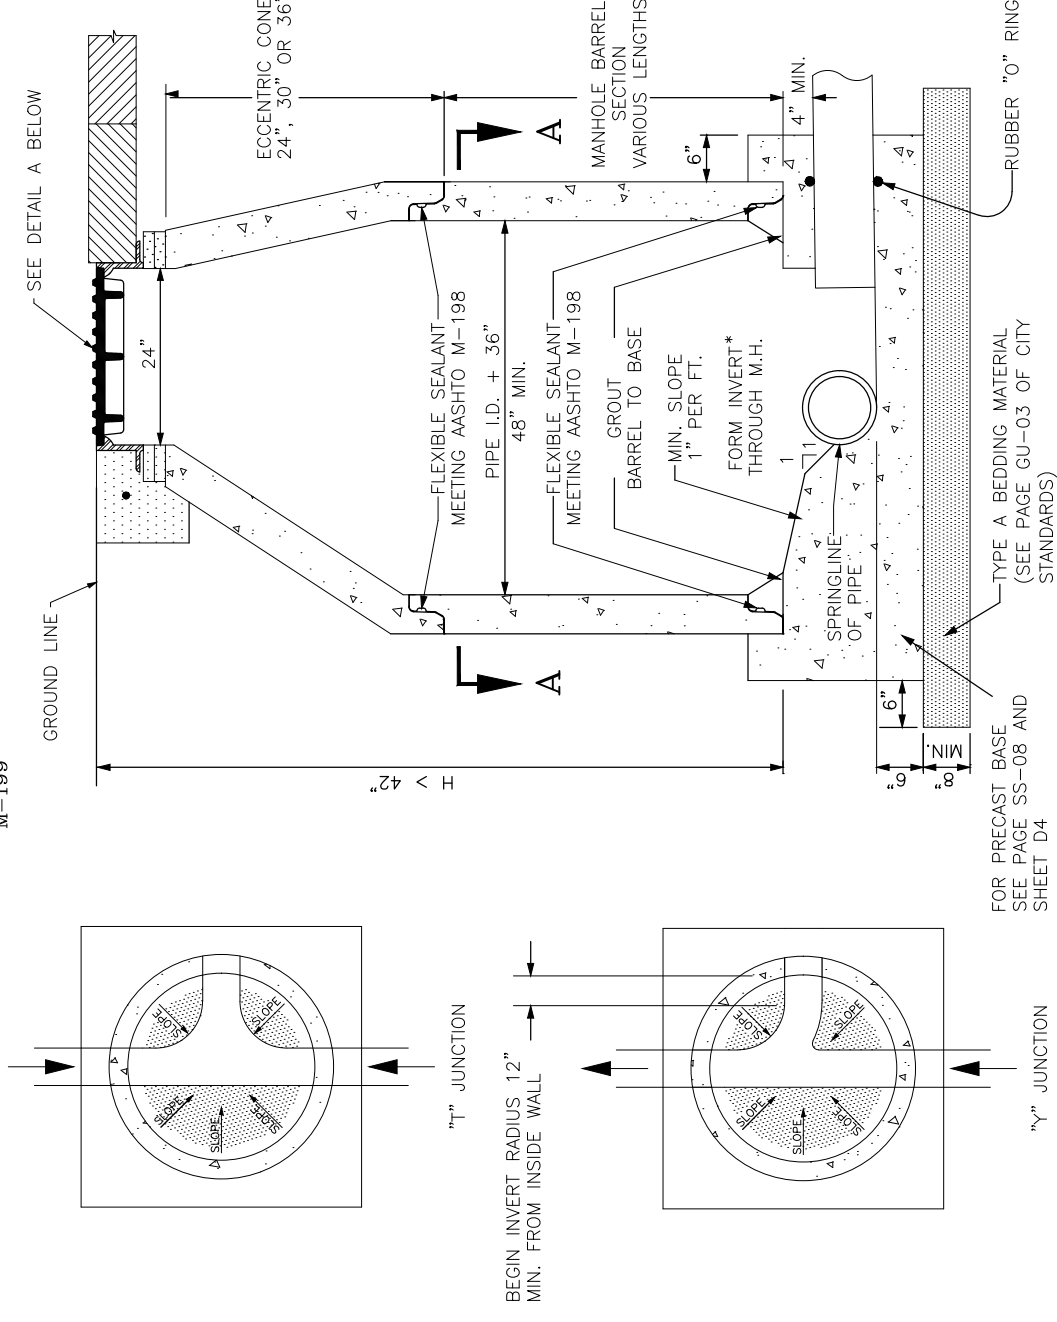

INVERTS SHALL BE FORMED TO PROVIDE A 12" MIN. APPROACH IN LINE WITH EACH PIPE FOR MAINTENANCE EQUIPMENT.

SECTION A-A

STANDARD M.H. RING & COVER (CASTINGS INC. M.H.-250-24" C.I. OR APPROVED SUBSTITUTE) SEE DETAIL PAGE SS-05 AND SHEET D3

ADJUST MANHOLE RING AND COVER TO MATCH SLOPE OF PAVEMENT. TOP OF KNOBS ON MANHOLE LID SHALL BE FLUSH WITH TOP OF PAVEMENT

811
CALL UTILITY NOTIFICATION CENTER OF COLORADO BEFORE YOU DIG GRADE OR EXCAVATE FOR THE MARKING OF UNDERGROUND MEMBER UTILITIES

CONCRETE COLLAR REQUIRED IN UNPAVED AREAS

DETAIL A

GENERAL SEWER NOTES

REVISION Δ	DATE	DRAWN BY BCH	DATE 03/20/18	SCALES: PLAN & PROFILE
REVISION Δ		DESIGNED BY BCH	DATE 03/20/18	HORIZONTAL: 1" = NA
REVISION Δ		CHECKED BY ALC	DATE	VERTICAL: 1" = NA
REVISION Δ		APPROVED BY ALC	DATE	

CITY STANDARD SANITARY SEWER DETAIL - PAGE SS-01





STANDARD MANHOLE - CAST IN PLACE BASE

CITY STANDARD SANITARY SEWER DETAIL - PAGE SS-02

PUBLIC WORKS ENGINEERING DIVISION

2018 SEWER LINE REPLACEMENTS - PHASE A
GENERAL SEWER NOTES AND STANDARD MANHOLE


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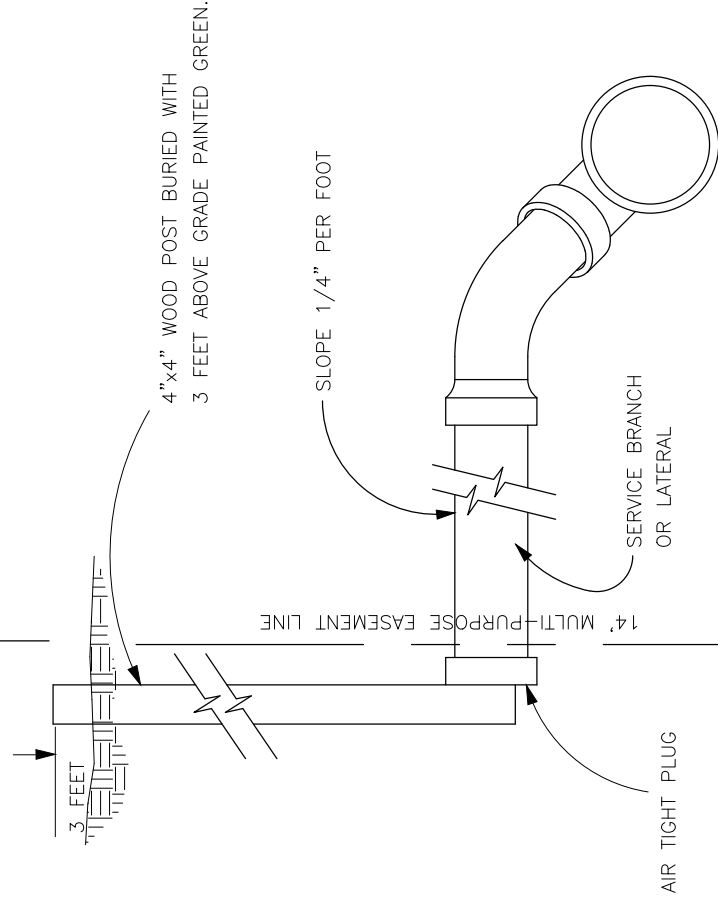
SECTION A-A

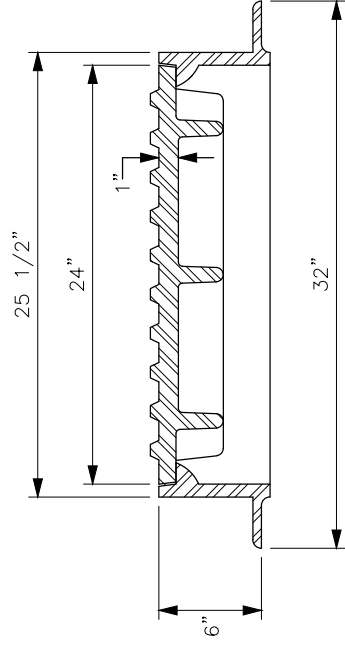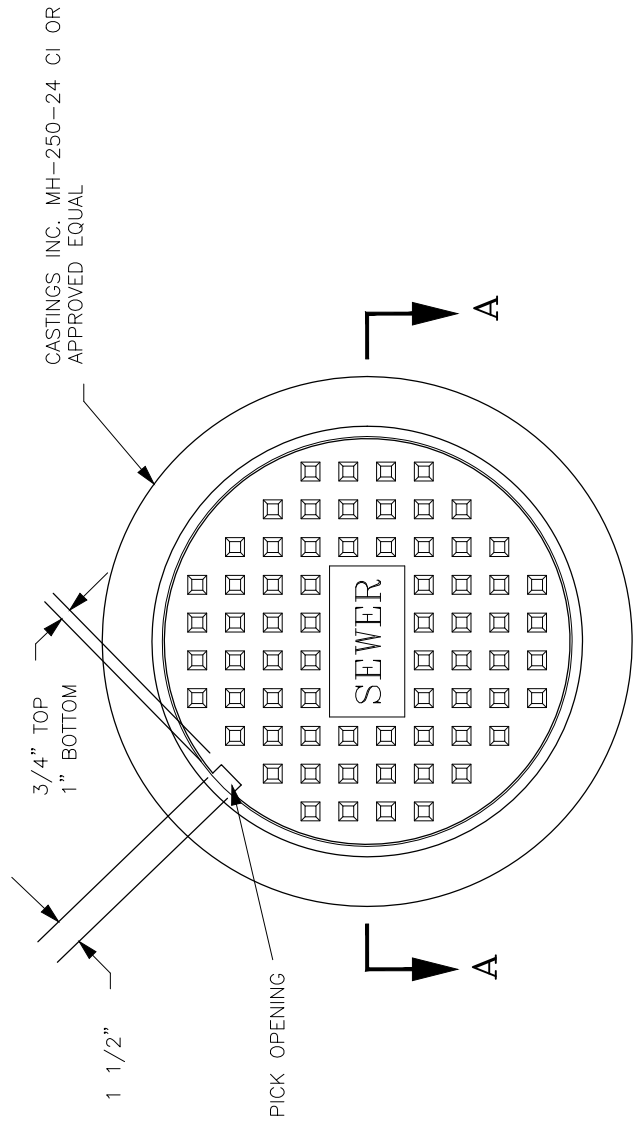FOR MANHOLES LOCATED IN SIDEWALK OR OTHER PEDESTRIAN WAY USE CASTINGS INC. MH-150-24 AL OR APPROVED EQUAL (SEE DETAIL ON PAGE D-15 OF CITY STANDARDS).

CALL UTILITY NOTIFICATION CENTER OF COLORADO **811**
 CALL 2-BUSINESS DAYS IN ADVANCE BEFORE YOU DIG, GRADE OR EXCAVATE FOR THE MARKING OF UNDERGROUND MEMBER UTILITIES



PLAN

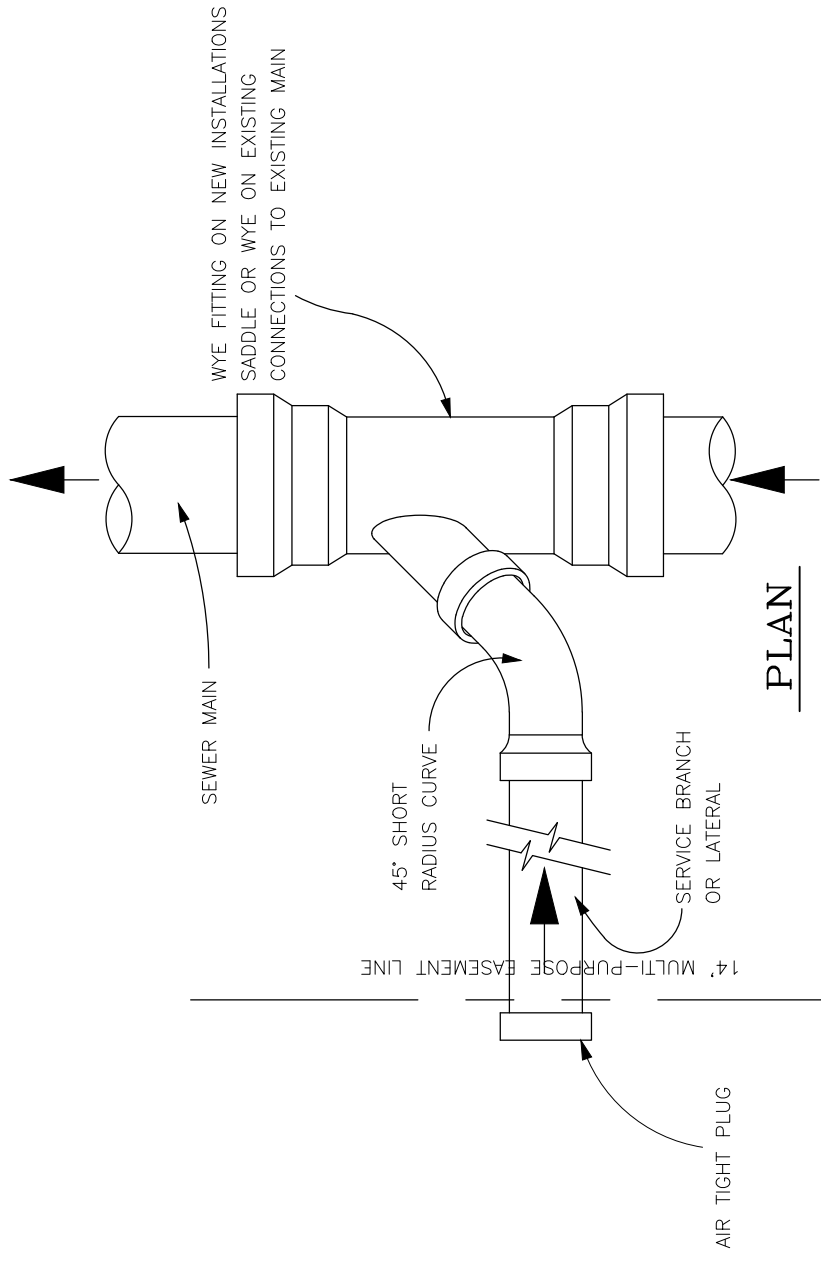

ELEVATION

STANDARD MANHOLE RING AND COVER

TYPICAL SERVICE "Y" CONNECTION

CITY STANDARD SANITARY SEWER DETAIL - PAGE SS-06

REVISION	DATE	DESCRIPTION
REVISION Δ	DATE	DESCRIPTION
REVISION Δ	DATE	DESCRIPTION
REVISION Δ	DATE	DESCRIPTION

DRAWN BY	BCH	DATE	03/20/18
DESIGNED BY	BCH	DATE	03/20/18
CHECKED BY	ALC	DATE	
APPROVED BY	ALC	DATE	


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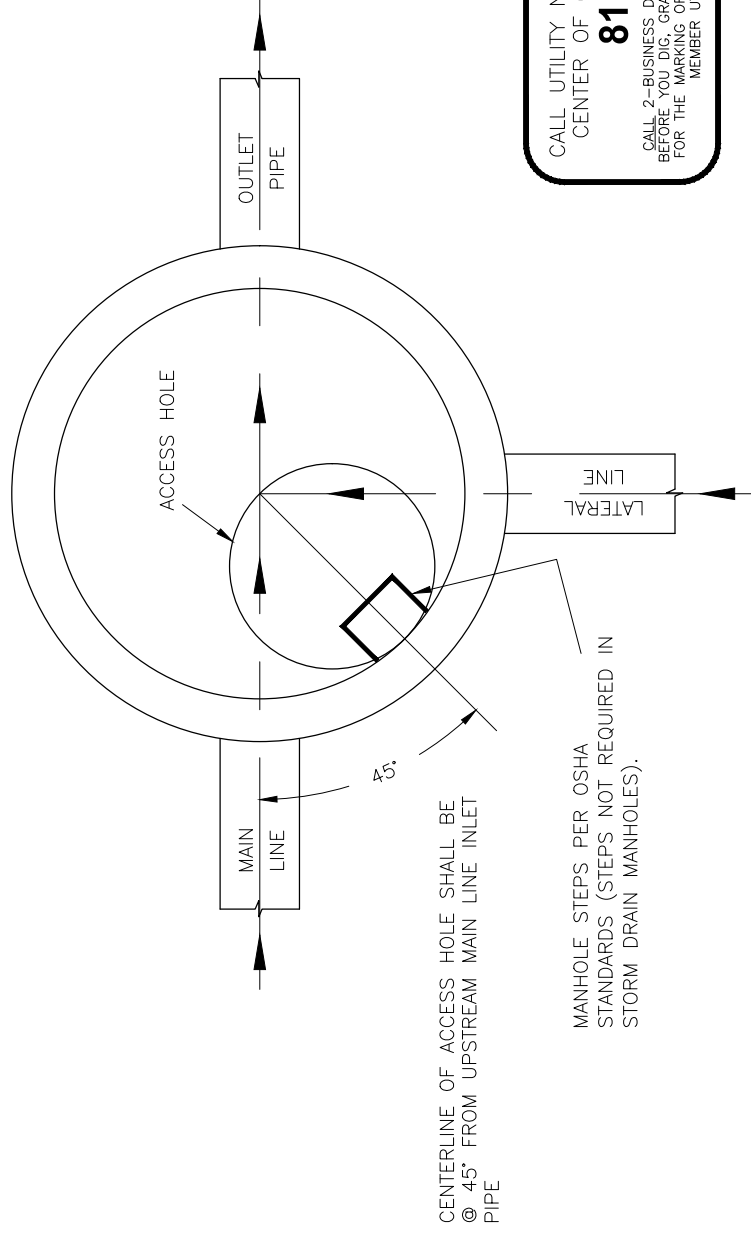
PUBLIC WORKS ENGINEERING DIVISION

2018 SEWER LINE REPLACEMENTS - PHASE A STANDARD MANHOLE RING AND COVER, AND TYPICAL SERVICE "Y" CONNECTION

GROUT FOR PIPE CONNECTIONS SHALL BE ALL-CRETE (5 OR 20 MINUTE SET) MANUFACTURED BY FOSROC INC. OR AN APPROVED SUBSTITUTE.




PRECAST MANHOLE BASE/TIE TO EXISTING MANHOLE WITHOUT BOOT

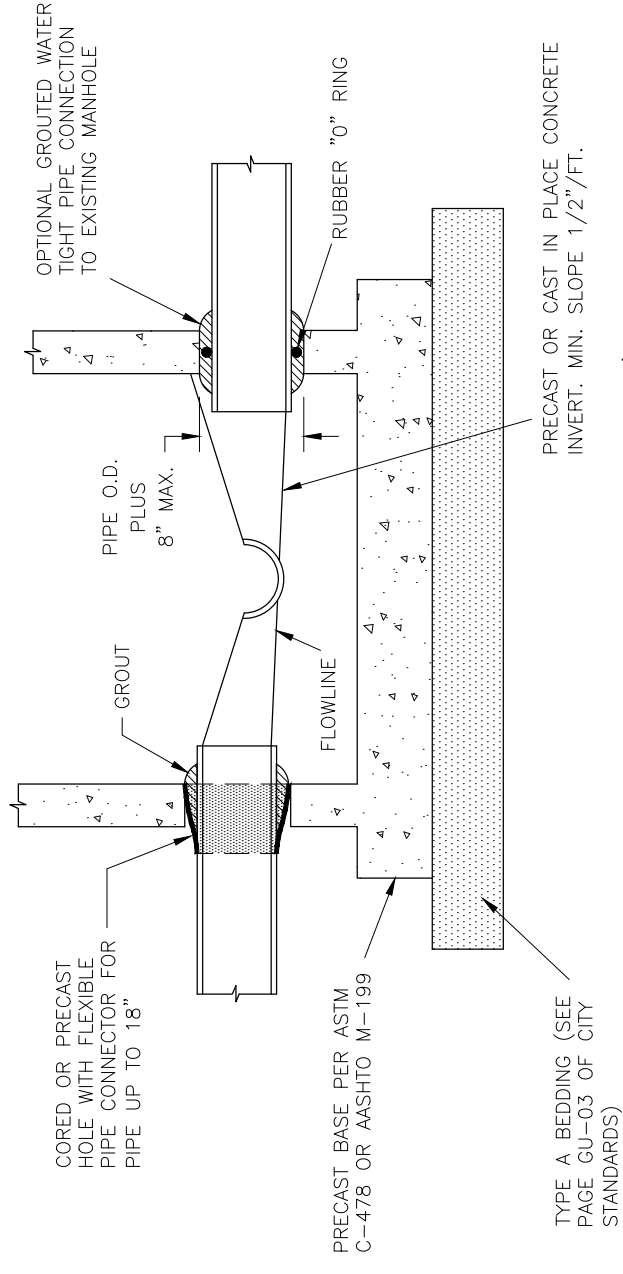


CALL UTILITY NOTIFICATION CENTER OF COLORADO **811**
CALL 2-BUSINESS DAYS IN ADVANCE BEFORE YOU DIG, GRADE, OR EXCAVATE FOR THE MARKING OF UNDERGROUND MEMBER UTILITIES

MANHOLE ACCESS LOCATION

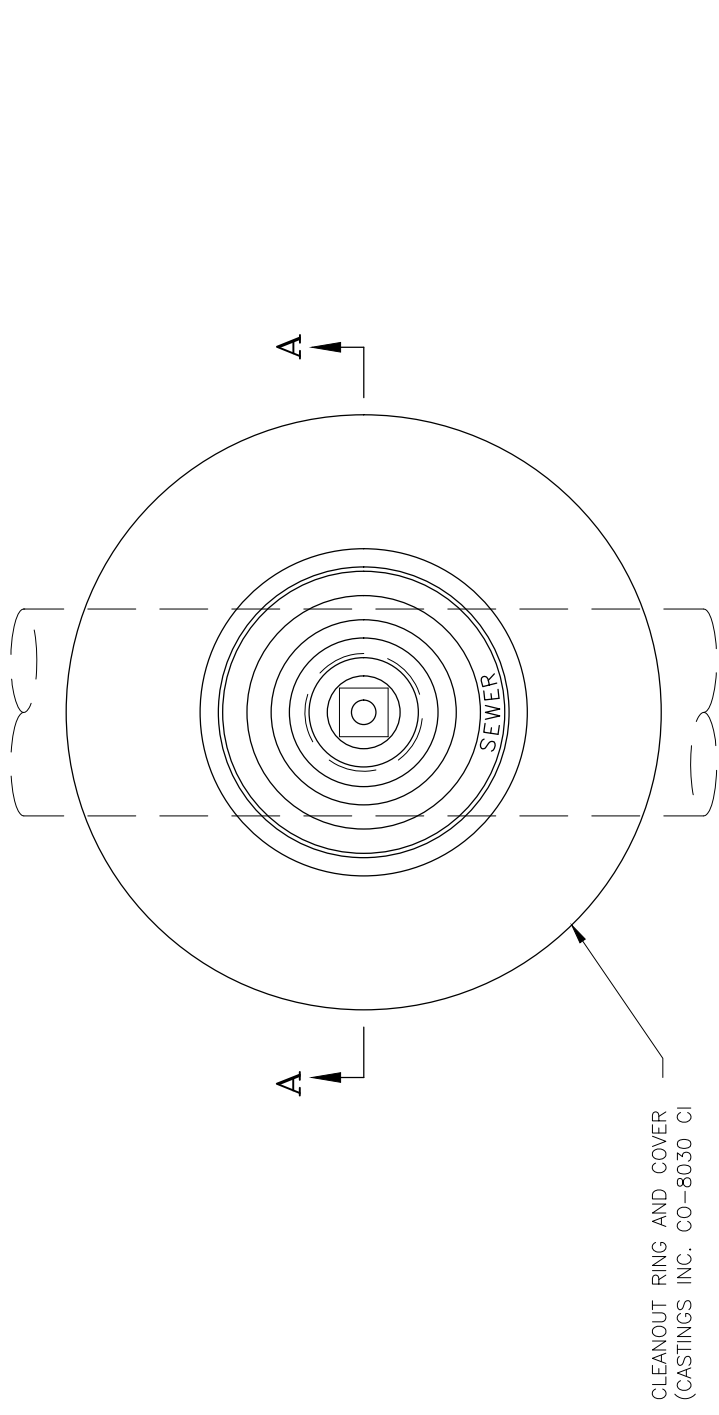

PLAN
N.T.S.

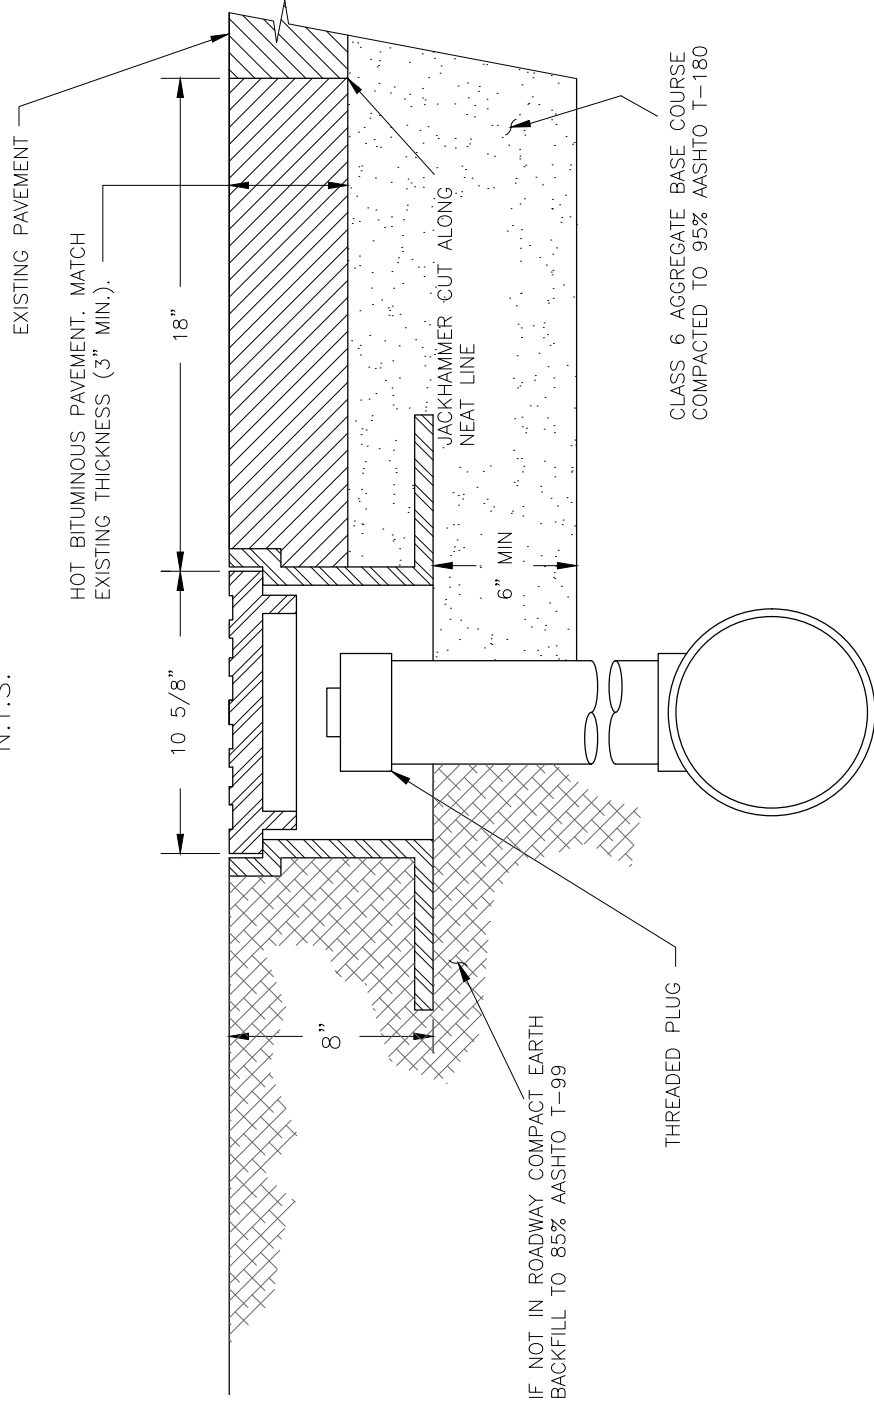

SECTION A-A
N.T.S.

SEWER SERVICE CLEANOUT WITHIN RIGHT OF WAY DETAIL

CITY STANDARD SANITARY SEWER DETAIL - PAGE SS-07

PRECAST MANHOLE BASE, PIPE CONNECTIONS & ACCESS HOLE LOCATION


CITY STANDARD SANITARY SEWER DETAIL - PAGE SS-08

REVISION	DATE	DATE	DATE	DATE
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REVISION	DESCRIPTION	DRAWN BY	DESIGNED BY	CHECKED BY
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REVISION				
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PUBLIC WORKS ENGINEERING DIVISION

2018 SEWER LINE REPLACEMENTS - PHASE A SEWER SERVICE CLEANOUT AND PRECAST MANHOLE BASE



REMOVE RIM, CONE AND BARREL SECTIONS OF EXISTING MANHOLES AND EXCAVATE AS NECESSARY TO INSTALL NEW FPVC PIPE.

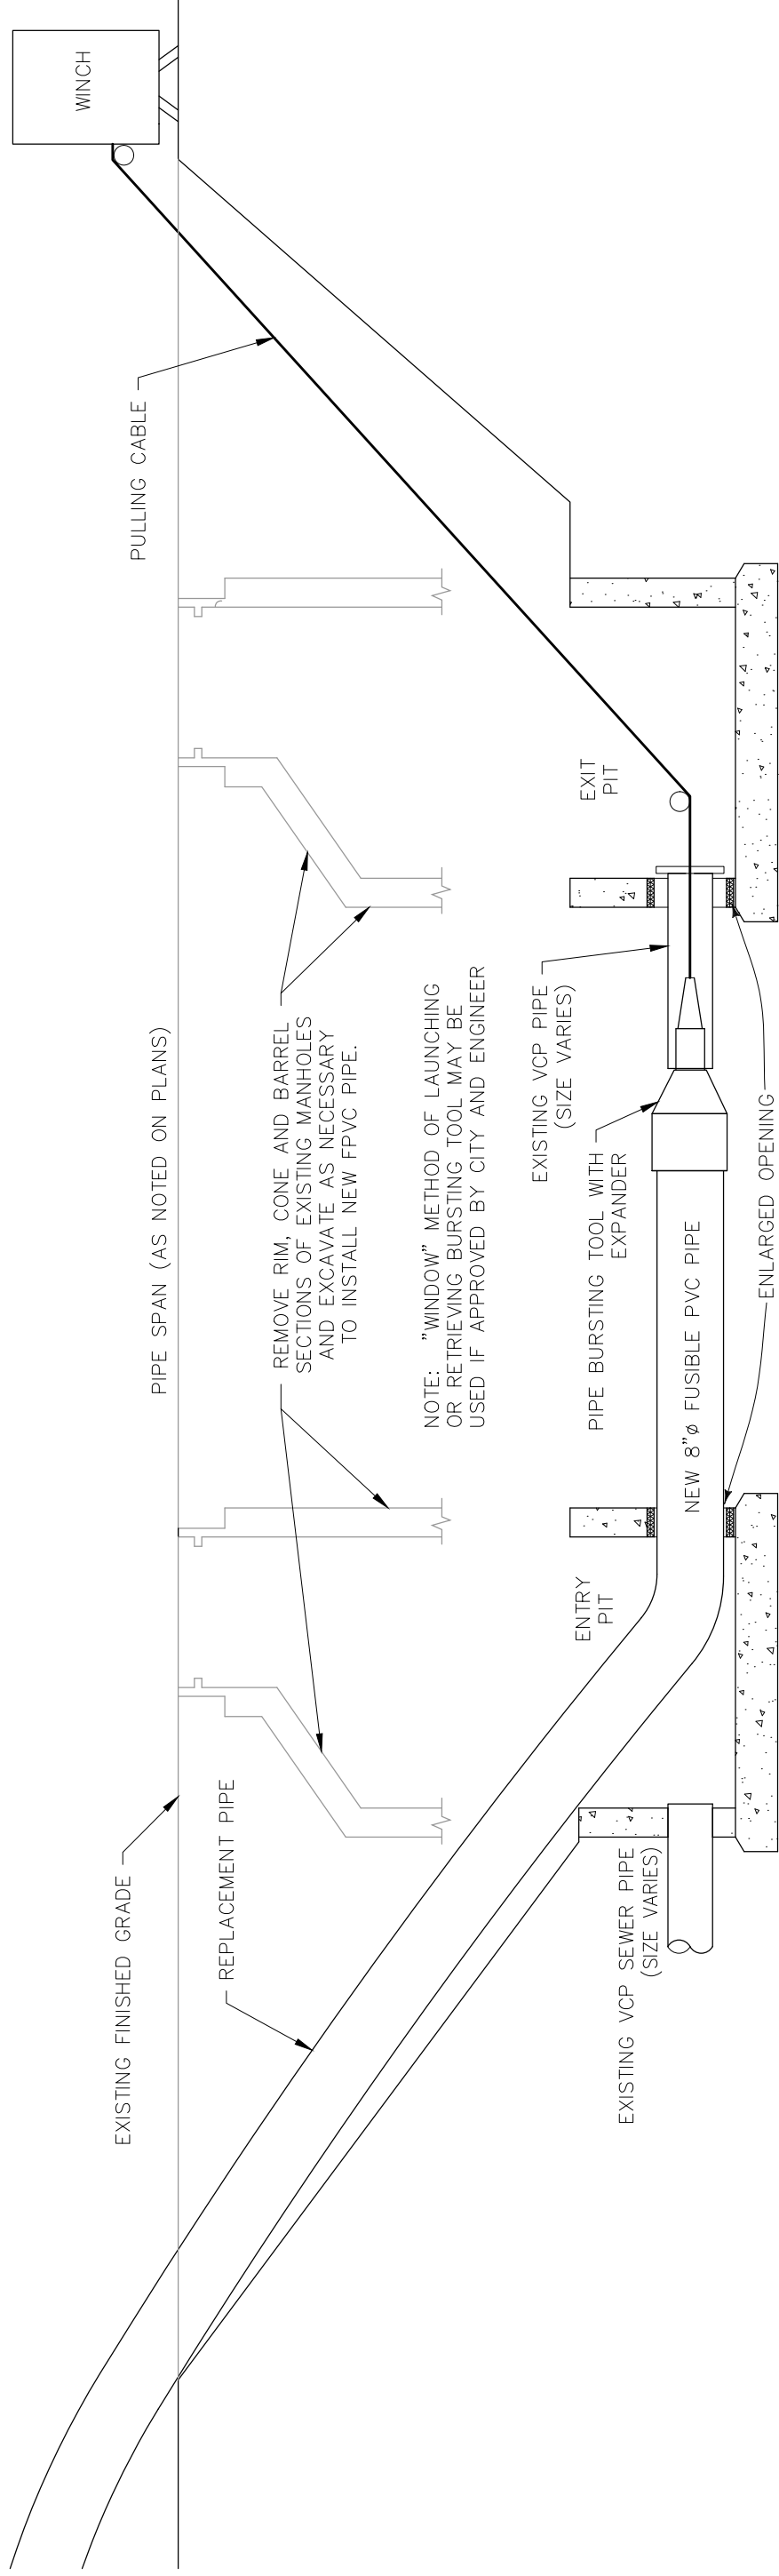NOTE: "WINDOW" METHOD OF LAUNCHING OR RETRIEVING BURSTING TOOL MAY BE USED IF APPROVED BY CITY AND ENGINEER

NOTE:
CONTRACTOR SHALL MAINTAIN MINIMUM ALLOWABLE BENDING RADIUS FOR 8" FPVC PER MANUFACTURER RECOMMENDATIONS AT ALL TIMES DURING PIPE BURSTING OPERATIONS.

TYPICAL PIPE BURSTING SETUP

N.T.S.


CALL UTILITY NOTIFICATION CENTER OF COLORADO
811
CALL 2-BUSINESS DAYS IN ADVANCE BEFORE YOU DIG GRADE OR EXCAVATE FOR THE MARKING OF UNDERGROUND MEMBER UTILITIES

REVISION Δ	DESCRIPTION	DATE	DRAWN BY	DATE	03/20/18	SCALES: PLAN & PROFILE
REVISION Δ			DESIGNED BY	DATE	03/20/18	HORIZONTAL: 1" = NA
REVISION Δ			CHECKED BY	ALC		VERTICAL: 1" = NA
REVISION Δ			APPROVED BY	ALC		



PUBLIC WORKS
ENGINEERING DIVISION

2018 SEWER LINE REPLACEMENTS - PHASE A
PIPE BURSTING DETAILS

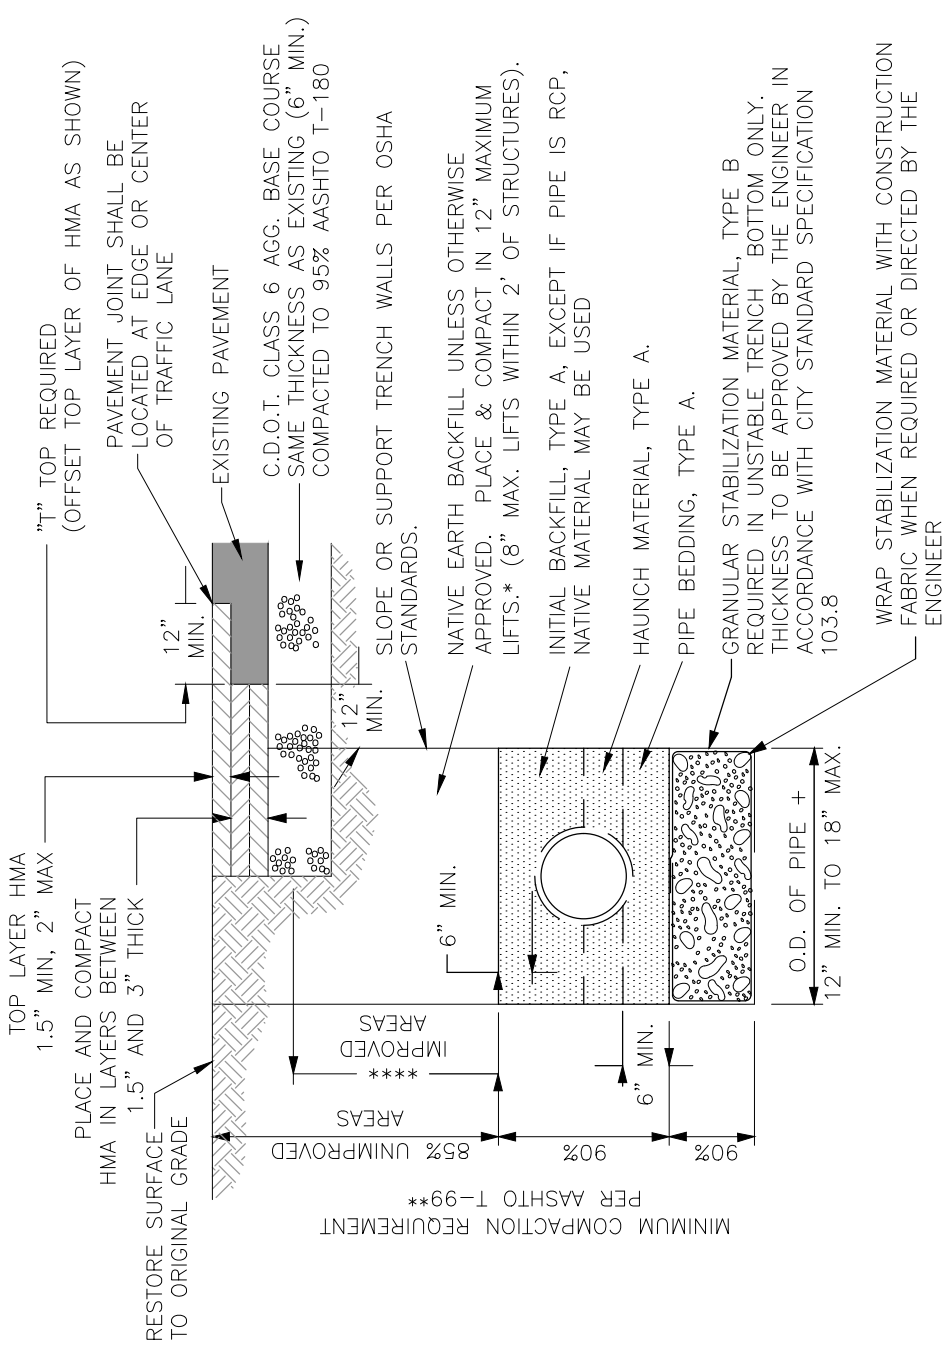

SIEVE SIZE	MAXIMUM PERCENT BY WEIGHT PASSING SQUARE MESH SIEVES
12 INCH	---
2 INCH	100
1 INCH	---
NO 4	15 MAX
NO 200	20 MAX ***
	3% - 20% ***

* 24" COMPACTED BACKFILL REQUIRED OVER ALL PLASTIC PIPE PRIOR TO VEHICLE OR HEAVY EQUIPMENT LOADING.

** COMPACT PER AASHTO T-180 WHEN SPECIFIED, DIRECTED OR APPROVED BY THE ENGINEER.

*** PLASTIC INDEX (PI) SHALL NOT BE MORE THAN 7.

**** TRENCH BACKFILL UNDER ASPHALT OR CONCRETE PAVEMENT SHALL BE COMPACTED PER SECTION 103.14 AND TABLE 101 IN THE SSFUU (STANDARD SPECIFICATIONS FOR UNDERGROUND UTILITIES).

ALL BACKFILL MATERIAL SHALL BE UNIFORMLY ADJUSTED TO WITHIN 2% OF THE OPTIMUM MOISTURE CONTENT PRIOR TO PLACEMENT AND COMPACTON.

TYPICAL TRENCH DETAIL

DEPARTMENT OF PUBLIC WORKS AND PLANNING
ENGINEERING DIVISION
CITY OF GRAND JUNCTION, COLORADO

GENERAL UTILITY
DETAIL


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REVISED: *FEB 2007*
DRAWN: *ILT*

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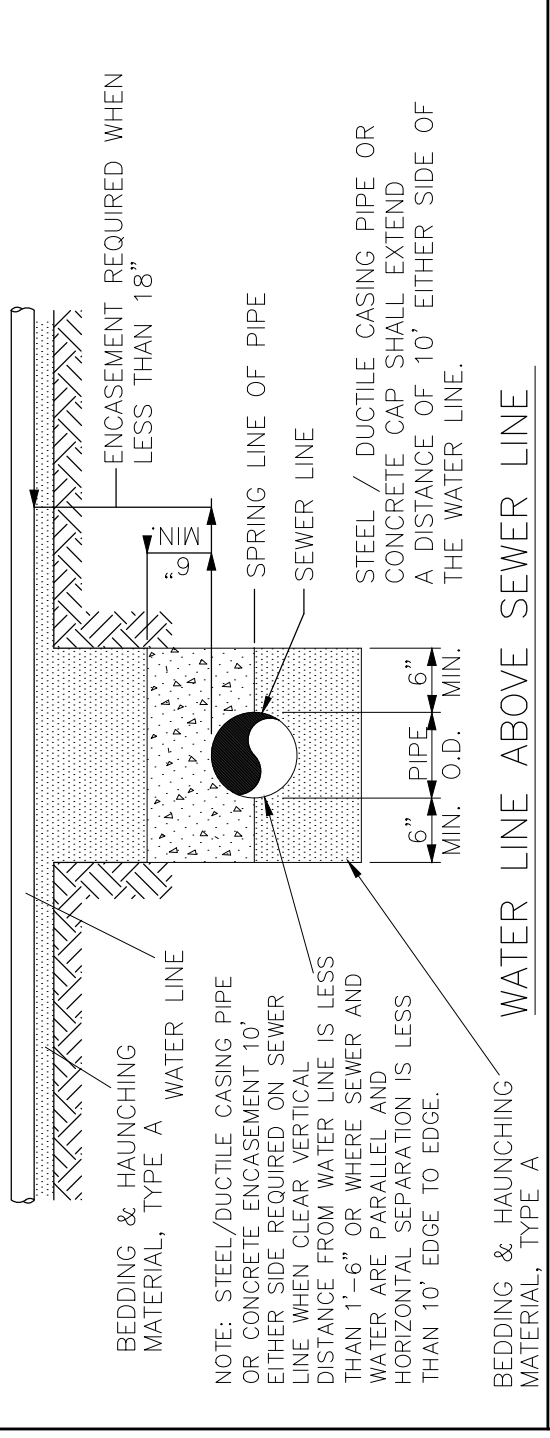
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SCALES: PLAN & PROFILE
HORIZONTAL: 1" = NA
VERTICAL: 1" = NA

Grand Junction
COLORADO



WATER LINE BELOW SEWER LINE

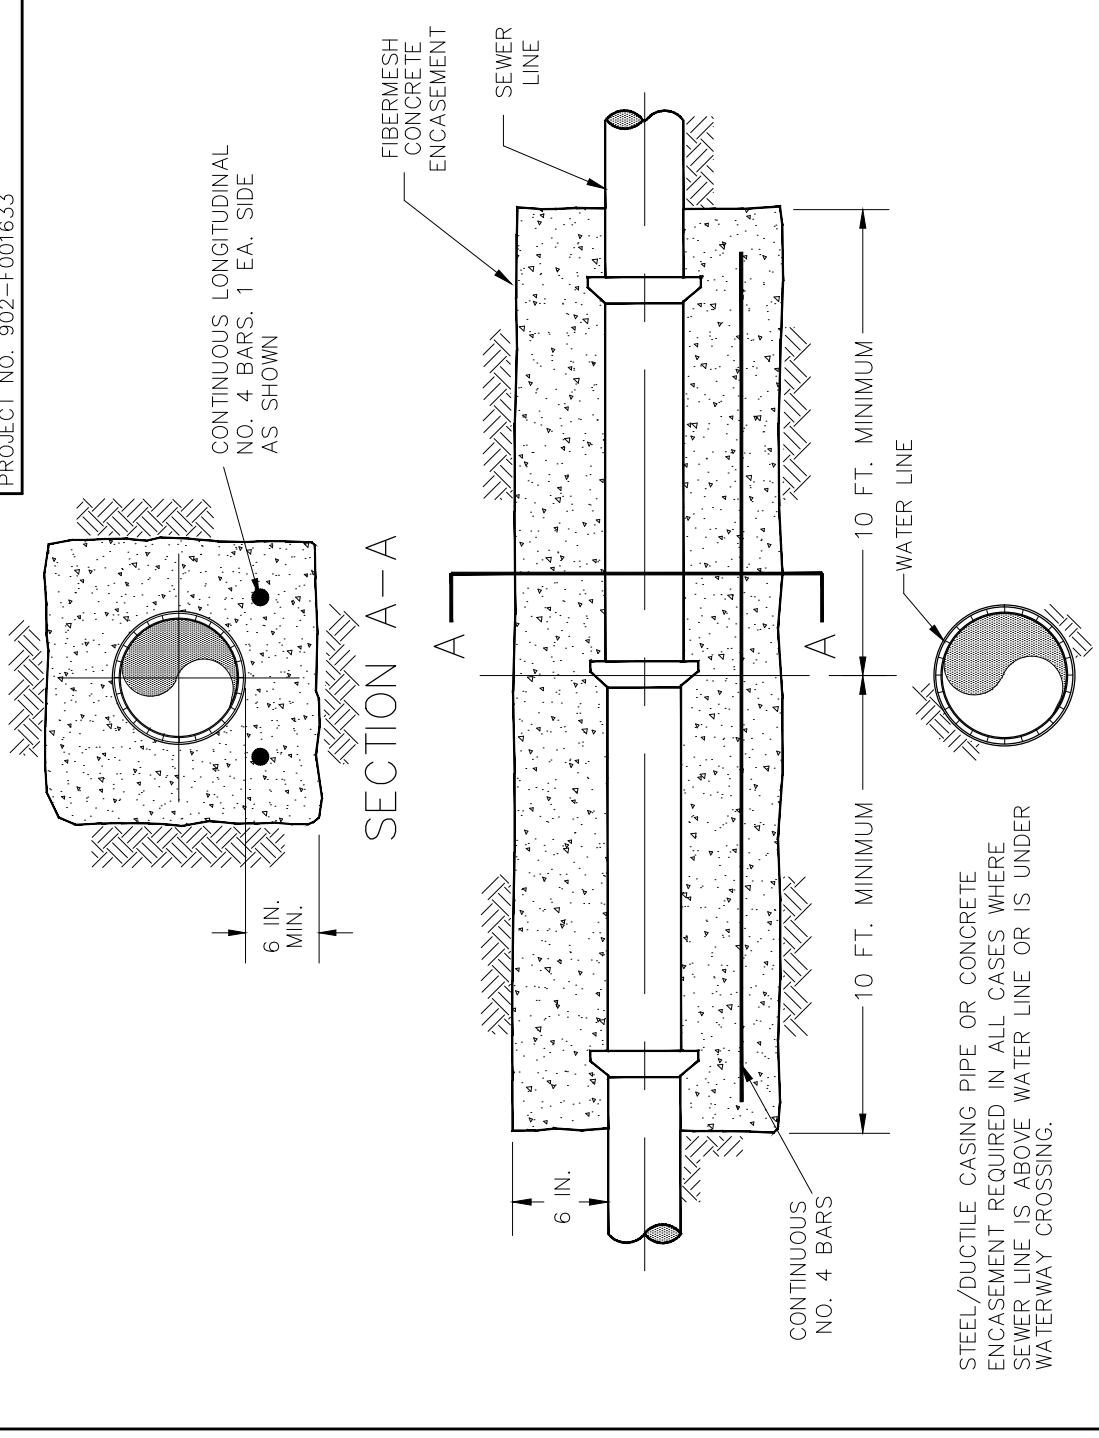

TYPICAL WATER AND SEWER LINE CROSSINGS

DEPARTMENT OF PUBLIC WORKS AND PLANNING
ENGINEERING DIVISION
CITY OF GRAND JUNCTION, COLORADO

GENERAL UTILITY
DETAIL

APPROVED: *DN*
DATE: *FEB 2005*
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PUBLIC WORKS
ENGINEERING DIVISION

2018 SEWER LINE REPLACEMENTS - PHASE A
GENERAL UTILITY DETAILS

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